
## NEW TWO STORY SINGLE FAMILY RESIDENCE 1779 RAVIZZA AVE, SANTA CLARA, CA

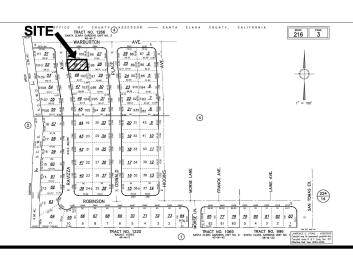

# Barkley Ave Barkley Ave Ragglo Ave Ragglo Ave Ragglo Ave Ragglo Ave Small Station of the state of the s

### BUILDING CODE DATA

CCCUPANCY:

R-3 / U-I

SINSUE FAMILY RESIDENCE

WITH ATTACHED GARAGE.

CONSTRUCTION TYPE:

V-B

FIRE SPRINCLER

NO

BUILDING CODE:

ALL APPLICABLE CURRENT CODES

TO THE CITY OF SANTA CLARA

AND THE STATE OF CALIFORNIA

2022 CALIFORNIA BLID'ES CODE (CPC)

2022 CALIFORNIA PLID'ES CODE (CPC)

2022 CALIFORNIA PLID'ES CODE (CPC)

2022 CALIFORNIA PLIDENIA CODE (CPC)

2022 CALIFORNIA BEREIN BUILDING CODE (CALGREEN)

2022 CALIFORNIA GERMAN CODE

2022 CALIFORNIA ENERGY CODE

PROJECT DESCRIPTION

25 FT.

### TABULATION

HEIGHT LIMITATION

LOT SIZE 5044 SQ. FT. LOT COVERAGE 40% 5044 X 40% = 2,017.6 SQ. FT.

LOT COVERAGE

 (N) FIRST FLOOR
 1546.10 50. FT.

 (N) GARAGE
 425.21 50.FT.

 (N) COVERED FRONT PORCH
 49.99 50.FT.

TOTAL (E) LOT COVERAGE 2,015.14 SQ, FT, LESS THAN 2017.6 SC

SECOND FLOOR TO FIRST FLOOR RATIO

NI SECOND FLOOR 1042 SQ. FT.

<u>SECOND FLOOR</u> = 1042 = 52% LESS THAN 66% (ok) FIRST FLOOR 2015.14

COMMON LIVING AREA

(N) FIRST FLOOR 1546.10 Sq. FT.
(N) SECOND FLOOR 1042 Sq. FT.

TOTAL LIVING AREA 2,588.I SQ. FT.

REQUIRED COMMON LIVING AREA 2,588.I SQ. FT. x 25% = 641,025 PROVIDED = 743 SQ.FT.

### SHEET INDEX.

A-00 COVER SHEET/ PLANNING DATA / SITE PLAN
C-I BOUNDARY AND TOPOGRAPHY SURVEY
ARCHITECTURAL

A-10 (E) BITE PLAN / PROPOSED BITE PLAN
A-11 PRIVACY PROTECTION PLAN
CB-10 BUILEPRINT FOR CLEAN BAY
CA-10 PROPOSED HIST FLOOR
A-21 PROPOSED HIST FLOOR
A-21 PROPOSED SECOND FLOOR
A-30 ROOF FLAN

A-40 EXTERIOR ELEVATIONS
A-4.1 EXTERIOR ELEVATIONS
A-50 BUILDING SECTION

No. Date Description

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Project:

NEW SINGLE FAMILY 1779 RAVIZZA AVE, SANTA CLARA, CA



1011 S De Anza Blvd SAN JOSE, CA. 95129 Phone (408) 441-0967 alis\_construction@yahoo.com

6/24/24

SCOPE OF WORK

- DEMOLITION OF EXISTING SINGLE STORY RESIDENCE.

2- PROPOSE NEW SINGLE FAMILY RESIDENCE NUMBER OF STORY: 2 NUMBER OF BEDROOM: 5

NUMBER OF BATHROOM: 3.5

Job No:

Date:

Scale:


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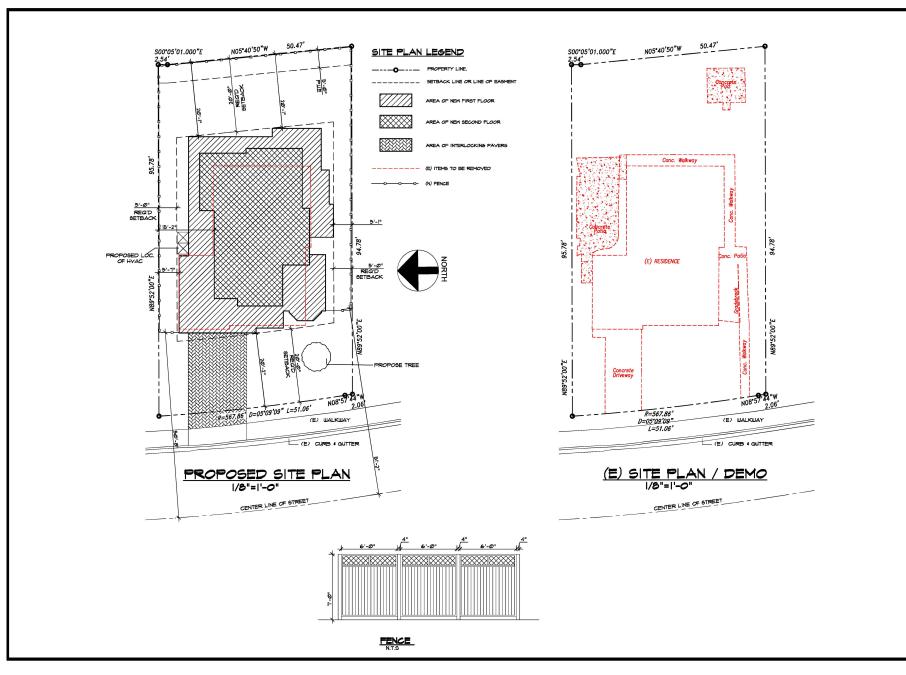
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COVER SHEET PLANNING DATA

Sheet No.:

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Project:

NEW SINGLE FAMILY 1779 RAVIZZA AVE, SANTA CLARA, CA

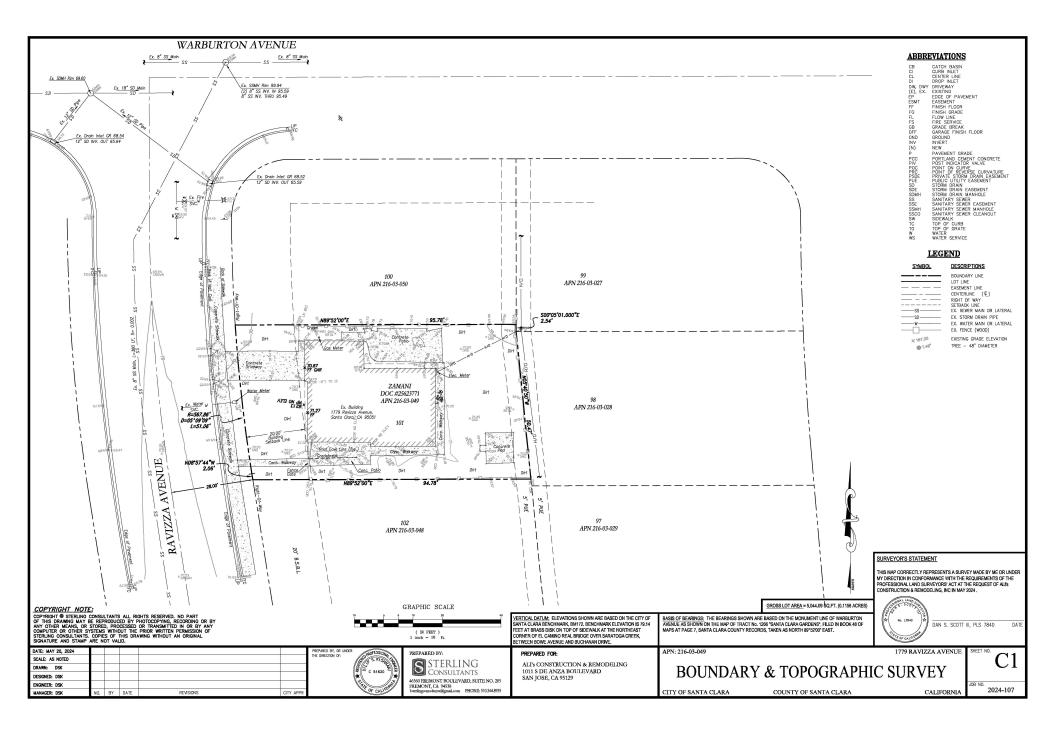

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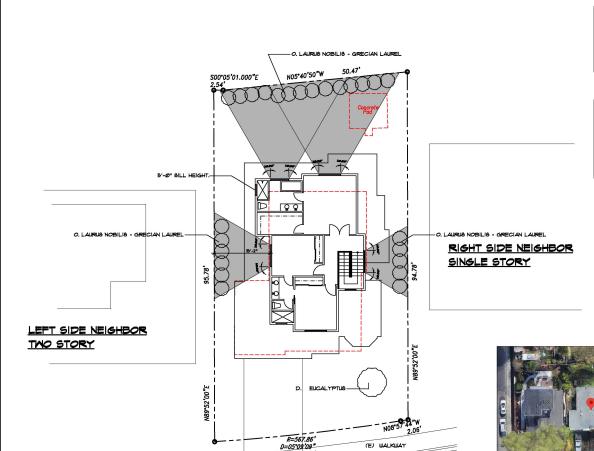
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(E) SITE PLAN / DEMO PROPOSED SITE PLAN

Sheet No.:

A-1.0



PRIVACY PROTECTION PLAN

CENTER LINE OF STREET

1/8"=1'-0"

NON DECIDUOUS TREES	HEIGHT	SPREAD	PLANTING DISTANCE MAXIMUM
A. CEDRUS DEODARA - DEODARA CEDAR	TO 80'	40' e GROUND	20'
B. MELALEJCA LINARIFOLIA - FLAXLEAF PAPERBAK	80'	12'-15'	6'
C. PINUS HELIPENSIS - ALEFPO PINE	40'-60'	20'-25'	ō.
D. EJCALYPTUS POLYANTHEMOS - SILVERDOLLAR	20'-60'	10'-15'	5'
E. CINAMOMOM CAMPHORA - CAMPHOR	50'	50'	20'
F. ARBUTUS MARINA	40'	95'	15'
6. MAGNOLIA GRANDIFLORA - SOUTHERN MAGNOLIA	80'	40'	20'

NOTE: THE MINIMUM TREE SIZE SHALL BE 24' BOX MINIMUM AND A MINIMUM OF 8' HIGH PLANTED HEIGHT.

NON DECIDUOUS SHRUBS	HEIGHT	SPREAD	PLANTING DISTANCE MAXIMUM
H. PITTOSPORUM EUGENOIDES	40'	20'	5'
I. PITTOSPORUM TENUIFOLIUM	40'	20'	5'
J. PITTOSPORUM CRASSIFOLIUM	25'	15'-20'	8'
K. PITTOSPORUM UNDULATUM -VICTORIAN BOX	15'-40'	15'-40'	8'
L. CUPRESSUS SEMPERVIRENS - ITALIAN CYPRESS	60'	3'-6'	5'
M. PODOCARPUS GRACILIOR - FERN PINE	60'	20'	0
N. PRIVET LIGUSTRUM - GLOSSY PRIVET	35'-40'	20'	ō.
O. LAURUS NOBILIS - GRECIAN LAUREL	15'-40'	20'	10'
P RHIS LANCIA - AFRICAN SIMAC	25'	20'	10'

NOTE: THE MINIMUM SHRUB SIZE SHALL BE IS SALLON MINIMUM AND A MINIMUM OF 6' HIGH PLANTED HEIGHT.



AERIAL PICTURE

No. Date	Description	
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Project:

NEW SINGLE FAMILY 1779 RAVIZZA AVE, SANTA CLARA, CA



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6/24/24

Date:

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Job No:

Signature:

Sheet Title:

PRIVACY PROTECTION PLAN

Sheet No.:

A-1.1

### **Construction Best Management Practices (BMPs)**

Construction projects are required to implement year-round stormwater BMPs.

### Materials & Waste Management



### Non-Hazardous Materials

- ☐ Berm and cover stockpiles of sand, dirt or other construction material with tarps when rain is forecast or when they are not in use
- ☐ Use (but don't overuse) reclaimed water for dust control.
- ☐ Ensure dust control water doesn't leave site or discharge to storm

### Hazardous Materials

- ☐ Label all hazardous materials and hazardous wastes (such as pesticides, paints, thinners, solvents, fuel, oil, and antifreeze) in accordance with City, County, State and Federal regulations.
- ☐ Store hazardous materials and wastes in water tight containers, store in appropriate secondary containment, and cover them at the end of every work day or during wet weather or when rain is forecast
- ☐ Follow manufacturer's application instructions for hazardous materials and do not use more than necessary. Do not apply chemicals outdoors when rain is forecast within 24 hours
- ☐ Arrange for appropriate disposal of all hazardous wastes.

### Waste Management

- ☐ Cover and maintain dumpsters. Check frequently for leaks. Place dumpsters under roofs or cover with tarps or plastic sheeting secured around the outside of the dumpster. A plastic liner is recommended to prevent leaks. Never clean out a dumpster by hosing it down on the
- ☐ Place portable toilets away from storm drains. Make sure they are in good working order. Check frequently for leaks.
- ☐ Dispose of all wastes and demolition debris properly. Recycle materials and wastes that can be recycled, including solvents, waterbased paints, vehicle fluids, broken asphalt and concrete, wood, and cleared vegetation.
- ☐ Dispose of liquid residues from paints, thinners, solvents, glues, and cleaning fluids as hazardous waste
- ☐ Keen site free of litter (e.e. lunch items, cigarette butts).
- ☐ Prevent litter from uncovered loads by covering loads that are being transported to and from site.

### Construction Entrances and Perimeter

- ☐ Establish and maintain effective perimeter controls and stabilize all construction entrances and exits to sufficiently control erosion and sediment discharges from site and tracking off site.
- ☐ Sweep or vacuum any street tracking immediately and secure sediment source to prevent further tracking. Never hose down streets to clean up tracking.

### Equipment Management & Spill Control



### Maintenance and Parking

- ☐ Designate an area of the construction site, well away from streams or storm drain inlets and fitted with appropriate BMPs, for auto and equipment parking,
- ☐ Perform major maintenance, repair jobs, and vehicle and equipment washing off site.
- ☐ If refueling or vehicle maintenance must be done onsite, work in a bermed area away from storm drains and over a drip pan or drop cloths big enough to collect fluids. Recycle or dispose of fluids as hazardous waste.
- ☐ If vehicle or equipment cleaning must be done onsite, clean with water only in a bermed area that will not allow rinse water to run into gutters, streets, storm drains, or surface waters.
- Do not clean vehicle or equipment onsite using soaps solvents, degreasers, or steam cleaning equipment, and do not use diesel oil to lubricate equipment or parts

### Spill Prevention and Control

- ☐ Keep spill cleanup materials (e.g., rags, absorbents and cat litter) available at the construction site at all times.
- ☐ Maintain all vehicles and heavy equipment. Inspect frequently for and repair leaks. Use drip pans to catch leaks until repairs are made.
- ☐ Clean up leaks, drips and other spills immediately and dispose of cleanup materials properly.
- Use dry cleanup methods whenever possible (absorbent materials, cat litter and/or rags).
- ☐ Sweep up spilled dry materials immediately. Never attempt to "wash them away" with water, or bury
- ☐ Clean up spills on dirt areas by digging up and properly disposing of contaminated soil
- ☐ Report significant spills to the appropriate local spill response agencies immediately. If the spill poses a significant hazrd to human health and safety, property or the environment, you must report it to the State Office of Emergency Services. (800) 852-7550 (24

### Earthmoving



### Grading and Earthwork ☐ Schedule grading and excavation work

- during dry weather. ☐ Stabilize all denuded areas, install and maintain temporary erosion controls (such as erosion control fabric or bonded fiber
- matrix) until vegetation is established. ☐ Remove existing vegetation only when absolutely necessary, plant temporary vegetation for erosion control on slopes or where construction is not immediately planned.
- ☐ Prevent sediment from migrating offsite and protect storm drain inlets, drainage courses and streams by installing and maintaining appropriate BMPs (i.e. silt fences, gravel bags, fiber rolls, temporary swales, etc.).
- ☐ Keep excavated soil on site and transfer it to dump trucks on site, not in the streets.

### Contaminated Soils

- ☐ If any of the following conditions are observed, test for contamination and contact the Regional Water Quality Control Board:
- Unusual soil conditions, discoloration, or odor.
- Abandoned underground tanks - Abandoned wells
- Buried barrels, debris, or trash,
- ☐ If the above conditions are observed document any signs of potential contamination and clearly mark them so they are not distrurbed by construction

### activities.

- ☐ Protect stockpiled landscaping materials from wind and rain by storing them under tarps all year-round.
- ☐ Stack bagged material on pallets and under cover.
- ☐ Discontinue application of any erodible landscape material within 2 days before a forecast rain event or during wet weather

### Concrete Management and Dewatering



### Concrete Management

- ☐ Store both dry and wet materials under cover, protected from rainfall and runoff and away from storm drains or waterways. Store materials off the ground, on pallets. Protect dry materials from wind.
- ☐ Wash down exposed aggregate concrete only when the wash water can (1) flow onto a dirt area: (2) drain onto a bermed surface from which it can be pumped and disposed of properly; or (3) block any storm drain inlets and vacuum washwater from the gutter. If possible, sweep first.
- ☐ Wash out concrete equipment/trucks offsite or in a designated washout area onsite, where the water will flow into a temporary waste nit and make sure wash water does not leach into the underlying soil. (See CASQA Construction BMP Handbook for properly designed concrete washouts.)

- ☐ Discharges of groundwater or captured runoff from dewatering operations must be properly managed and disposed. When possible, send dewatering discharge to landscaped area or sanitary sewer. If discharging to the sanitary sewer, call your local wastewater treatment plant.
- ☐ Divert run-on water from offsite away from all disturbed areas.
- ☐ When dewatering, notify and obtain approval from the local municipality before discharging water to a street gutter or storm drain. Filtration or diversion through a basin tank, or sediment trap may be required.
- ☐ In areas of known or suspected contamination, call your local agency to determine whether the ground water must be tested. Pumped groundwater may need to be collected and hauled off-site for treatment and proper disposal.

### Paving/Asphalt Work




- ☐ Avoid paving and seal coating in wet weather or when rain is forecast, to prevent materials that have not cured from contacting stormwater runoff.
- ☐ Cover storm drain inlets and manholes when applying seal coat, slurry seal, fog seal, or similar materials.
- ☐ Collect and recycle or properly dispose of excess abrasive gravel or sand. Do NOT sweep or wash it into gutters.

### Sawcutting & Asphalt/Concrete Removal

- ☐ Protect storm drain inlets during saw
- ☐ If saw cut slurry enters a catch basin.
- clean it up immediately. ☐ Shovel or vacuum saw cut slurry deposits and remove from the site. When making saw cuts, use as little water as possible. Sweep up, and properly dispose of all

### Painting & Paint Removal

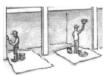

- ☐ Never clean brushes or rinse paint containers into a street, gutter, storm drain, or stream. ☐ For water-based paints, paint out brushes
- to the extent possible, and rinse into a drain that goes to the sanitary sewer. Never pour paint down a storm drain.
- the extent possible and clean with thinner reuse thinners and solvents. Dispose of excess liquids as hazardous waste
- ☐ Sweep up or collect paint chips and dust from non-hazardous dry stripping and sand blasting into plastic drop cloths and
- ☐ Chemical paint stripping residue and chips and dust from marine paints or paints containing lead, mercury, or tributyltin must be disposed of as hazardous waste. Lead based paint removal requires a statecertified contractor





### Painting Cleanup and Removal

- ☐ For oil-based paints, paint out brushes to
- or solvent in a proper container. Filter and



1011 S De Anza Blvd

No. Date Description

NEW SINGLE FAMILY

1779 RAVIZZA AVE,

SANTA CLARA CA

Project:

SAN JOSE, CA. 95129 Phone (408) 441-0967 alis\_construction@yahoo.com

6/24/24

Date: Scale:

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Signature:

Sheet Title:

BLUEPRINT FOR CLEAN BAY

Sheet No.:

Storm drain polluters may be liable for fines of up to \$10,000 per day!



### City of Santa Clara The General Office of the 615-2440 The General Office of the 615-2

New residential buildings shall be designed to include the green building menatory measures specified in this checklist. This checklist shall also be applied to additions or alterations of existing residential buildings where the addition or alteration increases the building's conditioned area, volume, or size. The requirements shall apply only to the specific area of the addition or alteration.

BUILDING PERMIT NO.:	BLD2	MANDATORY MEASURES
ADDRESS:	1779 RAVIZZA AVE. SANTA CLARA	SPECIFIED (Please check boxes below)

Feature or Measure	Yes
SITE DEVELOPMENT (CGC 4.106)	
Storm water drainage and retention during construction. A plan shall be developed and shall be implemented to manage storm water drainage during construction per CGC 4.106.2.	⊄
Grading and paving. Construction plans shall indicate how site grading or a drainage system will manage all surface water flows to keep water from entering buildings per CGC 4.108.3.	
Electric vehicle (EV) charping for new one- and two-flamity devellings and town-houses with attached private garages andre prairing spaces not assigned to a develling unit, and ADUIADU without additional parking but with electrical panel upgrades or new panels. Provide capability for electric vehicle charging with minimum respired Level of EV Ready, Leve V Peeu Ready, Lev V Peeu Revel 2 EV Ready see specified in CGC 4.108.4.1 as amended by City of Sarita Clian Reach Code Ordinance No.2006 (CSC 2023 Reach Code) section 15.33 040.  **Membraderon: The raceway termination location shall be perminently and visibly marked as "Level 2 EV-ReADY" per CGC 4.108.4.1 as amended by CSC 2023 ResearCodes section 15.33 040.	
Electric vehicle (EV) charging for new multifamily dwellings, affordable housing, hotels, motels, and new residential parking facilities. Provide electric vehicle infrastructure and capscibility for electric vehicle charging with minimum required Level 2 EV Panager, Level 1 EV Ready, Level 2 EV Ready, Level 2 EV Ready, Level 2 EV Alexandry Level 2 EV Ready, Lev	
110v Electrical Outlet at Bicycle Parking: All multifamily residential developments shall include secured bicycle parking with 110v electrical outlets per CSC 2023 Reach Code section 15.38.040.	
Location: EVCS shall be located adjacent to an accessible parking space, and/or on an accessible route, per CGC 4.106.4.2.2.1.1.	
Dimension: Each EV ready space or EVCS shall be minimum 18 ft long and 9 ft wide. One in every 25 charging spaces, but not less than one, shall have an 8 ft wide access eisle. A 5 ft wide minimum eisle shall be permitted provided the minimum width of the EV space is 12 Sect. Surface stope for this EV space and the aisle shall not exceed 2.083% slope in any direction, per CGO 4.106.4.2.2.12.	
Accessibility: EV Ready and EVCS spaces shall comply with the accessibility provision for EV Charging stations in California Building Code Chapter 11A (section 1109A) and Chapter 11B, per CGC 4.106.4.2.2.1.3.	
EV Ready Space Signage: EV ready spaces shall be identified by signage or pavement markings, in compliance with Califrans Traffic Operations Policy Directive 13-01 (Zero Emission Vehicle Signs and Pavement Marking) or its successor(s), per CGC 4-106.4.2.5.	
Automatic load management system (ALMS) may be installed to increase the number of EV chargers or the amperage or voltage beyond the minimum requirements in this code. The option does not allow for installed less electrical panel capacity then would be required without ALMS, per CGC 4.106.4.2.2 as amended by CSC 2023 Reach Code section 15.3.040.	

RG01 2022 Green Building Residential-Revised 01-2023.docx

BLD Fellik No.	
VERIFICATION (CGC 703)	
Documentation. Upon request, verification of compliance with this code may include construction documents, plans, specifications, builder or installer certification, inspection reports, or other methods acceptable to the building department which will show substantial conformance per CGC 703.1.	⊄

Responsible Designer's Declaration Statement	Contractor Declaration Statement
I hereby certify that this project has been designed to meet the requirements of the 2022 California Green Building Standards Code.	I hereby certify, as the builder or installer under the permi listed herein, that this project will be constructed to meet the requirements of the California Green Building Standards Code.
Name: Ali Zamani_	Name: ALI'S CONSTRUCTION & REMODELING INC
Signature / / / /	Signature:
Date: 6/12/24	Date: 6/12/24/
Company: ALI'S CONSTRUCTION & REMODELING INC	License: 909433
Address: 1011 S DE ANZA BLVD	Address: 1011 S DE ANZA BLVD
City: SANJOSE State: CA Zip: 95129	City: San Jose State: Ca Zip: 95129

Electric vehicle (EV) charging for additions or alterations of parking facilities serving existing multifamily building. When were variety facilities are edited, or electrical systems or lighting or desting parking facilities are added or altered and the work requires a building permit, minimum 10% of total addediatored parking spaces shall be electrical vehicle charging spaces capable of supporting future Level 2 electric vehicle supply equipment (VEX) per CGC 4.100.4.3.	
ENERGY EFFICIENCY (CGC 4.201)	
California Energy Code. The building's construction shall meet or exceed the requirements of the 2022 California Building Energy Efficiency Standards per CGC 4.201.1.	
WATER EFFICIENCY AND CONSERVATION	
INDOOR WATER USE (CGC 4.303)	
Water conserving plumbing fixtures and fittings. Plumbing fixtures (water closets and urinals) and fittings (faucets, showerheads, pre-rinse spray valves) shall comply with the prescriptive requirements of Section 4.303.1.1 through 4.303.1.4.5.	ø
Water closets: The effective flush volume of all water closets shall not exceed 1.28 gallons per flush (CGC 4.303.1.1).	Ø
Urinals: The effective flush volume of wall-mounted urinals shall not exceed 0.125 gallons per flush, and all other urinals shall not exceed 0.5 gallons per flush (CGC 4.303.1.2).	_
Showerheads. The flow rate for single showerhead and multiple showerheads serving one shower shall not exceed 1.8 gallons per minute at 80 psi and shall be certified to the performance criteria of the U.S. EPA WaterSense Specification (CSC 4.303.1.3).	⊄
Residential lavatory faucets. The flow rate shall not be more than 1.2 gallons per minute at 60 psi, and not less than 0.8 gallons per minute at 20 psi (CGC 4.303.1.4.1).	⊄
Lavatory faucets in common and public use areas. The flow rate shall not exceed 0.5 gallons per minute at 60 psi (CGC 4.303.1.4.2).	_
Metering Faucets. The flow rate shall not deliver more than 0.2 gallons per cycle (CGC 4.303.1.4.3).	
Kitchen Faucets. The flow rate shall not exceed 1.8 gallons per minute at 60 psi (CGC 4.303.1.4.4).	5/
Pre-rinse Spray Valves. When installed, shall meet the requirements of Title 20 of the California Code of Regulations, and shall be equipped with an integral automatic shutoff (CGC 4.303.1.4.5).	-
Submeters for multifamily buildings and dwelling units in mixed-use residential/commercial buildings. Submeters shall be installed to measure water usage of individual rental dwelling units in accordance with the California Pluming Code per CSB C 4303.2.	
Standards for plumbing fixtures and fittings. Plumbing fixtures and fittings shall meet the applicable standards referenced in Table 1701.1 of the California Plumbing Code per CGC 4.303.3.	₩/
OUTDOOR WATER USE (CGC 4.304)	
Outdoor potable water use in landscape areas. Residential developments shall comply with the City's Water Service and Use Rules and Regulations, Item No. 24, as adopted by Santal Clara City Codo Section 13.15 list, or the California Model Water Efficient Landscape Ordinance (MWELO), whichever is more stringent, per CGC 4.304.1.	
ENHANCED DURABILITY AND REDUCED MAINTENANCE (CGC 4.406)	
Rodent proofing, Annular spaces around pipes, electric cables, conduits or other openings in sole/bottom plates at exterior walls shall be rodent proofed by closing such openings with cement morter, concrete masonry, or similar method acceptable to the City per CGC 4.406.1.	⊄
CONSTRUCTION WASTE REDUCTION, DISPOSAL AND RECYCLING (CGC 4.408)	
Construction waste management. Recycle and/or salvage for reuse a minimum of 65% of nonhazardous construction and demolition waste in accordance with Section 4.408.2, 4.408.3, or 4.408.4, or meet a more stringent local construction and demolition waste management ordinance (CGC 4.408.1).	
BUILDING MAINTENANCE AND OPERATION (CGC 4.410)	
An operation and maintenance manual shall be provided to the building occupant or owner per CGC 4.410.1.	

RG01 2022 Green Building Residential-Revised 01-2023.docx of 4

BLD Permit No :

BLD Permit No.:	
Recycling by occupants. Where 5 or more multifamily dwelling units are constructed on a building site, provide readily accessible areas that serve all buildings on the site and are identified for depositing, storage and collection of nonhazardous materials for recycling per CGC 4.410.2.	
ENVIRONMENTAL QUALITY (CGC 4.503)	
Gas fireplace. Any installed gas fireplaces shall be a direct-vent sealed-combustion type per CGC 4.503.1.	
Woodstoves. Any installed woodstove or pellet stove shall comply with U.S. EPA New Source Performance standards (NSPS) emission limits as applicable and shall have a permanent label indicating they are certified to meet the emission limits per CGC 4.503.1. Woodstoves and pellet stoves shall also comply with Santa Clara City Code Chapter 15.65.	
POLLUTANT CONTROL (CGC 4.504)	
Covering of duct openings and protection of mechanical equipment during construction. At the time of rough installation, during storage on the construction site and until final startup of the heating, cooling and verillating equipment, at duct and other related air distribution component openings shall be covered with large, plastic, sheatmetal, or other methods acceptable to the City to reduce the amount of water, dust or debris, which may enter the system per CGC 4.504.1.	ø
Adhesives, sealants and caulks shall meet the VOC or other toxic compound limits per CGC 4.504.2.1.	M
Paints, stains and other coatings shall comply with VOC limits per CGC 4.504.2.2.	Ø
Aerosol paints and coatings shall meet the product-weighted MIR limits for ROC and other requirements per CGC 4.504.2.3.	Ø
Verification. Documentation shall be provided, at the request of the Building Division, to verify that compliant VOC-limit finish materials have been used per CGC 4.504.2.4.	IJ.
Carpet systems. All carpet installed in the building interior shall meet the testing and product requirements of CGC 4.504.3.	
Resilient flooring systems. Where resilient flooring is installed, at least 80% of the floor area receiving resilient flooring shall comply with the requirements of CGC 4.504.4.	
Composite wood products. Hardwood plywood, particleboard and medium density fiberboard composite wood products used on the interior or exterior of the building shall comply with low formaldehyde emissions standards and requirements per CGC 4.504.5.	
INTERIOR MOISTURE CONTROL (CGC 4.505)	
Concrete stab foundations. Vapor retarder and capillary break shall be installed if a stab-on-grade foundation system is used. The use of a 4" thick base of ½" or larger clean aggragate under a 10" mil vapor retarder with joints ispped not less than 6" shall be provided per CGC 4.505.2, CRC R506.2.2, CRC R505.2.3 and CBC Section 1605.	
Moisture content of building material. Building materials with visible signs of water damage shall not be installed. Wall and floor framing shall not be enclosed when the framing members exceed 19% moisture content. Moisture content shall be checked prior to finish material being applied per CGC 4.505.3.	
INDOOR AIR QUALITY AND EXHAUST (CGC 4.506)	
Bathroom exhaust fans. Each bathroom shall be mechanically ventilated using ENERGY STAR compliant fans ducted to the exterior and equipped with humidity controls system per CGC 4.506.1.	Ø
ENVIRONMENTAL COMFORT (CGC 4.507)	
Heating and air-conditioning system shall be sized, designed and have their equipment selected using the following methods per CGC 4.507.2: 1. Heat LossHeat Gain values in accordance with ANSI/ACCA 2 Manual J-2016, ASHRAE handbook or equivalent. 2. Duct systems are sized according to ANSI/ACCA 1 Manual D-2016, ASHRAE handbook or equivalent.	Ø
3. Select heating and cooling equipment in accordance with ANSI/ACCA 3 Manual S-2014 or equivalent.	
INSTALLER AND SPECIAL INSPECTOR QUALIFICATION (CGC 702)	
Installer training, HVAC system installers shall be trained and certified in the proper installation of HVAC systems including ducts and equipment by a recognized training or certification program per CGC 702.1.	₽
Special inspection. Special inspectors employed by the City must be qualified and able to demonstrate competence in the discipline they are inspecting per CGC 702.2.	⋪

RG01 2022 Green Building Residential-Revised 01-2023.docx of 4

No. Date Description

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NEW SINGLE FAMILY 1779 RAVIZZA AVE, SANTA CLARA, CA



1011 S De Anza Blvd SAN JOSE, CA. 95129 Phone (408) 441-0967 alis\_construction@yahoo.com

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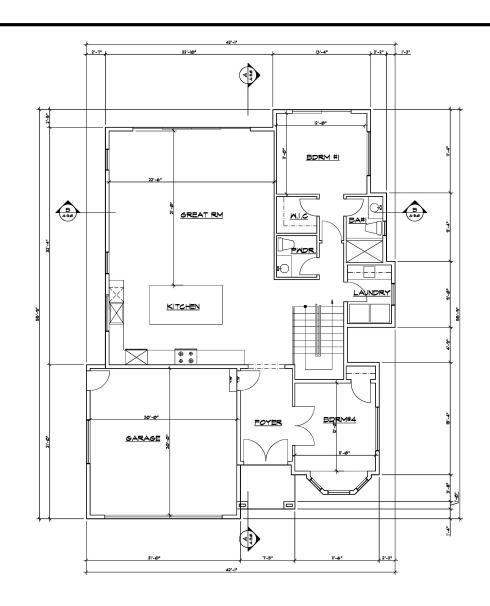
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CALGREEN CHECKLIST

Sheet No.:

CG-1.0



### PROPOSED FIRST FLOOR PLAN

2015.2 SQ. FT. INCLDUING GARAGE AND ENTRY PORCH FOR LOT COVERAGE (40%)

No. Date	Description	
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$\triangle$		_

Project:

NEW SINGLE FAMILY 1779 RAVIZZA AVE, SANTA CLARA, CA



1011 S De Anza Blvd SAN JOSE, CA. 95129 Phone (408) 441-0967 alis\_construction@yahoo.com

6/24/24

Date:

Scale: 1/4"=1'-0"

Job No:


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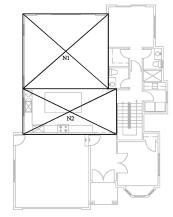
Sheet Title:

FIRST FLOOR PLAN

Sheet No.:

A-2.0



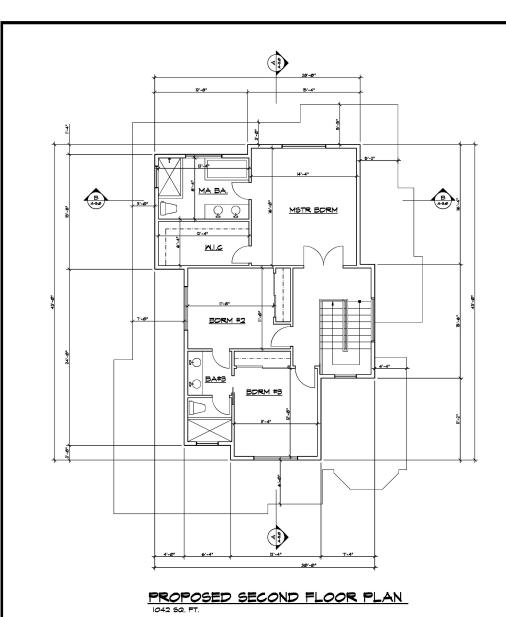

### COMMON LIVING AREA DIAGRAM

POLYGON	DIMENSIONS	AREA (SQ. FT.)
N1	23'-4" x 20'-5"	476.38
N2	25'-6" x 12'-5"	316.62
		743.00

(N) FIRST FLOOR (N) SECOND FLOOR 1546.10 SQ. FT. 1042 5Q. FT.

REQUIRED COMMON LIVING AREA 2,586.1 Sq. FT,  $\times$  25% = 641,025 PROVIDED = 148 Sq.FT.

1779 RAVIZZA AVE, SANTA CLARA, CA

Project:

No. Date Description

NEW SINGLE FAMILY

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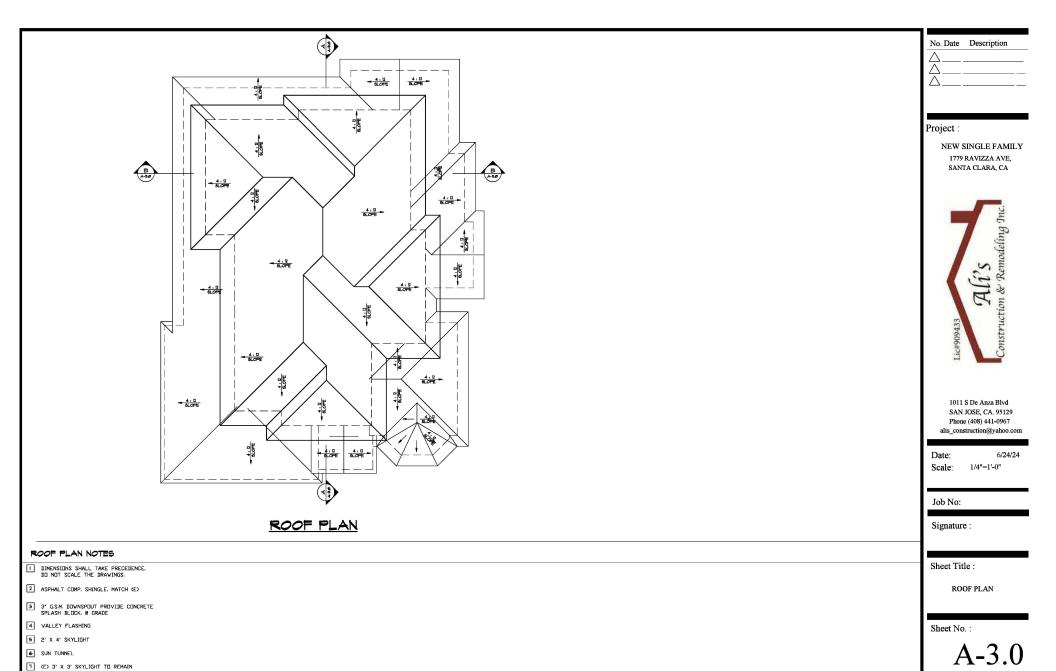
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SECOND FLOOR PLAN


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A-2.1





### FRONT ELEVATION

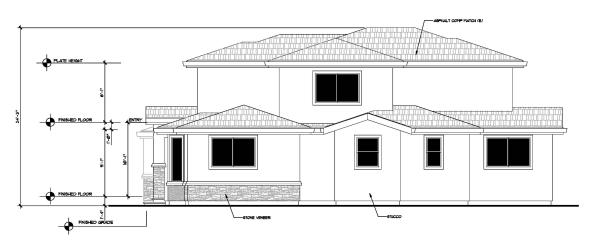

RIGHT SIDE ELEVATION

No. Date	Description	
Δ		
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Δ		_

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Signature :

Sheet Title:

EXTERIOR ELEVATIONS

Sheet No.:

A-4.0



### REAR ELEVATION



LEFT SIDE ELEVATION

No. Date	Description	
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Δ		_
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NEW SINGLE FAMILY 1779 RAVIZZA AVE, SANTA CLARA, CA



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Date:

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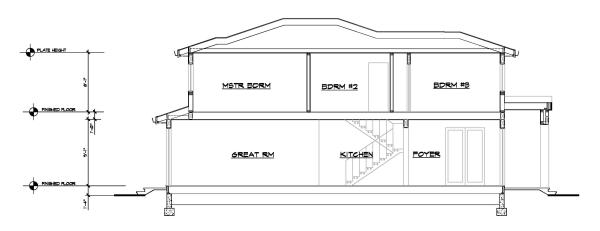
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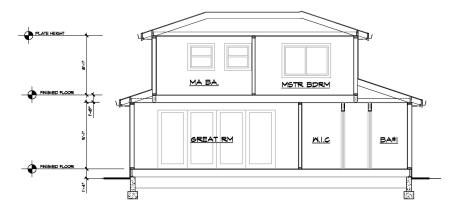
EXTERIOR ELEVATIONS

Sheet No.:

A-4.1



### SECTION A-A



SECTION B-B

No. Date	Description
$\Delta$	
Δ	
Δ	

Project:

NEW SINGLE FAMILY 1779 RAVIZZA AVE, SANTA CLARA, CA



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Sheet Title:

BUILDING SECTOINS

Sheet No.:

A-5.0