RESOLUTION NO. 24-9387

A RESOLUTION OF THE CITY OF SANTA CLARA, CALIFORNIA, TO APPROVE A REZONING FROM PLANNED DEVELOPMENT (PD) TO HEAVY INDUSTRIAL (HI) TO ALLOW THE PROPOSED USE OF HEAVY INDUSTRIAL AT 2201 LAFAYETTE STREET, SANTA CLARA

(File No. PLN23-00208- Rezoning)

WHEREAS, on August 22, 2023, John Ha with Innovative Design Architecture ("Applicant"), on behalf of Cindy Cheng with Vista Grande Investment, LLC ("Owner") filed an application (PLN23-00208) requesting a rezoning for the property located at 2201 Lafayette Street (APN: 224-03-087) ("Project Site") in the City of Santa Clara;

WHEREAS, the General Plan land use designation for the Project Site is Heavy Industrial;

WHEREAS, the Project Site is zoned Planned Development (PD);

WHEREAS, the Project Site is developed with an industrial building that was previously occupied with Union Stone, a construction materials retail showroom and warehouse;

WHEREAS, the Property Owner applied to rezone the Project Site from Planned Development (PD) to Heavy Industrial (HI) to allow the existing building to be used for a heavy industrial business ("Project") as shown on the development plans, attached hereto and incorporated herein by reference;

WHEREAS, the Project is Categorically Exempt from formal environmental review per Section 15301, Class 1 "Existing Facilities" of the Guidelines of the California Environmental Quality Act ("CEQA"), which applies to small additions and minor modifications to existing facilities involving negligible or no expansion of the existing or former use. Here, the proposal involves a minor tenant improvement without changing the building footprint and minor site improvements and would represent a negligible expansion of the prior use;

WHEREAS, on October 30, 2024, a notice of the public hearing on the proposed Rezoning was published in the *The Weekly*, a newspaper of general circulation for the City, for the City Council Hearing to be conducted on November 12, 2024;

Resolution/ 2201 Lafayette Street - Rezoning Rev. / Typed 12-2-22

WHEREAS, on October 31, 2024, the notice of meeting date for this item was mailed to property owners within a 500-foot radius of the Project Site for the City Council hearing on November 12,

2024; and

WHEREAS, on November 12, 2024, the City Council held a duly noticed public hearing to consider the rezoning application, at which time all interested persons were given an opportunity to give testimony and the City Council considered the information presented in the Staff Report and all verbal and written evidence.

NOW THEREFORE, BE IT RESOLVED BY THE CITY OF SANTA CLARA AS FOLLOWS:

1.	That the City Council hereby finds that the above Recitals are true and correct and by this
	reference makes them a part hereof.

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2. That the City Council hereby approves rezoning the Project Site from Planned Development (PD) to Heavy Industrial (HI) to allow the existing buildings on the project site to be used for a heavy industrial business, as depicted on the attached Illustration Plan, incorporated herein by this reference.

3. Effective date. This resolution shall become effective immediately.

I HEREBY CERTIFY THE FOREGOING TO BE A TRUE COPY OF A RESOLUTION PASSED AND ADOPTED BY THE CITY OF SANTA CLARA, CALIFORNIA, AT A REGULAR MEETING THEREOF HELD ON THE 12TH DAY OF NOVEMBER, 2024, BY THE FOLLOWING VOTE:

AYES: COUNCILORS: Becker, Chahal, Hardy, Jain, and Watanabe, and

Mayor Gillmor

NOES: COUNCILORS: None

ABSENT: COUNCILORS: Park

ABSTAINED: COUNCILORS: None

ATTEST:

NORA PIMENTEL, MMC ASSISTANT CITY CLERK CITY OF SANTA CLARA


Attachments Incorporated by Reference:

1. Development Plans

INDUSTRIAL BUILDING RE-ZONING

HEAVY INDUSTRIAL RE-ZONING

2201 LAFAYETTE ST. SANTA CLARA, CA 95051

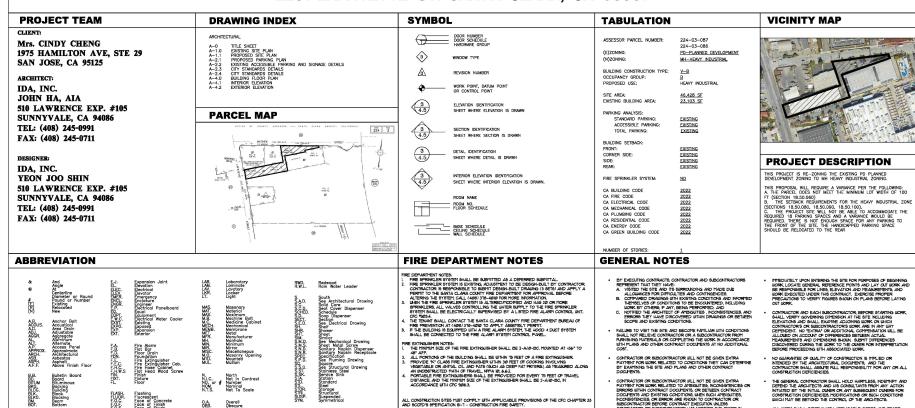

ALL CONSTRUCTION SITES MUST COMPLY WITH APPLICABLE PROVISIONS OF THE CFC CHAPTER 3: AND SCCFD'S SPEIFICATION SI-1 - CONSTRUCTION FIRE SAFETY.

FIRE DEPARTMENT ACCESS TO THE SITE, THE BUILDING, AND TO ALL FIRE PROTECTION SYSTEMS SHALL BE MAINTAINED AT ALL TIMES, IN ACCORDINGE WITH CPC CHAPTER 5.

ANY TITE THE FIRE SPRINKLER SYSTEM IS IMPAIRED, A FIRE WATCH IS TO BE PROVIDED. THE SYSTEM IS TO BE TAGGED, AND A CORRESPONDING IMPAIRMENT PROGRAM IS TO BE PROVIDED FOR THE IMPAIRMENT TO THE PRICE PROTECTION SYSTEM, IN ACCORDANCE WITH CPC CHAPTER 9.

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ALL FINISHES SHALL MEET THE REQUIREMENTS OF CFC AND CBC CHAPTER 8.

EGRESS LIGHTING SHALL NOT BE DIMMED OR CONTROLLED, AND SHALL PROVIDE THE MINIMH I FOOT-CAPILE AT THE WALKING SURFACE FOR ALL EGERSS PATHS, IN ACCORDANCE WITH CFC 160821.

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Threshold
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P.T.D.
P.T.D/R

PTN. P.T.R.

Q.T. QTY.

FLASH. FLUOR. F.O.C. F.O.S. FPRF. FT. FTG. FURR. FUT.

JAN. JT. Janitor Jaint

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- THE DEPERMED SUBMITTAL ITEMS SHALL NOT BE INSTALLED UNTIL THE BUILDING OFFICIAL HAS APPROVED THEIR DESIGN AND SUBMITTAL DOCUMENTS
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- CONTRACTOR SHALL ACCEPT THE SITE AND THE EXISTING SURROUNDING IN THE CONDITIONS IN WHICH THEY EXIST AT THE TIME CONTRACTOR IS GIVEN ACCESS TO BEGIN THE WORK.
- DAYAGE CAUSED BY CONTRACTOR TO EXISTING STRUCTURES, AND WORK BY OTHERS SHALL DE REPAIRED BY CONTRACTOR AND LETT IN AS GOOD CONTROLS AS DESIGNED SEPTOR SEPTORED DAYAGING, INLESS SUCH EXISTING WORK IS SHOUN TO BE REPOYED OR REPLACED BY NEW WORK.
- COPIESTE DOCUMENTATION OF ENSINES CANSTRUCTION IS NOT ANALAGEL DINESSINES, LAND I DIVITIN'S HATISMAL AND CONCRUED CONDITIONS HAVE NOT NECESSARILY DEEN HERRIED AND AREA NOT REPRESENTED TO BE ACCURATE BEYOND THE LEVEL NECESARY TO DESINE THE APPROXIMATE SCOPE OF SURFACE REPOVATION AND SYSTEM FREE, ACCIDENT.

- NO GLIARANTEE OF GUALITY OF CONSTRUCTION IS IMPLIED OR INTENDED BY THE ARCHITECTURAL DOCUMENTS, AND THE CONTRACTOR SHALL ASSUME RILL RESPONSIBILITY FOR ANY OR ALL CONSTRUCTION DEPOIDED.
- ALL BORK SHALL COPPLY BITH APPLICABLE CODES AND TRADE STANDARDS BHICK GOVERN EXCENTRACE OF BORK, INCLIDING BUT NOT LIMITED TO: CALFORNIA BUILDING CODE (CBC), CALFORNIA PECHARICAL CODE (CPC), CALFORNIA ELECTRICAL CODE (CPC), CALFORNIA PLIPBING CODE (CPC), AND ALL APPLICABLE LOCAL CODES AND LEGISLATION.
- ALL PUBLIC IMPROVEMENTS SHALL BE MADE IN ACCORDANCE WITH THE LATEST ADOPTED CITY STANDARDS. THE STORING OF GOODS THE CALEST ADOPTED CITY STANDARDS. THE STORMS OF GOODE AND MATERIALS ON SIDEWALK AND/OR STREET WILL NOT BE ALLOWED WILESS THE CONTRACTOR HAS APPLIED AND SECURED A SPECIAL PERMIT WHICH ALLOW SUCH STORAGE TO BE PLACED.



JOHN HA, AIA 510 LAWRENCE EXPWY.
SUITE # 105
SUNNYVALE, CA 94085
TEL: (408) 245-0991
TEL: (408) 245-0711

Mrs. CINDY CHENG 1975 HAMILTON AVE. STE 29 SAN JOSE, CA 95125 408-369-2929

RE-ZONING

BUILDING

NDUSTRIAL

RE-ZONING 95051 ST. ш 8 LAFAYETT CLARA, SANTA

REVISIONS:	
SHEET TITLE:	
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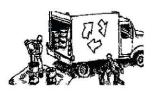
OF SHEETS

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Construction Best Management Practices (BMPs)

Construction projects are required to implement year-round stormwater BMPs.

Materials, Waste, and Sediment Management



Construction Entrances and Perimeter

- Establish and maintain effective perimeter controls, and stabilize all construction entrances and exits to sufficiently control erosion, sediment discharges and tracking of sediment offsite.
- Weep or vacuum immediately any tracking of sediment offsite and secure sediment source to prevent further tracking. Never hose down streets or sidewalks.

Non-Hazardous Materials and Dust Control

- U Berm and cover stockpiles of sand, dirt or other construction material with tarps when rain is forecast or when they are not in use. Weigh down and secure tarps for wind protection.
- Keep materials off the ground (e.g., store bagged materials on wood pallets, store loose materials on tarps not pavement, etc.).
- ☐ Use captured water from other activities (e.g., testing fire lines) for dust control.
- Ensure dust control water doesn't leave site or discharge to storm drains. Only
 use enough to control dust. Contain and dispose of excess water properly.

Hazardous Materials

- Label all hazardous materials and hazardous wastes (such as pesticides, paints, thinners, solvents, fiel, oil, and antifreeze) in accordance with City, County, State and Federal resultation.
- □ Store hazardous materials and wastes in watertight containers, store in appropriate secondary containment, and cover them at the end of every workday, during wet weather or when rain is forceast.
- ☐ Follow manufacturer's application instructions for hazardous materials and do not use more than necessary. Do not apply chemicals outdoors when rain is forcest within 24 hours
- Arrange for appropriate disposal of all hazardous wastes. Have all pertinent Safety Data Sheets (i.e., SDS/MSDS/PSDS) onsite.

Waste Management

- ☐ Inform trash-hauling contractors that you will accept only watertight dumpsters for onsite use. Repair/replace any dumpster that is not watertight or leaking.
- Cover and maintain dumpsters. Check frequently for leaks. Place dumpsters under roofs or cover with tarps or plastic sheeting secured around the outside of the dumpster. If the dumpster leaks, place a plastic liner undermeath the dumpster to collect leaks. Never clean out a dumpster by hosing it down on the construction site clean with dry methods, clean offsite or replace dumpster.
- Place portable toilets and hand wash stations away from storm drains. Make sure they are equipped with containment pans (secondary containment) and are in good working order. Check frequently for leaks.
- □ Dispose of all wastes and demolition debris properly per SDS and applicable regulations. Recycle or compost materials and wastes as feasible and appropriate, including solvents, water-based paints, vehicle fluids, broken asphalt and concrete, wood, and cleared vecetation.
- Dispose of liquid residues from paints, thinners, solvents, glues, and cleaning fluids as hazardous waste per SDS.
- Keep site free of litter (e.g., lunch items, water bottles, eigarctic butts and plastic packaging).
- Prevent litter from uncovered loads by covering loads that are being transported to and from site.

Equipment Management & Spill Control



Vehicle and Equipment Maitenance

- □ Designate an area of the construction site equipped with appropriate BMPs, well away from creeks or storm drain inlets, for auto and equipment parking and storage.
- Perform major maintenance, repair jobs, and vehicle/equipment washing offsite.
- ☐ If refueling or vehicle maintenance must be done onsite, work in a bermed area away from storm drains and over a drip pan or drop cloths big enough to collect fluids. Recycle or dispose of fluids as hazardous waste.
- If vehicle or equipment cleaning must be done onsite, clean with water only in a bermed area that will not allow rinse water to run into gutters, streets, storm drains, or creeks.
- Do not clean vehicles or equipment onsite using soaps, solvents, degreasers, or steam cleaning equipment, and do not use diesel oil to lubricate equipment or parts onsite.

Spill Prevention and Control

- Always keep spill cleanup materials (e.g., rags, absorbents, and cat litter) available at the construction site.
- Maintain all vehicles and heavy equipment.
 Inspect frequently for leaks. Use drip pans to eatch leaks until repairs are made.
- Clean up leaks, drips and other spills immediately using dry cleanup methods whenever possible (absorbent materials, eat litter and/or rags) and dispose of cleanup materials properly.
- Sweep up spilled dry materials immediately.
 Never attempt to "wash them away" with water or bury them.
- Clean up spills on dirt areas by digging up and properly disposing of contaminated soil.
- □ Report significant spills to the appropriate local spill response agencies immediately. If the spill posses a significant hazard to human health and safety, property or the environment, report it to the State Office of Emergency Services at (800) 852-7550 (24 hours).

Earthmoving



Grading and Earthwork

- Schedule grading and excavation work during dry weather.
- □ Prevent sediment from migrating offsite and protect storm drain inlets, drainage courses and erecks by installing and maintaining appropriate BMPs tailored to the site's specific characteristics and conditions. Examples of such BMPs may include sith fences, gravel bags, fiber rolls, temporary swales, compost socks, etc. Ensure that BMPs are installed in accordance with manufacturer's specifications and properly maintained throughout the duration of construction activities.
- U Stabilize all denuded areas and install and maintain temporary erosion controls (such as erosion control fabric or bonded fiber matrix) until vegetation is established.
- □ Remove existing vegetation only when necessary. Plant temporary vegetation to prevent erosion on slopes or in areas where construction is not immediately planned.
- Keep excavated soil and/or transfer it to dump trucks, onsite, not in the streets.
- Ensure all subcontractors working onsite are implementing appropriate BMPs.

Contaminated Soils

- ☐ If any of the following conditions are observed, test for contamination and contact the Regional Water Outility Control Burnf and the local agency 1) Unusual soil conditions, discoloration, or odor. 2) Abandoned underground tunks. 3) Abandoned wells, 4) Burnful barrels, debris, or trask.
- □ If the above conditions are observed, document any signs of potential contamination, clearly mark areas and fence/upe them off so they are not disturbed by construction activities.

Landscaping

- Protect stockpiled landscaping materials from wind and rain by storing them under tarps year-round.
- Stack bagged material on pallets and under cover.
 Discontinue application of any evoluble landscape
- Discontinue application of any erodible landscape material within 2 days before a forecast rain event or during wet weather.
- ☐ Store materials onsite, not in the street.

Concrete Management & Dewatering



Concrete Management

- Store both dry and wet concrete-related materials under cover, protected from rainfall and runoff and away from storm drains or creeks. Store materials off the ground on pallets. Protect dry materials from wind.
- Avoid pouring concrete in wet weather or when rainfall is imminent to prevent concrete that has not cured from contacting stormwater runoff.
- Wash out concrete equipment/mixers/trueks offsite, or onsite only in designated washout containers/areas where the water will flow into a temporary lined waste pit and in a manner that will prevent leaching into the underlying soils. (See CASQA Construction Stormwater BMP Handbook for temporary concrete washout facility details).
- Do not wash sweepings from exposed aggregate concrete into the street or storm drain. Collect and return sweepings to aggregate base stockpile or dispose properly.
- Make sure that construction waste (e.g., concrete, stucco, cement wastewater, or residual materials) is collected, removed, and disposed of only at authorized disposal areas. Do not dispose of construction waste in storm drains, ditches, streets, creeks, dirt areas, or the sanitary sewer.

Dewatering

- □ Discharges of groundwater or captured runoff from dewatering operations must be properly managed and disposed. When possible, send dewatering discharge to landscaped area or similarly sewer. If discharging to the sanitary sewer, obtain permission from the local wastewater treatment plant.
- Divert water originating from offsite away from all onsite disturbed areas.
- □ When dewatering, notify and obtain approval from the local municipality before discharging water to a street gutter or storm drain. Filtration or diversion through a basin, tank, or sediment trap may be required.
- □ In areas of known or suspected contamination, eall the local agency to determine whether the groundwater must be tested. Pumped groundwater may need to be collected and hauled offsite for treatment and proper disposal.
- For additional information, refer to the CASQA's Construction Stormwater BMP Handbook, Fact Sheet NS-2 "Dewatering Operations."

Paving/Asphalt Work



Paving

- Avoid paving and seal coating in wet weather or when rain is forecast to prevent materials that have not cured from contacting with stormwater runoff.
- Cover storm drain inlets and manholes when applying seal coat, slurry seal, fog seal, or similar materials.
- When construction is complete, remove all covers from storm drain inlets and manholes.
- □ Collect and recycle or properly dispose of excess abrasive gravel or sand. Do NOT sweep or wash it into gutters, storm drains, streets, dirt areas, or the saniiary sewer.

Sawcutting & Asphalt/Concrete Removal

- □ Protect storm drain inlets during saw cutting.
- When making saw cuts, use as little water as possible.
- Residue from saw cutting, coring and grinding operations shall be picked up by means of a vacuum device.
- □ Shovel, absorb, or vacuum saw cut slurry deposits and dispose of all waste properly and as soon as reasonably possible. Sawcutting residue should not be left on payement surface.
- If saw cut slurry enters a storm drain inlet, clean it up immediately and notify the local municipality.

Painting & Paint Removal




Painting Cleanup and Removal


- Wever clean brushes or rinse paint containers to landscaping, dirt areas or into a street, gutter, storm drain, or creek.
- □ For water-based paints, paint out brushes to the extent possible, and then rinse into a drain connected to the sanitary sewer. Never pour paint down a storm drain inlet.
- ☐ For oil-based paints, paint out brushes to the extent possible, and then clean with thinner or solvent in a proper container. Filter and reuse thinners and solvents. Dispose of excess liquids as hazardous waste.
- Sweep up or collect paint chips and dust generated from non-hazardous dry stripping and sand blasting into plastic drop cloths and dispose of as trash.
- Chemical paint stripping residue and chips and dust from marine paints or paints containing lead, mercury, or tributyltin must be disposed of as hazardous waste. I cad- based paint removal requires a state-certified contractor.


Storm drain polluters may be liable for fines of up to \$10,000 per day!





February 2024

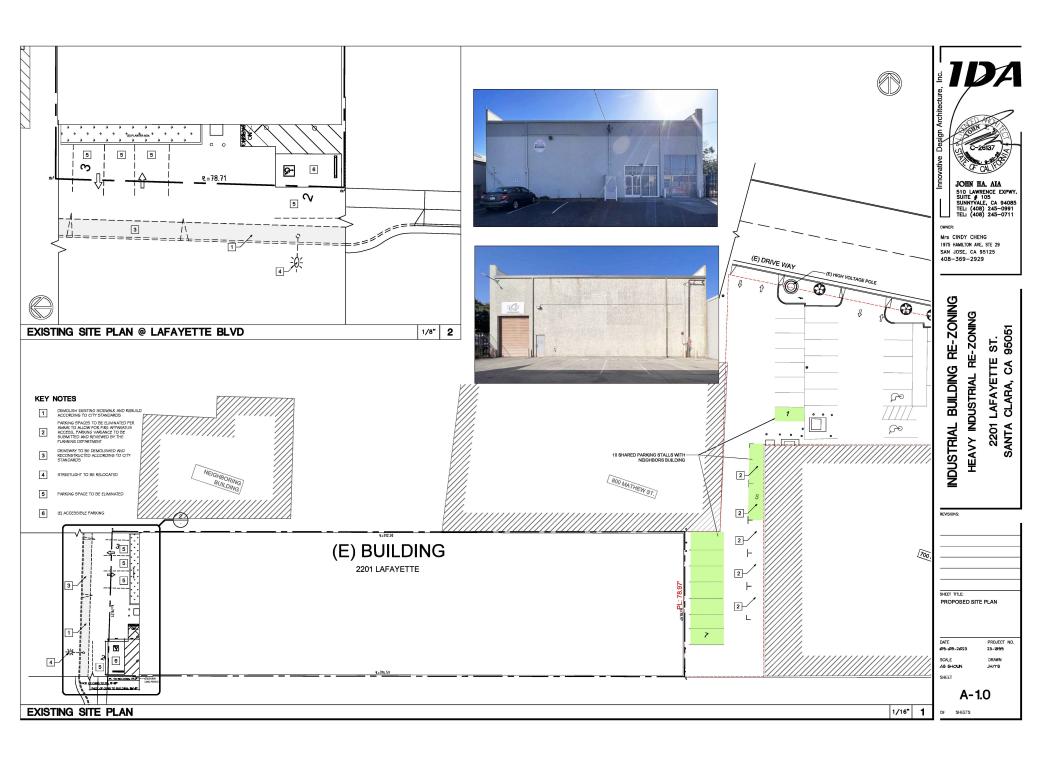

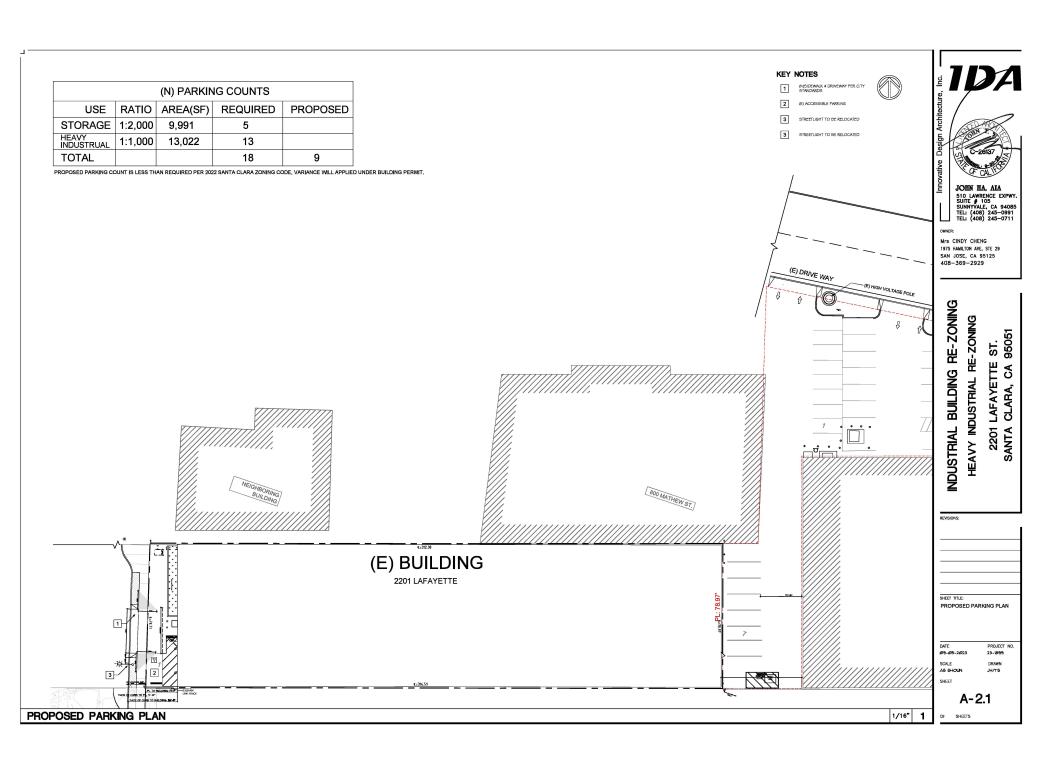

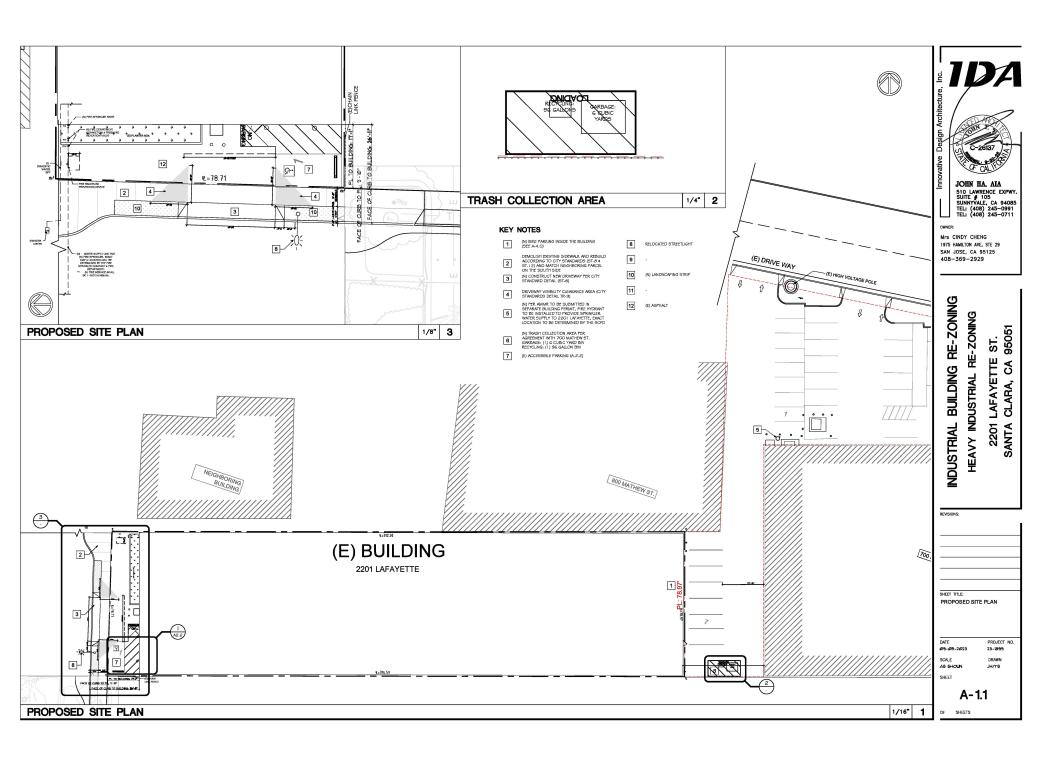

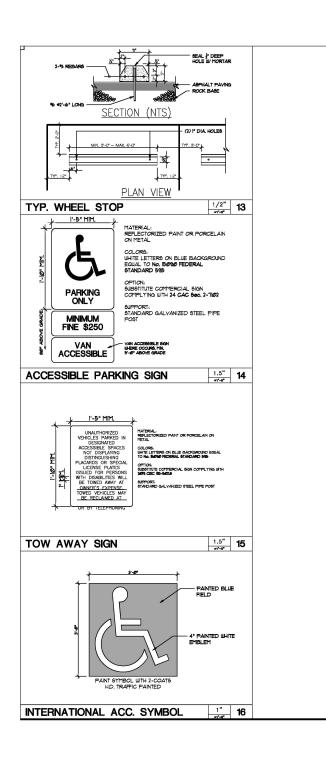

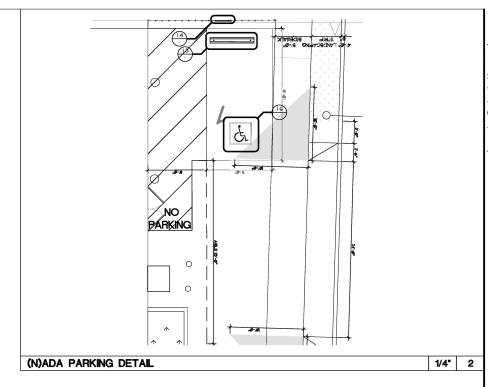



HEAVY INDUSTRIAL RE-ZONING ST. 95051 LAFAYETTE (CLARA, CA 9

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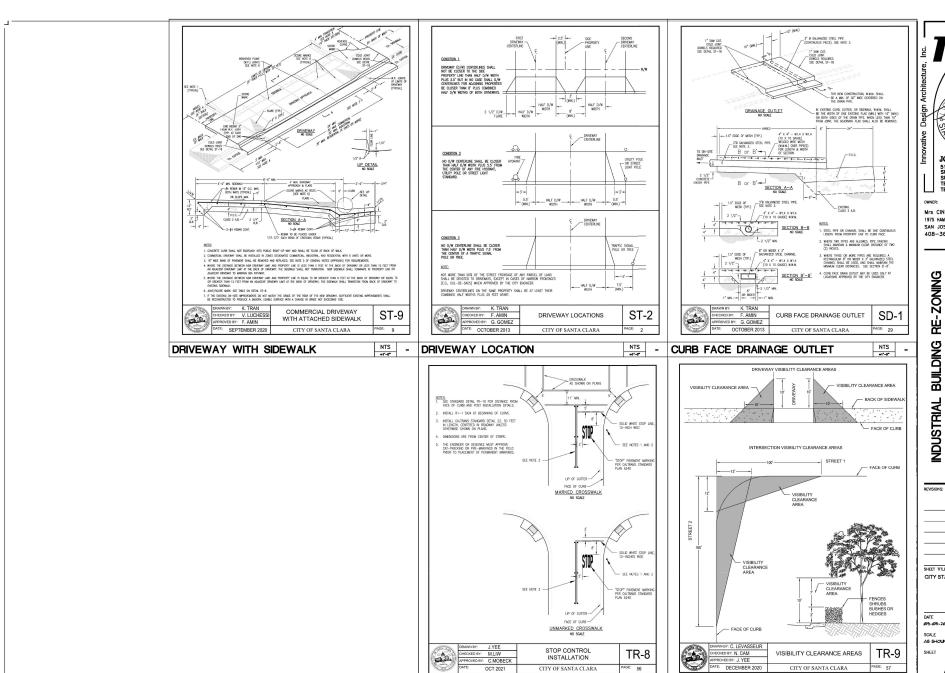
JOHN HA, AIA 510 LAWRENCE EXPWY.
SUITE # 105
SUNNYVALE, CA 94085
TEL: (408) 245-0991
TEL: (408) 245-0711

(E)ACCESSIBLE PARKING AND SIGNAGE DETAILS DATE PROJECT NO. AS SHOUN

A-2.2

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OF SHEETS



DRIVEWAY WITH/WITHOUT SIDEWALK NTS



RE-ZONING

LAFAYETTE S HEAVY INDUSTRIAL 2201 SANTA

95051


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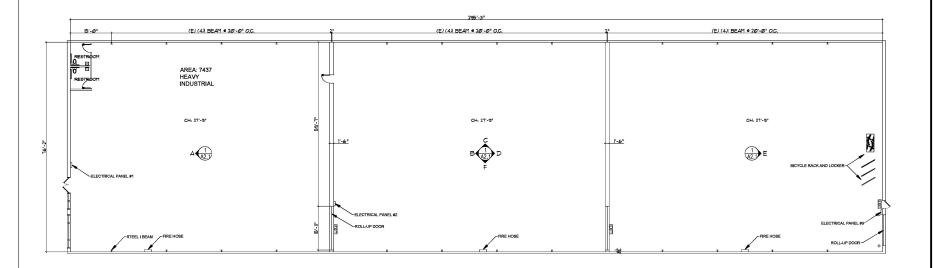
SHEET TITLE: CITY STANDARD DETAILS PROJECT NO AS SHOWN JH/YS A-2.3 OF SHEETS

NTS

VISIBILITY CLEARANCE AREAS

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JOHN HA. AIA 510 LAWRENCE EXPWY. SUITE # 105 SUNNYVALE, CA 94085 TEL: (408) 245-0991 TEL: (408) 245-0711

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INDUSTRIAL BUILDING RE-ZONING HEAVY INDUSTRIAL RE-ZONING

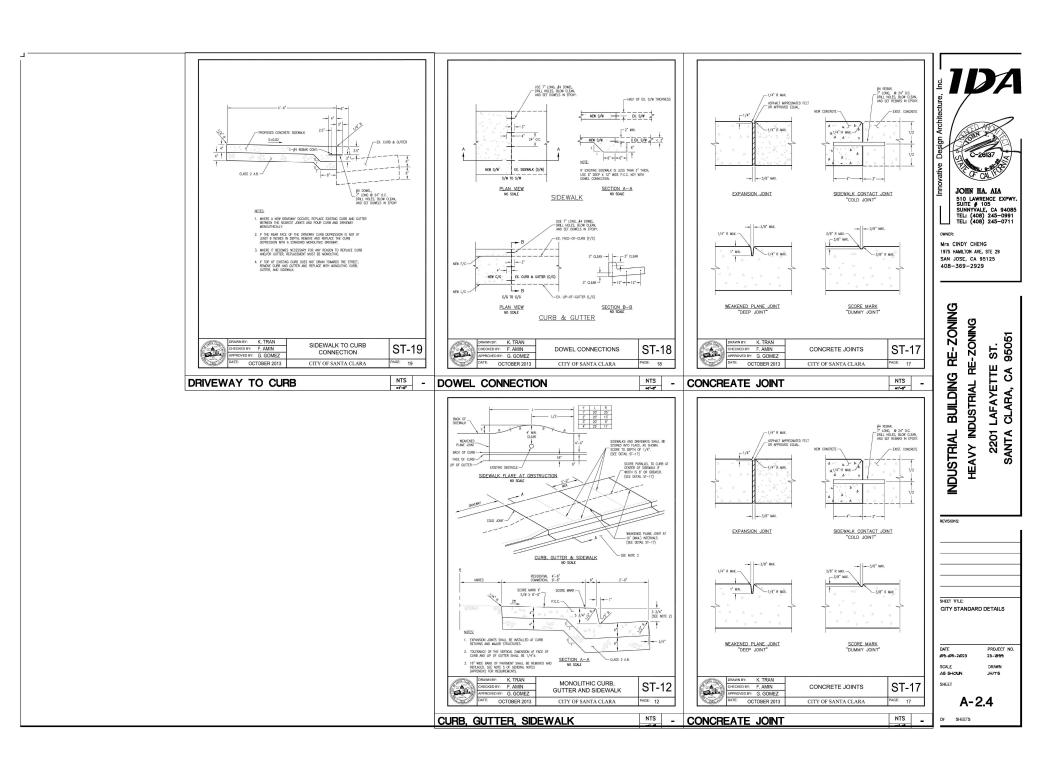2201 LAFAYETTE BLVD. SANTA CLARA, CA 95051

SHEET TITLE:

EXISTING BUILDING PLAN

DATE Ø3-Ø5-2Ø23 SCALE AS SHOWN


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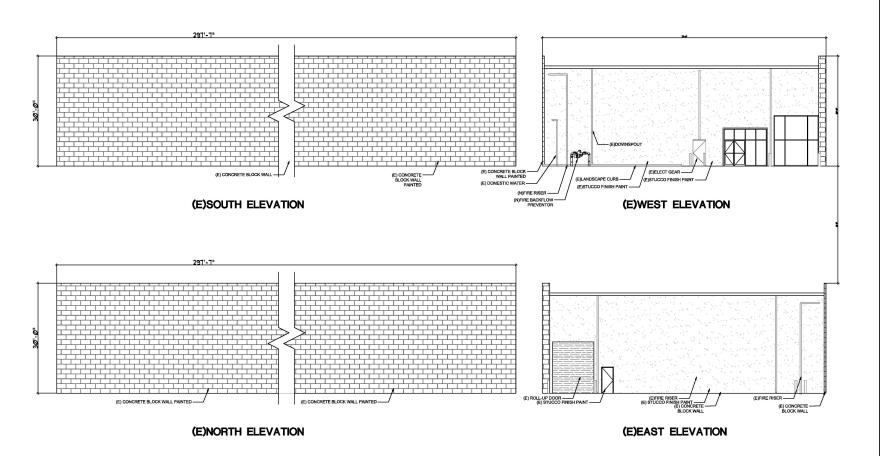
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A-4.0 OF SHEETS

BUILDING PLAN

3/32" 1



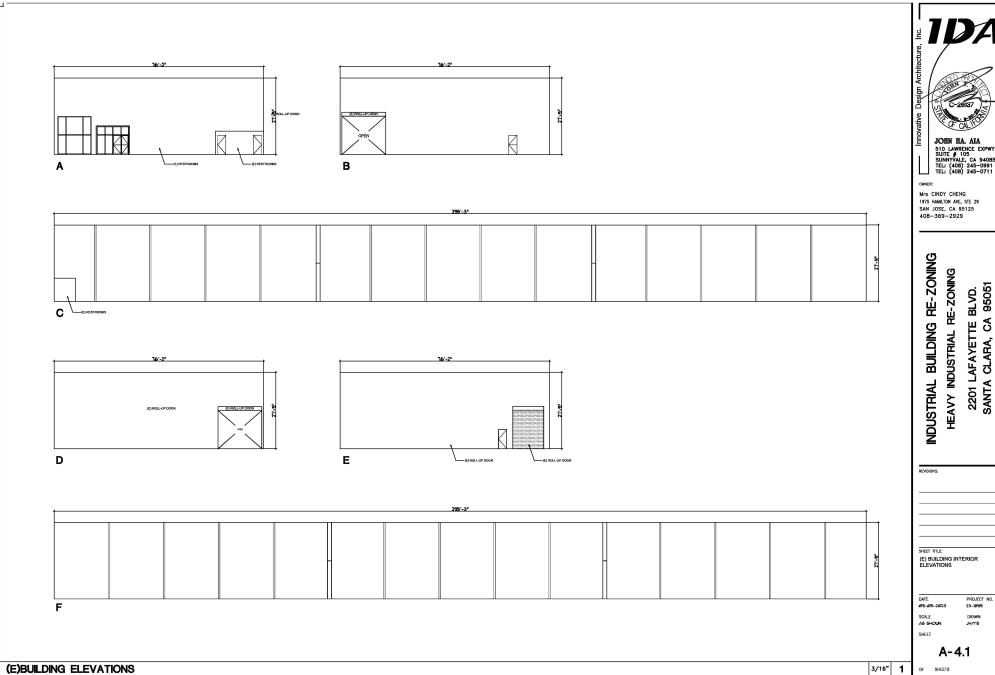

Mrs CINDY CHENG 1975 HAMILTON AVE, STE 29 SAN JOSE, CA 95125 408-369-2929

INDUSTRIAL BUILDING RE-ZONING HEAVY INDUSTRIAL RE-ZONING

2201 LAFAYETTE BLVD. SANTA CLARA, CA 95051

(E)BUILDING EXTERIOR ELEVATIONS

PROJECT NO.

SCALE AS SHOWN SHEET

A-4.2

OF SHEETS