

PROJECT RAPTOR

2305 MISSION COLLEGE BOULEVARD SANTA CLARA, CALIFORNIA 95054

PROJECT TEAM

CLIENT	GENERAL CONTRACTOR	ARCHITECT	STRUCTURAL ENGINEER	MECHANICAL ENGINEER	ELECTRICAL ENGINEER	CIVIL ENGINEER	LANDSCAPE ARCHITECT	GEOTECH ENGINEER
ALIGNED DATA CENTERS LLC 80 Banker Avenue Dorsey, CT 06810	SKANAKA USA BUILDING INC 1889 HARRISON ST #1800 OAKLAND, CA 94612 TEL: 910-235-1084 BOB FINNEY	CAC ARCHITECTS 400 BRANNAN STREET, SUITE NO. 1 SAN FRANCISCO, CA 94107 TEL: 415-402-0000 TED WAVE	PEOPLES ASSOCIATES STRUCTURAL ENGINEERS 1989 SWANSON ST MILPITAS, CA 95035 TEL: 408-957-9229 WALT ROYDSON	SOUTHLAND INDUSTRIES MECHANICAL ENGINEERS 23225 WESTERN AVENUE LARKIN CITY, CA 94027 TEL: 310 477 3300 TOMY SAKAGUCHI	ALFATECH 1321 REDDICK PARK DR #20 SAN JOSE, CA 95131 TEL: 408 487 1500 MARK FISHER	XIER & WRIGHT 3300 SCOTT BLVD #202 SANTA CLARA, CA 95054 TEL: 408-727-6865 NICKINOS MATHEOS	TANGUCHI LANDSCAPE ARCHITECTURE 1513 SOUTH CLAREMONT SAN MATEO, CA 94402 TEL: 650-438-9993 DONNE TANIGUCHI	CORNERSTONE EARTH GROUP GEOTECHNICAL 1270 SPOFFORD ROAD STE 101 WALNUT CREEK, CA TEL: 925 938 9900 WYTHEW SWAFFER

PROJECT TEAM

PROJECT DATA


SCOPE OF WORK	TYPE OF CONSTRUCTION:	IB
New 2 level, 495,810 SF data center on a 15.7 acre site bordered by Mission College Boulevard, San Tomas Creek, Agnew Road and existing commercial buildings. The site development includes a generator yard, equipment yard, underground water storage and parking for 71 cars. Part of the site will be used for a Silicon Valley Power substation that will be dedicated to this project.	NUMBER OF STORIES	2
	HEIGHT (TOP OF ROOF)	58'-1" +/-
	LEVEL 1	201,489 SF
	LEVEL 1 MEZZANINE	46,329 SF
	LEVEL 2	202,870 SF
	LEVEL 2 MEZZANINE	44,922 SF
	TOTAL	495,610 +/-
	TOTAL SITE AREA	15.7 ACRES (684,990 +/- SF)
	ZONING DISTRICT	ML (LIGHT INDUSTRIAL)
	HEIGHT LIMIT	70'

DRAWING INDEX

ARCHITECTURAL	CIVIL	LANDSCAPE
A0.0 COVER SHEET & PROJECT DATA	C1.0 TOPOGRAPHIC SURVEY	L-1 SCHEMATIC LANDSCAPE PLAN
A0.1 ARCHITECTURAL SITE PLAN	C2.0 OVERALL SITE PLAN	L-2 IRRIGATION HYDROZONE PLAN
A1.1 LEVEL 1 PLAN	C3.0 FIRE ACCESS PLAN	L-3 IRRIGATION HYDROZONE PLAN
A1.2 LEVEL 1 MEZZANINE PLAN	C4.0 GRADING AND DRAINAGE PLAN	
A2.1 LEVEL 2 PLAN	C5.0 UTILITY PLAN	ELECTRICAL
A2.2 LEVEL 2 MEZZANINE PLAN	C6.0 STORMWATER CONTROL PLAN	E.1 SITE LIGHTING PLAN
A3.0 LEVEL 2 MEZZANINE PLAN	C6.1 STORMWATER CONTROL DETAILS	
A7.1 ELEVATIONS		
A7.2 DETAILS/PERSPECTIVES		
A8.0 ALTERNATE PARKING PLAN		

AGENCY APPROVAL

VICINITY MAP

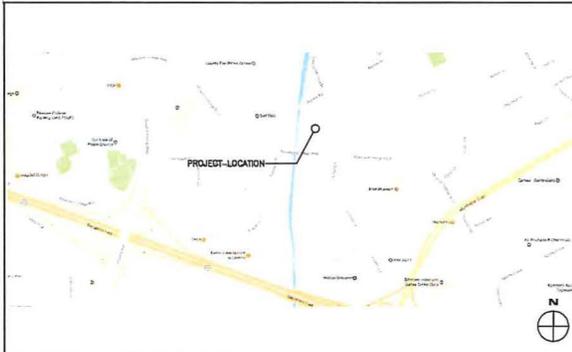

OVERALL AREA RENDERING



MAIN ENTRANCE RENDERING



PROJECT



ALIGNED DATA CENTERS
 PROJECT RAPTOR
 2305 MISSION COLLEGE BLVD
 SANTA CLARA, CA 95054

CAC PROJECT NO. 11222

REVISIONS
 1 RESPONSE TO PCC COMMENTS 05/09/2017

KEY PLAN & NORTH ARROW

DATE 2017-02-06

SCALE

DRAWING TITLE

COVER SHEET AND PROJECT DATA

SHEET NO.

A0.0

3" = 120'
 1" = 102' = 102'
 1" = 100'
 1" = 100'
 3/8" = 100'
 1/2" = 100'
 3/4" = 100'
 1" = 100'
 1 1/2" = 100'

PROJECT TEAM

AGENCY APPROVAL

PROJECT

ALIGNED
 DATA CENTERS
 PROJECT RAPTOR
 2305 MISSION COLLEGE BLVD
 SANTA CLARA, CA 95054

CAC PROJECT NO. 11222

REVISIONS
 1 RESPONSE TO PCC COMMENTS 04/09/17

KEY PLAN & NORTH ARROW

DATE 03-21-2017
 SCALE 1/32" = 1'-0"
 DRAWING TITLE

LEVEL 1 PLAN

SHEET NO.

A1.1

1/8" = 1'-0"
 1/16" = 1'-0"
 1/32" = 1'-0"
 1/64" = 1'-0"
 1/128" = 1'-0"
 1/256" = 1'-0"
 1/512" = 1'-0"
 1/1024" = 1'-0"
 1/2048" = 1'-0"
 1/4096" = 1'-0"
 1/8192" = 1'-0"
 1/16384" = 1'-0"
 1/32768" = 1'-0"
 1/65536" = 1'-0"
 1/131072" = 1'-0"
 1/262144" = 1'-0"
 1/524288" = 1'-0"
 1/1048576" = 1'-0"
 1/2097152" = 1'-0"
 1/4194304" = 1'-0"
 1/8388608" = 1'-0"
 1/16777216" = 1'-0"
 1/33554432" = 1'-0"
 1/67108864" = 1'-0"
 1/134217728" = 1'-0"
 1/268435456" = 1'-0"
 1/536870912" = 1'-0"
 1/1073741824" = 1'-0"
 1/2147483648" = 1'-0"
 1/4294967296" = 1'-0"
 1/8589934592" = 1'-0"
 1/17179869184" = 1'-0"
 1/34359738368" = 1'-0"
 1/68719476736" = 1'-0"
 1/137438953472" = 1'-0"
 1/274877906944" = 1'-0"
 1/549755813888" = 1'-0"
 1/1099511627776" = 1'-0"
 1/2199023255552" = 1'-0"
 1/4398046511104" = 1'-0"
 1/8796093022208" = 1'-0"
 1/17592186044416" = 1'-0"
 1/35184372088832" = 1'-0"
 1/70368744177664" = 1'-0"
 1/140737488355328" = 1'-0"
 1/281474976710656" = 1'-0"
 1/562949953421312" = 1'-0"
 1/1125899906842624" = 1'-0"
 1/2251799813685248" = 1'-0"
 1/4503599627370496" = 1'-0"
 1/9007199254740992" = 1'-0"
 1/18014398509481984" = 1'-0"
 1/36028797018963968" = 1'-0"
 1/72057594037927936" = 1'-0"
 1/144115188075855872" = 1'-0"
 1/288230376151711744" = 1'-0"
 1/576460752303423488" = 1'-0"
 1/1152921504606846976" = 1'-0"
 1/2305843009213693952" = 1'-0"
 1/4611686018427387904" = 1'-0"
 1/9223372036854775808" = 1'-0"
 1/18446744073709551616" = 1'-0"
 1/36893488147419103232" = 1'-0"
 1/73786976294838206464" = 1'-0"
 1/147573952589676412928" = 1'-0"
 1/295147905179352825856" = 1'-0"
 1/590295810358705651712" = 1'-0"
 1/1180591620717411303424" = 1'-0"
 1/2361183241434822606848" = 1'-0"
 1/4722366482869645213696" = 1'-0"
 1/9444732965739290427392" = 1'-0"
 1/18889465931478580854784" = 1'-0"
 1/37778931862957161709568" = 1'-0"
 1/75557863725914323419136" = 1'-0"
 1/151115727451828646838272" = 1'-0"
 1/302231454903657293676544" = 1'-0"
 1/604462909807314587353088" = 1'-0"
 1/1208925819614629174706176" = 1'-0"
 1/2417851639229258349412352" = 1'-0"
 1/4835703278458516698824704" = 1'-0"
 1/9671406556917033397649408" = 1'-0"
 1/19342813113834066795298816" = 1'-0"
 1/38685626227668133590597632" = 1'-0"
 1/77371252455336267181195264" = 1'-0"
 1/154742504910672534362390528" = 1'-0"
 1/309485009821345068724781056" = 1'-0"
 1/618970019642690137449562112" = 1'-0"
 1/1237940039285380274899124224" = 1'-0"
 1/2475880078570760549798248448" = 1'-0"
 1/4951760157141521099596496896" = 1'-0"
 1/9903520314283042199192993792" = 1'-0"
 1/19807040628566084398385987584" = 1'-0"
 1/39614081257132168796771975168" = 1'-0"
 1/79228162514264337593543950336" = 1'-0"
 1/158456325028528675187087900672" = 1'-0"
 1/316912650057057350374175801344" = 1'-0"
 1/633825300114114700748351602688" = 1'-0"
 1/1267650600228229401496703205376" = 1'-0"
 1/2535301200456458802993406410752" = 1'-0"
 1/5070602400912917605986812821504" = 1'-0"
 1/10141204801825835211973625643008" = 1'-0"
 1/20282409603651670423947251286016" = 1'-0"
 1/40564819207303340847894502572032" = 1'-0"
 1/81129638414606681695789005144064" = 1'-0"
 1/162259276832213363915578010288128" = 1'-0"
 1/324518553664426727831156020576256" = 1'-0"
 1/649037107328853455662312041152512" = 1'-0"
 1/1298074214657707111324624082305024" = 1'-0"
 1/2596148429315414222649248164610048" = 1'-0"
 1/5192296858630828445298496329220096" = 1'-0"
 1/10384593717261656890596996584440192" = 1'-0"
 1/20769187434523313781193993168880384" = 1'-0"
 1/41538374869046627562387986337760768" = 1'-0"
 1/83076749738093255124775972675521536" = 1'-0"
 1/166153499476186510249551945351042752" = 1'-0"
 1/332306998952373020499103890702085504" = 1'-0"
 1/664613997904746040998207781404171008" = 1'-0"
 1/1329227995809492081996415562808342016" = 1'-0"
 1/26584559916189841639928311256166844032" = 1'-0"
 1/53169119832379683279856622512336888064" = 1'-0"
 1/106338239664759366559713245024677760" = 1'-0"
 1/212676479329518733119426490049355520" = 1'-0"
 1/425352958659037466238852980098711040" = 1'-0"
 1/850705917318074932477705960197422080" = 1'-0"
 1/1701411834636149864955411920394844160" = 1'-0"
 1/3402823669272299729910823840789688320" = 1'-0"
 1/6805647338544599459821647681579376640" = 1'-0"
 1/13611294677089198919643295363158753280" = 1'-0"
 1/27222589354178397839286590726317506560" = 1'-0"
 1/54445178708356795678573181452635013120" = 1'-0"
 1/108890357416713591357146362905270026240" = 1'-0"
 1/217780714833427182714292725810540052480" = 1'-0"
 1/435561429666854365428585451620800104960" = 1'-0"
 1/871122859333708730857170903241600209920" = 1'-0"
 1/1742245718667417461714341806483200419840" = 1'-0"
 1/3484491437334834923428683612966400839680" = 1'-0"
 1/6968982874669669846857367225932801679360" = 1'-0"
 1/13937965749339339693714734451865603358720" = 1'-0"
 1/27875931498678679387429469003731206717440" = 1'-0"
 1/55751862997357358774885898007462413434880" = 1'-0"
 1/111503725994714717549771796014924826869760" = 1'-0"
 1/223007451989429435099543592029849653739520" = 1'-0"
 1/446014903978858870199087184059699307479040" = 1'-0"
 1/892029807957717740398174368119398614958080" = 1'-0"
 1/178405961591543548079634873623797229916160" = 1'-0"
 1/356811923183087096159269747247594459832320" = 1'-0"
 1/713623846366174192318539494495188919664640" = 1'-0"
 1/14272476927323483846370789889903778332800" = 1'-0"
 1/28544953854646967692741579779807556665600" = 1'-0"
 1/570899077092939353854831595596151133312000" = 1'-0"
 1/1141798154185878707709663191192302266624000" = 1'-0"
 1/2283596308371757415419326382384604533248000" = 1'-0"
 1/4567192616743514830838652764769209066480000" = 1'-0"
 1/9134385233487029661677305529538418132960000" = 1'-0"
 1/18268770466974059323354611059076836265920000" = 1'-0"
 1/36537540933948118646709222118153672531840000" = 1'-0"
 1/73075081867896237293418444236307345063680000" = 1'-0"
 1/146150163735792474586836888472614690127360000" = 1'-0"
 1/292300327471584949173673776945229380254720000" = 1'-0"
 1/584600654943169898347347553890458760509440000" = 1'-0"
 1/1169201309886339796694695107780917521018880000" = 1'-0"
 1/2338402619772679593389390215561835042037760000" = 1'-0"
 1/4676805239545359186778780431123670084075520000" = 1'-0"
 1/9353610479090718373557560862247340168151040000" = 1'-0"
 1/18707220958181436741115121724494680336302080000" = 1'-0"
 1/37414441916362873482230243448989360672604160000" = 1'-0"
 1/74828883832725746964460486897978721345208320000" = 1'-0"
 1/14965776766545149328892097379595744269041600000" = 1'-0"
 1/299315535330902986577841947591914893378083200000" = 1'-0"
 1/598631070661805973155683895183829887576166400000" = 1'-0"
 1/1197262141323611946311367790367659755152332800000" = 1'-0"
 1/2394524282647223892622735580735319510304665600000" = 1'-0"
 1/47890485652944477852454711614706390206093312000000" = 1'-0"
 1/95780971305888955704909423229412780412186624000000" = 1'-0"
 1/191561942611777911409818846458825560824373248000000" = 1'-0"
 1/383123885223555822819637692917651136448746496000000" = 1'-0"
 1/766247770447111645639275385835302272897492960000000" = 1'-0"
 1/1532495540894223291278550771670604545794985920000000" = 1'-0"
 1/3064991081788446582557101543341209091589971840000000" = 1'-0"
 1/6129982163576893165114203086682418183179943680000000" = 1'-0"
 1/12259964327153786330228406173644836366359887360000000" = 1'-0"
 1/24519928654307572660456812347289672732719774720000000" = 1'-0"
 1/49039857308615145320913624694579345465439548480000000" = 1'-0"
 1/98079714617230290641827249389158690930879096960000000" = 1'-0"
 1/1961594292444605812836544987783173818617579193600000000" = 1'-0"
 1/3923188584889211625673089975566347637235155387200000000" = 1'-0"
 1/7846377169778423251346179951132695274470310774400000000" = 1'-0"
 1/15692754339556846502692359902265388488940621548800000000" = 1'-0"
 1/31385508679113693005384719804530776977881243097600000000" = 1'-0"
 1/62771017358227386010769439609061553955762486195200000000" = 1'-0"
 1/125542034716454772021538879218123107911524972390400000000" = 1'-0"
 1/251084069432909544043077758436246215823049944780800000000" = 1'-0"
 1/502168138865819088086155516872492436446099889561600000000" = 1'-0"
 1/10043362777316381761723110377449848728921997791232000000000" = 1'-0"
 1/20086725554632763523446220754899697457843995582464000000000" = 1'-0"
 1/40173451109265527046892441509799394915687991164928000000000" = 1'-0"
 1/80346902218531054093784883019598789831375982329856000000000" = 1'-0"
 1/160693804437062108187569766039197579662751964659712000000000" = 1'-0"
 1/321387608874124216375139532078395159325503929319424000000000" = 1'-0"
 1/642775217748248432750279064156790318651007858638848000000000" = 1'-0"
 1/1285550435496496865500558128313580637302015717277696000000000" = 1'-0"
 1/2571100870992993731001116256627167464604034345555520000000000" = 1'-0"
 1/5142201741985987462002232513254339289208068691111040000000000" = 1'-0"
 1/10284403483971974924004465026508678578161377382222080000000000" = 1'-0"
 1/20568806967943949848008930053017357156322754644444160000000000" = 1'-0"
 1/41137613935887899696017860106034714312645509288888320000000000" = 1'-0"
 1/82275227871775799392035720212069428625291018577776640000000000" = 1'-0"
 1/164550457743551598784071440424138857250582037155553280000000000" = 1'-0"
 1/3291009154871031975681428808482777145011607423111106560000000000" = 1'-0"
 1/658201830974206395136285761696555429002321444622221212160000000000" = 1'-0"
 1/13164036619484127902725715233931108180046428884444424242240000000000" = 1'-0"
 1/26328073238968255805451430467862216360092857768888848484480000000000" = 1'-0"
 1/52656146477936511610902860935724432720185755537777697776960000000000" = 1'-0"
 1/105312292955873023221805721871448654440371511075555355535200000000000" = 1'-0"
 1/2106245859117460464436114437428928888074302211511111111110400000000000" = 1'-0"
 1/42124917182349209288722288748578577614860444222222222222208000000000000" = 1'-0"
 1/84249834364698418577444577497157152289728828444444444444416000000000000" = 1'-0"
 1/168499668729396837154888949994311455794567688888888888888832000000000000" = 1'-0"
 1/336999337458793674309777899988228111159189133777777777777640000000000000" = 1'-0"
 1/673998674917587348619555799976456222318378267555555555554800000000000000" = 1'-0"
 1/1347997349835174697239111599952912446376755135111111111119600000000000000" = 1'-0"
 1/2695994699670349394478223199905824892753510222222222223920000000000000000" = 1'-0"
 1/539198939934069878895644639981165778550700444444444447840000000000000000" = 1'-0"
 1/1078397879868139757791289279962331511101400888888888896800000000000000000" = 1'-0"
 1/2156795759736279515582578559324663022202801777777777936000000000000000000" = 1'-0"
 1/4313591519472559031164557118649326044405635555555587200000000000000000000" = 1'-0"
 1/8627183038945118062329114373298652088811111111744000000000000000000000000" = 1'-0"
 1/17254366077890236124658228746597041777222222222222222222222400000000000000" = 1'-0"
 1/34508732155780472249316457493194083554444444444444444444444800000000000000" = 1'-0"
 1/69017464311560944498632914986388171088888888888888888888889600000000000000" = 1'-0"
 1/138034928623121888977265829972776342177777777777777777777779200000000000000" = 1'-0"
 1/276069857246243777954531659545546684355555555555555555555584000000000000000" = 1'-0"
 1/552139714492487555909063319091093687111111111111111111111168000000000000000" = 1'-0"
 1/1104279428984975111818126681822177234222222222222222222222360000000000

PROJECT TEAM

AGENCY APPROVAL

PROJECT

ALIGNED
DATA CENTERS

ALIGNED DATA CENTERS

PROJECT RAPTOR
 2305 MISSION COLLEGE BLVD
 SANTA CLARA, CA 95054

CAC PROJECT NO. 11222

REVISIONS
 1 RESPONSE TO PCC COMMENTS 02/21/17

KEY PLAN & NORTH ARROW

DATE 02-21-2017


SCALE 1/32" = 1'-0"

DRAWING TITLE

LEVEL 1 MEZZANINE PLAN

SHEET NO.

A1.2

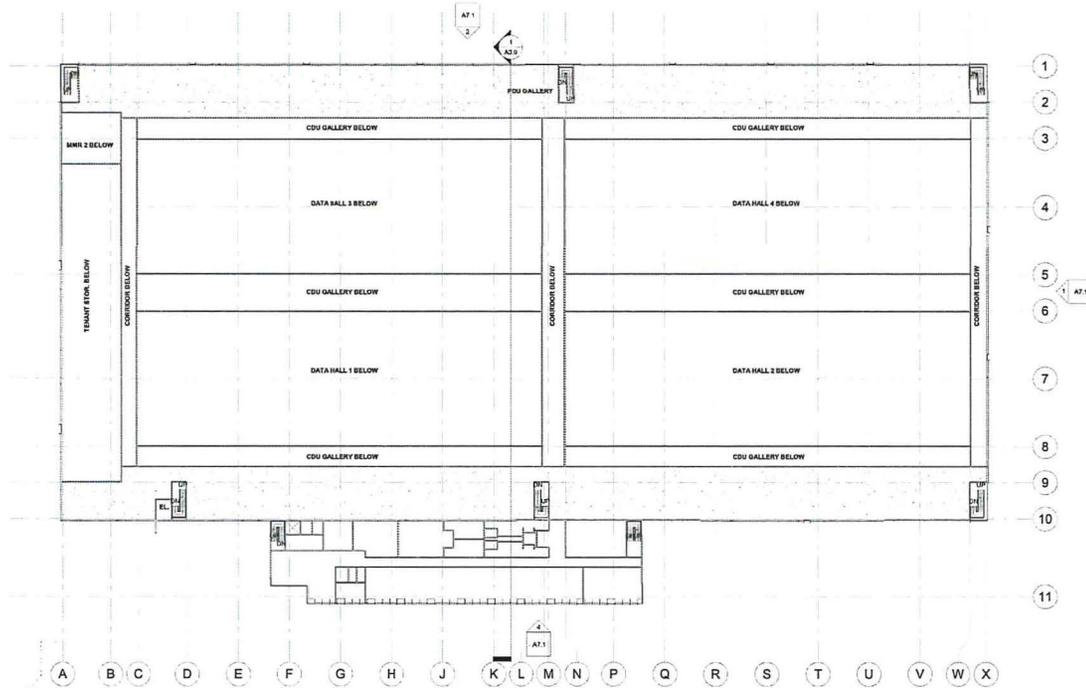

1 Mezzanine 1
 1/32" = 1'-0"

3" = 1'-0"
 1 1/2" = 1'-0"
 1" = 1'-0"
 3/4" = 1'-0"
 1/2" = 1'-0"
 3/8" = 1'-0"
 1/4" = 1'-0"
 1/8" = 1'-0"

PROJECT TEAM

AGENCY APPROVAL

PROJECT

ALIGNED
 ALIGNED DATA CENTERS
 PROJECT RAPTOR
 2305 MISSION COLLEGE BLVD
 SANTA CLARA, CA. 95054

CAC PROJECT NO. 11222

REVISIONS
 1 RESPONSE TO PCC COMMENTS 04/09/17

KEY PLAN & NORTH ARROW



DATE 02-21-2017

SCALE 1/32" = 1'-0"

DRAWING TITLE


EQUIPMENT PLATFORM PLAN

SHEET NO.

A2.3

1/8" = 1'-0"
 0 4 8
 1/4" = 1'-0"
 0 4 8
 1/2" = 1'-0"
 0 4 8
 3/4" = 1'-0"
 0 4 8
 1" = 1'-0"
 0 4 8
 1 1/2" = 1'-0"
 0 4 8
 2" = 1'-0"
 0 4 8
 3" = 1'-0"
 0 4 8
 4" = 1'-0"
 0 4 8
 5" = 1'-0"
 0 4 8
 6" = 1'-0"
 0 4 8
 7" = 1'-0"
 0 4 8
 8" = 1'-0"
 0 4 8
 9" = 1'-0"
 0 4 8
 10" = 1'-0"
 0 4 8
 11" = 1'-0"
 0 4 8
 12" = 1'-0"
 0 4 8
 13" = 1'-0"
 0 4 8
 14" = 1'-0"
 0 4 8
 15" = 1'-0"
 0 4 8
 16" = 1'-0"
 0 4 8
 17" = 1'-0"
 0 4 8
 18" = 1'-0"
 0 4 8
 19" = 1'-0"
 0 4 8
 20" = 1'-0"
 0 4 8
 21" = 1'-0"
 0 4 8
 22" = 1'-0"
 0 4 8
 23" = 1'-0"
 0 4 8
 24" = 1'-0"
 0 4 8
 25" = 1'-0"
 0 4 8
 26" = 1'-0"
 0 4 8
 27" = 1'-0"
 0 4 8
 28" = 1'-0"
 0 4 8
 29" = 1'-0"
 0 4 8
 30" = 1'-0"
 0 4 8
 31" = 1'-0"
 0 4 8
 32" = 1'-0"
 0 4 8
 33" = 1'-0"
 0 4 8
 34" = 1'-0"
 0 4 8
 35" = 1'-0"
 0 4 8
 36" = 1'-0"
 0 4 8
 37" = 1'-0"
 0 4 8
 38" = 1'-0"
 0 4 8
 39" = 1'-0"
 0 4 8
 40" = 1'-0"
 0 4 8
 41" = 1'-0"
 0 4 8
 42" = 1'-0"
 0 4 8
 43" = 1'-0"
 0 4 8
 44" = 1'-0"
 0 4 8
 45" = 1'-0"
 0 4 8
 46" = 1'-0"
 0 4 8
 47" = 1'-0"
 0 4 8
 48" = 1'-0"
 0 4 8
 49" = 1'-0"
 0 4 8
 50" = 1'-0"
 0 4 8
 51" = 1'-0"
 0 4 8
 52" = 1'-0"
 0 4 8
 53" = 1'-0"
 0 4 8
 54" = 1'-0"
 0 4 8
 55" = 1'-0"
 0 4 8
 56" = 1'-0"
 0 4 8
 57" = 1'-0"
 0 4 8
 58" = 1'-0"
 0 4 8
 59" = 1'-0"
 0 4 8
 60" = 1'-0"
 0 4 8
 61" = 1'-0"
 0 4 8
 62" = 1'-0"
 0 4 8
 63" = 1'-0"
 0 4 8
 64" = 1'-0"
 0 4 8
 65" = 1'-0"
 0 4 8
 66" = 1'-0"
 0 4 8
 67" = 1'-0"
 0 4 8
 68" = 1'-0"
 0 4 8
 69" = 1'-0"
 0 4 8
 70" = 1'-0"
 0 4 8
 71" = 1'-0"
 0 4 8
 72" = 1'-0"
 0 4 8
 73" = 1'-0"
 0 4 8
 74" = 1'-0"
 0 4 8
 75" = 1'-0"
 0 4 8
 76" = 1'-0"
 0 4 8
 77" = 1'-0"
 0 4 8
 78" = 1'-0"
 0 4 8
 79" = 1'-0"
 0 4 8
 80" = 1'-0"
 0 4 8
 81" = 1'-0"
 0 4 8
 82" = 1'-0"
 0 4 8
 83" = 1'-0"
 0 4 8
 84" = 1'-0"
 0 4 8
 85" = 1'-0"
 0 4 8
 86" = 1'-0"
 0 4 8
 87" = 1'-0"
 0 4 8
 88" = 1'-0"
 0 4 8
 89" = 1'-0"
 0 4 8
 90" = 1'-0"
 0 4 8
 91" = 1'-0"
 0 4 8
 92" = 1'-0"
 0 4 8
 93" = 1'-0"
 0 4 8
 94" = 1'-0"
 0 4 8
 95" = 1'-0"
 0 4 8
 96" = 1'-0"
 0 4 8
 97" = 1'-0"
 0 4 8
 98" = 1'-0"
 0 4 8
 99" = 1'-0"
 0 4 8
 100" = 1'-0"
 0 4 8

1 Mech. Pod
 1/32" = 1'-0"

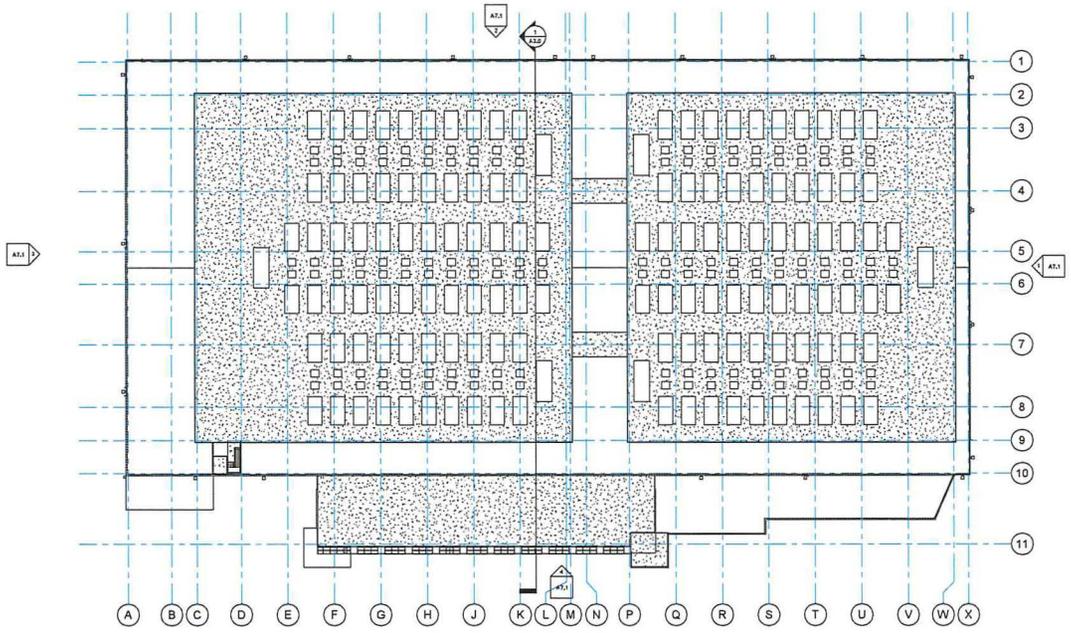

PROJECT TEAM

AGENCY APPROVAL

PROJECT

ALIGNED
 ARCHITECTS
 ALIGNED DATA CENTERS
 PROJECT RAPTOR
 2305 MISSION COLLEGE BLVD
 SANTA CLARA, CA 95054

CAC PROJECT NO. 11222

REVISIONS
 1 RESPONSE TO PCC COMMENTS 04/09/17


KEY PLAN & NORTH ARROW

DATE 02-21-2017
 SCALE 1/16" = 1'-0"

DRAWING TITLE
BUILDING SECTION

SHEET NO.

A3.0

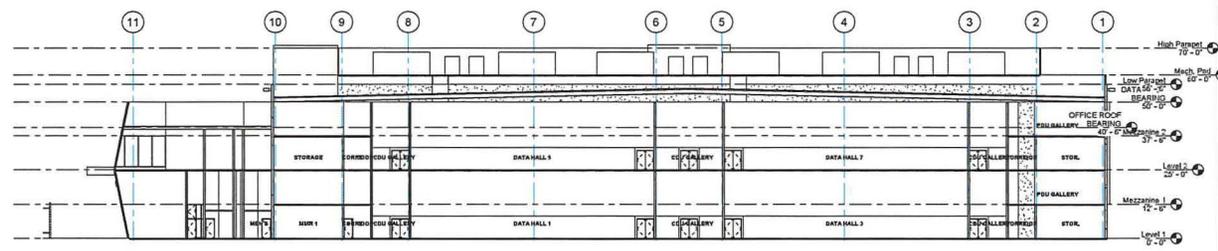

Section 1/16" = 1'-0"



PROJECT TEAM

AGENCY APPROVAL

PROJECT
 ALIGNED
 ALIGNED DATA CENTERS
 PROJECT RAPTOR
 2305 MISSION COLLEGE BLVD
 SANTA CLARA, CA 95054

CAC PROJECT NO. 11222

REVISIONS
 1 RESPONSE TO PGC COMMENTS 05/04/17


KEY PLAN & NORTH ARROW

DATE 03-21-2017
 SCALE 3/8" = 1'-0"
 DRAWING TITLE

ELEVATIONS

SHEET NO.

A7.1

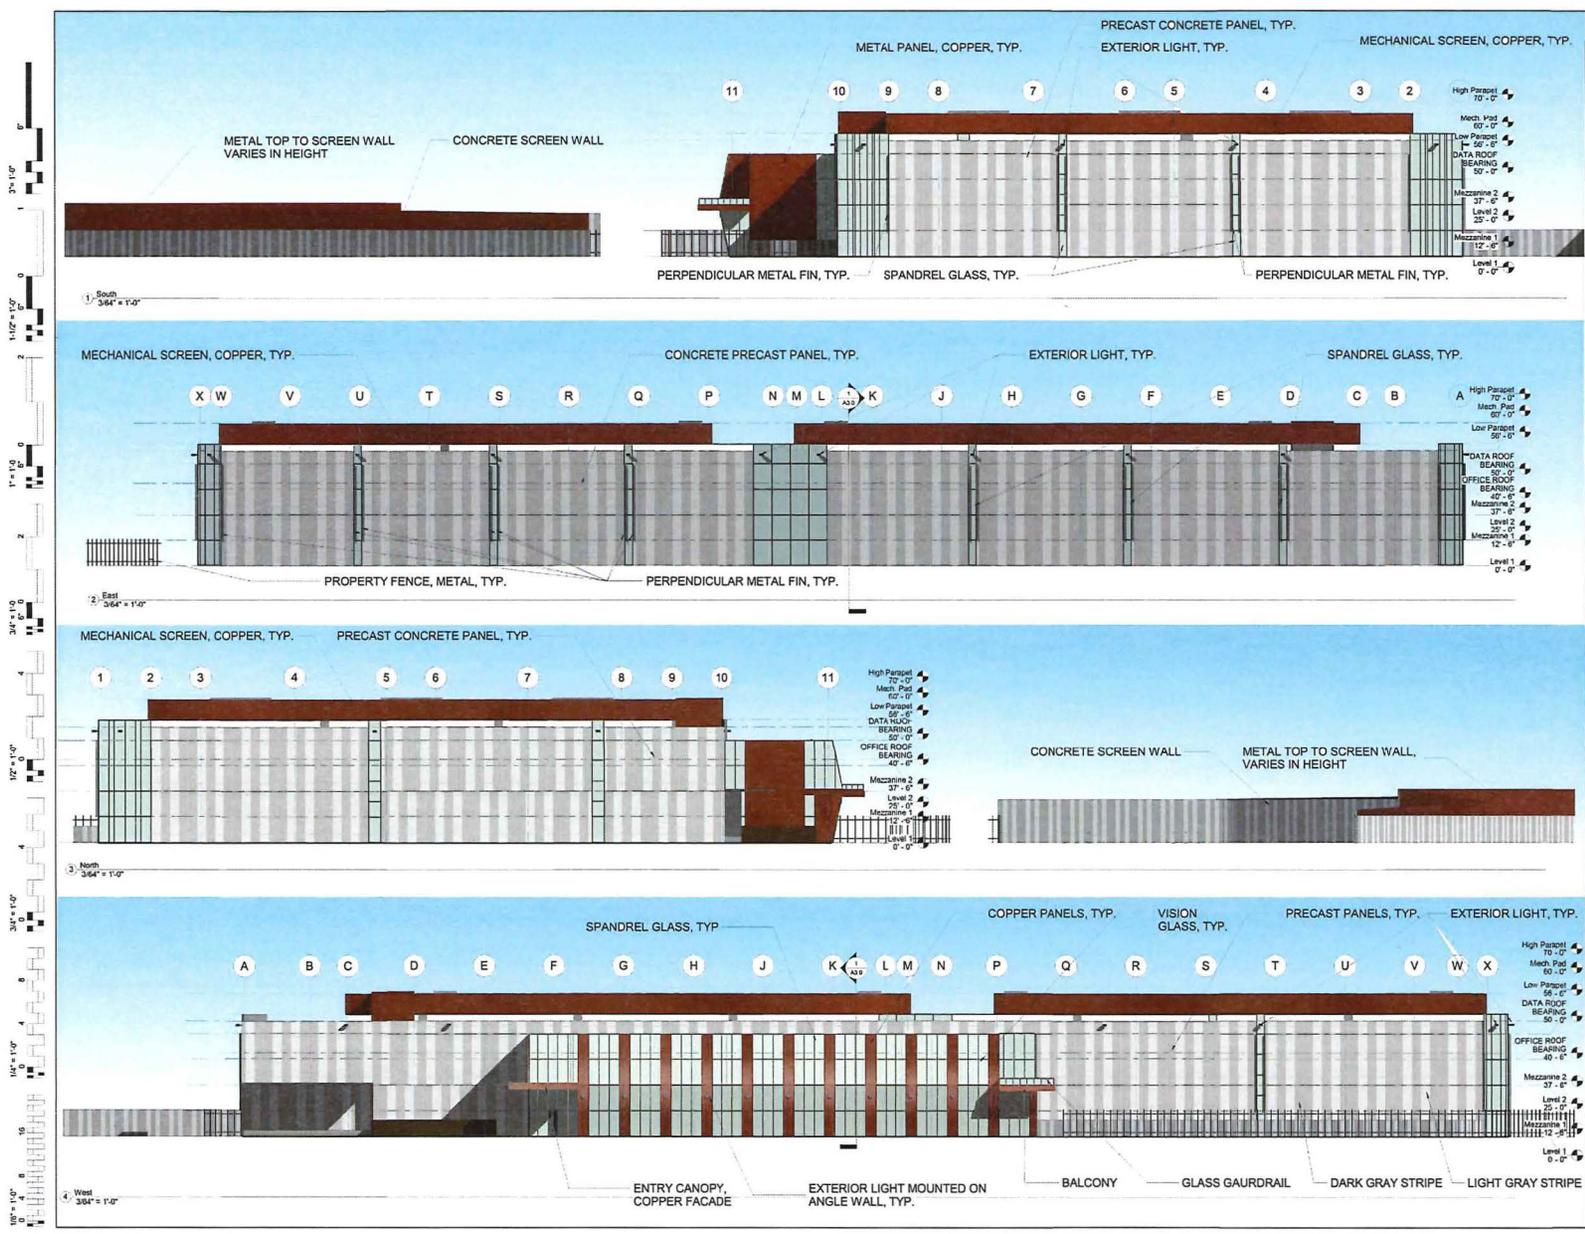

PROJECT TEAM

AGENCY APPROVAL

PROJECT

ALIGNED DATA CENTERS

PROJECT RAPTOR
 2305 MISSION COLLEGE BLVD
 SANTA CLARA, CA 95054

CAC PROJECT NO. 11222

REVISIONS
 1 RESPONSE TO POC COMMENTS 05/09/2017

KEY PLAN & NORTH ARROW

DATE 2017-05-09


SCALE

DRAWING TITLE

ALTERNATE PARKING PLAN

SHEET NO.

A8.0

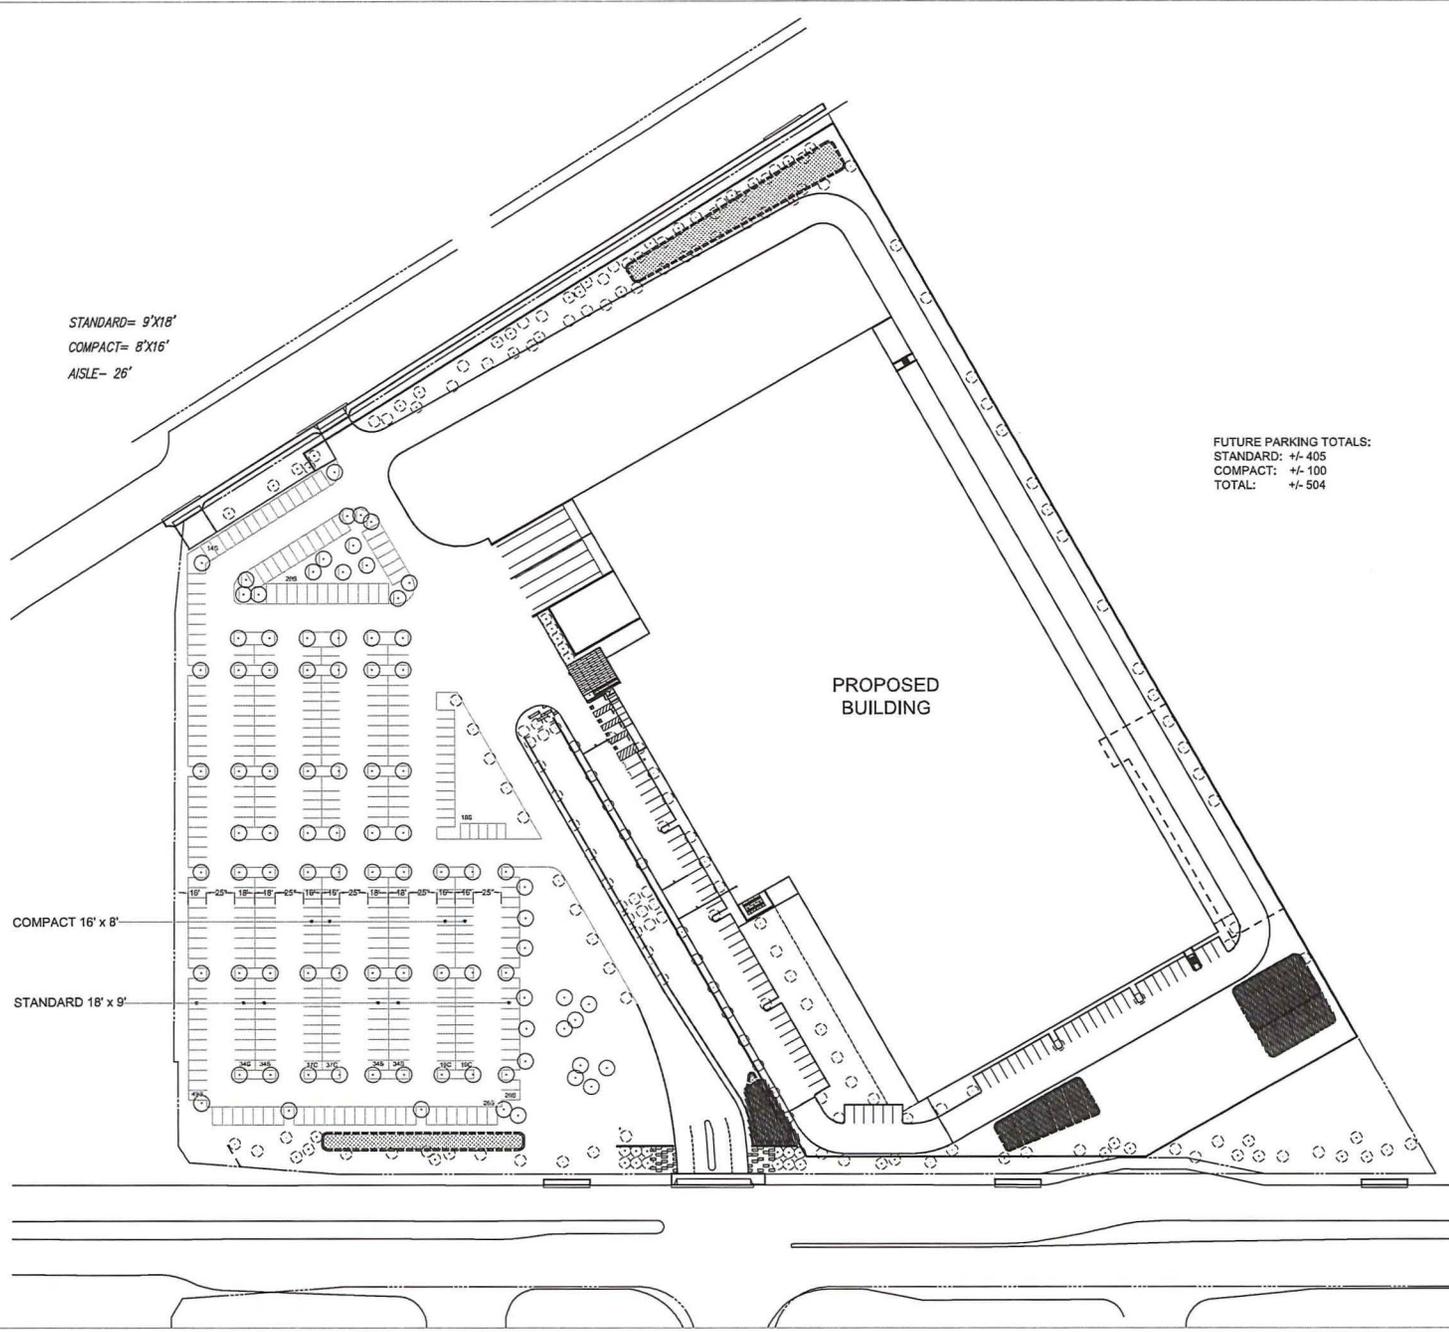

STANDARD= 9'x18'
 COMPACT= 8'x16'
 AISLE= 26'

FUTURE PARKING TOTALS:
 STANDARD: +/- 405
 COMPACT: +/- 100
 TOTAL: +/- 504

COMPACT 16' x 8'

STANDARD 18' x 9'

