# 1252 CABRILLO PROPOSED NEW HOME **1252 CABRILLO AVE** SANTA CLARA, CA, 95050



(Main House and Attached ADU)





1) FIRE SPRINKLER SYSTEM DESIGN

Shideh Heidarkhani 1252 Cabrillo Ave.Santa Clara.Ca.95050

PORJECT DIRECTORY

DESIGNER:

(410) 420-0149 4100 MOORPARK AVE#114, SAN JOSE, CA 95117 Info@linedesingbuild.COM

2022 CALIFORNIA BUILDING CODE

2022 CALIFORNIA RESIDENTIAL CODE

2022 CALIFORNIA MECHANICAL CODE

2022 CALIFORNIA PLUMBING CODE

2022 CALIFORNIA ENERGY CODE 2022 CALIFORNIA FIRE CODE

2022 CALIFORNIA ELECTRICAL CODE

2022 CALIFORNIA GREEN BUILDING CODE

CITY OF SANTA CLARA MUNICIPAL CODE

5870 Stoneridge Mall Rd, Pleasanton, CA 94588

APPLICABLE CODES

ALL APPLICABLE COUNTY OF SANTA CLARA CODES & REGULATIONS

OCCUPANCY GROUP R-3/II

CONSTRUCTION TYPE: VB - SPRINKLERED ZONING: R1 - 6L

PORJECT DATA

EXISTING/PROPOSED NUMBER OF FLOORS: 1 (ONE) PROPOSED NEW FIRE SPRINKLERS: MAIN HOUSE - REDROOM/BATHROOM RATIO: 2/1.5

ADU: BEDROOM/BATHROOM RATIO:

Very Low Density Residential General Plan designation:

SCOPE OF WORK

1) 2.519.5 SF NEW HOME INCLUDING 1.403.6 SF NEW LIVING AREA

405.9 SF NEW GARAGE, 23.6 SF NEW FRONT PORCH, AND 686.4 ATTACHED ADU

SHALL BE ALLOWED.EXISTING GAS SERVICE & METER SHALL BE CAPPED

2) FULL DEMOLITION OF EXISTING HOUSE & ACCESSORY

STRUCTURES.
3)SERVICE PANEL UPGRADE TO 200 AMPS


4)NEW 2-CAR DRIVEWAY

AND SEALED

Cover Sheet

BUILD

1 OF 10

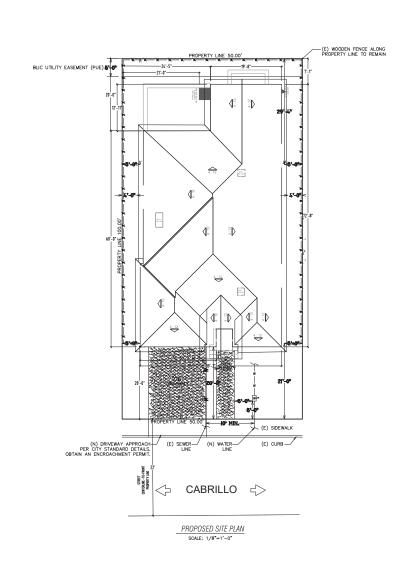



LINE DESIGN BUILD
Phone: 415-426-0146
Email: info@linedesignbuild.com

REVISION TABLE:

A REVISION DATE BY DEP

01 08/05/2025 R.A. PLN

02 08/18/2025 R.A. PLN

1252 Cabrillo Ave Santa Clara, CA, 95050 (Main House and Attached ADU)

SCALE: 1/8"=1'-0" A 0.1

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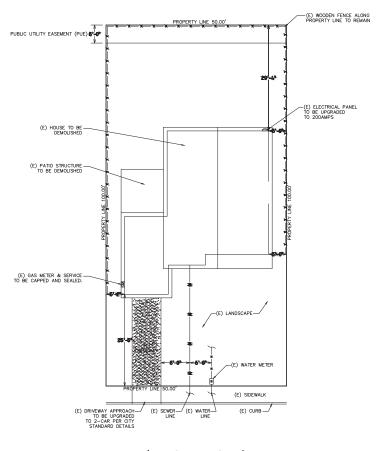
SCALE:

1/8"=1'-0"

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DRAWING NUMBER

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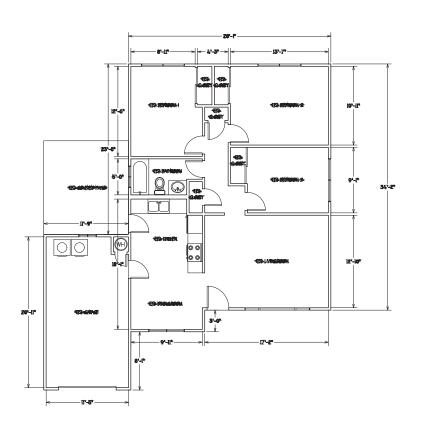


CABRILLO <>

EXCITING SITE PLAN SCALE: 1/8"=1'-0"

II		
	PROPERTY LINE	
	ROOF LINE	
	WALL BELOW ROOF	
	SETBACK LINE, REQUIRED	
-×-×-	EXISTING FENCE	
-w-w-	EXISTING WATER LINE, FIELD VERIFY	
	EXISTING SEWER LINE, FIELD VERIFY	
- G - G -	EXISTING GAS LINE, FIELD VERIFY	
	CONCRETE	

LEGEND



EXCITING FLOOR PLAN
SCALE: 1/4"=1'-0"

WALL SCHEDULE		
LEGEND	DESCRIPTION	
	EXISTING WALL TO BE DEMOLISHED (2X4 WOOD STUDS)	





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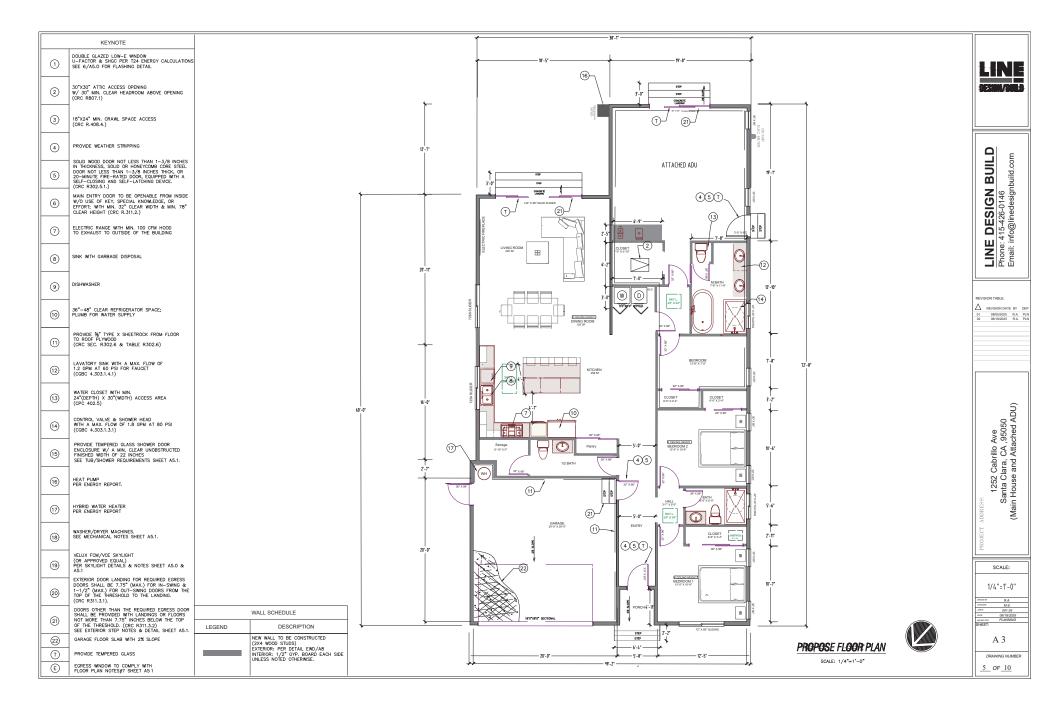
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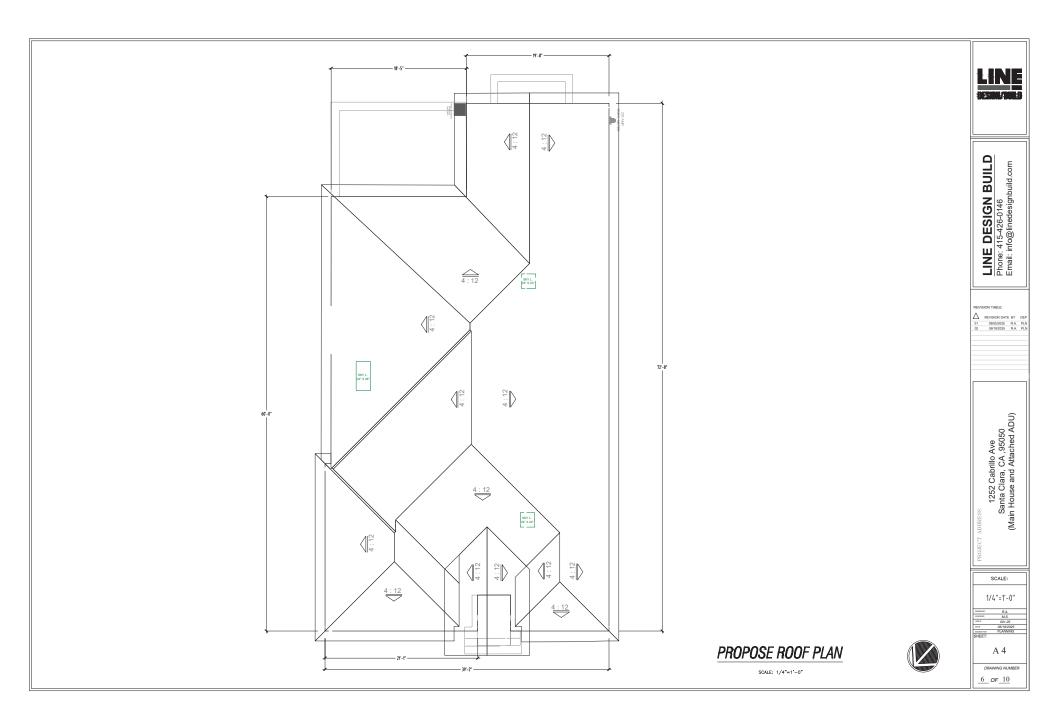
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SCALE:

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#### ELEVATION NOTES

1) FINISH GRADE WITHIN 10' OF THE HOUSE SHALL HAVE A MIN. 5% SLOPE AWAY FROM FOUNDATION FOR PERVIOUS SURFACE AND MIN. 2% SLOPE FOR IMPERVIOUS SURFACE (CBC 1804.3).

2) ON GRADED SITES, THE TOP OF ANY EXTERIOR FOUNDATION SHALL EXTEND ABOVE THE ELEVATION OF THE STREET GUTTER AT A POINT OF DISCHARGE (OR THE INLET OF AN APPROVED DRAINAGE DEVICE), A MIN. OF 12 INCHES PLUS 28.

3) EXISTING DRAINAGE SHALL REMAIN THROUGHOUT CONSTRUCTION.

4) ROOFING MATERIAL SHALL HAVE 2-LAYERS OF # 30 FELT AS UNDERLAY AND FASTENED TO ROOF SHEATHING WITH CORROSION RESISTANT FASTENERS, TYPICAL (CRC R905.2.5.)

5) FLASHING (GRC 1507 AND CRC R905.2.8-R905.2.8.4)
PRONDE ROOF FLASHING AT ALL WALL AND ROOF
INTERSECTIONS, GUTTERS, AND WHERE THERE IS A CHANGE
IN THE ROOF SLOPE OR DIRECTION AROUND ROOF OPENINGS.
FLASHING SHALL BE A MINIMUM AS GAUGE
CORROSION—RESISTANT GALVANIZED
METAL.

6) DRIP EDGE (CBC 1507.2.8.3 AND CRC R905.2.8.5)
PROVIDE A DRIP EDGE AT EAVES AND GABLES OF ASPHALT
SHINGLE ROOTS. ADJACENT PIECES OF THE DRIP EDGE
SHALL BE OVERLAPPED A MINIMUM OF 2 INCHES. THE GRIP
AND A MINIMUM OF 2 INCHES UT THE ROOF DEGK. THE DRIP
EDGE SHALL BE MECHANICALLY FASTENED TO THE ROOF
DEGK AT A MAXIMUM OF 2 INCHES WITH APPROVED OKER
FASTENERS. THE UNDERLAYMENT SHALL BE INSTALLED DRIP
EDGE AT GABLES (FAME EDGES). SHINGLES CAN BE FLUSH
WITH THE DRIP EDGE IF ALLOWED BY THE MANUFACTURER.

7) WEATHER RESISTIVE BARRIERS SHALL BE INSTALLED AS REQUIRED IN SECTION R703.2 AND, WHERE APPLIED OVER WOOD-BASED SHEATHING, SHALL INCLUDE A WATER-RESISTIVE VAPOR-PERMEABLE BARRIER WITH A PERFORMANCE AT LEAST EQUIVALENT TO TWO LAYERS OF GRADE D PAPER (R703.6.3)

8) PLASTERING WITH PORTLAND CEMENT PLASTER SHALL NOT BE LESS THAN THREE COATS WHEN APPLIED OVER METAL LATH OR WIRE LATH AND SHALL BE NOT LESS THAN TWO COATS WHEN APPLIED OVER MASOWRY, CONCRETE, PRESSURE-PRESERVATIVE TREATED WOOD OR COAY-RESISTANT WOOD AS SPECIFIED IN SECTION R317.1 OR GYPSUM BACKING (R703.6.2).

9) A MINIMUM 26 GA. GALVANIZED CORROSION-RESISTANT 9) A MINIMUM 26 GA. GALVANIZED CORROSION-HESISTANT WEEP SCREED WITH (R703.8.2.1):

A) A MINIMUM VERTICAL ATTACHMENT FLANGE OF 3-1/2 INCHES PROVIDED AT OR BELOW THE FOUNDATION PLATE LINE AT ALL EXTERIOR WALLS.

B) THE SCREED SHALL BE PLACED A MINIMUM OF 4 INCHES ABOVE EARTH OR 2 INCHES ABOVE PAYED AREA.

10) WINDOWS AND GLAZED DOORS MUST HAVE LABELS FOR "U-FACTOR" & "SHGC" AS REQUIRED PER ENERGY CODE. SEE ENERGY COMPLIANCE INFORMATION ON SHEET T-24.

11) CRAWL SPACE VENTS SHALL NOT OCCUR AT SHEAR

12) MINIMUM NET AREA OF VENTILATION OPENINGS SHALL NOT BE LESS THAN 1 SQUARE FOOT FOR EACH 150 SQUARE FEET OF UNDER-FLOOR AREA (R408.2).

13) ONE VENTILATION OPENING SHALL BE WITHIN 3 FEET OF EACH CORNER OF THE BUILDING (R408.2).

14) 50% TO 70% OF EYEBROW VENTS SHALL BE IN THE UPPER 1/3 OF ROOF STRUCTURE.

15) Shielded light fixtures where necessary to direct light to the ground and protect adjacent properties from excessive glare.

## ATTIC VENTLATION CALCULATIONS


MANUFACTURER: CONSTRUCTION METALS MODEL: LPDH18-0.125 (OR APPROVED EQUAL) VENT OPENING: 18" X 7" NET FREE AREA: 81 SQ. INCH (0.56 SF)

NEW ATTIC SPACE: 2,519.5 SF REQUIRED VENTILATION (SF): 150 = 16.79 REQUIRED VENTS (#): 16.79 /0.56=30

#### UNDERFLOOR VENTLATION CALCULATIONS

MANUFACTURER: CONSTRUCTION METALS
MODEL: SCV166 (OR APPROVED EQUAL)
VENT OPENING: 6 " X 16 "
NET FREE AREA: 96" SQ. INCH ( 0.667 SF)

UNDERFLOOR SPACE: 2,113.6 SF REQUIRED VENTILATION (SF): 1100 = 14.09 REQUIRED VENIS (#): 14.09 /0.667 = 22

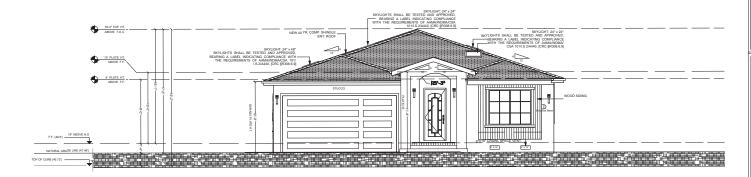

PROPOSED FRONT (NORTH) ELEVATION

SCALE: 1/4"=1'-0"



PROPOSED REAR (SOUTH) ELEVATION

SCALE: 1/4"=1'-0"



BUILD 415-426-0146 info@linedesignbuild. SIGN ш LINE Phone: Email: ii

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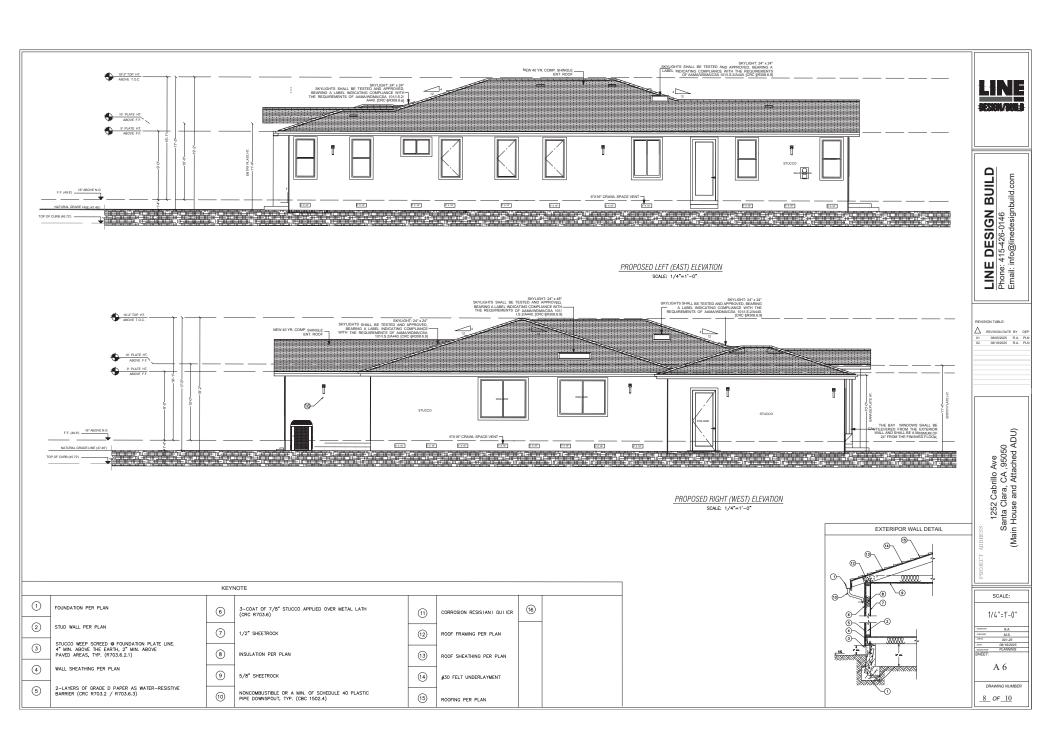
SCALE: 1/4"=1'-0"

08/18/2025 PLANNING

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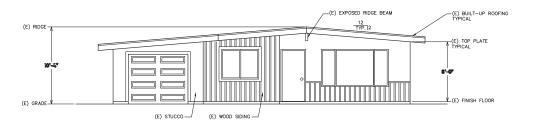
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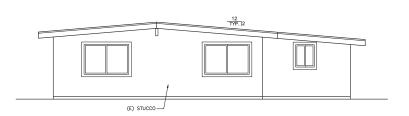
08/18/2025 PLANNING

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# EXCITING EAST/FRONT ELEVATION

SCALE: 1/4"=1'-0"



### EXCITING WEST/ REAR ELEVATION

SCALE: 1/4"=1"-0"