



VICINITY MAP


	SI	HEET INDEX
NO.	DATE	DESCRIPTION
1.	5/22/2020	SITE PLAN
2.	5/22/2020	ELEVATIONS
3.	5/22/2020	PROPOSED 15T FLOOR PLAN
4.	5/22/2020	PROPOSED 2 <sup>NO</sup> FLOOR PLAN
5.	5/22/2020	ELECTRICAL 197 FLOOR PLAN
6.	5/22/2020	ELECTRICAL 200 FLOOR PLAN
7.	5/22/2020	FOUNDATION PLAN
8.	5/22/2020	ROOF PLAN
9.	5/22/2020	CROSS SECTIONS
10.	5/22/2020	DETAIL SHEET "A"
11.	5/22/2020	DETAIL SHEET "B"
	ADU	PLANS
1A.	5/22/2020	ADU ELEVATIONS
2A.	5/22/2020	ADU FLOOR PLAN
3A.	5/22/2020	ADU FOUNDATION
4A.	5/22/2020	ADU ROOF PLAN
	TITLE -	24 MAIN RESIDENCE
EN.1		TITLE - 24
EN.2		TITLE - 24
GB.1		CALGREEN
	TITLE -	24 ADU
EN.1		TITLE - 24
EN.2		TITLE - 24
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S4.		STRUCTURAL
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A) A MINIMUM OF 35% OF THE MINIMUM OF 35% OF THE MINIMUM FRONT AREA TO BE RESERVED FOR LANDSCAPE OR 350 S F MIN OF 20X50 OR 1000 S F



# ADDITIONAL... BATHROOM FIXTURE / ELECT / PLUMBING, MECH AND INSULATION NOTES

#### DI LIMBINO

- ALL SINK FAUCETS, SHOWER HEADS, TOILETS AND URBHALS SHALL COMPLY
  WITH CALIFORNA CORL DODG SECTION 1018 (KITCHEN FAUCETS SHALL NOT
  EXCEED 1.8 MAX PER FLUSH)... LAVATORY FAUCETS SHALL NOT EXCEED
  1.2 GALLONS... SHOWER HEADS SHALL NOT EXCEED 2.0 GALLONS... AND
  URNALS SHALL NOT EXCEED 5 GALLONS PER FLUSH
- PER OPC SECTION 492.2.2, SINGLE FLUSH WATER CLOSETS SHALL HAVE AN EFFECTIVE FLUSH VOLUME NOT TO EXCEED 1.28 GALLONS.
- INDOOR WATER USE SHALL BE REDUCED BY AT LEAST 20% BY USING WAT SAWNS FIXTURES OR FLOW RESTRICTIONS OR DEMONSTRATE A 20% REDUCTION IN BASELINE WATER PER SECTION 4 303.1
- ALL ADDITIONS ON OR AFTER JANUARY 1,2014 SHALL REPLACE NON COMPLIANT PLUMBING FOXTURES WITH WATER CONSERVING PLUMBING FIXTURES

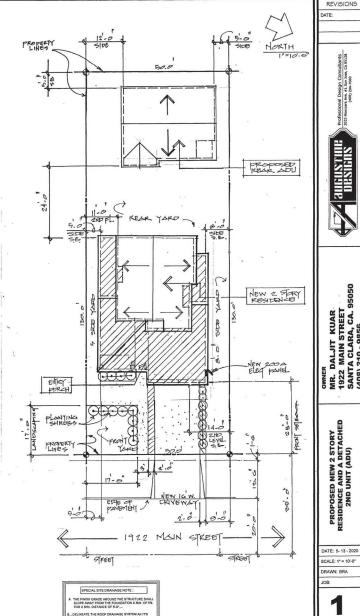NON-COMPILANT PLUMBING FIXTURES SHALL BE REPLACED WITH WATER CONSERVING PLUMBING FIXTURES PER COS SECTION 301.1. PLUMBING FIXTURES PER ACCEPTION TO SECTION 301.1. PLUMBING FIXTURE REPLACEMENT OF ROUTED PROPORT OS SEMENCE OF A CERTIFICATE OF FOUL COMPLETION, CERTIFICATE OF FOUL COMPLETION, CERTIFICATE OF COLUMNOY OR FINAL PERMIT APPROVALS IT THE BUILDING DEPARTMENT.

#### ELECTRICAL

- ALL BRANCH CIRCLITS THAT SUPPLY 12S-YOLT, SHOKE PHASE, 15-AND 20 AMPERE BECEPTACE OF OUTER INSTALLED IN A OWELLING NITH TUNING, DINNIG AND FAMIL YOU OWN, PARLORS, BEDROCOUS, LIBRARIES, DENS, HALLWAYS, BECREATION ROOM, CLOSET OR SMIMAR ROOMS OR AREAS SHALL BE PROTECTED BY A LISTED ARC-FALLT CIRCLIT INTERRUPTER TO PROVIDE PROTECTION OF THE ENTIRE BRANCH CIRCLIT. CEC ARTICLE
- 2 ALL NEW AND REPLACED DUPLEX RECEPTACLES SHALL BE LISTED TAMPER-RESISTANT \* RECEPTACLE .2016 CEC ART 406.12
- AT LEAST TWO 20-AMP BRANCE CIRCUITS SHALL BE PROVIDED FOR SMALL KITCHEN APPLIANCES AT THE COUNTER TOP (CEC 210.52)
- ALL RECEPTACLES IN KITCHEN AREAS TO BE GFIC TAMPER PROOF NOT TO EXCEED. 41-0" O.C.
- 5 ALL EXAUST FANS THROUGHOUT THE RESIDENCE SHALL BE SWITCHED SEPARATELY FROM ANY LIGHTING SYSTEM
- ALL KITCHEN EXHAUST SHALL BE DUCTED TO THE EXTERIOR
- ALL RECESSED LIGHTING FIXTURES INSTALLED IN INSULATED CEILINGS SHALL BE IC; INSULATION COVER JAND AT ( AIR TIGHT JRATED AND SHALL BE SEALED BETWEEN THE FIXTURE HOUSING AND THE GYP WITH A GASKET OR CAULK

#### GENERAL EXTERIOR NOTES

- ALL PLUMBING VENTS TO BE A MINIMUM 10 FEET AWAY FROM, OR AT LEAST 3 FEET ABOVE ANY OPERABLE SKYLIGHTS PER CPC 908.2.
- DISTAL DESIGNATION OF THE MODE WAS OFFICED WITHOUT STATE OF THE MODE WAS OFFI THE MO

# EXTERIOR WEATHER PROTECTION NOTES

- STLDS OR SHEATING OF ALL EXTERIOR WALLS SHALL BE WEATHER PROTECTED WITH 15 POUND ASPHALT. SATURATED FELT OR OTHER APPROVED WATERPROOF PAPER SUCH PAPER SHALL BE APPLIED IN WEATHER BOARD FASHION, LAPPED NOT LESS THAN 2" AT HORROTOTAL JOINTS AND NOT LESS THAN 6" AT VERTICLE.
- WHERE STUCCO IS APPLIED OVER EXTERIOR SHEATING THERE SHALL BE TWO
  LAYERS OF GRADE "D" BUILDING PAPER, BUILDING PAPER MAY BE OMMITTED IN
- A)...WHERE THERE IS NO HUMAN OCCUPA
- WHERE EXTERIOR COVERING IS OF APPROVED W.P. MATERIAL OVER WATER REPELLENT SHEATING
- 3 .... STUCCO SHALL BE 7 / 8" THICK AND THREE COATS APPLIED OVER APPROVED WIRE LATH AND TWO LAYERS OF GRADE D BUILDING PAPER. PROVIDE WEEP CREEK
- WIRE LATH AND TWO LAYERS OF GRADE D BUILDING PAPER PROVIDE WEEP CREED


  4 .... SIDING SHALL BE APPLIED OVER ONE LAYER OF GRADE D BUILDING PAPER
- SIDING SHALL BE APPLIED OVER ONE LAYER OF GRADE D BUILDING PY
   PROVIDE A SPARK ARRESTOR FOR ANY NEW OR EXISTING CHIMNEY


### IMPORTANT GRADING NOTE


HE FINISH GRADE AROUND THE STRUCTURE HALL SLOPE AWAY FROM THE FOUNDATION I MIN. OF 5 PER CENT FOR A MIN. DISTANCE IF 10 FEET (1:02 MIN RATIO)

### ROOF FRAMING NOTES

ALL FASTENERS FOR THE ROOF FRAMIN SHALL CORROSION RESISTANT

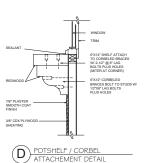

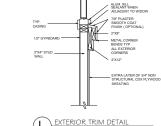

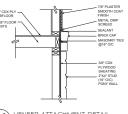

VENEER ATTACHMENT DETAIL


#### GENERAL NOTES


- PLANS TO COMPLY WITH CONVENTIONAL CONSTRUCTION PROVISIONS AS STATED IN 2019 CALEFORNIA RESIDENTIAL BUILDING MECHANICS, PLIMBRING, ELECTRICAL AND ENERGY CODES AS AMENDED BY STATE OF CALIFORNIA AND ALL CITY & MUNICIPAL CI PROJECT LOCATED TO SPECIFY SEISMIC DESIGN CATEGORY E.)
- INTERPRETATION OF DRAWINGS FOR ARRANGEMENT OF FLOORS, GENERAL FINISH, AND
  MESSUREMENTS, REFERENCE MUST BE MADE TO THE DRAWINGS, SHOULD ANY DIFFERENCE
  APPEAR REFIVEEN SCALE MESSUREMENT AND FOLKIES OR BETWEEN WORDING OF
  SPECIFICATIONS & LETTERING ON DRAWINGS. THE SPECIFICATION SHALL IN ALL CASES TAKE
  PRECEDENCE. IF ANY ERROR THAT IS NOT DEVALED BETHER BY REFERENCE TO THE DRAWIN
- THE WURN (LOWINGLISH IS ON TO SCHOOL TO SCHOOL THE WORK (LOWINGLISH).

  BEROOFS AND OMBISSIONS: IN THE EVENT THAT AN ACUTE ERROR OR OMISSION MAY EXIST ON THE PLAN IT SHALL BE THE RESPONSIBILITY OF THE OWNER OR CONTRACTOR TO NOTHY THE DESIGNER, PRAFFSMAN PROR TO THE COMMENCEMENT OF WORK. FALLER TO DO SUCH,
- 4. SITE PLAN LAYOUT: IN THE EVENT THERE MAY BE DISCREPINCIES BETWEEN THE OMENSIONS ON THE SITE PLAN AND THE ACTUAL DIMENSIONS OF THE LOT AND ITS SETBLOSS, IT WILL BE THE OWNERS RESPONSIBILITY TO PROVIDE A LEGAL SURVEY TO CONSTRUCT HE ACCURACY OF THE PROPERTY SIZE AND LAYOUT. ALL SITE PLANS, AS DRAWN ARE FOR REFERENCE AND SHOULD NOT BE LOCKED UPON AS WAN OFFICIAL DOCUMENT.

#### EXTERIOR BUILDING NOTES

- CLEARANCE BETWEEN WOOD SIDING, FRAMING MEMBERS INCLUDING SHEATHING, AND EARTH ON THE EXTERIOR OF A BUILDING SHALL NOT BE LESS THAN 6" OR LESS THAN 2" MEASURED VERTICALLY FROM
- 2. WHERE OVERTICALLY FROM MEASURED VERTICALLY FROM SHALL BE PROPERLY TERMINATED WITH A SPLASH BLOCK AND SHALL CARRY WATER WAYS FROM THE FOUNDATIONS PER CITY ORNANCE. ORDINANCE. CLARIFY IF THERE ARE NEW GUTTERS AT NEW ADDITION.

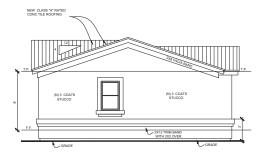

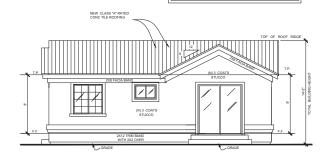

RIGHT SIDE ELEVATION (NORTH)

REAR ELEVATION (WEST)

SCALE: 14" = 1-0"

THE FRIEND GRADE AROUND THE STRUCT AND CONCERN TH

NEW CLASS 'N RATED
ONE THE ROOF NO

NO CONTROL

NO CON

LEFT SIDE ELEVATION (SOUTH)
SCALE: 1/4" = 1'.0"

PROPOSED 2ND UNIT

SCALE: 1/4" = 1'-0" ELEVATIONS

FRONT ELEVATION (EAST)

## IMPORTANT GRADING NOTE

THE FINISH GRADE AROUND THE STRUCTURE SHALL SLOPE AWAY FROM THE FOUNDATION A MIN. OF 5 PER CENT FOR A MIN. DISTANCE OF 10 FEET (1:02 MIN RATIO )

REVISIONS

TE:

Professional Design Consultants
3033 Moorpark Ave. # 1 San Jose, CA 95128
(408) 294-7060

ALIENSTINE THE STRING


OWNER
DALJIT KAUR
1922 MAIN STREET
SANTA CLARA, CA 95050
PHONE: (196) 756-1311

PROPOSED NEW SINGLE FAMILY RESIDENCE AND NEW REAR DETACHED ADU

DATE: 05 -15 - 2020

SCALE: 1/4" = 1'-0" DRAWN: BRA

1a

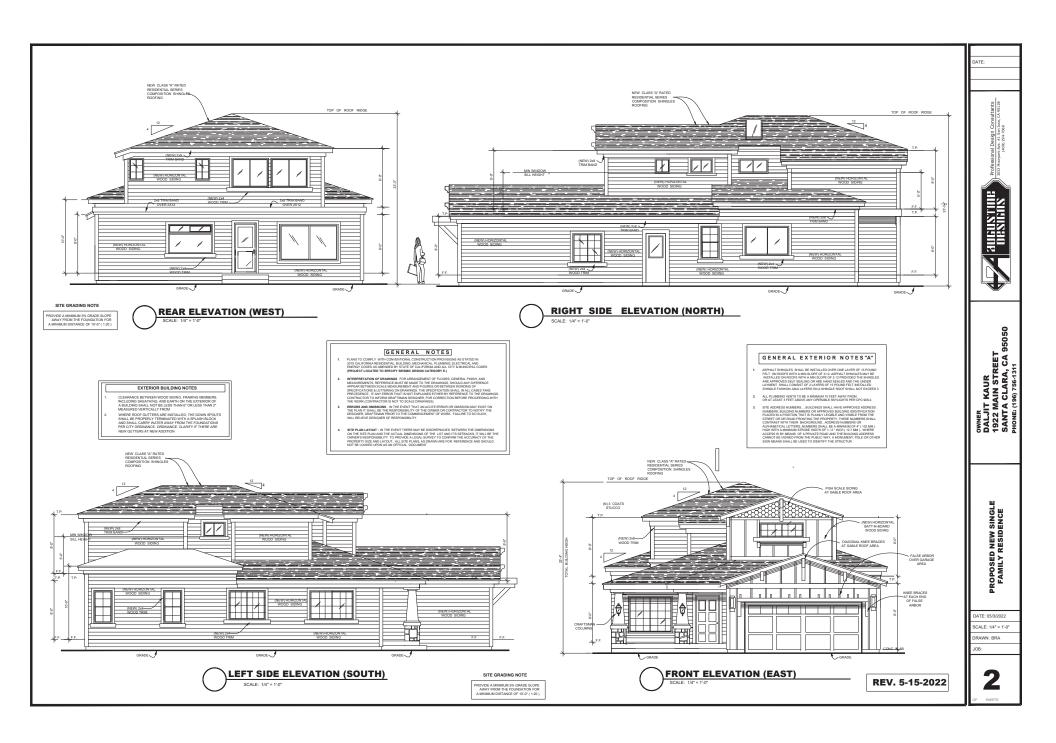

- EXCEED 1.8 MAX PER FLUSH)... LAVATORY FAUCETS SHALL NOT EXCEED 1.2 GALLONS... SHOWER HEADS SHALL NOT EXCEED... 2.0 GALLONS... AND URINALS SHALL NOT EXCEED 5 GALLONS PER FLUSH
- PER CPC SECTION 402.2.2, SINGLE FLUSH WATER CLOSETS SHALL HAVE AN EFFECTIVE FLUSH VOLUME NOT TO EXCEED 1.28 GALLONS.
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NON-COMPUNITY DUMBING PIXTURES SPEEL DE REPUBLIES WIT WATER CONSERVING PLUMBING PIXTURES PER CBC SECTION 301.1.1. PLUMBING FIXTURE REPLACEMENT IS REQUIRED PRIOR TO ISSUANCE OF A CERTIFICATE OF FINAL COMPLETION, CERTIFICATE OF OCCUPANCY OR FINAL PERMIT APPROVAL BY THE BUILDING DEPARTMENT

#### FLECTRICAL

- ALL BRANCH CRICUITS THAT SUPPLY 125-VOLT, SINGLE PHASE, 15-AND 20 AMPRER RECEPTACLE OUTLETS INSTALLED IN A DWELLING UNIT LIVING, DONING AND FAMILY POOMS PIAROSE BERDROUSL (BRANKES DENN HALLWAYS, RECREATION ROOM, CLOSET OR SIMILAR ROOMS OR AREAS SHALL BE PROTECTED BY A LISTED ANG-FAULT CRICIATIVITY MERRIPITER TO PROVIDE PROTECTION OF THE ENTIRE BRANCH CIRCUIT, CEC ARTICLE 2010.
- AT LEAST TWO 20-AMP BRANCH CIRCUITS SHALL BE PROVIDED FOR SMALL KITCHEN APPLIANCES AT THE COUNTER TOP (CEC 210.52)
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#### BRACED WALL PANEL NOTES:

L NEW CONSTRUCTION, ADDITIONS OR NEW RESIDENTIAL STRUCTURES TO CONFORM MINIMUM ACCEPTED BRACING PER CRC 2019 WHICH REQUIRES


1). . 2 1/2 LF OF BRACED WALL PER EA 10LF
 2). . 4 LF OF SOLID WALL PANES AT ALL CORNERS PER EACH 2S LF OF WALL
 3). . WALL PARES MAYES REDUCED TO ABSOLUTE 32" MIN WIDTH PROVIDED
 THEY ARE ANCHORED WITH THE APPROPRIATE STRAPS OR HOLDOWNS
 AT EACH END OF PAREL.

| INDICATES 3/6" MINIMUM THICK INTERIOR / EXTERIOR BRACED WALL PANELS 4-0" MIN IN LENGTH SECURED TO STUDS WITH 80 NAILS AT 1/2" O.C. AT FIELD & 4" O.C. AT EDGES AT EDGES FOR SINGLE STORY (SEE ALSO FLOOR PLAN). 2a INDICATES ALTERNATIVE BRACED PANEL WITH MIN. WIDTH OF 32° AT 8:0° HEIGHT OR 2'-10° AT 10:0° HEIGHT

USE. - HDU4. - HOLDOWNS OR. - HTT4. - HOLDOWNS W/5/8\* MIN. DIAMETER BOLTS WITH 10" MIN EMBEDMENT. SPECIAL INSPECTION REQUIRED FOR HOLDOWNS INTE EXISTING FROMING.

### METAL STRAPING / CONNECTOR NOTES:

- A....ALL STRAPING, CLIPS, HOLDOWNS, POST SUPPORT, BEAM HANGERS AND METAL CONNECTORS TO BE SIMPSON OR EQUAL.

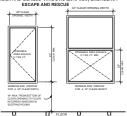

RESIDENTIAL EGRESS WINDOWS (2019 CBC) EMERGENCY

- se so many fire deaths occur when occupants of residential buildings are soleep at the e, the 2019 California Building Code (CBC), Section 1029 requires that:
- clear openable area shall be no less than 5.7 square feet (5 square feet for grade floor s and basement window wells ).

ELECTRICAL NOTES

ALL 120 - VOLT, SINGLE-PHASE, IS-AND 20 AMPERE BRANCH CIRCLITS SUPPLYING OUTLETS OR DEVICES NETFLALED IN DIVELING LINT KITCHENS, FAMILY ROOMS, DIVING FORCE, PARKEL STRONG COLDS, SUPPLYING FORCE INSTRUCTAGE, SUPPLYING COLDS, DIVING COLDS, DI

### SMOKE DETECTOR NOTES


- A SMOKE DETECTORS
- PROVIDE 1 EACH SMOKE DETECTOR IN ALL SLEEPING ROOMS AND AT A POINT CENTRALLY LOCATED IN AN AREA GIVING ACCESS TO THE SLEEPING ROOMS POWER SOURCE:

NeW COMBRIGHTON, REQUIRED SMOKE DETECTOR SHALL RECEIVE THER PRAMARY FOWER FROM THE BUILDING WERD WERD SLICH WINDOW. SI SERVED FROM COMBRIGHT SHOULD THE BUILDING WERD WERD SLICH WINDOW. THE DETECTION OF THE STATE O

IN DWELLING UNITS, A DETECTOR SHALL BE INSTALLED IN THE CORRIDOR OR AREA GIVIN EACH SLEEPING ROOM AND AT A POINT CENTRALLY LOCATED IN THE CORRIDOR OR AREA GIVIN ACCESS TO EACH SEPARATE IS EXEMPTED AREA WHEN THE DWELLING UNIT HAS MORE THAN ONE STORY AND IN DVINELINGS WITH BASSEMENTS A DETECTOR SHALL BE INSTALLED ON EACH STOR AND IN THE ASSEMENT AND UNITS WHERE A STORY OR DESEMENTS SHALL THE OWN FACH.

THE BANKE DETECTION SHALL BE RESTALLED IN THE UPPORT LYFE, EXCESS THAT HAVE THE CHARM LIVER LYFE ALL BE INSTALLED ON EACH LYFE, WHICH BE LOTHER LYFE ALL BEING A BEFORM AND A EXCESS THAT TO THE SECRET AND A SECRET LYFE AND A SECRET AND A SECRET LYFE AND A SECRET LY

# MIN MIN St. 2% C1 LANDING DETAIL SCALE 1/4"=1"-0" WHEN PORCH SLAE WITH ENTRY DOOR

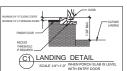



#### ELECTRICAL/ MECHANICAL LEGEND EXISTING WALLS CHIME DOORBELL PUSHBUTTON COMB. EXHAUST & LIGHT FIXT ✓ ELECT. FAN DUPLEX RECEPTABLE OUTLET GROUND FAULT INTERLIPT CIRC GROUND FAULT INTERUPT CIRCU pup. REC. OUTLET W/GROUND CEILING AIR REGISTER WATER HEATER FURNACE FOUR PLEX RECEPTICLE 220 V RECEPTABLE OUTLET RECESSED CEILING LIGHT HOSE BIBB CARBON MONOXIDE ALARMS WALL LIGHT WP () WATERPROOF ₩ INTERCOM ELECT. METER & MAIN PANEL FLUORESCENT LIGHT SMALL FLUORESCENT FIXTURE POTLIGHT ELECTRICAL SUB-PANEL RECESSED LIGHT DISPOSAL \$ WALL SWITCH CONCRETE STUCCO \$ 3 THREE-WAY SWITC \$ 4 FOUR-WAY SWITCH (E) EXISTING ⊗ SMOKE DETECTOR ▼ TELEPHONE OUTLET S.H. SINGLE HUNG FIX. FIXED GLASS ▼ TV/CABLE OUTLET

# GENERAL INTERIOR NOTES

- ALL LANDING AT MAIN ENTRY DOOR TO BE NOT MORE THAN 1/2" BELLOW THE DOOR'S THRESHOLD PER CRC 311.3.1.
- ALL PLUMBING VENTS TO BE A MINIMUM 10 FEET AWAY FROM, OR AT LEAST 3 FEET ABOVE ANY OPERABLE SKYLIGHTS PER CPC 908.2.
- ALL BATHTUB AND SHOWER FLOORS AND WALLS TO BE FINISHED WITH A NONABSORBENT SURFACE UP TO A HEIGHT OF 6 FEET (72") ABOVE FLOOR PER CRC 307.2.
- PROVIDE EXHAUST FAN KITCHEN AREA FOR LOCAL VENTILATION INDOOR AIR QUALITY REQUIREMENTS PER 2019 CALIFORNIA ENERGY CODE SECTION 150 (0) AND ASHRAE 62.2: OTHERWISE SPECIFY KITCHEN HOOD RANGE TO BE 100 CPM MINIMUM.
- PROVIDE CARBON MONOXIDE ALARMS OUTSIDE EACH BEDROOM PER CRC 315.2.
- ALL EXTERIOR RECEPTACLES TO BE GFCI PROTECTED.
- ALL 125-VOLT, 15-AND 20-AMPERE RECEPTACLE OUTLETS SHALL BE LISTED TAMPER RESISTANT RECEPTACLES PER CEC 406.11.
- PROVIDE SEPARATE SWITCHES FOR ALL EXHAUST FANS IN BATHROOMS PER CALIFORNIA ENERGY CODE 150(K)(8).
- 10 ALL NEW WAIDOWS SHALL HAVE A MAYARIM IL EACTOR OF 0.30

# SPECIAL SHOWER NOTES

ALL RECEPTACLES IN BATHROOM, GARAGES, ACCESSORY BUILDINGS, OL CRAWL SPACES, LINFINISHED BASEMENTS, KITCHENS (WHERE RECEPTAC COUNTER TOP SURFACES), LAUNDRY AREA, CIRCUIT INTERRUPTER (GFCI CEC210.8)

- .. SHOWER PAN DIMENSIONS TO BE A MINIMUM AREA OF 1034 SQ, INCHES AND A MINIMUM FINISH DIMENS OF 30 INCHES ANY DIRECTIONS.
- SHOWER DOORS SHALL OPEN TO MAINTAIN NOT LESS THAN A 22" UNOBSTRUCTED OPENING FOR EGRESS

## GENERAL NOTES

- PLANS TO COMPLY WITH CONVENTIONAL CONSTRUCTION PROVISIONS AS STATED IN 2019 CALIFORNIA RESIDENTIAL, BUILDING, MECHANICAL, PLUMBING, ELECTRICAL AND ENERGY CODES AS AMENDED BY STATE OF CALIFORNIA AND ALL CITY & MUNICIPAL (PROJECT LOCATED TO SPECIFY SEISMIC DESIGN CATEGORY E.)

CONTRICTOR OF DESCRIPTION RESIDENCY AND ADMINISTRATION OF CONTRICTOR OF DESCRIPTION OF CONTRICTOR OF

WINDOW..... APPROVED DOUBLE GLAZED NOTE: ALL OPENING, ALL DOORS, WINDOWS, ETC. TO BE CALLIKED OR FULLY WEATHER STRIPPED


- TIE. ALL OFFINING, ALL DOORS, WINDOWS, ETC TO BE CALLED OR FULLY WEATHER STRIPPED.

  PROCEEDING TO THE CAN RESOURTH, A GOOTIONS, RESOLD OF HEATT OR SHALL BE WRITHLED.

  FLOOR SHACKHOWN WITH HALDON'S BANKERS ON LINCE THE WASHINGTON OR OR WITH WITH A SHACK PROCESS.

  WIND SHACK HOUSE OR OR WITH SHALL BE ON LINCE SHALL BE ILL SHATE OR AD LINE SHALL BE ALL THE WASHINGTON OR SHATE OF THE WASHINGTON OF THE WASHING
- WINDOWS / BATHROOM NOTES

  1. ALL NEW WINDOW TO BE APROVED DOUBLE GLAZED (WITH BEDROOM WINDOWS HAVING A MIN. 2\* 24\* 90, OPENNO). REFER TO EGRESS WINDOW DIAGRAM
- ALL GLAZING IN OR WITHIN 36" OF DOORS, OVER 9 SQUARE FEET AND WITHIN 16" OF FLOOR AND ALL GLAZING IN SHOWERS OR BATHTUBS TO BE SAFETY GLASS.
- BATRROOM FINISH NOTE. RINISHE AS SMOUTH, HABE, NONASSORBENT SURFACE OVER A MOIST-LINE RESISTANT UNDERLAYMENT TO A HEIGHT OF 72" AGOUT THE BRAN NET FOR SHOWER PER GEO (213) WATER CLOSETS IN ALL BATHROOMS TO BE MAXIMUM 128 GALLONS PER FLUSH.

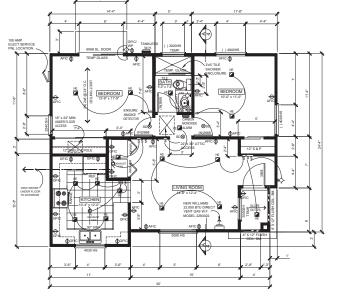

PROPOSED 2ND UNIT PLAN SCALE: 1/4" = 1'-0"

# TO BE ATTACHED OVER THE WOOD STRUCTURAL PANEL PANEL MUST BE ATTACHED TO CONCRETE FOOTING OF CONCRETE FOUNDATION WALL CONTINUOUS OVER BRACED WALL LINE (2) 1 / 2 " DIAMETER ANCHOR BOLTS LOCATED BETWEEN 6° AND 12° OF EACH END OF THE SEGMENT HOLDOWNS.....HDU2

EMBEDMENT.......10" MINIMUM INTO CONCRETE "ALL EPOXY INTO EXISTING FOUNDATION EPOXY...... SIMPSON SET XP EPOXY

ANCHOR BOLTS.....5/8" ALL THREAD EPOXIED

ALTERNATE BRACED WALL
PANEL DETAIL FIG. R602.10.6.1 ALTERNATE BRACED WALL 95050

AUGUSTINE DESIGNS

ATE:

OWNER DALJIT KAUR 1922 MAIN STREET SANTA CLARA, CA 96 PHONE: (198) 756-1311

PROPOSED NEW SINGLE FAMILY RESIDENCE AND NEW REAR DETACHED ADU

DATE: 5 -16 - 2020

SCALE: 1/4" = 1'-0" DRAWN: BRA

2a


#### ADDITIONAL... BATHROOM FIXTURE / ELECT PLUMBING, MECH AND INSULATION NOTES

- ALL SINK FAUCETS, SHOWER HEADS, TOILETS AND URINALS SHALL COMPLY WITH CALIFORNIA CIVIL CODE SECTION 1101.8 ( KITCHEN FAUCETS. SHALL NOT WITH CALF CRINIA CIVIL CODE BECT FUR 1101.0 INTEREST PROCESS OF BEXCEED 1.8 MAX PER FLUSH )... LAVATORY FALICETS SHALL NOT EXCEED 12 GALLONS...SHOWER HEADS SHALL NOT EXCEED...12 GALLONS... AND URINALS SHALL NOT EXCEED...5 GALLONS PER FLUSH
- PER CPC SECTION 402.2.2, SINGLE FLUSH WATER CLOSETS SHALL HAVE AN EFFECTIVE FLUSH VOLUME NOT TO EXCEED 1.26 GALLONS.
- INDOOR WATER USE SHALL BE REDUCED BY AT LEAST 20%BY USING WATER SAVING FIXTURES OR FLOW RESTRICTIONS OR DEMONSTRATE A 20% REDUCTION IN BASELINE WATER PER SECTION 4.303.1

NON-COMPLIANT PLUMBING FIXTURES SHALL BE REPLACED WITH WATER CONSERVING PLUMBING FIXTURES PER COGG SECTION 301.1.1 PLUMBING FIXTURE REPLACEMENT IS REQUIRED PRIOR TO ISSUANCE OF A CERTIFICATE OF FIXEL COMPLETION, CERTIFICATE OF COCUPANCY OR FIXAL PERMIT APPROVAL BY THE BUILDING DEPARTMENT

#### ELECTRICAL

- ALL BRANCH CRICLUTE THAT SUPPLY 155-YOLT, SWOILE PHASE, 15-AND 20 AMBRIER RECEPTALE ONLTEE BY SEXTALE DIA THE VIBELING LINET THAN 20 AMBRIER RECEPTALE CONTIETE BY SEXTALE DIA THE VIBELING LINET AND FAMILY ROOMS, PARLORS, BEDROOMS, LERRARES, DENS, HALLWAYS, RECEPTATION ROOM, COSET OR SIMILAR ROOMS OR AREAS SHALL BE PROTECTED BY A LISTED ANC-PAULT CIRCUIT INTERRUPTER TO PROVIDE PROTECTION OF THE ROTHER BRANCH CRECUIT CEC ARTICLES.
- ALL NEW AND REPLACED DUPLEX RECEPTACLES SHALL BE LISTED TAMPER-RESISTANT \* RECEPTACLE . 2016 CEC ART 406.12
- AT LEAST TWO 20-AMP BRANCE CIRCUITS SHALL BE PROVIDED FOR SMALL KITCHEN APPLIANCES AT THE COUNTER TOP (CEC 210.52)
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### ELECTRICAL NOTES

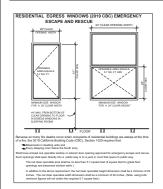- ALL 120 VOLT, SINGLE-PHASE: 15-AN GAMERE BRANCH CROLITS SUPPLYING OUTLETS OR DEVICES NOT TALLED IN DWELLING UNIT KTOPHEN, FAMILY ROOMS, DINNING ROOMS, LIWING ROOMS, PRACIOES, LIBRANES, DENS, EEDROOMS, SINGHOUS, RECORDING CODETS; HALLINGS, LURRAY RESPONSE ON BRANCH ROOMS OF AN EAST SAME A PROTECTED BY A LISTED ARE-FALLY CIPICALT INTERRUPPER (252 216 12).
- IN ALL AREAS SPECIFIED IN 210.52, ALL 125-VOLT, 15- AND 20- AMPERE RECEPTACLES SHALL BE LISTED TAMPER RESISTANT RECEPTACLES (15C 408 12)


### SPECIAL TITLE - 24 NOTES


- ALL LIGHTING TO BE HIGH EFFICACY AND MEET THE REQUIREMENTS OF SECTION 150 0(ty), AND LOOK APPENDIX JAS.


  ALL LIBRANISES THAT ARE INSTALLED WITH JAS CERTIFED LOHT SOURCES NEED TO BE CONTROLLED BY A DUMBER OR VICANCY SERSIOR. THIS IS NOT REQUIRED FOR LIGHTING BY CLOSETS LESS THAN 75967T OR IN HALLWAYS.
- ALL OUTDOOR LIGHTING TO BE HIGH EFFICACY AND CONTROLLED BY ONE OF THE FOLLOWING COMBINATIONS:


  - A. PHOTOCELL AND MOTION SENSOR
    B. PHOTOCELL AND TIME SWITCH
    C. ASTRONOMICAL TIME CLOCK
    D. EMCS WITH FEATURES OF ASTRONOMICAL TIME CLOCK.
    ECESSED IN INSULATED CELINGS SHALL COMPLY WITH THE FOLLO

  - A. SHALL BE ZERO CLEARANCE IC LISTED AND CERTIFIED AIR TIGHT.
     B. BE SEALED WITH GASKET OR CAULK BETWEEN LUMINAIRE HOUSING AND CEILING AND AT ALL AIR LEEK.
  - C. SHALL NOT CONTAIN SCREW BASE SOCKETS

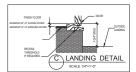

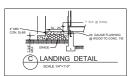

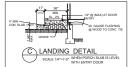

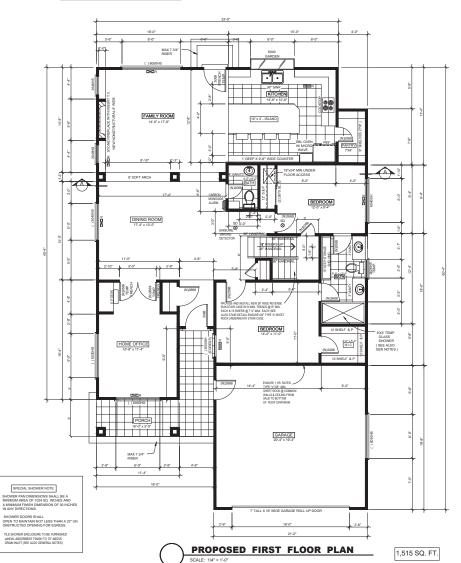

ELECTRICAL/ MECHANICAL LEGEND							
	EXISTING WALLS		CHIME				
	NEW WALLS	•	DOORBELL PUSHBUTTON				
=====	WALLS TO BE REMOVED		COMB. EXHAUST & LIGHT FIXT				
777772	CLOSE WALLS	/@/	ELECT. FAN				
↔	DUPLEX RECEPTABLE OUTLET	•	HEAT LAMP				
gnc <b>⊖l</b>	GROUND FAULT INTERUPT CIRCUIT	M	HEATER REGIST.				
wp. 😝	DUP. REC. OUTLET WIGROUND	N	CEILING AIR REGISTER				
<b>⊕</b> H	FOUR PLEX RECEPTICLE	0	WATER HEATER				
₩.	220 V RECEPTABLE OUTLET	$\boxtimes$	FURNACE				
	RECESSED CEILING LIGHT	Į	HOSE BIBB				
<b>⊘</b> HE	HIGH EFFICACY LIGHT	177A	CARBON MONOXIDE ALARMS				
фı	WALL LIGHT	₩/	INTERCOM				
w»-¢H	WATERPROOF WALL LIGHT FIXTURE	þ	ELECT. METER & MAIN PANEL				
> <	FLUORESCENT LIGHT	m	ELECTRICAL SUB-PANEL				
	SMALL FLUORESCENT FIXTURE	p	RECESSED LIGHT				
$\vdash$	SPOTLIGHT	1	DISPOSAL				
\$	WALL SWITCH	87-27-43	CONCRETE				
\$3	THREE-WAY SWITCH	218256E	STUCCO				
\$4	FOUR-WAY SWITCH	(E)	EXISTING				
8	SMOKE DETECTOR	H.S.	HORIZONTAL SLIDER				
▼	TELEPHONE OUTLET	S.H.	SINGLE HUNG				
$\nabla$	TV/ CABLE OUTLET	FIX.	FIXED GLASS				

#### GENERAL INTERIOR NOTES

- ALL BATHTUB AND SHOWER FLOORS AND WALLS TO BE FINISHED WITH A NONABSORBENT SURFACE UP TO A HEIGHT OF 6 FEET (72") ABOVE FLOOR PER CRC 307.2.
- PROVIDE EXHAUST FAN KITCHEN AREA FOR LOCAL VENTILATION INDOOR AIR QUALITY REQUIREMENTS PER 2019 CALIFORNIA ENERGY CODE SECTION 150 (0) AND ASHRAE 62.2. OTHERWISE SPECIFY KITCHEN HOOD RANGE TO BE 100 CFM MINIMUM.
- ALL EXTERIOR RECEPTACLES TO BE GFCI PROTECTED.
- ALL 125-VOLT, 15-AND 20-AMPERE RECEPTACLE OUTLETS SHALL BE LISTED TAMPER-RESISTANT RECEPTACLES PER CEC 406.11:
- PROVIDE SEPARATE SWITCHES FOR ALL EXHAUST FANS IN BATHROOMS PER CALIFORNIA ENERGY CODE 150(K)(8).( FANS AND LIGHTS TO BE SEPARATELY SWITCHED.)
- ALL NEW WINDOWS SHALL HAVE A MAXIMUM U-FACTOR OF 0.30

#### GENERAL NOTES

- PLANE TO COMPAY WITH CONSTRUCTION PROVISIONS AS STATED IN PLANE TO COMPAY WITH CONSTRUCTION PROVISIONS AS STATED IN CONSTRUCTION PROVISION AS STATED IN CONSTRUCTION AND ALL CITY AMERICAN COMPACT COLORS TO DEPOY THE SERVE SHEET AND ALL CITY AMERICAN COMPACT COLORS TO COMPAY THE SERVE SHEET AND ADMITTANT FOR THE SERVE SHEET AND ALL CITY AMERICAN CONSTRUCTION OF THE SERVE SHEET AND ADMITTANT FOR THE SERVE SHEET AN
- CONTROL TO THE POWER CONTRIBUTE CONTROL TO THE CONTROL TO THE CONTROL THE CONT

- NOTE: ALL OPPINIO, ALL DOORS, WINDOWS, ETC. TO BE CALUKED OR FULLY WEATHER STRIPPED SUPPLEMENT TO TITLE 24 FOR RESIDENTIAL ADDITIONS.
- PLEMBAT TO THE 24 FOR RESIDENTIAL ADDITIONS.

  ROOF SHEATHON WITH HADANT BEARER ON INDERSIDE OF SHEATO SHALL BE INSTALLED.
  ALL MINDOWS SHALL HAVE A SIGNAR HEAT COAN COEFFICIENCY OF A ON BETTER.
  ALL MINDOWS SHALL HAVE A SIGNAR HEAT COAN COEFFICIENCY OF A ON BETTER HEATON FOR THE PROPERTY OF THE PROPERTY

- OWS / BATHROOM NOTES

  ALL NEW WINDOW TO BE APROVED DOUBLE GLAZED (WITH BEDROOM WINDOWS HAVING A MIN. 24" X-9" SO, DPENNIG), REFER TO EGRESS WINDOW DIAGRAM

- ALL GLAZING IN OR WITHIN 36" OF DOORS, OVER 9 SQUARE FEET AND WITHIN 16" OF FLOOR AND ALL GLAZING IN SHOWERS OR BATHTUBS TO BE SAFETY GLASS.

ATE:

Professional Design Consultants 3033 Morpark Ave. #1 San Jose, CA 95128 (408) 294-7060



OWNER
DALJIT KAUR
1922 MAIN STREET
SANTA CLARA, CA 95
PHONE: (196) 756-1311

PROPOSED NEW SINGLE FAMILY RESIDENCE WITH DETACHED (ADU)

DATE: REV 03/20/202

SCALE: 1/4" = 1'-0"

RAWN: BRA

BATHROOM PROHINGE A SHORT HAVE A SHORT HAVE

3

## ADDITIONAL... BATHROOM FIXTURE / ELECT /

- ALL SINK FAUCETS, SHOWER HEADS, TOILETS AND URRNALS SHALL COMPLY WITH CALIFORNA CIVIL. CODE SECTION 1911.5 (WITCHEN FAULETS SHALL) EXCECED 1.8 MAY PER FLUSH). LAWATORY FAUCETS SHALL NOT EXCEED 1.2 CALLONS. SHOWER HEADS SHALL NOT EXCEED 1.3 CALLONS. AND URRNALS SHALL NOT EXCEED 5.0 CALLONS. AND URRNALS SHALL NOT EXCEED 5.0 CALLONS PER TABLE SHALL SHA
- PER CPC SECTION 402.2.2, SINGLE FLUSH WATER CLOSETS SHALL HAVE AN EFFECTIVE FLUSH VOLUME NOT TO EXCEED 1.28 GALLONS.
- INDOOR WATER USE SHALL BE REDUCED BY AT LEAST 20% BY USING WATER SAVING FIXTURES OR FLOW RESTRICTIONS OR DEMONSTRATE A 20% REDUCTION IN BASELINE WATER PER SECTION 4 303.1
- ALL ADDITIONS ON OR AFTER JANUARY 1,2014 SHALL REPLACE NON COMPLIANT PLUMBING FIXTURES WITH WATER CONSERVING PLUMBING FIXTURES

NON-COMPLIANT PLUMBING FIXTURES SHALL BE REPLACED WITH WATER CONSERVING PLUMBING FIXTURES PER COGC SECTION 301.1.1 PLUMBING FIXTURE REPLACEMENT IS REQUIRED PROVED TO SUBJURICE OF A CERTIFICATE OF FOUL COMPLETION, CERTIFICATE OF COCUPANCY OR FINAL PERMIT APPROVAL ST THE BUILDING DEPARTMENT

#### ELECTRICAL


- AT LEAST TWO 20-AMP BRANCE CIRCUITS SHALL BE PROVIDED FOR SMALL KITCHEN APPLIANCES AT THE COUNTER TOP (CEC 210.52)
- ALL RECEPTACLES IN KITCHEN AREAS TO BE GFIC TAMPER PROOF NOT TO EXCEED. 4'-0" O.C.
- ALL EXHAUST FANS THROUGHOUT THE RESIDENCE SHALL BE SWITCHED SEPARATELY FROM ANY LIGHTING SYSTEM
- ALL KITCHEN EXHAUST SHALL BE DUCTED TO THE EXTERIOR

#### SMOKE DETECTOR NOTES

PROVIDE 1 EACH SMOKE DETECTOR IN ALL SLEEPING ROOMS AND AT A POINT CENTRALLY LOCATED IN AN AREA GIVING ACCESS TO THE SLEEPING ROOMS

IN DWELLING UNITS, A DETECTOR SHALL BE INSTALLED IN THE CORRIDOR OR AREA GIVING LESEPHOR DOOL AND AT POINT CENTRALLY LOCATED IN THE CORRIDOR OR AREA GIVING ACCESS TO EACH SEPARATE SEEPING AREA WHEN THE OWNELING UNIT HAS MODE THAN ONE THAN ONE THE ACCESS TO EACH SEPARATE SEPARATE SEPARATE AND THE MACESTALLY OF THE ACCESSION OF THE BASEMENT IN OWILLING UNITS WHERE A STORY OR BASEMENT IS SPUT INTO TWO OR MORE LEVELS.


THE MADE DETECTOR BHALL BE INSTALLED IN THE UPPER LEVEL DOOPT THAT WHICH THE CONTROL AS EXEMPTION OF THE CONTROL WITH WHITE THE CESSAR HEIGHT OF A GOOD OWN TO THE HEIGHT OF THE CESSAR HEIGHT OF A GOOD OWN TO THE HEIGHT OF THE CESSAR HEIGHT OF A GOOD OWN TO THE HEIGHT OF THE CESSAR HEIGHT OF THE CESSAR

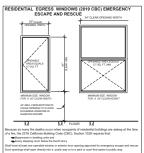

weeking weeking commence are businessed.

This was all least one operatible window or eather's door opening approved for emergency excape and re-openings shall open directly into a public way or to a yard or court that opens to public way.

The rist clear openable area shall be no less than 5.7 equare feet [5 aquare feet for grade floor openings and beament visiodow wells.]

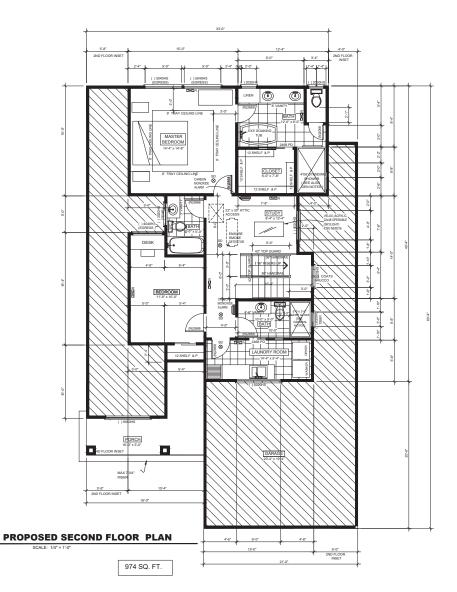

SPECIAL TITLE - 24 NOTES

ALL LIGHTING TO BE HIGH EFFICACY AND MEET THE REQUIREMENTS OF SECTION 150.0(K) AND JOINT APPENDIX JAB.

ALL LUMINAIRES THAT ARE INSTALLED WITH JAS-CERTIFIED LIGHT SOURCES NEED TO BE CONTROLLED BY A DIMMER OR VACANCY SENSOR. THIS IS NOT REQUIRED FOR LIGHTING IN CLOSETS LESS THAN

ALL OUTDOOR LIGHTING TO BE HIGH EFFICACY AND CONTROLLED BY ONE OF THE FOLLOWING COMPRISATIONS:

- A. PHOTOCELL AND MOTION SENSOR
  B. PHOTOCELL AND TIME SWITCH
  C. ASTRONAMOL TIME CLOCK
  C. ASTRONAMOL TIME CLOCK
  LIMMARES RECESSED IN SELECT BY ASTRONAMICAL TIME CLOCK.
  LIMMARES RECESSED IN SELECT BY CLOCK SHALL COMPLY WITH THE FOLLOWING.

  - C. SHALL NOT CONTAIN SCREW BASE SOCKETS

	ELECTRICAL/ MEG	CHANICA	L LEGEND
	EXISTING WALLS		CHIME
	NEW WALLS		DOORBELL PUSHBUTTON
=====	WALLS TO BE REMOVED		COMB. EXHAUST & LIGHT FIXT
	CLOSE WALLS	/@/	ELECT. FAN
⇔ı	DUPLEX RECEPTABLE OUTLET	•	HEAT LAMP
anc <b>H</b>	GROUND FAULT INTERUPT CIRCUIT	$\boxtimes$	HEATER REGIST.
w.p. 😝	DUP. REC. OUTLET WIGROUND		CEILING AIR REGISTER
⊕1	FOUR PLEX RECEPTICLE	0	WATER HEATER
€	220 V RECEPTABLE OUTLET	$\boxtimes$	FURNACE
	RECESSED CEILING LIGHT	Ŧ	HOSE BIBB
<b>⊘</b> HE	HIGH EFFICACY LIGHT	1773	CARBON MONOXIDE ALARMS
♦	WALL LIGHT	₩/	INTERCOM
w» 🗘	WATERPROOF WALL LIGHT FIXTURE	d	ELECT. METER & MAIN PANEL
X	FLUORESCENT LIGHT	<u>f</u>	ELECTRICAL SUB-PANEL
I	SMALL FLUORESCENT FIXTURE	0	RECESSED LIGHT
Υ	SPOTLIGHT		DISPOSAL
\$	WALL SWITCH	A 100 G	CONCRETE
\$ <sub>3</sub>	THREE-WAY SWITCH	2000	STUCCO
\$4	FOUR-WAY SWITCH	(E)	EXISTING
8	SMOKE DETECTOR	H.S.	HORIZONTAL SLIDER
	TELEPHONE OUTLET	S.H.	SINGLE HUNG
$\nabla$	TV/ CABLE OUTLET	FIX.	FIXED GLASS

#### GENERAL NOTES

- PLANE TO COMEY WITH CONSTRUCTION, CONTRICTION PROVISION AS STATED IN MANY CONTRICTION PROVISION AS STATED IN MANY CONTRICTION PROVISION AS STATED IN MANY CONTRICTION PROVISION AS STATED IN CONTRICTION PROVISION AS STATED IN CONTRICTION PROVISION AS STATED IN CONTRICTION PROVISION CONTRICTION PROVISION CONTRICTION PROVISION CONTRICTION CONTR

- THE WORK CONTRACTION IS NOT TO SULLE DIMENSION.

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- DOTE TALL OFFICIALS, ALL DOMES, WINDOWS, CIT. 10 SEC. ALL DOMES, A

- WINDOWS / BATHROOM NOTES

  1. ALL NEW WINDOW TO BE APROVED DOUBLE GLAZED (WITH BEDROOM WINDOWS HAVING A MIN. 24" 24" SQ. OPENING), REFER TO EGRESS WINDOW DIAGRAM.
- ALL GLAZING IN OR WITHIN 36" OF DOORS, OVER 9 SQUARE FEET AND WITHIN 18" OF FLOOR AND ALL GLAZING IN SHOWERS OR BATHTUBS TO BE SAFETY GLASS.
- BATHROOM FINDS HOTEL ENGINE A BMODTH, HARD, NONABSORBENT SURFACE OVER A MOST LIVE RESISTANT UNDERLAYMENT TO A HEIGHT OF 72" ABOVE THE BRANK HARE FOR SHOWER PER CEC 1233.

  WATER CLOSETS IN ALL BATHROOMS TO BE MAXMUM 1 28 GALLONS PER FLUSH.

DATE REV. 05/18/2021

AUGUSTINE DESIGNS

OWNER DALJIT KAUR 1922 MAIN STREET SANTA CLARA, CA 95050 PHONE: (196) 756-1311


PROPOSED NEW SINGLE FAMILY RESIDENCE WITH DETACHED (ADU)

DATE: 03/23/2022

SCALE: 1/4" = 1'-0"

DRAWN: BRA



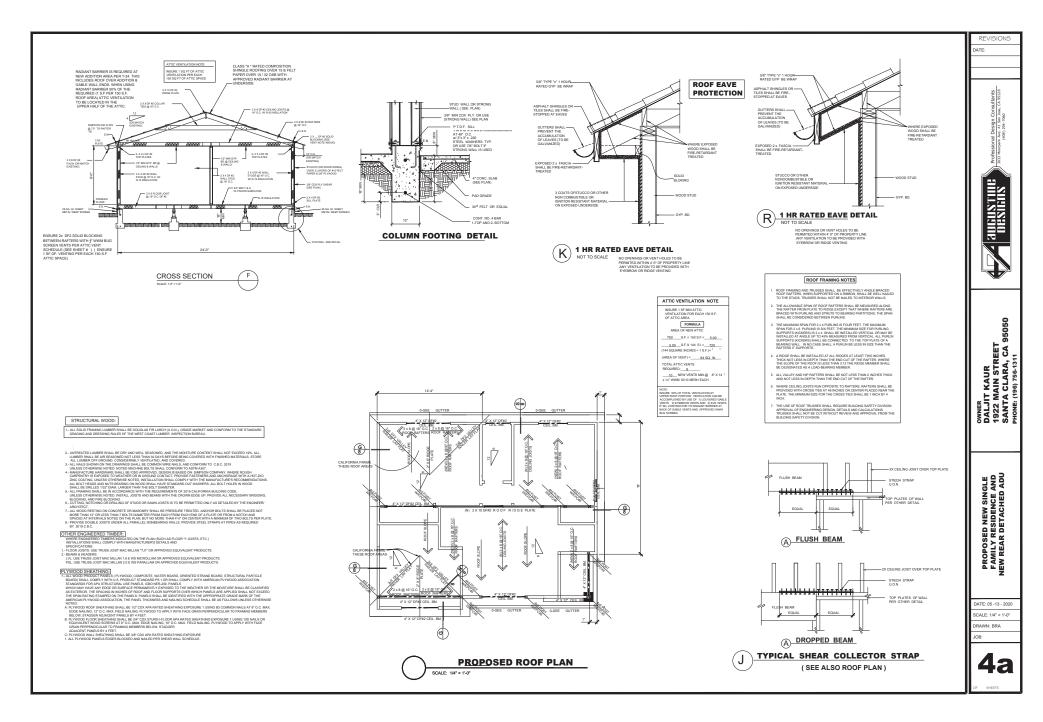


# ADDITIONAL... BATHROOM FIXTURE / ELECT / PLUMBING, MECH AND INSULATION NOTES

- ALL SIM PAULE IS DOWNER HEADS, (OLLETS AND UNINUALS SHALL CORNET WITH CALIFORNIA CIVIL CODE SECTION 1101.8 (KITCHEN FAUCETS SHALL NOT EXCEED 1.8 MAX PER FLUSH )... LAVATORY FAUCETS SHALL NOT EXCEED 1.2 GALLONS. SHOWER HEADS SHALL NOT EXCEED 1.2 GALLONS... AND URINNLS SHALL NOT EXCEED 5.2 GALLONS PER FLUSH
- INDOOR WATER USE SHALL BE REDUCED BY AT LEAST 29/89 USING WATER SAVING FIXTURES OR FLOW RESTRICTIONS OR DEMONSTRATE A 20% REDUCTION IN BASELINE WATER PED SECTION.
- ALL ADDITIONS ON OR AFTER JANUARY 1,2014 SHALL REPLACE NON COMPLIANT PLUMBING FIXTURES WITH WATER CONSERVING PLUMBING FIXTURES

NON-COMPLIANT PLIMBING FIXTURES SHALL BE REPLACED WITH WATER CONSERVING PLUBBING FOTURES PER COSC SECTION 301.1.1 PLUBBING STYLINE SHALL DESIRED FOR THE SUBJECT OF A CERTIFICATE OF FINAL COMPLETION, CERTIFICATE OF OCCUPANCY OR FINAL PERMIT APPROVAL ST THE BUILDING DEPARTMENT.

#### ELECTRICAL


- ALL BRANCH CRICLITS THAT SUPPLY 155-YOLT, SINGLE PHAGE, 55-AND 20 AMPRISE RECOMPLOLE OUTLES NOTALLED NA ORELLING LINKT LANKE, ONNEL AND FAN YOURSE, PAULOSE RECROOKS LIBBORISES DIPS. HALLWAYS, RECREATION ROOM, CLOSET OR SMALAR ROOMS OR AREAS PAUL SECONDER STREAM, TOWNER OF THE REPORT OF THE PROVIDE PROTECTED BY A LISTED AND FAULT CITEDY LITERAPHIET TO PROVIDE PROTECTION OF THE ENTIRE BRANCH CRICLIT. CEC ARTICLE 210:12.
- ALL NEW AND REPLACED DUPLEX RECEPTACLES SHALL BE LISTED TAMPER-RESISTANT \* RECEPTACLE. 2016 CEC ART 406.12
- AT LEAST TWO 20-AMP BRANCE CIRCUITS SHALL BE PROVIDED FOR SMALL KITCHEN APPLIANCES AT THE COUNTER TOP (CEC 210.52)
- ALL RECEPTACLES IN KITCHEN AREAS TO BE GFIC TAMPER PROOF NOT TO EXCEED. 4'40' O.C.
- ALL KITCHEN EXHAUST SHALL BE DUCTED TO THE EXTERIOR

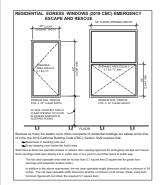


### ELECTRICAL NOTES


- ALL 120 VOLT, SINGLE-PHASE, 15-AND 20-AMPERE BRANCH CIRCUITS SUPPLYING OUTLETS OR DEVICES INSTALLED IN DWELLING LINIT KITCHENS, FAMLY ROOMS, DINNING ROOMS, PARI CORS, LISARRES, DENS, BEDFOOMS, SURROOMS, RICHESTON ROOMS, CLOSETS, HALLIMAYS, LAUNDRY AREAS, OR SIMILAR ROOMS OR AREAS SHALL BE PROTECTED BY A LISTED ARE FAULT CIRCUIT INTERRUPTER.

NEW ELECTRICAL LIGHTING IN GARAGE, KITCHEN & LAUNDRY ROOM TO BE HIGH EFFICIENCY LUMINARIES PER TITLE 24

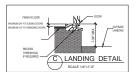

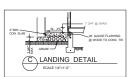



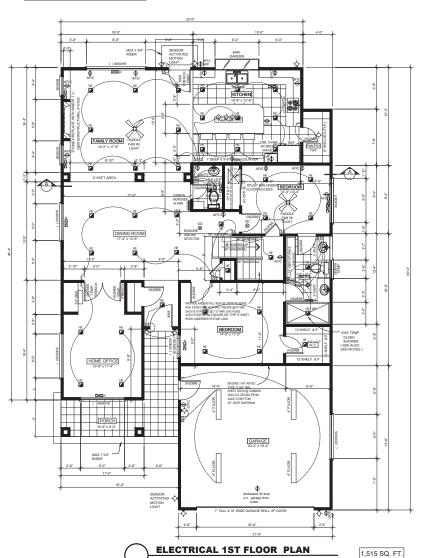

	ELECTRICAL/ ME	CHANICAL	LEGEND
	EXISTING WALLS	Α.	CHIME
*****	NEW WALLS	•	DOORBELL PUSHBUTTON
	WALLS TO BE REMOVED		COMB. EXHAUST & LIGHT FIXT
	CLOSE WALLS	<i>∕</i> ⊚∕	ELECT. FAN
€	DUPLEX RECEPTABLE OUTLET	•	HEAT LAMP
anc <b>Ol</b>	GROUND FAULT INTERUPT CIRCUIT	$\boxtimes$	HEATER REGIST.
w. <b>₽.⊖I</b>	DUP. REC. OUTLET W/GROUND		CEILING AIR REGISTER
<del>\$</del> I	FOUR PLEX RECEPTICLE	0	WATER HEATER
⇔ı	220 V RECEPTABLE OUTLET		FURNACE
	RECESSED CEILING LIGHT	#	HOSE BIBB
<b>⊘</b> HE	HIGH EFFICACY LIGHT	273	CARBON MONOXIDE ALARMS
ф	WALL LIGHT	₩/	INTERCOM
wr 🗘	WATERPROOF WALL LIGHT FIXTURE	Д	ELECT. METER & MAIN PANEL
$\sim$	FLUORESCENT LIGHT	550	ELECTRICAL SUB-PANEL
$\overline{}$	SMALL FLUORESCENT FIXTURE	a	RECESSED LIGHT
<b>≻</b>	SPOTLIGHT	•	DISPOSAL
\$	WALL SWITCH	AT STATE	CONCRETE
\$ <sub>3</sub>	THREE-WAY SWITCH	2005	STUCCO
\$4	FOUR-WAY SWITCH	(E)	EXISTING
8	SMOKE DETECTOR	H.S.	HORIZONTAL SLIDER
▼	TELEPHONE OUTLET	S.H.	SINGLE HUNG
$\nabla$	TV/ CABLE OUTLET	FIX.	FIXED GLASS

#### SPECIAL ELECTRICAL NOTES

- A... THE BATHROOM OUTLET IS TO BE A DEDICATED CIRCUIT, PER SECTION 210.11C OF THE 2019 CEC
- B... THE KITCHEN COUNTERTOP OUTLETS TO HAVE A MIN OF 2 DEDICATED CIRCUITS, PER SECTION 210.52B (2) OF THE 2019 CEC
- C... PER SECTION 210.52C OF THE 2019 CEC, ELECTRICAL OUTLETS ARE REQUIRED TO BE SPACED SUCH THAT NO SECTION OF WALL IS MORE THAT 24-INCHES FROM AN OUTLET FOR KITCHEN COUNTERTOPS.
- D... ALL BEDROOM CIRCUITS SHALL BE LISTED COMBINATION TYPE ARC-FAILT CRULIT WITEHRUPTERS PROTECTED AT THE PANEL. CIRCUITS INCLIDE COULTES AND COMBINED THE PANEL. CIRCUITS INCLIDE COULTES. ROOMS WITHIN BEDROOMS (SIGURE AS LOCKETS AND OFFER BATHROOMS/AVANITIES) SHALL ALSO BE INCLIDED. PER SECTION 210.12 (8) OF 2019 (EC.)

#### GENERAL NOTES

- PLANS TO COMPLY WITH CONVENTIONAL CONSTRUCTION PROVISIONS AS STATED IN 2019 CALIFORNIA RESIDENTIAL, BULLDING, MECHANICAL, PLUMBING, ELECTRICAL AND ENERGY CODES AS AMMENDED BY STATE OF CALIFORNIA AND ALL CITY & MUNICIPAL (PROJECT LOCATED TO SPECIFY SEISMIC DESIGN CATEGORY E.)

- PROJECT LOCATION DESCRIPTION OF CONTROL MICHIGAN CONTROL TO A CONTROL

DWELTING UNTIL WHITCH THE PARE DOCATED:

NISULATION CERSON. — R. 98 BATT INSULATION (NEW CONST. ONLY)

FLOOR. — R. 19 EART INSULATION (NEW CONST. ONLY)

FLOOR. — R. 19 FLOOR INSULATION

ACCESS: UNDERFLOOR. — 15" x 2" MM s.0 (F WOOD FLOOR)

CELLING. — 2" x 2" MM s. WIGO\* CLEAR FEIGHT.

WINDOW. — APPROVED DOUBLE GLAZED

NOTE: ALL OPENING, ALL DOORS, WINDOWS, ETC. TO BE CALUKED OR FULLY WEATHER STRIPPED

- NOTE AL OPENNO, AL DOORS, WINDOWS, ET. TO BE COLLISED OF PLLY WEATHER STRIPPED.

  SEPPLEMENT TO TILLY SOME RESIDENTIAL ACKNOWN.

  1. ROOF SEATHER UNTIL MOUNT BAMERS ON INCREDISCO OF SHEAT TO SHALL BE RISTALLED.

  1. ROOF SEATHER UNTIL MOUNT BAMERS ON INCREDISCO OF SHEAT TO SHALL BE RISTALLED.

  1. ROOF SEATHER UNTIL MOUNT BAMERS ON INCREDISCO OF SHEAT TO SHALL BE RISTALLED.

  1. ROOF SEATHER UNTIL MOUNT BAMERS ON INCREDISCO OF SHEAT TO SHALL BE RISTALLED ON SHEAT THE MOUNT BAMERS FOR MOUNT BAMERS FO

- ALL GLAZING IN OR WITHIN 35" OF DOORS, OVER 9 SQUARE FEET AND WITHIN 15" OF FLOOR AND ALL GLAZING IN SHOWERS OR BATHTUSS TO DE SAFETY GLASS. BATHROOM PRINS HOTE. ELSINES A BOMOTH, HAND, NOUMBORBENT SURFACE OVER A MOSTURE RESISTANT UNDERLAYMENT TO A HEIGHT OF 72" ABOUT THE ORAN MEET FOR SHOWER FRE GED 2113.
- WATER CLOSETS IN ALL BATHROOMS TO BE MAXIMUM 1.28 GALLONS PER FLUSH

5

REVISIONS


AUGUSTINE DESIGNS

OWNER DALJIT KAUR 1922 MAIN STREET SANTA CLARA, CA 95050 PHONE: (198) 756-131

PROPOSED NEW SINGLE FAMILY RESIDENCE WITH DETACHED (ADU)

DATE: REV 03/20/202 SCALE: 1/4" = 1'-0"

RAWN: BRA

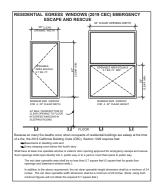

#### SMOKE DETECTOR NOTES

A. SMOKE DETECTORS.

PROVIDE 1 EACH SMOKE DETECTOR IN ALL SLEEPING ROOMS AND AT A POINT CENTRALLY LOCATED IN AN AREA GIVING ACCESS TO THE SLEEPING ROOMS

IN INSW CORBITACITION, REQUIRED BIONED DETECTOR SHALL RECEIVE
THEM PRAMARY POWER FROM THE BELLINGH WINNING WHIS JUCH WINNING THE EFFECTOR
CHAMBELLA, SOURCE AND SHALL BE EQUIPED WITH A BATTEW SACKUF. THE EFFECTOR
WITHOUT A DESCONACTION GENTLO THAN THOSE REQUIRED FROM VIRE OF THE PROTECTION, SHALLOW SECTION SHALLOW A SHALLOW S


B) LOCATION WITHIN DWELLING UNITS:

IN DWELLING LINTS, A DETECTOR SHALL BE INSTALLED IN LEAD SEEPING ROOM AND AT POINT CENTRALLY LOCATED IN THE CORRIDOR OR AREA GIVING ACCESS TO SEACH SEPANATE SEEPING AREA WHEN THE DWILLING LINT HAS MORE THAN DISC. ACCESS TO SEACH SEPANATE SEPANATE SEPANATE OF WHICH THE SHALL BOTH THE SEACH OF THE SEACH SEPANATE SEPANATE OF THE BASEMENT IS SPATE INTO TWO OR MORE LEVELS.

THE WAS THE COURT AND ALL ESTABLED BY THE UPPER LIVES. EXPERT WHITE WAS THE COURT LIVES COUNTY LIVES CONTINUED TO THE COUNTY LIVES COUNTY LIVES COUNTY LIVES COUNTY TO THE COUNTY TO COUNTY TO

#### GENERAL INTERIOR NOTES

- ALL LANDING AT MAIN ENTRY DOOR TO BE NOT MORE THAN 1/2" BELLOW THE DOOR'S THRESHOLD PER CRC 311.3.1.
- ALL PLUMBING VENTS TO BE A MINIMUM 10 FEET AWAY FROM, OR AT LEAST'S FEET ABOVE ANY OPERABLE SKYLJOHTS PER CPC 906.2.
- ALL BATHTUB AND SHOWER FLOORS AND WALLS TO BE FINISHED WITH A NONABSCRIBENT SURFACE UP TO A HEIGHT OF 6 FEET (72') ABOVE FLOOR PER CRC 307.2.
- PROVIDE EXHAUST FAN KITCHEN AREA FOR LOCAL VENTILATION INDOOR AIR QUALITY REQUIREMENTS PER 2019 CALIFORNIA ENERGY CODE SECTION 150 (II) AND ASHRAE 62.2. OTHERWISE SPECIFY KITCHEN HOOD RANGE TO BE 100 CPM MINIMUM.
- PROVIDE CARBON MONOXIDE ALARMS OUTSIDE EACH BEDROOM PER CRC 315.2.
- 6 ENSURE AFCI PROTECTED RECEPTACLES IN LIVING BOOM PER CEC 210.12
- ALL EXTERIOR RECEPTACLES TO BE GFCI PROTECTED.
- PROVIDE SEPARATE SWITCHES FOR ALL EXHAUST FANS IN BATHROOMS PER CALIFORNIA ENERGY CODE 150(K)(6).
- 10. ALL NEW WINDOWS SHALL HAVE A MAXIMUM U-FACTOR OF 0.30

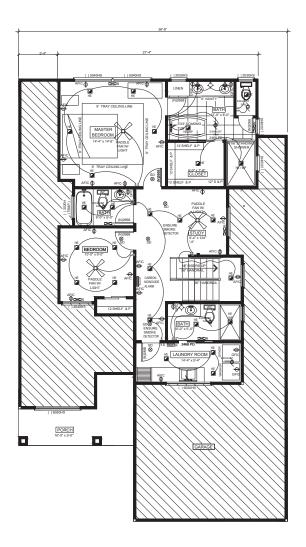



	ELECTRICAL/ ME	CHANICA	L LEGEND
	EXISTING WALLS		CHIME
	NEW WALLS	•	DOORBELL PUSHBUTTON
=::=::=	WALLS TO BE REMOVED		COMB. EXHAUST & LIGHT FIXT
	CLOSE WALLS	∕⊚∕	ELECT. FAN
⇔	DUPLEX RECEPTABLE OUTLET	•	HEAT LAMP
anc <b>⊖l</b>	GROUND FAULT INTERUPT CIRCUIT	$\boxtimes$	HEATER REGIST.
w.p. <del>O</del> I	DUP. REC. OUTLET W/GROUND		CEILING AIR REGISTER
₩.	FOUR PLEX RECEPTICLE	0	WATER HEATER
⇔	220 V RECEPTABLE OUTLET	M	FURNACE
	RECESSED CEILING LIGHT	+	HOSE BIBB
<b>⊘</b> HE	HIGH EFFICACY LIGHT	1273	CARBON MONOXIDE ALARMS
÷Н	WALL LIGHT	₩/	INTERCOM
w-어	WATERPROOF WALL LIGHT FIXTURE	石	ELECT. METER & MAIN PANEL
><	FLUORESCENT LIGHT	The state of	ELECTRICAL SUB-PANEL
$\overline{\mathbf{I}}$	SMALL FLUORESCENT FIXTURE	п	RECESSED LIGHT
⊳-	SPOTLIGHT	10	DISPOSAL
\$	WALL SWITCH		CONCRETE
\$ <sub>3</sub>	THREE-WAY SWITCH	PESSEE	STUCCO
\$4	FOUR-WAY SWITCH	(E)	EXISTING
8	SMOKE DETECTOR	H.S.	HORIZONTAL SLIDER
▼	TELEPHONE OUTLET	S.H.	SINGLE HUNG
▽	TV/ CABLE OUTLET	FIX.	FIXED GLASS

#### SPECIAL ELECTRICAL NOTES

- A... THE BATHROOM OUTLET IS TO BE A DEDICATED CIRCUIT, PER SECTION 210.11C OF THE 2019 CEC

- D... ALL BEDROOM CIRCUITS SHALL BE LISTED COMBINATION TYPE ARCFALLT CREUIT MITERIUPIERS PROTECTED AT THE FANEL CREUITS INCLIDE COULTER CREOMERS PROTECTED AT THE FANEL CREUITS INCLIDE CREOMERS AND CREO

#### RESIDENTIAL ENERGY LIGHTING NOTES

- RECESSED DOWNLIGHT LUMINAIRES IN CELINGS SHALL BE LISTED FOR ZERO CLEANANCE SHALL BE CERTIFIED AS ARTHORI INCLUDING DEVALUES FAN LUMINAIRE HOUSENESS AND SHALL BE CONTINUED AND CELLING SHALL NOT CONTINUE SCENE WAS ECONCETS, AND ALL LIGHT SOURCES SHALL BE MARKED WITH "JAB-2019-E" AS SPECIFIED IN REFERENCE CONT APPENDIX JAB.
- C) EXHAUST FANS SHALL BE SWITCHED SEPARATELY FROM LIGHTING SYSTEM.
- LUMINAIRES SHALL BE SWITCHED WITH READILY ACCESSIBLE CONTROLS THAT PERMIT THE LUMINAIRES TO BE MANUALLY SWITCHED ON AND OFF.
- E) IN BATHROOMS GARAGES, LAUNDRY ROOMS, AND UTILITY ROOMS, AT LEAST ONE LUMINAIRE IN EACH OF THESE SPACES SHALL BE CONTROLLED BY A VACANCY SENSOR.
- UNDER CABINET LIGHTING SHALL BE SWITCHED SEPARATELY FROM OTHER LIGHTING SYSTEMS.
- RESIDENTIAL OUTDOOR LIGHTING SHALL BE CONTROLLED BY A MANUAL ON AND OFF SWITCH WITH PHOTOCELL AND MOTION SENSOR.

OWNER
DALJIT KAUR
1922 MAIN STREET
SANTA CLARA, CA 95
PHONE: (196) 756-1311

PROPOSED NEW SINGLE FAMILY RESIDENCE AND REAR DETACHED ADU


DATE: 05/19/2020

SCALE: 1/4" = 1'-0" DRAWN: BRA







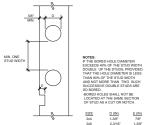

# ALLOWABLE HOLES & NOTCHES IN LOAD-BEARING STUDS


PLYWOOD FLOOR SHEATHING:


B: PLYWOOD FLOOR SHEATHING SHALL BE 34" CDX
STURD-I-FLOOR APA RATED SHEATHING EXPOSUR
1 USING 10D NAILS OR FQUIVALENT WOOD SCREW

SPECIAL HOLDOWN ANCHOR NOTE


ANCHORS TO BE TIED
IN PLACE PRIOR TO CALLING FOR
FOUNDATION INSPECTION

PLEASE REFER TO BRACED WALL PANEL NOTES ON SHEET #3 FOR SHEAR WALL SCHEDULE AND NAILING SCHEDULE

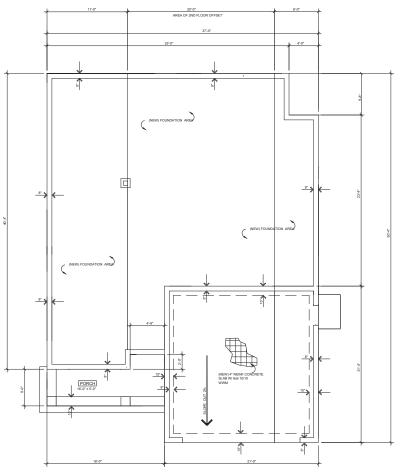


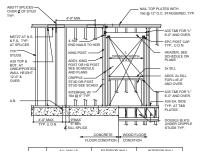

7.1	ALL WALLS IG KING POST			EXTERIOR WALL CRIPPLE STUDS/POSTS			INTERIOR WALL CRIPPLE STUDS/POSTS		
OPENING									
WIDTH	LEVEL			LEVEL			LEVEL		
(MAX.)	3RD	2ND	1ST	3RD	2ND	1ST	3RD	2ND	1ST
3'-6"	-	(1)2x	(1)2x		(2)2x4	(2)2x4	-	(2)2x4	(2)2x4
5'-0"	-	(2)2x	(2)2x	-	(2)2x4	(3)2x4	-	(2)2x4	(3)2x4
7"-0"	-	(2)2x	(2)2x	-	(2)2x4	4x4	-	(3)2x4	4x4
8'-6"	-	(3)2x	(3)2x	-	4x4	4x/6	-	4x4	4x6
	W	TYP	CAL V	VALL F	RAM	NG EI	EVAT	ION	

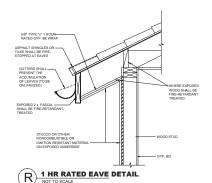

NO OPENINGS OR VENT HOLES TO BE PERMITED.WITHIN 4"0" OF PROPERTY LINE ANY VENTILATION TO BE PROVIDED WITH EYEBROW OR RIDGE VENTING

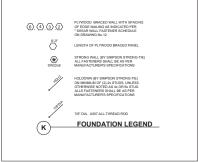

PROPOSED NEW SINGLE
FAMILY RESIDENCE
AND REAR DETACHED ADU
SANTA CLARA, CA 95050
PHONE: (186) 756-1311

REVISIONS

DATE: 05/22/2020

SCALE: 1/4" = 1'-0" DRAWN: BRA

T SHEETS

PROPOSED FOUNDATION PLAN ( FOR REFERENCE SOLE: 147°-170° ONLY- SEE ALSO STRUCTURAL )

#### ROOF FRAMING NOTES

- THE ALLOWABLE SPAN OF ROOF RAFTERS SHALL BE MEASURED ALONG THE RAFTER FROM PLATE TO RIDGE EXCEPT THAT WHERE RAFTERS ARE BRACED WITH PUBLISM SAID STRUTS TO BEARING PARTITIONS, THE SPAN SHALL BE CONSIDERED BETWEEN PURLINS.
- THE MAXIMUM SPAN FOR 2 x 4 PURINS IS FOUR FEET. THE MAXIMUM SPAN FOR 2 x 6 PURINS IS 9X FEET. THE MINIMUM SIZE FOR PURINS 9 SUPPORTS (DOCESS) IS 2 x 4 SHALL BE INSTALLE DESTRUCTION OF ANY SHALLED AT ANGLE UP TO 45% MEASURED FROM VERTICAL. ALL PURINS INSTALLED AT ANGLE UP TO 45% MEASURED FROM VERTICAL. ALL PURINS DIPPORTS (DOCESS) SHALL BE CONNECTED TO THE OF PLATE OF A BEARING WALL. IN NO CASE SHALL A PURIN BE LESS IN SIZE THAN THE RAFTERS IT SUPPORTS.
- ALL VALLEY AND HIP RAFTERS SHALL BE NOT LESS THAN 2 INCHES THICK AND NOT LESS IN DEPTH THAN THE END CUT OF THE RAFTER.
- APPROVAL OF ENGINEERING DESIGN, DETAILS AND CALCULATIONS. TRUSSES SHALL NOT BE CUT WITHOUT REVIEW AND APPROVAL FROM THE BUILDING SAFETY DIVISION.

# ATTIC VENTILATION NOTE

SF.X 144 S.L= (144 SQUARE INCHES = 1 S.F.)= "

(AREA OF VENT) =\_\_\_


TOTAL ATTIC VENTS
REQUIRED:
NEW VENTS MIN. (§ 12" x 1 x 14" WWM 10/10 MESH EACH.

NOTE:
INDIRES 50% OF TOTAL VENTILATION AT
EMPIRE 80% OF TOTAL VENTILATION AN
EMPIRE ROOF PORTION: VENTILATION CAN BE
ACCOMMUNICATION OF VENTILATION CAN BE
FOR STATE 25 EVERNOW VENTS AND 35 EVE VENTS
IF SQ. CONTRACTOR TO ROAGNAT BARRIES AT
BACK OF GABLE VENTS AND APPROVED WWM.
BUS SCREEN

# ATTIC VENTILATION NOTE


S.F.X 144 S.L.= (144 SQUARE INCHES = 1 S.F.)= " " (AREA OF VENT) =\_\_\_


NOTE: ENGINE SON OFTOTAL VENTLATION AT 
UPPER ROOF PORTION: VENTILATION ON BE 
ACCOMPLISHED BY USE OF 1 LICENSERED GABS 
VENTS: 2) EVERROW VENTS AND 3) EVE VENT 
IFSO, CONTRACTOR TO REAGANT BARRENT 
BACK OF GABLE VENTS AND APPROVED WWM 
BUS SCIENTS.

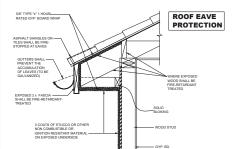

1 HR RATED EAVE DETAIL

NOT TO SCALE NO OPENINGS OR VENT HOLES TO NO OPENINGS OR VENT HOLES TO BE PERMITED.WITHIN 4'0" OF PROPERTY LINE ANY VENTILATION TO BE PROVIDED WITH EYEROW OR RIDGE VENTING

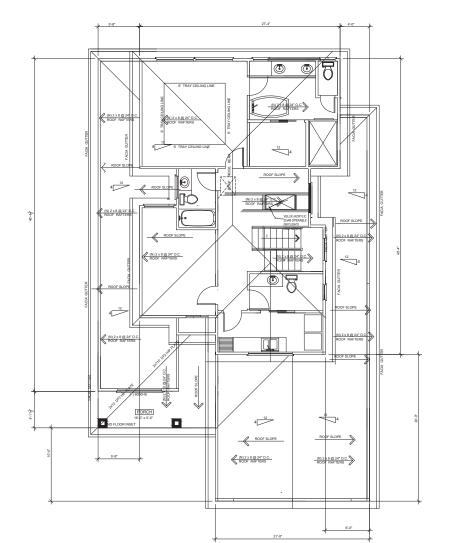

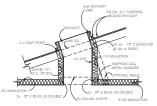

SECTION @ SKYLIGHT SKYLIGHT TO BE INSTALLED IN BETWEEN (E) FRAMING MEMBERS AND NO (E) FRAMING TO BE ALTERED

OWNER DALJIT KAUR 1922 MAIN STREET SANTA CLARA, CA 95050 PHONE: (196) 756-1311

REVISIONS


PROPOSED NEW SINGLE FAMILY RESIDENCE


SCALE: 1/4" = 1'-0"


DRAWN: BRA


8


PROPOSED ROOF PLAN (FOR REFERENCE SCALE: 1/4" = 1'-0" ONLY..SEE ALSO STRUCTURAL)

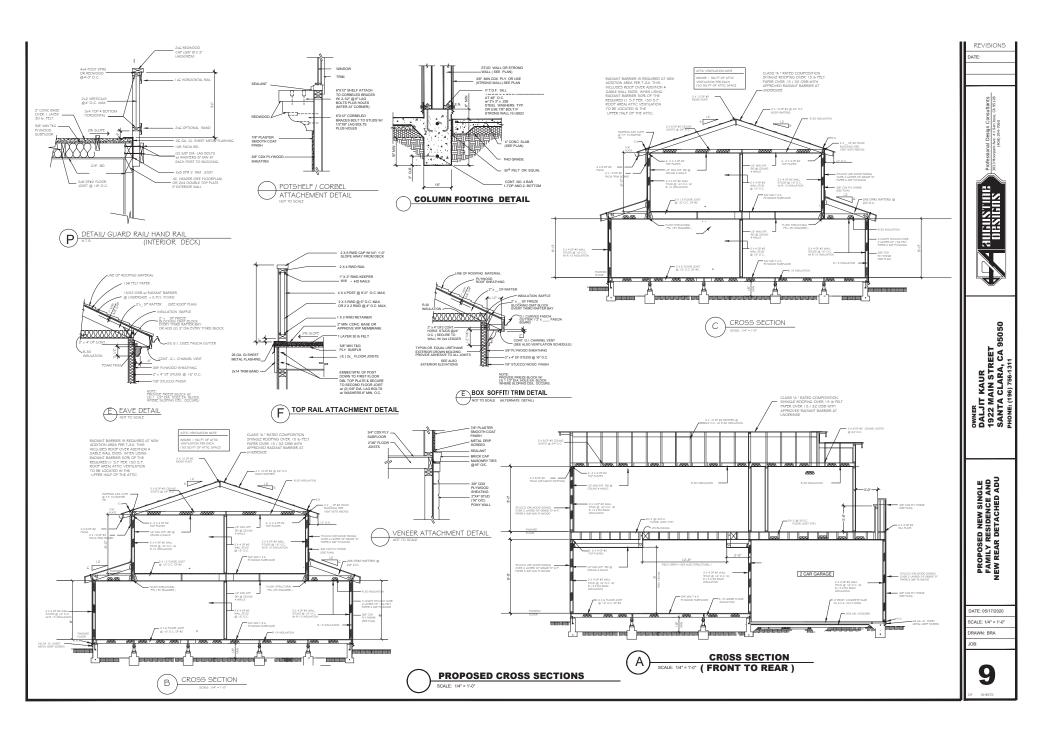

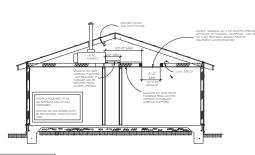

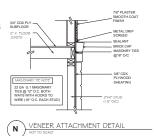

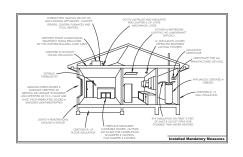

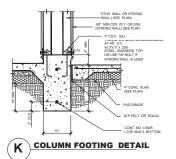


ATTIC FURNACE NOTE

PROVIDE AN ADDITIONAL WATER TIGHT PAN OF CORROSION-RESISTANT MATERIAL WITH A SEPARATE DRAIN LINE UNDERNIES. THE ATTIC MOUNTED FURNACE TO CATCHHE OVERFLOW CONDENSATE DUE TO

ATTIC FURNACE DETAIL F

TYPICAL FOR BOTH WOOD AND SLAB FOUNDATIONS

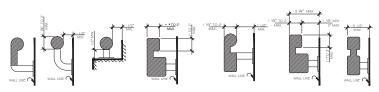



# STAIRWAYS

WID: THE MINIMUM STARWAY WIDTH SHALL NOT BE LESS THAN 44 INCHES (11) 5 MM. STARWHS SERVING AN OCCUPANT LOAD OF 49 DE LESS SHALL NOT THE REQUEST WORTH A DESIRED OF 15 MM. STARWHS SERVING AND STARWHS STARWHS

- NICH MINIALM. RIM.

  WHERE THE BOTTOM OR TOP RISES ADJOINS A SLOTING PARILLY WAY.

  A MAKING THE BOTTOM OR TOP RISES WAY WE REDUCED ADDOR THE

  ADAPTION OF THE BOTTOM OR TOP RISES WAY WE REDUCED ADDOR THE

  SLOTE TO LOSE THAN A RICES FOR SAME PRODUCED ADDOR THE

  SLOTE TO LOSE THAN A RICES FOR SAME PRODUCED ADDOR THE

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  THE SLOTE THE STANDARD WINNER THE TRADO ARE MINKPORKE, BUT IN NO

  THE SLOCE OF THE STANDARD WINNER THE TRADO ARE MINKPORKE, BUT IN NO

  PROSPECTION OF THE STANDARD WINNER THE TRADO ARE MINKPORKE, BUT IN NO

  THE SLOCE OF THE STANDARD WINNER THE TRADO ARE MINKPORKE, BUT IN NO

  STANDARD THE SLOTE THE STANDARD WINNER THE TRADO ARE MINKPORKE, BUT IN NO


  THE SLOCE OF THE STANDARD WINNER THE TRADO ARE MINKPORKE, BUT IN NO

  STANDARD THE SLOTE THE SLOTE ADDRESS THE SLOTE ADDRE

- SQUARE FEET (37.16 SQ. METERS)

STARWAYS: WHEN A BASDWENT STARWAY AND A STARWAY TO AN UPPER STORY TERMINATE IN THE SAME DUT ENCLOSURE. AN APPROVED BARRIER SHALL BE PROVIDED TO PREVENT PERSONS FROM CONTINUING ON INTO THE


- ......STARKWAYS HAVING LESS THAN FOUR RISERS AND SERVING ONE NOVIDUAL DIKELING UNIT IN GROUP R. DIVISION I OR 3, OR A GROUP R. DIVISION 3 CONGRECATE RESIDENCE OR SERVING GROUP U. OCCUPANCIES NEED NOT HAVE HANDRALES.

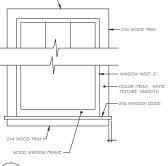

2XG WOOD TRIM =






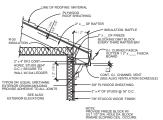

BOX SOFFIT/ TRIM DETAIL

STANDARD STAIR SECTION
SCALE 380'=11:0' (Page Section )

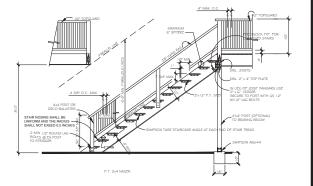

B STANDARD STAIR SECTION

Professional Design Consultants 3033 Moopark Ave. #1 San Jose, CA 95128 (408) 294-7060

OBSIGNS N

95050 DALJIT KAUR 1922 MAIN STREET SANTA CLARA, CA 9! PHONE: (196) 756-1311

PROPOSED NEW SINGLE FAMILY RESIDENCE AND REAR DETACHED ADU

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