

# **Meeting Agenda**

# **Bicycle & Pedestrian Advisory Committee**

Monday, October 27, 2025

4:00 PM

Hybrid Meeting City Hall Council Chambers 1500 Warburton Avenue Santa Clara, CA 95051

The City of Santa Clara is conducting the Bicycle and Pedestrian Committee meetings in a hybrid manner (in-person and continues to have methods for the public to participate remotely).

Via Zoom:

https://santaclaraca.zoom.us/j/83368467068

Meeting ID: 833 6846 7068 or Phone: 1 (669) 900-6833

### 1 CALL TO ORDER AND ROLL CALL

### 2 PUBLIC PRESENTATIONS

[This item is reserved for persons to address the body on any matter not on the agenda that is within the subject matter jurisdiction of the body. The law does not permit action on, or extended discussion of, any item not on the agenda except under special circumstances. The governing body, or staff, may briefly respond to statements made or questions posed, and appropriate body may request staff to report back at a subsequent meeting.]

### 3 CONSENT CALENDAR

A. 25-1074 Bicycle and Pedestrian Advisory Committee Meeting Minutes of August 25, 2025 (Chair)

**Recommendation:** Approve the Bicycle and Pedestrian Advisory Committee Meeting Minutes of August 25, 2025.

### 4 REPORTS FOR COMMITTEE INFORMATION

A. 25-1075 Police Verbal Update (Police Staff)

### 5 ACTION ITEMS / GENERAL BUSINESS

A. 25-1084 Action to Recommend City Council Adoption of the Santa Clara

Vision Zero Action Plan (He)

**Recommendation:** Recommend to City Council to adopt the Santa Clara Vision Zero Action Plan.

B. 25-1518 <u>Dissolution of Current Subcommittees and Creation of New Subcommittees (Chan/Haro)</u>

**Recommendation:** Dissolve current BPAC subcommittees and create new subcommittees as requested by the BPAC

### 6 REPORTS FOR COMMITTEE INFORMATION (CONTINUED)

- A. 25-1077 Public Works Verbal Update (Liw/Chan)
- B. 25-1085 Complete Streets Review for the 2026 Annual Street

  Maintenance and Rehabilitation Project (Chan)
- C. 25-1083 Revise Traffic Calming Policy from 1999; Review, Revise, and Update City's Neighborhood Traffic Calming Program (Chan)
- D. 25-1080 San Tomas Aquino Creek Trail Closures, Detours, and Public Noticing for Upcoming Major Events (Chan)
- E. 25-1082 Report on Funding Opportunities (Garcia)
- F. 25-1071 Bicycle Plan Status of Projects and Programs (Shariat)
- G. 25-1073 Pedestrian Master Plan Status of Projects, Objectives, and Policies (Shariat)
- H. 25-1122 Grant Activity Verbal Update (Shariat)
- I. 25-1078 <u>Valley Transportation Authority Bicycle and Pedestrian Advisory</u>

  <u>Committee Meetings Update (Megas)</u>
- J. 25-1079 Santa Clara Station Area Task Force Update (Shure)

### 7 ANNOUNCEMENTS

### **8 ADJOURNMENT**

The next meeting will be on Monday, January 26, 2026.

### MEETING DISCLOSURES

The time limit within which to commence any lawsuit or legal challenge to any quasi-adjudicative decision made by the City is governed by Section 1094.6 of the Code of Civil Procedure, unless a shorter limitation period is specified by any other provision. Under Section 1094.6, any lawsuit or legal challenge to any quasi-adjudicative decision made by the City must be filed no later than the 90th day following the date on which such decision becomes final. Any lawsuit or legal challenge, which is not filed within that 90-day period, will be barred. If a person wishes to challenge the nature of the above section in court, they may be limited to raising only those issues they or someone else raised at the meeting described in this notice, or in written correspondence delivered to the City of Santa Clara, at or prior to the meeting. In addition, judicial challenge may be limited or barred where the interested party has not sought and exhausted all available administrative remedies.

If a member of the public submits a speaker card for any agenda items, their name will appear in the Minutes. If no speaker card is submitted, the Minutes will reflect "Public Speaker."

In accordance with the requirements of Title II of the Americans with Disabilities Act of 1990 ("ADA"), the City of Santa Clara will not discriminate against qualified individuals with disabilities on the basis of disability in its services, programs, or activities, and will ensure that all existing facilities will be made accessible to the maximum extent feasible. The City of Santa Clara will generally, upon request, provide appropriate aids and services leading to effective communication for qualified persons with disabilities including those with speech, hearing, or vision impairments so they can participate equally in the City's programs, services, and activities. The City of Santa Clara will make all reasonable modifications to policies and programs to ensure that people with disabilities have an equal opportunity to enjoy all of its programs, services, and activities.

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Individuals who require an auxiliary aid or service for effective communication, or any other disability-related modification of policies or procedures, or other accommodation, in order to participate in a program, service, or activity of the City of Santa Clara, should contact the City's ADA Coordinator at 408-615-3000 as soon as possible but no later than 48 hours before the scheduled event



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# Agenda Report

25-1074 Agenda Date: 10/27/2025

### REPORT TO BICYCLE AND PEDESTRIAN ADVISORY COMMITTEE

### **SUBJECT**

Bicycle and Pedestrian Advisory Committee Meeting Minutes of August 25, 2025 (Chair)

### RECOMMENDATION

Approve the Bicycle and Pedestrian Advisory Committee Meeting Minutes of August 25, 2025.

Written by: Nicole He, Associate Civil Engineer, Public Works

Reviewed by: Carol Shariat, Principal Transportation Planner, Public Works

Reviewed by: Steve Chan, Transportation Manager, Public Works

Approved by: Michael Liw, Assistant Director/City Engineer, Public Works

### **ATTACHMENT**

1. BPAC Meeting Minutes, August 25, 2025



# **Meeting Minutes**

# **Bicycle & Pedestrian Advisory Committee**

08/25/2025 4:00 PM

Hybrid Meeting City Hall Council Chambers 1500 Warburton Avenue Santa Clara, CA 95051

The City of Santa Clara is conducting the Bicycle and Pedestrian Committee meetings in a hybrid manner (in-person and continues to have methods for the public to participate remotely).

Via Zoom:

https://santaclaraca.zoom.us/j/83368467068

Meeting ID: 833 6846 7068 or Phone: 1 (669) 900-6833

### 1 CALL TO ORDER AND ROLL CALL

**Public Works Assistant Director Liw** called the meeting to order at 4:00 PM.

Present 7 - Member Hung Duong, Member Jorge Haro, Member Ken Kratz, Vice Chair Jonathan Marinaro, Chair Betsy Megas, Member Guillermo Jenaro, and Member Vernon Shure

### **2 ACTION ITEMS / GENERAL BUSINESS**

Α. 25-489 Election of a Chair and Vice Chair of the Bicycle and Pedestrian Advisory Committee for FY 2025/26 (Liw)

**Recommendation:** Nominate and elect a Chair and Vice Chair for the Bicycle and Pedestrian Advisory Committee for the FY 2025/26 term.

Video: [00:03:00]

Public Works Assistant Director Liw provided a brief overview of the election process.

Member Kratz nominated himself as the Chair and also recommended Member Megas as either Chair or Vice Chair.

**Member Megas** indicated that she was willing to take either role.

**Member Marinaro** also nominated himself as the Chair.

Member Shure asked the candidates how they would strike the balance of ensuring people being heard versus keeping BPAC meetings move forward.

All three candidates shared why they are interested and how they plan to improve the efficiency of BPAC meetings.

Public Speaker: Diane Harrison

A motion was made by Member Jenaro and seconded by Member Duong to elect Member Megas as the Chair. The motion carried by following votes.

Aye: 7 - Member Duong, Member Haro, Member Kratz, Vice Chair Marinaro, Chair Megas, Member Jenaro, and Member Shure

**Chair Megas** asked if there were any members interested in the Vice Chair position. **Member Marinaro** and **Member Kratz** both self-nominated as the Vice Chair.

**Member Jenaro** asked the candidates how they would support Chair Megas. Both candidates discussed their strategies to support **Chair Megas**. **Chair Megas** also shared her expectations about the Vice Chair.

A motion was made by Member Marinaro and seconded by Member Shure to elect Member Marinaro as the Vice Chair. The motion carried with the following votes.

**Aye:** 6 - Member Duong, Member Haro, Vice Chair Marinaro, Chair Megas, Member Jenaro, and Member Shure

Nay: 1 - Member Kratz

### **3 PUBLIC PRESENTATIONS**

Video: [0:44:30]

Edmund Drozek requested the City to conduct pavement maintenance on San Tomas Aquino Creek Trail between the stadium and the Bay Trail as the trail is rough and has patches and bumps. He also stated that he travels along Caribbean Drive within Sunnyvale north of the Bay Trail and there is a crossing for bikes and pedestrians, but the markings for the bike lane are washed out and sometimes not even present on both sides of the roadway. Thus, would like Santa Clara BPAC to contact Sunnyvale BPAC to make them aware of this situation and make it a priority to have them fix the bike lane markings.

**Public Works Assistant Director Liw** addressed **Edmund Drozek** question.

**Diane Harrison** indicated that she crossed Warburton Avenue at a location where there were no marked crosswalks and a driver almost did not stop. She commented that every intersection should have all four legal crosswalk markings and asked the City to paint crosswalks at the intersections when the roadways get repaved.

### **4 CONSENT CALENDAR**

A. <u>25-795</u> Bicycle and Pedestrian Advisory Committee Meeting Minutes of June 23,

2025 (Chair)

**Recommendation:** Approve the Bicycle and Pedestrian Advisory Committee Meeting Minutes

of June 23, 2025.

Video: [00:56:50]

**Member Kratz** asked why the meeting minutes do not have all of the specific discussion comments.

**Principal Transportation Planner Shariat** addressed **Member Kratz** question.

A motion was made by Member Marinaro and seconded by Member Jenaro to Approve the Staff Recommendation. The motion carried by the following votes.

Aye: 6 - Member Duong, Member Haro, Vice Chair Marinaro, Chair Megas,

Member Jenaro, and Member Shure

Abstained: 1 - Member Kratz

B. <u>25-796</u> Bicycle and Pedestrian Advisory Committee Calendar of Meetings for

2026 (Chair)

**Recommendation:** Recommend that Council Approve the Bicycle and Pedestrian Advisory

Committee Calendar of Meetings for 2026.

Video: [00:58:00]

**Member Kratz** commented that other cities have more BPAC meetings in a year and suggested adding one more meeting in July and overall have at least six meetings a year. He also suggested establishing a subcommittee to look at improving BPAC efficiency and make BPAC meetings shorter.

**Member Shure** commented that he would support more BPAC meetings a year if the meetings are shorter.

**Member Marinaro** suggested approving the staff recommendation with consideration of asking the City Council for approval of adding more meetings in the future.

**Member Haro** suggested staff looking into the option of organizing BPAC meetings every two months for 2027.

Public Speaker: Diane Harrison

A motion was made by Member Marinaro and seconded by Member Duong to Approve Staff Recommendation with an amendment to explore bimonthly BPAC meeting format for 2027 BPAC Calendar of Meetings.

**Aye:** 6 - Member Duong, Member Haro, Vice Chair Marinaro, Chair Megas, Member Jenaro, and Member Shure

Nay: 1 - Member Kratz

### **5 REPORTS FOR COMMITTEE INFORMATION**

A. 25-797 Police Verbal Update (Wilson)

This agenda item was not discussed at the meeting due to Officer Wilson not being present.

### **6 REPORTS OF SPECIAL COMMITTEES**

A. 25-798 Subcommittee on Police Collision History (Donoghue, Kratz, Granvold)

Video: [01:22:00]

**Member Kratz** provided a brief update that the Subcommittee work is currently on hold until Vision Zero Plan is completed.

### 7 REPORTS FOR COMMITTEE INFORMATION (CONTINUED)

A. 25-812 Review of Existing Work Plan Topics for Fiscal Year 2025-26 BPAC Work

Plan (Garcia)

Video: [01:24:00]

**Senior Civil Engineer Garcia** presented information on the existing work plan development process and outlined staff's proposed changes to improve the process.

Committee comments followed.

Public Speaker: Diane Harrison

B. <u>25-804</u> Public Works Verbal Update (Liw/Chan)

Video: [01:48:00]

**Transportation Manager Chan** and **Public Works Assistant Director Liw** provided an update on recent activities at the Public Works
Department.

Committee comments and questions followed.

Transportation Manager Chan addressed Committee questions.

Public Speakers: Edmund Drozek, Diane Harrison

E.

C. <u>25-801</u> Wayfinding & Install Way-finding Signs (Garcia)

Video: [2:10:00]

**Senior Civil Engineer Garcia** presented information on wayfinding and installation of wayfinding signs.

Committee comments followed.

**Member Marinaro** suggested establishing a Wayfinding Subcommittee to look at wayfinding and roadway markings.

Public Speakers: Edmund Drozek, Diane Harrison

D. <u>25-802</u> Proposal for a Data-Driven Framework to Evaluate Bicycle & Pedestrian
 Projects in Santa Clara (Chan)

Video: [03:10:30]

**Transportation Manager Chan** presented information on a data-driven framework to evaluate bicycle and pedestrian projects in Santa Clara.

**Committee** comments followed. BPAC would like to establish a subcommittee related to this agenda item. **Members Marinaro**, **Jenaro** and **Kratz**, along with **Diane Harrison**, a member of the public are interested on being on this subcommittee.

Public Speaker: Diane Harrison

Valley Transportation Authority Bicycle and Pedestrian AdvisoryCommittee Meetings Update (Megas)

Video: [03:57:00]

**Chair Megas** provided an update on recent VTA Bicycle and Pedestrian Advisory Committee meetings.

**Committee** comments and questions followed.

Chair Megas addressed Committee questions.

**F.** <u>25-807</u> Santa Clara Station Area Task Force Update (Shure)

Video: [05:02:30]

**Member Shure** provided an update on recent Santa Clara Area Task Force meetings.

Committee comments and questions followed.

Member Shure addressed Committee questions.

Public Speaker: Diane Harrison

G. 25-808 Grant Activity Verbal Update (Shariat)

Video: [05:40:20]

**Principal Transportation Planner Shariat** provided an update on recent grant activities.

Committee comments and questions followed.

**Principal Transportation Planner Shariat** addressed **Committee** questions.

Public Speaker: Diane Harrison

### **8 REPORTS OF SPECIAL COMMITTEES (CONTINUED)**

A. 25-809 Subcommittee on Bicycle Story Maps (Megas)

Video: [05:46:00]

Chair Megas suggested combining this subcommittee with wayfinding.

**B.** 25-810 Subcommittee on Bike to Shop Day (Megas, Kratz, and Harrison)

Video: [05:51:00]

**Diane Harrison** commented that this agenda item can be removed from August and October BPAC meetings.

### **C.** <u>25-811</u> Subcommittee on Roundabouts (Megas, Kratz, and Harrison)

Video: [05:52:00]

**Member Kratz** provided an update on the subcommittee. **Member Marinaro** asked staff if members of the public can on a subcommittee do to the Brown Act. **Public Works Assistant Director Liw** responded that he will ask City Attorney Office and get back to them.

Public Speaker: Diane Harrison

### **ANNOUNCEMENTS**

Committee made several announcements about upcoming events:

- 1. Ribbon cutting of Gateway Crossing Community Park on August 27
- 2. Viva Calle San Jose event on September 7
- 3. Call for volunteers of Silicon Valley Bicycle Coalition bike valet parking program at Levis Stadium
- 4. Stevens Creek Boulevard Vision Study will go before the Cupertino City Council on September 3
- 5. Santa Clara Art & Wine event on September 13 and 14
- 6. Santa Clara Parade of Champions event on October 4

### 9 ADJOURNMENT

The meeting was adjourned at 8:59 PM.

The next scheduled meeting will be on Monday, October 27, 2025 at 4:00

### **MEETING DISCLOSURES**

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# Agenda Report

25-1075 Agenda Date: 10/27/2025

### REPORT TO BICYCLE AND PEDESTRIAN ADVISORY COMMITTEE

### **SUBJECT**

Police Verbal Update (Police Staff)

### **DISCUSSION**

Police Department staff will provide a verbal update on bicycle and pedestrian related items.

Written by: Ralph Garcia, Senior Civil Engineer, Public Works

Reviewed by: Carol Shariat, Principal Transportation Planner, Public Works

Reviewed by: Steve Chan, Transportation Manager, Public Works

Approved by: Michael Liw, Assistant Director/City Engineer, Public Works



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### Agenda Report

25-1084 Agenda Date: 10/27/2025

### REPORT TO BICYCLE AND PEDESTRIAN ADVISORY COMMITTEE

### **SUBJECT**

Action to Recommend City Council Adoption of the Santa Clara Vision Zero Action Plan (He)

### BACKGROUND

Vision Zero is a strategy aimed at helping to eliminate all traffic fatalities and severe injuries, while also promoting safe and healthy mobility for everyone. The objective of developing and implementing a Vision Zero Action Plan is listed in both the City's Bicycle Plan and Pedestrian Master Plan. In December 2023, the City Council received Safe Streets and Roads for All (SS4A) grant funding from the Federal Highway Administration to establish a Santa Clara Vision Zero Action Plan. The City Council approved an agreement with Kimley-Horn and Associates, Inc. for professional services for the Santa Clara Vision Zero Action Plan on May 28, 2024.

The Santa Clara Vision Zero Action Plan (Plan) kicked off in July 2024. This effort involved extensive community engagement and a thorough citywide safety analysis to identify the most frequent types, locations, severity, and demographics of collisions in the city. The Plan included development of a safety countermeasure toolbox, which includes programmatic measures and roadway improvements to address traffic safety issues. Additionally, the Plan identifies a priority list of potential traffic safety improvements and implementable actions to guide the City's efforts in achieving Vision Zero.

The project has been presented to the Bicycle and Pedestrian Advisory Committee (BPAC) at four previous meetings:

- In August 2024, staff provided a project overview and the BPAC selected Member Kratz as the BPAC representative to serve on the Vision Zero Working Group, which guides the development of the Vision Zero Plan.
- In January 2025, staff provided a summary of collision analysis findings and the draft High-Injury Network (HIN). The HIN reflects the locations where the highest number of traffic fatalities and severe injuries occurred, and staff can use this HIN as a tool to prioritize future roadway improvement projects and update the City's policies and guidelines.
- In March 2025, staff provided an update on collision profiles, draft countermeasure toolbox, and outlined preliminary Vision Zero actions and strategies.
- In June 2025, staff provided a list of priority HIN corridors, summary of proposed improvements along the priority HIN corridors, BPAC-focused actions and strategies, and presented the outline of the Draft Vision Zero Action Plan.

At the October 2025 BPAC meeting, the project team will present the overview of the project background and present the draft Vision Zero Action Plan.

25-1084 Agenda Date: 10/27/2025

### DISCUSSION

Adopting a Vision Zero goal and approving the Plan will represent the City's commitment to end traffic fatalities and severe injuries in Santa Clara, and allow the City to pursue future federal, state, and local grant opportunities for traffic safety infrastructure improvements. This Plan represents a multidisciplinary and collaborative effort in developing and implementing comprehensive solutions to address factors contributing to traffic-related collisions. The Plan development included extensive stakeholder and community engagement, and comprehensive collision data analysis, in identifying key safety concerns and strategies for implementation through near-, mid-, and long-term projects.

### The full draft Plan

<a href="https://www.santaclaraca.gov/home/showpublisheddocument/88163/638947559642800000">https://www.santaclaraca.gov/home/showpublisheddocument/88163/638947559642800000> is available on the project webpage (<a href="http://SantaClaraCA.gov/VisionZero">http://SantaClaraCA.gov/VisionZero</a>) for public comment until October 19, 2025. Attachment 1 presents the draft Plan's executive summary.

As required by the federal grant, the Plan includes the following key elements:

- 1. Leadership Commitment and Goal Setting
- 2. Strategic Planning
- 3. Collaboration and Community Engagement
- 4. Safety Analysis, Collision Profiles and Countermeasure Toolbox
- 5. High Injury Network (HIN)
- 6. Priority Projects, Policy and Programs
- 7. Progress and Transparency

Each key element is discussed below.

### Leadership Commitment and Goal Setting

The Plan establishes a goal to eliminate all traffic fatalities and severe injuries on city roadways by the year 2050, and identified the following guiding principles of Vision Zero implementation:

- Safety of Human Life is Our Highest Priority
- Traffic-related Fatalities and Severe Injuries are Preventable and Unacceptable
- Vision Zero is a Shared Responsibility
- Community Engagement is Essential

Upon City Council adoption, the Plan will include the final resolution of Vision Zero policy and a cover letter from City leaders stating its official commitment.

### Strategic Planning

During the project, the City formed a Vision Zero Working group consisting of City staff from the Public Works, Community Development, Fire and Police Departments, one BPAC representative, and external stakeholders including Santa Clara County, VTA, Cities of San Jose and Sunnyvale, Silicon Valley Bicycle Coalition, school district, Santa Clara University, and Mission College.

The Plan recommends continuing this Working Group collaboration to guide and advise Vision Zero program implementation and progress monitoring.

### Collaboration and Community Engagement

The Plan's development was informed by four phases of robust community engagement, including

four community workshops with traffic safety item giveaways, three community surveys (with over 1,300 responses), pop-up events, a project webpage, project hotline and email, installation of Vision Zero street signs, and bus shelter advertisement. The community also provided location-specific feedback on an interactive map, which was taken into consideration into the citywide safety analysis.

Community input identified top safety concerns such as speeding and distracted driving; unsafe intersections and poor visibility; lack of protected bike infrastructure; non-compliance of traffic laws; safety in school zones; and need for more traffic safety education, enforcement, and traffic calming measures.

### Safety Analysis, Collision Profiles and Countermeasure Toolbox

The Plan includes a thorough review of collision data from 2016 to 2023 (8 years), with the following key findings:

- 51 fatal collisions and 139 severe injuries, with an average of over 6 fatalities and 17 severe injuries annually.
- 35 percent of killed or severely injured (KSI) collisions involved pedestrians or cyclists.
- Vulnerable users, including youth, seniors, and those walking or biking, are disproportionately
  affected.

The Plan identifies the top nine collision profiles with recurring patterns that provide insights about why fatalities and serious injuries occurred in the city:

- Bicycle and Pedestrian collisions
- Driving Under the Influence of Alcohol or Drugs
- Speeding Drivers
- Night-time Collisions
- Off-Street Collisions (Pedestrian-involved collisions on the sidewalk or shoulder)
- Vehicles Running a Red Light or Stop Sign
- Turning Vehicle Conflicts at Intersections
- Collisions Involving Persons Under the Age of 18 or Over 60 Years of Age
- Pedestrian Code Violations such as Improper Crossing or Not Yielding Right-of-Way

The Plan also includes a Countermeasure Toolbox with proven engineering and programmatic strategies across the following six categories:

- Roadway Segment Improvements
- Intersection Design Improvements
- Traffic Signal Improvements
- Signs & Markings
- Speed Management
- Bicycle & Pedestrian Improvements

### High Injury Network (HIN)

As part of Santa Clara's commitment to Vision Zero, the Plan identifies a High Injury Network (HIN) to guide safety improvements where they are needed most. The HIN consists of intersections and roadways throughout Santa Clara which experienced a disproportionate number of injury collisions and fatalities. By focusing on these high-risk corridors, Santa Clara can make the biggest impact in reducing severe injuries and fatalities. Figure 1 in Attachment 1 presents the City's HIN.

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The HIN analysis revealed two key findings:

 Approximately 60% of all collisions in the study period (2016 - 2023) occurred on 16% of the roadways within City limits, including County expressways and El Camino Real.

• Many of the streets in the HIN are arterials, or streets that carry higher volumes of vehicles at higher speeds, including Caltrans and County-owned streets.

### Priority Projects, Policy and Programs

The Plan identifies the top ten priority project locations along the High Injury Network (HIN) based on a combination of factors, including high concentrations of collisions, the severity of injuries, and community feedback on safety concerns. These locations represent areas with the greatest need for intervention and are the focus of targeted safety improvements outlined in the Plan:

- Monroe Street: Lawrence Expressway to Bowers Avenue and San Tomas Aquino Creek Trail to Scott Boulevard
- 2. Lafayette Street: Central Expressway to Poplar Street
- 3. Coleman Avenue Tri-level Interchange: De La Cruz Boulevard from Central Expressway to Lafayette Street, and Coleman Avenue from Reed Street to the City of San Jose limit line
- 4. Scott Boulevard: Monroe Street to El Camino Real
- 5. Homestead Road: Lawrence Expressway to Kiely Boulevard
- 6. Stevens Creek Boulevard: Lawrence Expressway to Kiely Boulevard
- 7. El Camino Real: Halford Avenue to Scott Boulevard
- 8. Pruneridge Avenue: Lawrence Expressway to Kiely Boulevard
- 9. Scott Boulevard: Bowers Avenue to San Tomas Expressway
- 10. Montague Expressway: Lick Mill Boulevard to US-101

In addition to proposed infrastructure improvements, non-engineering actions and strategies are critical to the success of a comprehensive Vision Zero program. The Plan includes a list of policy and program recommendations to streamline and improve the process of implementing traffic safety improvements, enforcement, and educational outreach. Each recommended action includes a proposed timeline and performance measure for progress tracking.

Some key policy and process updates include:

- Update existing Neighborhood Traffic Calming Program
- Develop and implement a multi-department post KSI-collision review process to discuss safety improvements
- Prioritize projects and focus enforcement and education efforts on the High Injury Network
- Incorporate Vision Zero principles into City communications, staff training, data collection, and design review.

### Progress and Transparency

The City is committed to ensuring progress, transparency, and accountability in the Vision Zero program implementation. Upon City Council adoption of this Plan, the City can pursue local, state and federal grants for infrastructure project implementation. The City will also produce annual reports on the program progress. Every five years or as necessary to meet grant requirements, the City will update the Vision Zero Plan to reevaluate the collision data and performance measures.

25-1084 Agenda Date: 10/27/2025

### **RECOMMENDATION**

Recommend to City Council to adopt the Santa Clara Vision Zero Action Plan.

Written by: Nicole He, Associate Civil Engineer, Public Works

Reviewed by: Carol Shariat, Principal Transportation Planner, Public Works

Reviewed by: Steve Chan, Transportation Manager, Public Works

Approved by: Michael Liw, Assistant Director/City Engineer, Public Works

### ATTACHMENT

1. Draft Santa Clara Vision Zero Action Plan - Executive Summary



# City of Santa Clara Vision Zero Action Plan

September 2025 (DRAFT)



# Message from City Leaders

 $A\ letter\ from\ City\ leaders\ will\ be\ included\ after\ City\ Council\ adoption.$ 

# **Acknowledgements**

The City of Santa Clara would like to dedicate this Vision Zero Action Plan to the members of our community who experienced life-changing traffic incidents and all advocates dedicated to improving roadway safety in Santa Clara. We extend our sincere gratitude to all those who contributed to the development of this Plan. Special thanks go to the Vision Zero Working Group for their leadership and dedication. We also acknowledge the valuable input from community members and partner agencies that reflects our shared commitment to safer streets for all. Your contributions have been vital in moving us closer to a future with zero traffic-related fatalities and severe injuries.

### **Elected Officials**

Lisa M. Gillmor, Mayor Albert Gonzalez, Councilmember District 1 Raj Chahal, Councilmember District 2 Karen Hardy, Councilmember District 3 Kevin Park, Councilmember District 4 Sudhanshu "Suds" Jain, Councilmember District 5 Kelly G. Cox, Vice Mayor District 6

### City of Santa Clara Public Works Staff

Nicole He, Project Manager Ralph Garcia, Senior Civil Engineer Steve Chan, Transportation Manager Carol Shariat, Principal Transportation Planner Michael Liw, Assistant Director/City Engineer Craig Mobeck, Director

### **Consultant Team**

Mike Colety, Kimley-Horn
Robert Paderna, Kimley-Horn
Tatiana Lundstrom, Kimley-Horn
Brandi Childress, Kimley-Horn
Zander Dally, Kimley-Horn
Abbey Ibarra, Kimley-Horn
Kristen Mei, Kimley-Horn
Zachary Ramalingam, Kimley-Horn
Julian Kaiser, Kimley-Horn
Ivy Morrison, Circlepoint
Regina Merrill, Circlepoint
Simon Stahl, Circlepoint

### City of Santa Clara Commissions/ Committees

Bicycle and Pedestrian Advisory Committee Senior Advisory Commission Parks & Recreation Commission Youth Commission

### **Vision Zero Working Group**

Jake Tomlin, Fire Department

Lillian Tsang, City of Sunnyvale

Scott Wilson, Police Department John Davidson, Community Development Department Ben Aghegnehu, County of Santa Clara Roads and Airports Alisa Campbell, County of Santa Clara Public Health Lauren Ledbetter, VTA Eugene Maeda, VTA Michal Healy, Santa Clara Unified School District Steve Ross, Santa Clara University Connor Keese, Mission College Danny Nguyen, Mission College Gabriela Landaveri, SVBC Ken Kratz, Santa Clara Bicycle and Pedestrian Advisory Commission (BPAC) Thao Nguyen, City of San Jose

This project is funded by federal Safe Streets & Roads for All (SS4A) grant and state Office of Traffic Safety (OTS) grant.

# **Executive Summary**

Santa Clara's Vision Zero Plan is a strategic commitment to eliminate all traffic fatalities and severe injuries on city roadways by the year 2050.

The City of Santa Clara's Vision Zero Action Plan is an ambitious strategy aimed at eliminating all traffic fatalities and severe injuries, while promoting safe and sustainable mobility for all road users. This multidisciplinary and collaborative effort unites stakeholders from various sectors to develop and implement comprehensive solutions addressing the complex factors contributing to traffic-related collisions.

# **Key Objectives and Findings**

### 1. Current State and Need for Action:

- a. Traffic fatalities and severe injuries in Santa Clara are significant, with 51 reported fatal collisions and 139 severe injuries between 2016 and 2023.
- b. The city's growth has led to increased traffic volumes and congestion, further amplifying the risk of collisions.
- c. High economic costs of traffic collisions highlight the financial imperative for safety measures.

### 2. Guiding Principles:

- a. Safety of human life is the highest priority.
- b. Recognition that traffic-related fatalities and severe injuries are preventable.
- c. Vision Zero is a shared responsibility involving coordinated efforts across the community.
- d. Community engagement is essential in soliciting input and partnering with the community to ensure solutions are inclusive and effective, and to guide development of our Vision Zero strategies.

# 3. Safety Strategies and Implementation Framework:

- a. The Safe System Approach minimizes fatalities and severe injuries by identifying risk factors and implementing preventive measures.
- b. Developing a High Injury Network (HIN) to identify specific corridors and intersections with a high concentration of collisions.
- c. Emphasizing protection for vulnerable road users, such as pedestrians and cyclists, who are involved in 35% of all KSI (Killed or Severely Injured) collisions in Santa Clara.

### 4. Priority Actions:

Through collision data analysis, community input, and stakeholder collaboration, this Plan identifies the following priority actions:


- a. Ten priority project locations along the HIN for targeted safety improvements.
- b. Policy and program updates to streamline traffic safety improvements, enforcement, and education.
- c. Funding strategies and pursuit of local, state, and federal grants to support Vision
   Zero implementation.
- d. Deploy proven collision intervention strategies using a curated set of community supported, proven safety countermeasures to guide the implementation of engineering solutions across the HIN corridors and other locations throughout the City's road network.

# **Progress and Accountability**

Santa Clara remains committed to transparent progress reporting and accountability. An annual report on the program's progress will be published,

and in five years, or as necessary to meet grant requirements, the Vision Zero Plan will be updated to reevaluate collision data and performance measures. Continued community engagement and feedback are crucial in achieving the Vision Zero goals.

Figure 1: Priority High Injury Network Corridors

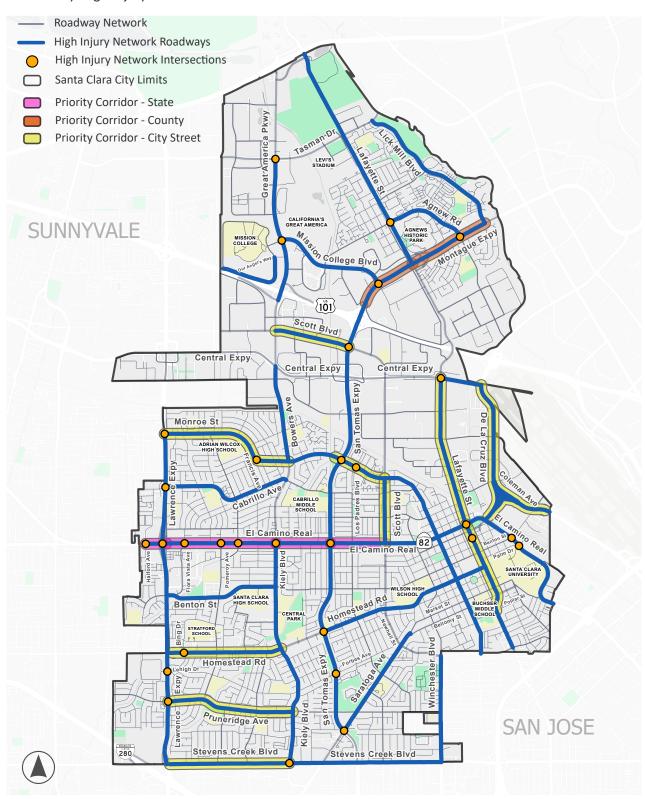



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# Agenda Report

25-1518 Agenda Date: 10/27/2025

### REPORT TO BICYCLE AND PEDESTRIAN ADVISORY COMMITTEE

### **SUBJECT**

Dissolution of Current Subcommittees and Creation of New Subcommittees (Chan/Haro)

### **BACKGROUND**

Based on a recent BPAC discussion regarding subcommittees, Traffic Engineering staff consulted with the City Attorney's Office, and it was determined that to remain in compliance with the Brown Act and in alignment with other City commissions, BPAC subcommittees shall be considered ad-hoc committees.

An ad-hoc committee is a committee that is (1) advisory; and (2) composed solely of members of the legislative body that are less than a quorum. To ensure that the subcommittees supporting BPAC's work qualify as ad-hoc committees, the subcommittees should:

- 1. Be comprised solely of BPAC members;
- 2. Consist of less than a quorum;
- 3. Have a defined purpose and timeframe to accomplish that purpose; and
- 4. Be advisory.

Once the work of the subcommittee is complete, the subcommittee is disbanded. Generally, subcommittees should be disbanded within 6-12 months.

Consequently, BPAC should dissolve existing subcommittees and create new subcommittees.

### DISCUSSION

Currently, BPAC has four subcommittees as listed below:

- Police Collision History
- Bicycle Story Maps
- Bike to Shop Day
- Roundabouts

Additionally, the BPAC recently discussed creating two additional subcommittee: 1) Data-Driven Approach to Evaluating Bicycle and Pedestrian Projects, and 2) Input on Phase I of the Wayfinding project. The intent of the subcommittees is to provide feedback on topics considered needing additional analysis and discussion.

Staff recommends that the BPAC discuss subcommittees, dissolve the four existing subcommittees and create new subcommittees, as needed.

25-1518 Agenda Date: 10/27/2025

### **RECOMMENDATION**

Dissolve current BPAC subcommittees and create new subcommittees as requested by the BPAC

Written by: Ralph Garcia, Senior Civil Engineer, Public Works

Reviewed by: Carol Shariat, Principal Transportation Planner, Public Works

Reviewed by: Steve Chan, Transportation Manager, Public Works

Approved by: Michael Liw, Assistant Director/City Engineer, Public Works



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# Agenda Report

25-1077 Agenda Date: 10/27/2025

### REPORT TO BICYCLE AND PEDESTRIAN ADVISORY COMMITTEE

### **SUBJECT**

Public Works Verbal Update (Liw/Chan)

### **DISCUSSION**

Staff will provide a verbal update on the following items:

- 1. Rules for Subcommittees
- 2. Superbowl 60, February 2026
- 3. FIFA World Cup, June and July 2026
- 4. Traffic staff update
- 5. Work Plan Topic Request Forms due December 12, 2025
- 6. BPAC Workplan

Written by: Steve Chan, Transportation Manager, Public Works Approved by: Michael Liw, Assistant Director/City Engineer, Public Works



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# Agenda Report

25-1085 Agenda Date: 10/27/2025

### REPORT TO BICYCLE AND PEDESTRIAN ADVISORY COMMITTEE

### **SUBJECT**

Complete Streets Review for the 2026 Annual Street Maintenance and Rehabilitation Project (Chan)

### BACKGROUND

The Department of Public Works (DPW) is preparing the design for the 2026 Annual Street Maintenance and Rehabilitation Project (Attachment 1).

This project provides maintenance and rehabilitation treatments to maximize pavement life for various streets in the City. The project applies pavement treatments ranging from slurry seal, asphalt overlay, and full depth replacement. Staff coordinates with the BPAC to review and determine if the project streets have the potential for adding bicycle facilities as identified in the Santa Clara Bicycle Plan. It is important to note that if a street requires removal of parking or travel lanes due to limited right-of-way widths, the recommendations in the Bicycle Plan cannot be implemented without extensive public outreach, traffic analyses, and study.

At the March 2025 BPAC meeting, staff presented the list of streets to be included in the 2026 project. BPAC voted to approve the proposed bicycle facilities for the streets listed below:

- 1. Cabrillo Avenue (Calabazas Blvd. to Francis Ave.) Class IIB Bicycle Lane
- 2. Camino Drive (Washington St. to Park Ave.) Class III Bicycle Route
- 3. Garrity Way (Agnew Rd. to Lick Mill Blvd.) Class III Bicycle Route
- 4. East River Parkway (Garrity Wy. to Lick Mill Blvd.) Class III Bicycle Route

As set forth by the City of Santa Clara Complete Streets Policy, relevant transportation projects shall be coordinated with the BPAC to gather comments and recommendations regarding Complete Streets features that should be incorporated into the project.

### DISCUSSION

The 2026 Annual Street Maintenance and Rehabilitation Project is currently at the 65 percent design phase. These projects are considered relevant transportation projects to be coordinated with BPAC, and as such, these plans are attached for BPAC to review and provide feedback.

Written by: Steve Chan, Transportation Manager, Public Works

Reviewed by: Carol Shariat, Principal Transportation Planner, Public Works Approved by: Michael Liw, Assistant Director/City Engineer, Public Works

### **ATTACHMENT**

1. 2026 Annual Street Maintenance and Rehabilitation Project



# CITY OF SANTA CLARA PUBLIC WORKS DEPARTMENT

COUNTY OF SANTA CLARA, STATE OF CALIFORNIA

### PLANS FOR

# 2026 ANNUAL STREET MAINTENANCE AND REHABILITATION PROJECT

PROJECT NO. CE xx-xx-xx

### INDEX OF SHEETS:

SHEET NO.	SHEET DESCRIPTION	
1	TITLE SHEET	AC
2	KEY MAP	AB BW
3	GENERAL NOTES	C&G
4	TYPICAL CROSS SECTIONS	CJ
5-44	PAVEMENT IMPROVEMENT PLAN	CONC
45-84	SIGNING AND STRIPING PLAN	CR
85-149	CURB RAMP AND CROSSWALK PLAN	DET
150	MATHEW STREET C&G REPLACEMENT	DI DH
XX	SURVEY CONTROL PLAN (TO BE INCLUDED IN 95% SUBMITTAL)	DWS
XX-XX	SIGNAL LOOP REPLACEMENT PLAN (TO BE INCLUDED IN 95% SUBMITTAL)	DWY
xx	MONUMENT PRESERVATIONS (TO BE INCLUDED IN 95% SUBMITTAL)	EP EVT
151-152	CONSTRUCTION DETAILS	EX
153	CONSTRUCTION BEST MANAGEMENT PRACTICES (BMPs)	FC FH
xx-xx	QUANTITY SHEET (TO BE INCLUDED IN 95% SUBMITTAL)	GV HAWK
		HMA

### APPLICABLE STANDARD PLANS:

SANTA CLARA STANDARD DETAILS (LATEST EDITION): ST-11 MONOLITHIC CURB AND GUTTER MONOLITHIC CURB, GUTTER AND SIDEWALK ST-14\* CURVED CURB RAMP ST-14M\* MODIFIED CURVED CURB RAMP
ST-16\* CURB RAMP GROOVING AND TRUNCATED DOME DETAILS ST=17 CONCRETE JOINTS ST-18 DOWEL CONNECTIONS ST-20 MONUMENT ST-21 SPECIAL MONUMENT BOX ADJUSTMENT MANHOLE MANHOLE RAISING DS-5 DS-6 TR-1 CONCRETE COLLAR STREET NAME SIGN AND LOCATION TR-5 TRAFFIC SIGNAL TRENCH DETAILS PULL BOX
TRAFFIC SIGNAL DETECTOR LOOPS SPACING TYPICAL STOP INTERSECTION SIGN POST INSTALLATION TR-10 TRAFFIC VALVE BOX

### \*SEE CONSTRUCTION DETAILS SHEET

CALTRANS STANDARD LIST (LATEST EDITION);
A20A-F PAVEMENT MARKERS AND TRAFFIC LINES, TYPICAL DETAILS

APPENDIX A GENERAL NOTES

A24A-G PAVEMENT MARKINGS, ARROWS, SYMBOLS, NUMERAL WORDS. LIMIT AND YIELD LINES
TEMPORARY WATER POLLUTION CONTROL DETAILS (TEMPORARY DRAINAGE INLET PROTECTION)

### CA MUTCD STANDARD LIST (LATEST EDITION):

MARKINGS

FIG 3B-102(CA) EXAMPLES OF FIRE HYDRANT LOCATION PAVEMENT FIG 9C-108(CA) EXAMPLES OF PLACEMENT OF SHARED LANE

### **ABBREVIATIONS**


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### **UTILITY LINES:**

EXIST	DESCRIPTION
- sd	STORM DRAIN LINE
-ss	SANITARY SEWER LI
_t	TELEPHONE LINE
- w — — —	WATER LINE
-g	GAS LINE
e	ELECTRICAL LINE
c	CONDUIT
- (oh)	OVERHEAD LINE

### **SURFACE FACILITIES:**

SYMBOL	DESCRIPTION
(SD)	STORM DRAIN MANHOLE
(SS)	SANITARY SEWER MANHOLE
	DRAIN INLET
$\Rightarrow$	ROUND INLET
*O*	HYDRANT
-0-	UTILITY WOOD POLE
<b>&gt;</b> ⊄	STREET LIGHT POLE
(A)	TREE
	- FENCE
	TRAFFIC SIGN

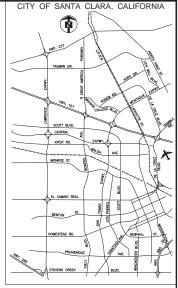

VICINITY MAP N.T.S.

### ACCEPTANCE OF PLANS:

THE CITY OF SANTA CLARA HEREBY ACCEPTS THESE PLANS FOR CONSTRUCTION, AS BEING IN GENERAL COMPLIANCE WITH PLANS PREPARATION REQUIREMENTS OF THIS GOVERNMENT. RESPONSIBILITY FOR THE COMPLETENESS AND ACCURACY OF THE PLANS AND RELATED DESIGN RESIDES WITH THE ENGINEER AND ENGINEERING FIRM OF RECORD.

### APPROVED FOR BIDDING:

MICHAEL JACK LIW ASSISTANT DIRECTOR OF PUBLIC WORKS / CITY ENGINEER REVIEWED BY:

WATER AND SEWER UTILITIES DEPARTMENT

STREET MAINTENANCE DIVISION

SILICON VALLEY POWER

TRAFFIC ENGINEERING DIVISION

DESIGN DIVISION

CERTIFICATION OF PEER REVIEW: REVIEW OF THESE PLANS AND THE REQUIRED DESIGNS WAS CONDUCTED BY ME, A PROFESSIONAL ENGINEER WITH EXPERTISE
AND EXPERIENCE IN THE APPROPRIATE FIELD OF ENGINEERING EQUAL TO OR GREATER THAN THE ENGINEER OF RECORD, AND THAT

APPROPRIATE CORRECTIONS HAVE BEEN MADE.

THE UNDERSIGNED HEREBY CERTIFIES THAT A PROFESSIONAL PEER



NOTE: THERE MAY BE ADDITIONAL UNDERGROUND FACILITIES THAT ARE NOT SHOWN ON PLANS AND ALL UTILITY LOCATIONS ARE APPROXIMATE. CONTRACTOR MUST FIELD VERIFY ALL UTILITIES PRIOR TO CONSTRUCTION.




I KOSEC	1 140.	CE XX-XX-XX	
ACCOUNT No.			
DATE	No.	REVISION	BY
			-

CITY OF SANTA CLARA 2026 ANNUAL STREET MAINTENANCE AND REHABILITATION PROJECT TITLE SHEET

INITIAL DATE Survey No. DESIGNED BY DS xx/xx/25 TRACING NO DRAWN BY HM xx/xx/25 CHECKED BY MF xx/xx/25



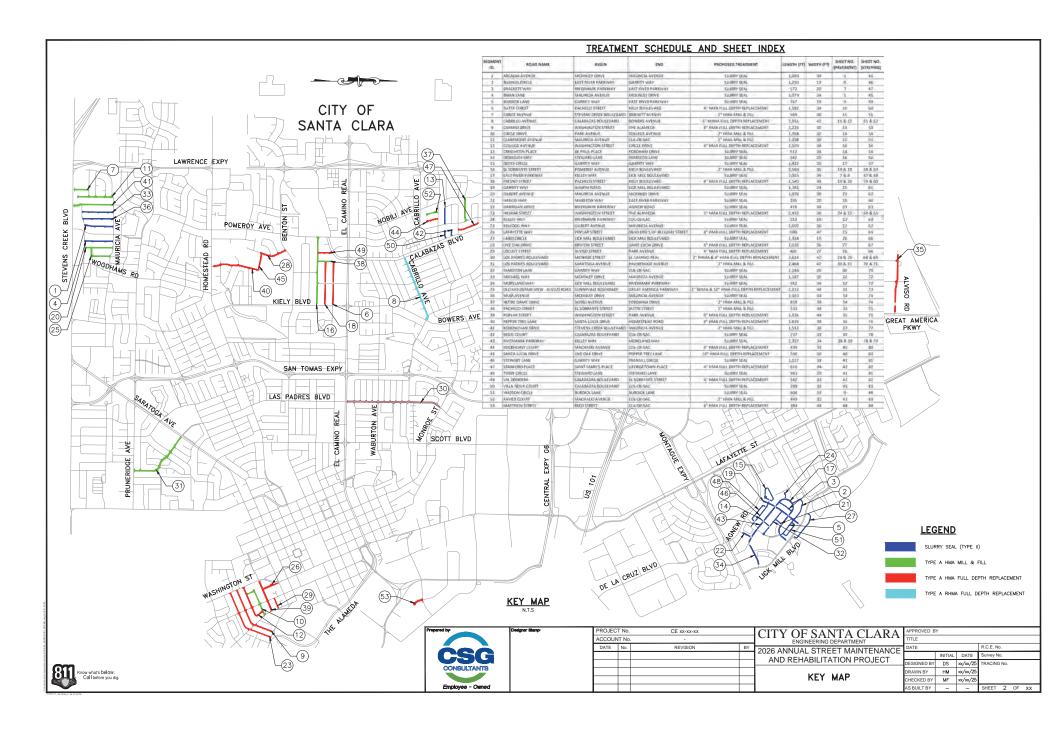

#### CITY GENERAL NOTES:

- . ALL MATERIALS AND WORKMANSHIP SHALL CONFORM TO THE CITY'S STANDARD 2015 DETAILS, STANDARD SPECIFICATIONS, AND GENERAL REQUIREMENTS.
- IT IS THE CONTRACTOR'S RESPONSIBILITY TO VERIFY THE LOCATION OF ALL EXISTING UTILITIES WITH THE
  APPROPRIATE UTILITY ASSUMES PRIOR TO THE COMMENCEMENT OF CONSTRUCTION, CONTRACTOR SHALL NOTIFY ALL
  PUBLIC AND PRIVATE UTILITY OWNERS 48 HOURS PRIOR TO COMMENCEMENT OF WORK ADJACENT TO THE UTILITY.
  CONTRACT UNDERGROUND SERVICE ALERT (USA) AT 811 OR 800-227-2500.
- THE CONTRACTOR SHALL NOTIFY, BY CIRCULAR, ALL BUSINESS ESTABLISHMENTS AND RESIDENCES LOCATED IN AREAS AFFECTED BY THE WORK AT LEAST FORTY-EIGHT (48) HOURS PRIOR TO START OF CONSTRUCTION. CIRCULAR SHALL BE SUBBLICT TO THE APPROVAL OF THE CITY ENDINEER.
- 4. UNLESS OTHERWISE DIRECTED BY THE CITY ENGINEER IN THE FIELD: AT EACH LOCATION WHERE NEW CURRY/GUTTER IS TO BE INSTALLED ON AN EXISTING STREET (IRNEWLY INSTALLATION, DIRWAY ABANDONMENT, CUBB RAMP INSTALLATION, CUBB FACE DRAINAGE INSTALLATION, ETC.) PAVEMENT RECONSTRUCTION SHALL BE REQUIRED. AN 18-INCH WIDE BAND OF PAVEMENT SHALL BE REMOVED AND REPLACED ALONG THE ENTIRE LENGTH OF CURRY/GUTTER INSTALLATION, REMOVAL DEPTH (SAW CUST REQUIRED) SHALL BE TO THE BASE MATERIAL ON STREETS WITH AC. OF P.C.C. PAVEMENT FOUR C4) NICHES MINIMUM ON STREETS WITH PLC. (GRIND) AND FOUR (4) INCHES MINIMUM ON STREETS WITH PLC. (GRIND) AND FOUR (4) INCHES MINIMUM ON STREETS WITH PLC. (SAW CUST) PAVEMENT THICKNESS. REGEATER THAN FOUR (4) INCHES MINIMUM ON STREETS WITH PLC. (SAW CUST) PAVEMENT THICKNESS REGEATER THAN FOUR (4) INCHES MINIMUM ON STREETS WITH PLC. (SAW CUST) PAVEMENT THICKNESS REGEATER THAN FOUR (4) INCHES MINIMUM ON STREETS WITH PLC. (SAW CUST) PAVEMENT THICKNESS REGEATER THAN FOUR (4) INCHES MINIMUM ON STREETS WITH PLC. (5)
- ALL SIDEWALK, CURB, AND GUTTER DAMAGED AS A RESULT OF THE PROJECT SHALL BE REMOVED AND REPLACED TO THE NEAREST SCOR MARK OR AS DIRECTED BY THE CITY ENGINEER. INSTALLATION OF NEW SIDEWALK, CURB AND GUTTER AGAINST EXISTING IMPROVEMENTS SHALL REQUIRE A SIDEWALK CONTACT JOINT (DOWNELS REQUIRED).
- 6. PARTIAL REPLACEMENT OF A DERIVEWY IS NOT ALLOWED. A DRIVEWY THAT HAS BEEN CUT OR DAMAGED MUST BE REPLACED IN ITS ENTIRETY. THE NEW REPLACEMENT DRIVEWAY MUST MEET CURRENT CITY STANDARDS WHICH MAY AFFECT ON-SITE IMPROVEMENTS AND/OR REQUIRE A SIDEMAK EASEMENT.
- SLURRY SEAL SHALL BE REQUIRED ON ALL NEW STREET PAVEMENT (E.G., TRENCH WORK, POTHOLES, AND STREE WIDENINGS). SLURRY SEAL SHALL EXTEND TWELVE INCHES BEYOND THE LIMIT OF PAVEMENT RECONSTRUCTION.
- 8. GRADE BREAKS ON CURBS AND SIDEWALKS ARE TO BE ROUNDED OFF ON FORM WORK AND FINISHED SURFACING.
- THE CONTRACTOR SHALL BE RESPONSIBLE FOR THE PRESERVATION AND/OR PERPETUATION OF EXISTING SURVEY MONUMENTS (CUIR BLASS RON PIEZS STREET MONUMENTS, ECC), NOTED ON THE E-LANS OF FOUND DURING MONUMENT HAS THE POTENTIAL OF BEING DISTURBED OR WHITHIN 3 FEET OF THE WORK, THE WOMMENT SHALL BE LOCATED, REFERENCED, AND A CORNER RECORD SHALL BE FILED WITH THE SHATE CLARA COUNTY SURVEYOR, AND A CONNER RECORD SHALL BE FILED WITH THE SHATE CLARA COUNTY SURVEYOR, AND A CONNER RECORD SHALL BE LOCATED, SHATE OF THE CONNER RECORD SHALL BE CLARA COUNTY SURVEYOR. AND A CONNER RECORD TO THE SHATE CONNERSTORY SHATE OF THE SHATE CONNERS PRIOR TO FINANCIAL SHATE CONNERS PRIOR TO PRIOR THE CONNERS PRIOR TO FINANCIAL SHATE CONNERS PRIOR TO PRIOR CONNERS PRIOR TO PRIOR CONNERS PRIOR TO PRIOR THE CONNERS OF THE SHATE CONNERS PRIOR TO PRIOR CONNERS OF THE MONUMENT PRIOR TO PRIOR CONNERS OF THE MONUMENT PRIOR TO PRIOR CONNERS PRIOR TO PRIOR CONNERS
- 10. ALL SURPLUS AND UNSUITABLE MATERIAL SHALL BE REMOVED FROM PUBLIC RIGHT-OF-WAY.
- 11. CONTRACTOR SHALL PROVIDE ADEQUATE DUST CONTROL AND KEEP MUD AND DEBRIS OFF THE PUBLIC RIGHT-OF-WAY AT ALL TIMES.
- 12. ALL TRENCHES AND EXCAVATIONS SHALL BE CONSTRUCTED IN STRICT COMPURINCE WITH THE APPLICABLE SECTIONS OF CALIFORMS AND FEDERAL O.S.H.A. REQUIREMENTS AND OTHER APPLICABLE SAFETY ORDINANCES. CONTRACTOR SHALL BEAR PULL RESPONSIBILITY FOR TRENCH SHORING DESIGN AND INSTALLATION.
- 13. EXISTING UTILITIES SHOWN ARE BISED UPON RECORD INFORMATION AND ARE APPROXIMATE IN LOCATION AND DEPTH. THE CONTRACTOR SHALL POTHLE ALL EXISTING UTILITIES THAT MAY RE AFFECTED BY NEW FACULITIES IN THIS CONTRACT, VERIEY ACTUAL LOCATION AND DEPTH, AND REPORT POTENTIAL CONFLICTS TO THE ENGINEER PRIOR TO EXCANATING FOR NEW FACULITIES.
- 14. CONTRACTOR SHALL PERFORM THEIR CONSTRUCTION AND OPERATION IN A MANNER, WHICH WILL NOT ALLOW HARMFUL POLLUTANTS TO ENTER THE STORM DIGNL SYSTEM. TO ENSURE COMPLIANCE, THE CONTRACTOR SHALL MPLEMENT THE APPROPRIATE BEST MANAGEMENT PRACTICE (BMP) AS OUTLINED IN THE BROCHURES ENTITLED "BEST MANAGEMENT PRACTICE FOR THE CONSTRUCTION INDUSTRY" ISSUED BY THE SANTA CLARA VALLEY NONPOINT SOURCE POLLUTION CONTROL PROGRAM, TO SUIT THE CONSTRUCTION STEE AND JOB CONDITION.
- 15. OVERNIGHT PARKING OF CONSTRUCTION EQUIPMENT IN THE PUBLIC RIGHT-OF-WAY SHALL NOT BE PERMITTED, EXCEPT AT LOCATION(S) APPROVED BY THE CITY TRAFFIC ENGINEER.
- 16. UNLESS OTHERWISE NOTED, CLASS 2 A.B. UNDER CURB, GUTTER, AND STREET SECTIONS PAVED WITH ASPHALT CONCRETE SHALL BE COMPACTED TO 95% RELATIVE COMPACTION.

#### ARRORIST NOTES

### I. GENERAL

- NO CUTTING OF ANY PART OF CITY TREES, INCLUDING ROOTS, SHALL BE DONE WITHOUT SECURING APPROVAL AND DIRECT SUPERVISION FROM THE CITY ARBORIST OR ARBORIST EMPLOYED BY CITY (408) 615-3080.
- NO CUTTING OF ANY PART OF PRIVATE TREES, INCLUDING ROOTS, SHALL BE DONE WITHOUT DIRECT SUPERVISION OF AN INTERNATIONAL SOCIETY OF ARBORICULTURE (ISA) CERTIFIED ARBORIST.
- 3. WHEN CONSTRUCTION OCCURS WITHIN THE DRIP LINE OF EXISTING TREES, CONTRACTOR SHALL PILE THE SOIL ON THE SIDE AWAY FROM THE TREE. WHEN THIS IS NOT POSSIBLE, PLACE SOIL ON PLYWOOD, TARP, OR 4" - 5" THICK BED OF MULCH. THIS IS TO PREVENT CUTTING INTO THE SOIL SURFACE WHEN THE BEACHING OR TRACTOR BLADE REFILET TRENCH.
- 4. REFILL OPEN TRENCHES QUICKLY WITHIN HOURS OF EXCAVATION WHEN THEY OCCUR WITHIN THE DRIP LINE OF EXISTING TREES. IF THIS IS NOT POSSIBLE AND THE WEATHER IS HOT, DRY, OR WINDY, CONTRACTOR MUST KEEP ROOT ENDS MOIST BY COVERNO THEM WITH WEST BURKEP, IF THE EMPERATURE IS 80 FOR OR GREATER, THE BURKEP MUST BE INSPECTED EVERY HOUR, AND RE-WET AS NECESSARY TO MAINTAIN A CONSTANT COOL MOIST CONDITION. SMALL ROOTS CAN DRY OUT AND DIE IN 10-15 MINUTES. LARGER ROOTS CAN DECUMB IN AN HOUR OR LESS UNDER UNFAVORABLE WEATHER CONDITIONS.
- 5. WHEN ROOTS 2" OR LARGER ARE REQUIRED TO BE CUIT, SHOPEL BY HAND NEAR THE ROOTS AND PRILLE THE ROOTS WITH AN INDUSTRY-APPROVED PRINING TOOL, BOOTS THAT ARE ACCIDENTALLY RORKEN SHOULD BE PRILLED TWO INCHES FROM THE DAMAGED END. CRUSHED OR TORN ROOTS ARE MORE LIKELY TO ALLOW DECAY TO BEGIN. SHARPLY CUIT ROOTS PRODUCE A FLUSH OF RISK ROOTS HELPING THE TREET TO RECOVER FROM ITS NUMPY.
- 6. CONTRACTOR SHALL NOTIFY THE CITY ARBORIST OR ARBORIST EMPLOYED BY CITY 72 HOURS IN ADVANCE OF ANY WORK REQUIRING DIGGING AROUND OR WITHIN THE DRIP LINE OF EXISTING TREES.
- 7. A CLEAR SYSTEM OF FLAGGING MUST BE PROVIDED AROUND TREES WITHIN 20' OF THE PROPOSED GRADING. CONTRACTOR SHALL SECURE APPROVAL OF SUCH SYSTEM FROM THE CITY ARBORIST OR ARBORIST EMPLOYED BY CITY.
- 8. MATERIALS, EQUIPMENT, TEMPORARY BUILDINGS, FUELS, PAINTS, AND OTHER CONSTRUCTION ITEMS SHALL NOT BE PLACED WITHIN THE DRIP LINE OF EXISTING TREES.
- 9. FENCE ALL TREES TO BE RETAINED TO COMPLETELY ENCLOSE THE TREE PROTECTION ZONE PRIOR TO DEMOLITION, GRUBBING, OR GRADING, FENCING SHALL BE PLACED AT THE DRIP LINE OF EXISTING TREES OR, IF POSSIBLE, I.5 TIMES THE RADIO OF THE DRIP LINE OF THE TREE. A WARRING SION SHALL BE PROMINENTLY DISPLAYED ON EACH FENCE. THE SIGN SHALL BE A MINIUM OF 8.5°X11" AND CLEARLY STATE "WARRING TREE PROTECTION ZONE THIS FENCE SHALL BE AS HALL BE A MINIUM OF 8.5°X11" AND CLEARLY STATE "WARRING TREE PROTECTION ZONE THIS FENCE SHALL BE 6.6"FOOT TALL CHANLINK OR COUNTAINT. FROM THE OTHER PROTECTION ZONE THIS TREAT SHALL BE 6.6"FOOT TALL CHANLINK OR COUNTAINT. A SPERVOED BY THE CITY ARBORIST, FOR ARBORIST EMPLOYED BY CITY, FENCES SHALL BE 6.6"FOOT TALL CHANLINK OR COUNTAINT. A SPERVOED BY THE CITY ARBORIST OR ARBORIST EMPLOYED BY CITY, FENCES SHALL BE 6.6"FOOT TALL CHANLINK OR AND CONSTRUCTION WORK IS COMPLETED. IN ADDITION, WARP ALL TREES WITH THE ARRAY WADDLE UP TO THE FIRST MAN BRANCH, THE WARP SHOW THE WORK.
- 10. NO TRENCHING SHALL BE DONE WITHIN THE DRIP LINE OF EXISTING TREES WITHOUT THE APPROVAL OF THE CITY ARBORIST OR ARBORIST EMPLOYED BY CITY, OPEN TERCHCHING IN THE ROOT ZONE OF A PUBLIC TREE IS PROHIBITED EXCEPT IN CASES WHERE THE TRENCHING FALLS OUTSIDE THE DRIP LINE OF THE TREE INDUCED. EXCEPTIONS MAYER ALLOWED IN, IN THE OPHION OF THE CITY ARBORIST OR ARBORIST EMPLOYED BY CITY, THE IMPACT OF TRENCHING ON THE TREE WILL BE
- 11, ANY CUTTING OF EXISTING ROOTS OF CITY TREES SHALL BE DONE WITH APPROVED LIGHT EQUIPMENT UNDER THE DIRECT SUPERVISION OF THE CITY ARBORIST OR ARBORIST EMPLOYED BY CUTTING OF EXISTING ROOTS OF PRIVATE TREES SHALL BE DONE WITH APPROVED EQUIPMENT UNDER THE DIRECT SUPERVISION OF AN ISA-CERTIFIED ARBORIST.
- 12. GRADING SHOULD NOT CREATE DRAINAGE PROBLEMS FOR TREES BY CHANNELING WATER INTO THEM, OR CREATING SUNKEN AREAS.
- 13. ALL GRADING WITHIN THE DRIF LINE OF CITY TREES SHALL BE DONE WITH APPROVED LIGHT COUPRENT LUNGER THE DIRECT SUPERVISION OF THE CITY ARGRESTS OR ARBORIST OR ARBORIST EMPLOYED SET CITY. ALL GRADING WITHIN THE DRIF DIRECT SHALL BE DONE WITH APPROVED EQUIPMENT UNDER THE DIRECT SUPERVISION OF AN ISA-CERTIFIED ARBORIST. THE ORIGINAL GRADE AT THE BASE OF EXISTING TREES SHALL NOT BE MODIFIED. IF A GRADE ROREASE IS NECESSARY, DRIV WELLS SHOULD
- 14. WHEN TRENCHING IS ALLOWED WITHIN THE DRIPLINE OF EXISTING TREES, THE CONTRACTOR MUST FIRST CUT ROOTS WITH A VERMEER ROOT CUTTER PRIOR TO ANY TRENCHING TO AVOID TUGGING OR PULLING OF ROOTS.
- 15. TREES THAT ARE DETERMINED TO BE REMOVED BY THE CITY ARBORIST OR ARBORIST EMPLOYED BY CITY DUE TO AN UNFORESEEN CIRCUMSTANCE DURING CONSTRUCTION SHALL BE REPLACED BY THE CONTRACTOR. THE CITY ARBORIST OR ARBORIST EMPLOYED BY CITY SHALL DETERMINE THE REPLACEMENT SPECIES, SIZE, QUANTITY, AND SPACING.
- 16. PLACE 4"-5" THICK MULCH AROUND ALL EXISTING TREES (OUT TO THEIR DRIP LINE) THAT ARE TO BE RETAINED PRIOR TO ANY CONSTRUCTION. THIS WILL HELP MAINTAIN MOISTURE UNDER THE TREE WITHIN THE FENCING AREA.
- 17. BORE PITS ARE NOT ALLOWED WITHIN THE DRIP LINE OF ANY TREE.
- 18. CONTRACTOR SHALL COORDINATE WITH CITY ARBORIST IF TREE TRIMMING IS REQUIRED TO PROVIDE ADEQUATE CLEARANCE PRIOR TO CONSTRUCTION WORK.

### II. BORING (NOT USED)

### III. TREE PROTECTION

- 1. CONTRACTOR SHALL TAG AND IDENTIFY EXISTING TREES WHICH ARE TO REMAIN WITHIN THE PROJECT LIMITS AND ON THE PUBLIC RIGHT-OF-MAY PRIOR TO START OF WORK, PROTECT ALL TAGGED TREES AT ALL TIMES FROM DAMAGE BY THE WORK, TREATMENT OF ALL MINOR DAMAGE TO TAGGED TREES SENALL BE PERFORMED. BY SAC-CERTIFIED ARBORIST OR OTHER PERSONNEL APPROVED BY THE CITY ARBORIST OR ARBORIST EMPLOYED BY CITY, IF A TAGGED TREE IS PERMANENTLY DISFOURCED OR KILLED AS A RESULT OF THE WORK, CONTRACTOR SHALL REMAIN ENDING. FROM THE SITE AND REPLACE EACH REMOVED THERE WITH AN EQUAL-SZED TREE. IF SUCH REPLACEMENT IS NOT POSSIBLE, THE CONTRACTOR SHALL REMOVED BY CITY AND ARBORIST OR ARBORIST DIAL BY THE OWNER THE ARBORIST OR ARBORIST DIAL BY THE OWNER THE OWNER THE ARBORIST OR ARBORIST DIAL BY THE OWNER THE OWNER THE ARBORIST OR ARBORIST DIAL BY THE OWNER THE CONTRACTION SHALL REMOVED.
- 2. CONTRACTOR SHALL PAY THE TREE OWNER THE VALUE OF EXISTING TREES TO REMAIN THAT DIED OR WERE DAMAGED BECAUSE OF THE CONTRACTOR'S FAILURE TO PROVIDE ADEQUATE PROTECTION AND MAINTENANCE. THE PAYMENT AMOUNT SHALL BE IN ACCORDANCE WITH THE FOLLOWING SCHEDULE OF VALUES, USING "TREE CALIER" METHOD ESTREBLISHED IN THE MOST RECENT ISSUE OF THE "GUIDE FOR ESTABLISHING VALUES OF TREES AND OTHER PLANTS," PREPARED BY THE COUNCIL OF TREE AND LANDSCAPE ARCHITECTS.

# 7 INCHES \$ 2,400 8 INCHES \$ 3,400 9 INCHES \$ 3,400 10 INCHES \$ 4,000 11 INCHES \$ 5,000 12 INCHES \$ 7,200 13 INCHES \$ 8,200



#### OUNTY OF SANTA CLARA GENERAL NOTES:

#### ICNAL AND ELECTRICAL OPERATIONS:

- 1. EUSTING COUNTY COMMUNICATION AND ELECTRICAL FACULTIES ARE LOCATED IN THE PROJECT AREA, COMMUNICATION FIBER OPING CABLE DAMAGED BY THE CONTRACTOR SCHOOL BET TEMPORARY RESTORED AND THEN REPLACED IN ACCORDANCE WITH CSS 86.01.06. DAMAGED FIBER OPTIC CABLE SHALL BE REPLACED FOR THE ENTIRE LENGTH BETWEEN EXISTING END-TO-END SPLICES.
- ANY DAMAGE TO EXISTING ELECTRICAL OR COMMUNICATION SYSTEM SUCH AS LOOP DETECTORS AND FIBER OPTICS SHALL BE TEMPORARILY RESTORED TO FULL OPERATION OR VIA MICROWAVE/VIDEO DETECTION IMMEDIATELY AND REPLACED PRIOR TO PROJECT CLOSURE.
- 3. ALL DESIGN WITHIN COUNTY'S RIGHT-OF-WAY SHALL COMPLY WITH COUNTY STANDARDS.
- 4. INFORMATION SHOWN ON AS-BUILT PLANS IS SUBJECT TO CHANGE. FIELD-VERIFY AND UPDATE CONDUCTOR SCHEDULE ACCORDINGLY. CONTRACTOR WILL BE RESPONSIBLE FOR ANY DAMAGE PERTAINING TO LOOPS/FIBER. CONTRACTOR NEEDS TO REPLACE DETECTION LOOPS WITHIN 24HRS. IF DAMAGED.

### ROAD OPER

- 1. THERE IS A 5-YE WARRANITY WHEN THE PROJECT IS COMPLICED (REFERENCE TO COUNTY ORDINANCE NS-7039, SECTION BIT-58-0, COUNTY'S ROADS OPERATIONS ENDINETRING WILL BETHER ONE TO DETERMINE WHAT CONSTITUTE FAULUTE BASED ON ACCEPTABLE INDUSTRY STANDARDS INCLIDING CRACKS AND SEPARATION IN THE MICRO SURFACING, SETTLEMENT WHERE THE TRENCH REPAIRS TOOK LPLOCE, DAMAGED PAPELWHET DOES ALLONG THE TRENCHES ARE CONSIDERED FAULUTED.
- CONTRACTOR SHALL BE RESPONSIBLE FOR RESTORING PAVEMENT TO LIKE OR BETTER CONDITION, ANY STRIPING IN COUNTY ROW SHALL BE THERMOPLASTIC AND REPLACED PER EXISTING STRIPING, ALL VERTICAL ASPHALT CUTS MUST BE TACK COATED PRIOR TO ASPHALT PLACEMENT.

### THERMOPLASTIC TRAFFIC STRIPES SPECIFICATIONS:

- THERMOPLASTIC TRAFFIC STRIPES SHALL CONFORM TO THE PROVISIONS IN SECTION 84, "TRAFFIC STRIPES AND PAVEMENT MARKINGS,"
  OF THE COUNTY STANDARD SPECIFICATIONS, THE DETAILS SHOWN ON THE PLANS, AND THESE SPECIAL PROVISIONS.
- 2. POST MICROSURFACE OVERLAY ALL FLEXIBLE TEMPORARY MARKERS, FLOPPIES, SHALL BE CUT FLUSH WITH PAVEMENT
- 3. NEW THERMOPLASTIC TRAFFIC STRIPES (ALL TYPES, WIDTHS) INCLUDING SHOULDER STRIPES SHALL REPLACE THE EXISTING STRIPES, IN THEIR EXISTING LOCATIONS, OR AS SHOWN ON THE PROJECT PLANS OR AS DIRECTED BY THE ENGINEER.
- 4. THE ENGINEER SHALL CHECK AND APPROVE THE CAT TRACKS REFORE STRIPING
- THERMOPLASTIC MATERIALS SHALL BE TESTED PRIOR TO USE OR THE MANUFACTURER SHALL PROVIDE THE ENGINEER WITH A
  CERTIFICATE OF COMPLIANCE IN ACCORDANCE WITH THE PROVISIONS OF SECTION 6.11, "CERTIFICATES OF COMPLIANCE," OF THE
  STANDARD SPECIFICATIONS.
- 6. THE ROADWAY SHALL NOT BE STRIPED BEFORE 5 CALENDAR DAYS OF PAVEMENT CURING, BUT SHALL BE STRIPED WITHIN 10 CALENDAR DAYS AFTER THE COMPLETION OF PAVING. LIQUIDATED DAMAGES, AT THE SPECIFIED RATE, SHALL APPLY TO EACH DAY OF DELAY BEYOND THIS DATE UNLESS APPROVED OTHERWISE BY THE ENRINEER.
- 7. FULL COMPENSATION FOR ALL NEW THERMOPLASTIC TRAFFIC STRIPES (ALL TYPES, WIDTHS) INCLUDING SHOULDER STRIPES AND LAYOUT, AND REAVONAL OF TEMPORARY REFLECTIVE MARKERS SHALL BE CONSIDERED AS INCLUDED IN THE UNIT PRICE PAID PER FOOT FOR THERMOPLASTIC TRAFFIC STRIPES AND NO ADDITIONAL COMPENSATION WILL BE ALLOWED THEREFOR.

### THERMOPLASTIC PAVEMENT MARKINGS SPECIFICATIONS:

- THERMOPLASTIC PAVEMENT MARKINGS SHALL CONFORM TO SECTION 84, "TRAFFIC STRIPES AND PAVEMENT MARKINGS," OF THE COUNTY STANDARD SPECIFICATIONS AND THESE SPECIAL PROVISIONS.
- THE PIGMENT, GLASS BEADS, AND FILLER ADDITIVE SHALL BE WELL DISPERSED IN THE BINDER BEFORE APPLICATION TO THE PAYEMENT. HEATED THERMOPLASTIC MATERIAL SHALL NOT EMIT FUNES THAT ARE TOXIC OR INJURIOUS TO PERSONS OR PROPERTY, AND SHALL COMPLY WITH ALL APPLICABLE TAR POLILLIFON CONTROL BRUES AND REGULATIONS.
- THE COMPLETED PAVEMENT MARKINGS SHALL HAVE CLEAN AND WELL—DEFINED EDGES WITHOUT RUNNING OR DEFORMATION, AND SHALL CONFORM TO THE DIMENSIONS SHOWN IN THESE SPECIAL PROVISIONS.
- 4. THERMOPLASTIC MATERIALS SHALL BE TESTED PRIOR TO USE OR THE MANUFACTURER SHALL PROVIDE THE ENGINEER WITH A CERTIFICATE OF COMPLIANCE IN ACCORDANCE WITH THE PROVISIONS OF SECTION 6.11, "CERTIFICATES OF COMPLIANCE," OF THE STANDARD SPECIFICATIONS.
- WORK SHALL CONSIST OF REPLACING EXISTING PAVEMENT MARKINGS, CROSSWALKS AND STOP BARS, WHERE PAVEMENT IS RESURFACED, MEDIAN ISLANDS, RAISED ISLAND LEADING EDGES, OR AT OTHER LOCATIONS AS DIRECTED BY THE ENGINEER
- 6. TIME REQUIREMENTS AS SET OUT IN "THERMOPLASTIC TRAFFIC STRIPES," SHALL ALSO APPLY TO THERMOPLASTIC PAVEMENT MARKINGS.


### THERMOPLASTIC PAVEMENT MARKINGS SPECIFICATIONS


- STOP BARS AND CROSSWALKS SHALL BE MEASURED BY THE SQUARE FOOT FOR THE AREA COVERED BY EACH MARKING UNIT. STOP BARS AND CROSSWALKS SHALL BE 12 INCHES WIDE AS PER STATE STD. PLAN A24E.
- 2. THE CONTRACT PRICES PAID PER SOURCE FOOT FOR THERMOPLASTIC PAYELENT MARKINGS SHALL INCLUDE FULL COMPENSATION FOR FUNNISHING, ALL LABOR, MATERIALS, TOOLS, COUPIEMEN AND INCIDENTALS, INCLUDING AN NECESSARY CAT TRACKS, DRIBBLE LINES, AND LAYOUT WORK, REMOVAL OR CUTTING OF TEMPORARY REFLECTIVE MARKERS COMPLETE IN PLACE AS SHOWN ON THE PLANS, AS SPECIFIED IN THESE SPECIAL PROVISIONS, AND AS DIRECTED BY THE ENRINER, AND NO ADDRIONAL ALLOWANCE WILL BE MADE.


### PAVEMENT MARKERS SPECIFICATIONS:


- PAVEMENT MARKERS SHALL CONFORM TO THE PROVISIONS OF SECTION 85, "PAVEMENT MARKERS," OF THE COUNTY STANDARD SPECIFICATIONS, THE DETAILS SHOWN ON THE PLANS, AND THESE SPECIAL PROVISIONS.
- 2. TIME REQUIREMENTS AS SET OUT IN "THERMOPLASTIC TRAFFIC STRIPES," SHALL ALSO APPLY TO PAVEMENT MARKERS.
- 3. TYPE K MARKERS SHALL BE INSTALLED ON ISLAND NOSES PER THE STATE STANDARD PLANS
- 4. TYPE D MARKERS SHALL BE INSTALLED FOR FIRE HYDRANTS PER THE STATE STANDARD PLANS.
- 5. THE CONTRACT PRICES PAID FER EACH PAYEMENT MARKERS SHALL INCLIDE FULL COMPENSATION FOR RYMINISHING ALL LABOR, MATERIAS, TOOLS, EQUIPMENT AND NIGHTMALS, INCLUDING ANY NECESSAY CAT TRACKS, DIBBIEL LINES, AND LAYOUT WORK AND REMOVAL OF TEMPORARY REFLICTIVE MARKERS, COMPLETE IN PLACE AS SHOWN ON THE PHANS, AS SPECIFIED IN THESE SPECIAL PROVISIONS, AND AS DIRECTED BY THE ENORMER, AND NO ADDITIONAL ALLOWANCE WILL BE MADE.




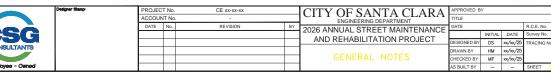


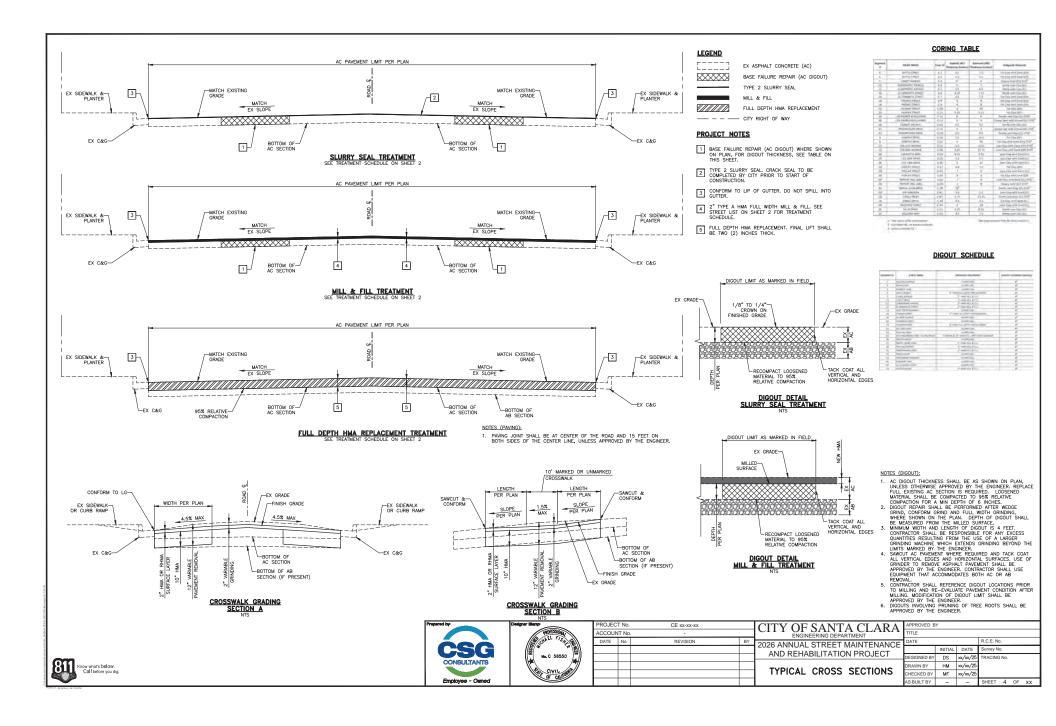


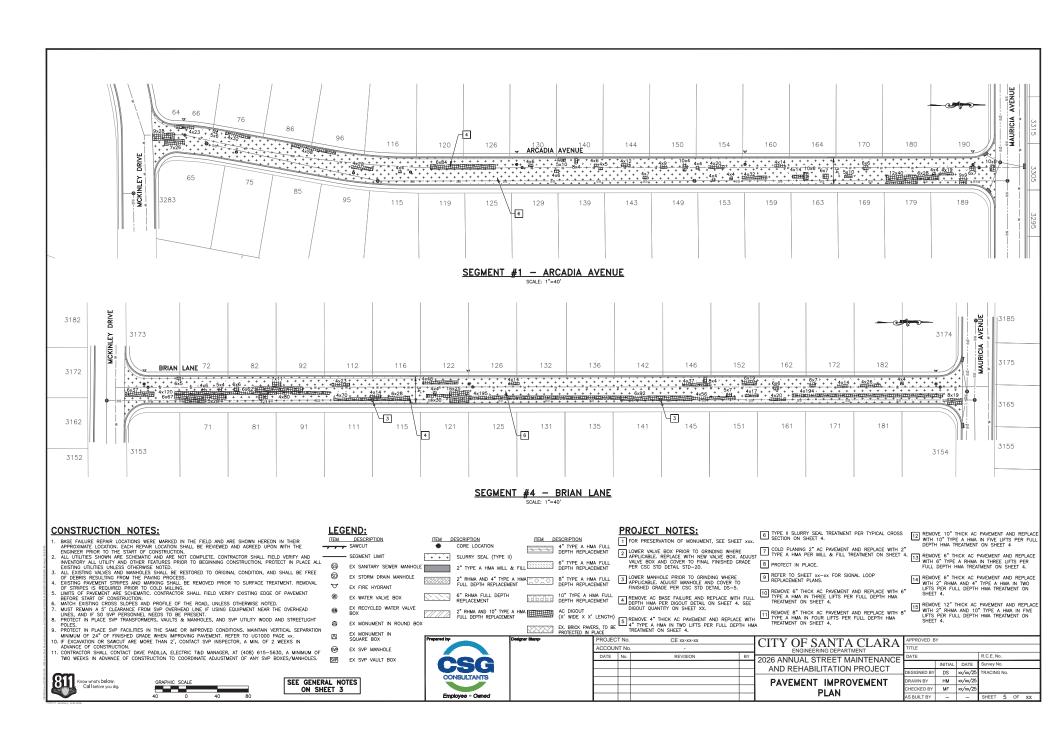


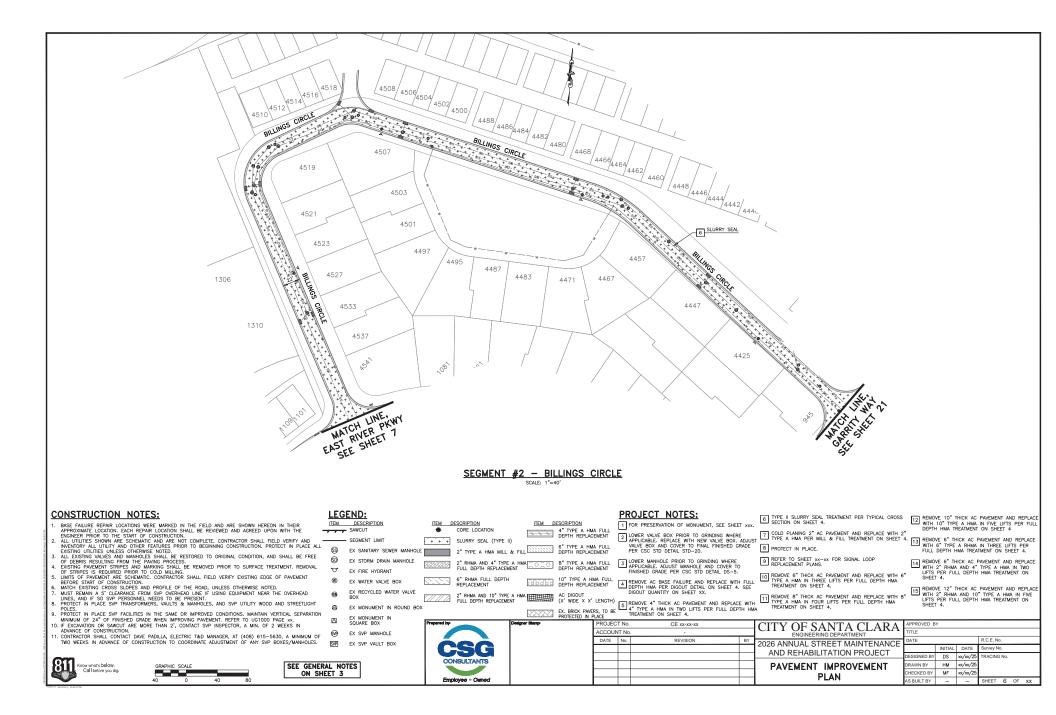


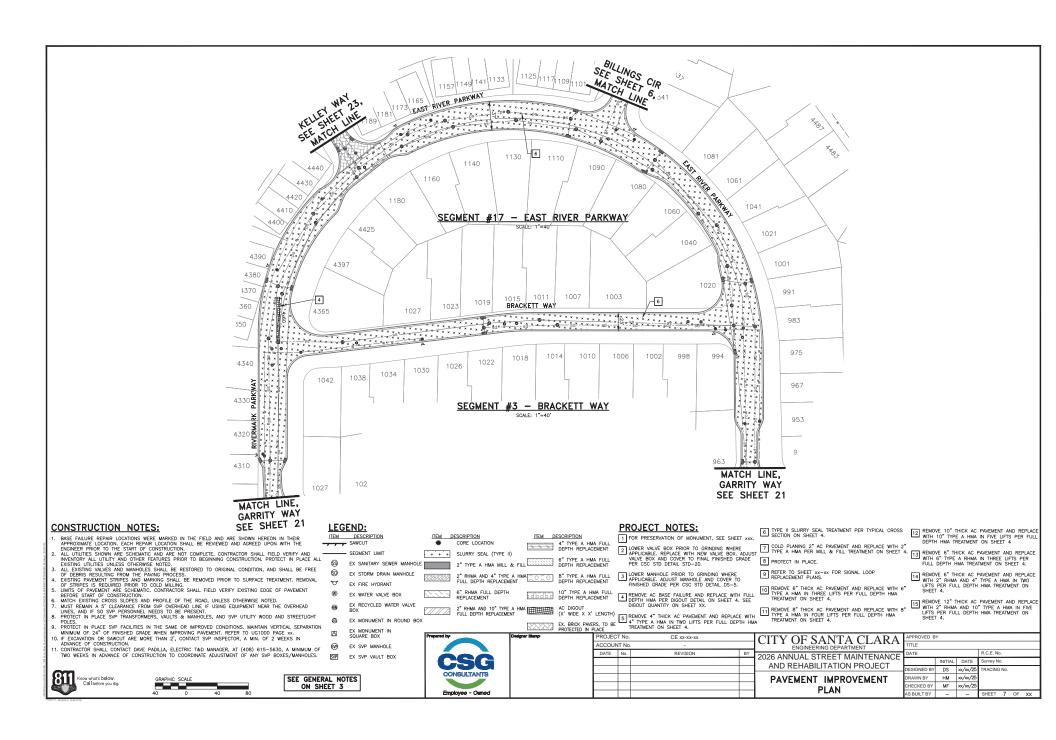


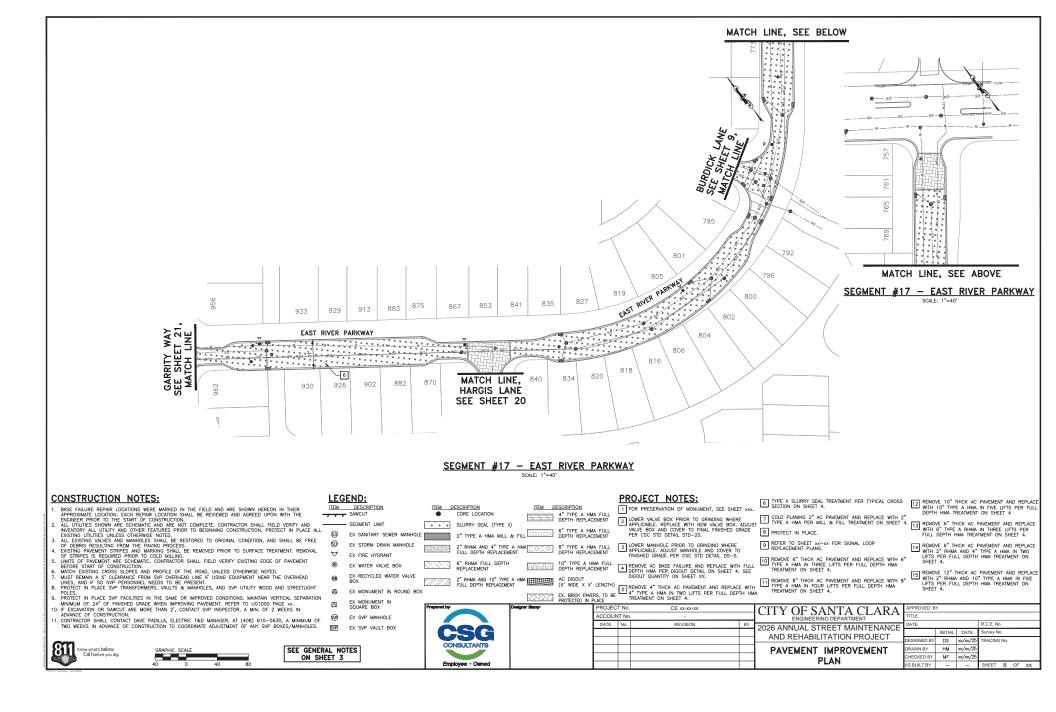


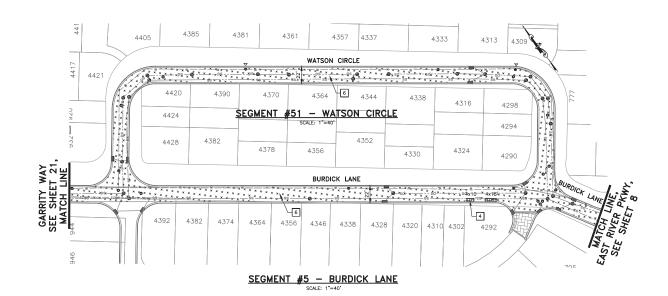


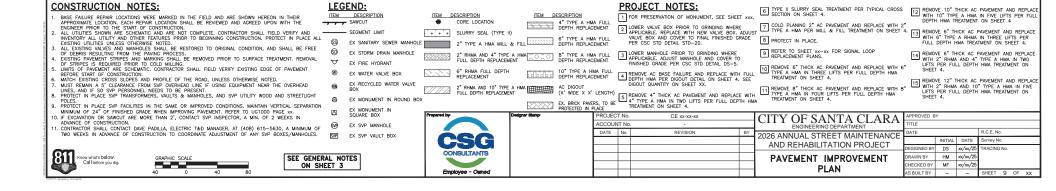


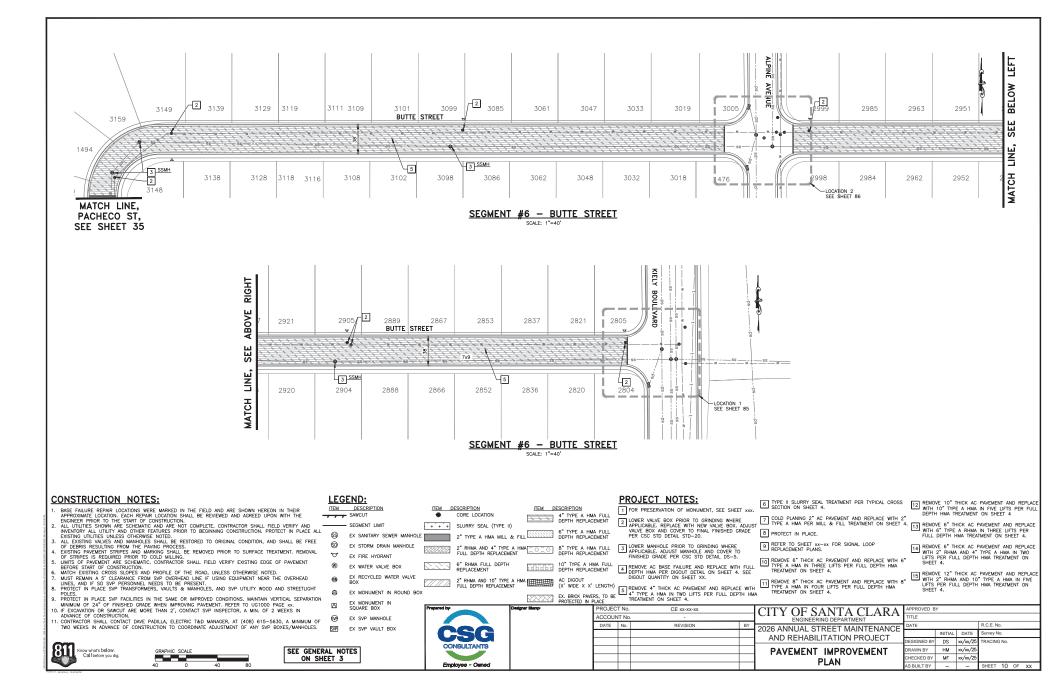


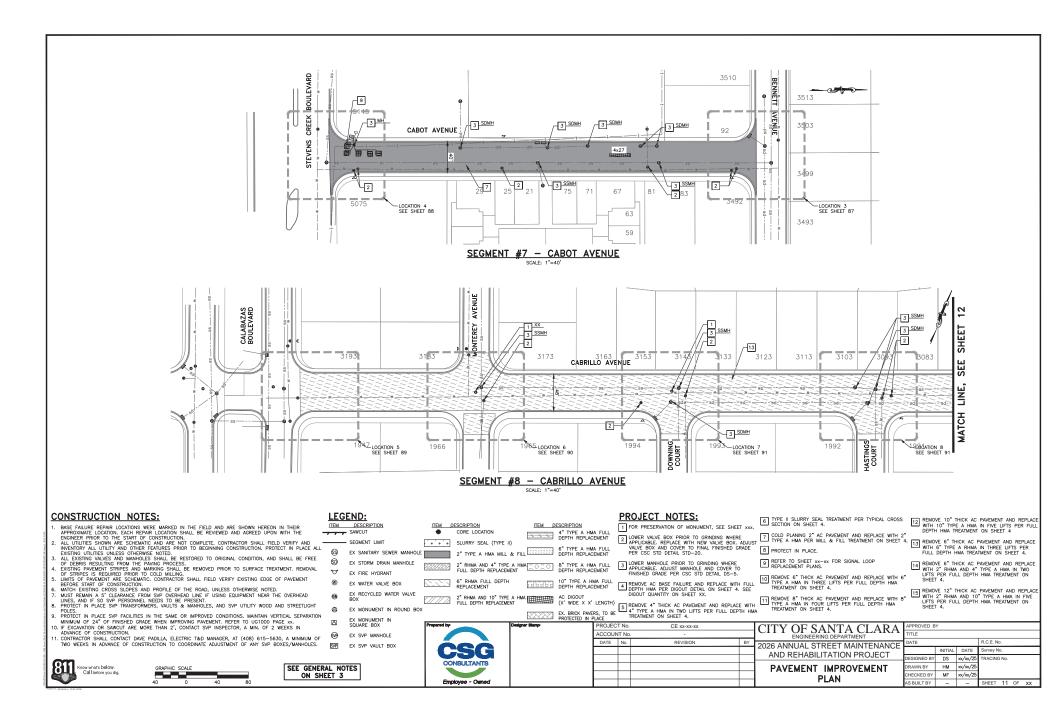


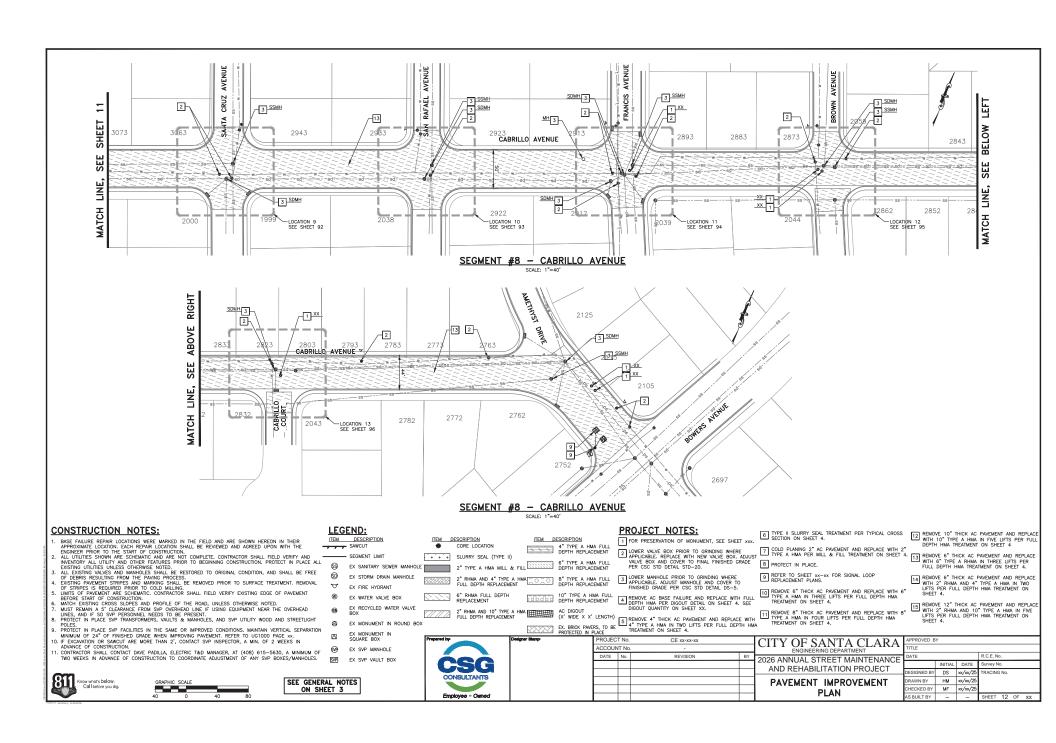


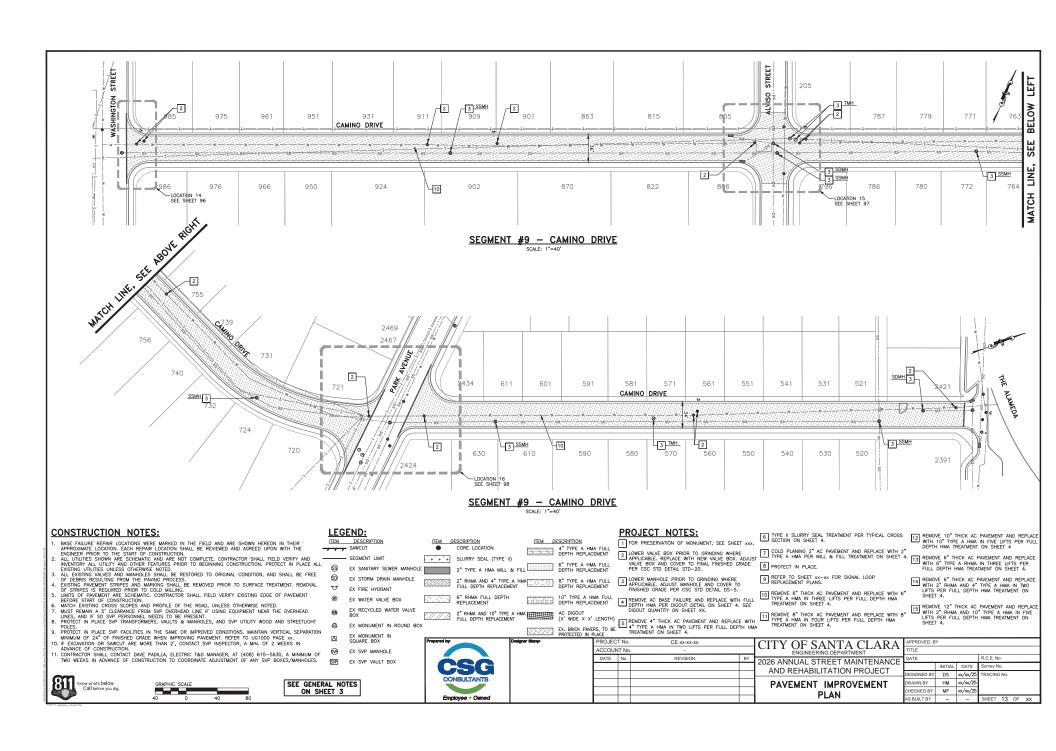


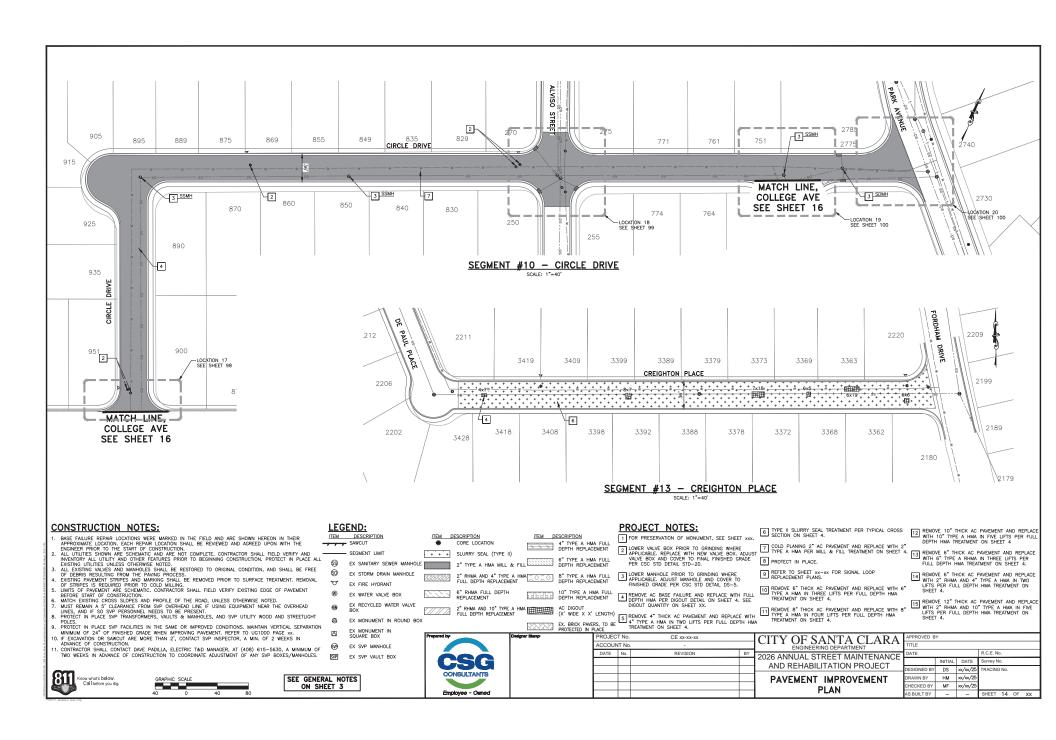


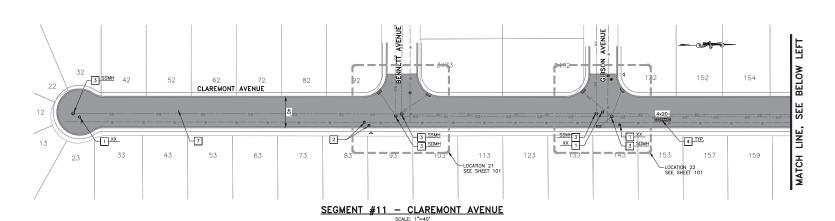

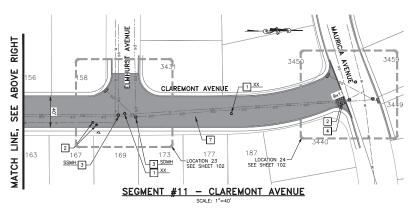

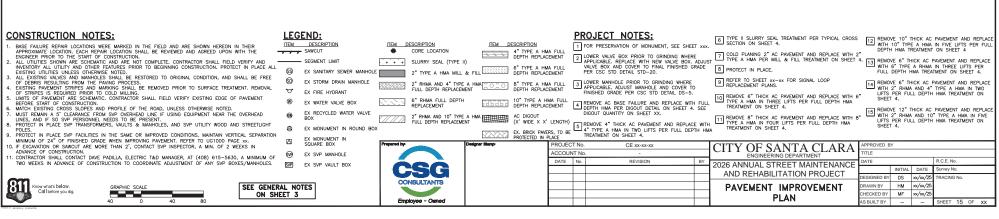

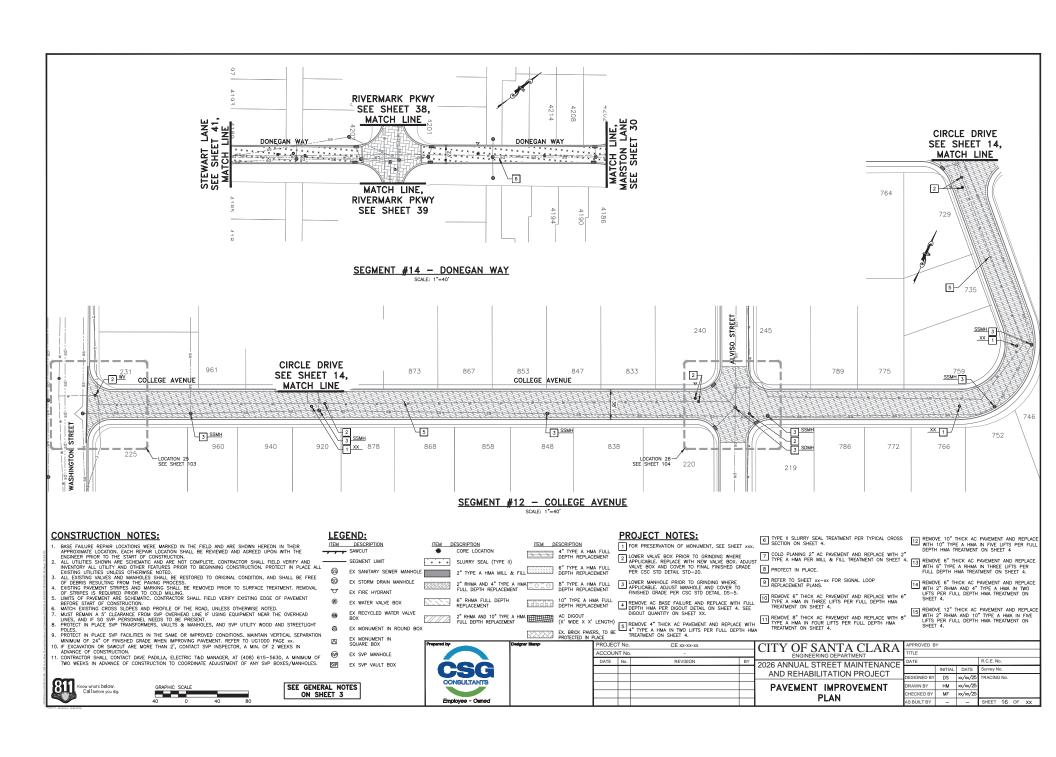


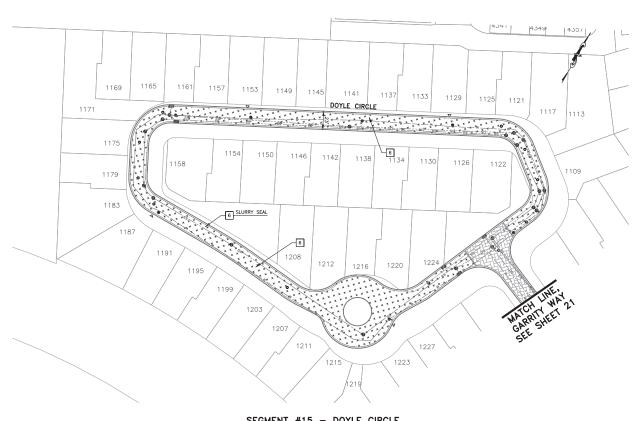



### SEGMENT #15 - DOYLE CIRCLE


#### **CONSTRUCTION NOTES:** LEGEND: **PROJECT NOTES:** 6 TYPE II SLURRY SEAL TREATMENT PER TYPICAL CROSS 22 REMOVE 10" THICK AC PAVEMENT AND REPLACE WITH 10" TYPE A HMA IN FIVE LIFTS PER FULL DEPTH HMA TREATMENT IN SHEET 4 CONSTRUCTION NOTES: 1. BASE FAILURE REPAIR LOCATIONS WERE MARKED IN THE FIELD AND ARE SHOWN HEREON IN THEIR PAPER FAILURE REPAIR LOCATION SHALL BE REVIEWED AND AGREED UPON WITH THE PAPER FAILURE. THE START OF CONSTRUCTION. 2. ALL UTILITIES SHOWN ARE SCHEMATIC AND ARE NOT COMPLETE. CONTRACTOR SHALL RIELD VERIFY AND INNEVERORY ALL UTILITY AND OTHER FEATURES PRIOR TO BEGINNING CONSTRUCTION. PROTECT IN PLACE ALL CHARLES SHOWN STRUCTURES OF THE PAPER SHOWN SHOW ITEM DESCRIPTION ITEM DESCRIPTION ITEM DESCRIPTION 1 FOR PRESERVATION OF MONUMENT, SEE SHEET xxx. CORE LOCATION 4" TYPE A HMA FULL DEPTH REPLACEMENT 2 LOWER VALVE BOX PRIOR TO GRINDING WHERE APPLICABLE. REPLACE WITH NEW VALVE BOX. ADJUST VALVE BOX AND COVER TO FINAL FINISHED GRADE B PROTECT IN PLACE. 2 COLD PLANING 2" AC PAVEMENT AND REPLACE WITH 2" TYPE A HMA PER MILL & FILL TREATMENT ON SHEET 4. 13 REMAKE 6" THICK AC PAVEMENT AND REPLACE WITH 5" TYPE A FINAL IN THREE LIFTS PER PER CSS TOD EDITAL STORY OF THE ACTION OF SHEET 4. 13 REMAKE 6" TYPE A FINAL IN THREE LIFTS PER PER CSS TOD EDITAL STORY OF THE ACTION OF SHEET 4. 14 REMAKENT ON SHEET 4. 15 REMAKE 6" TYPE A FINAL IN THEATMENT ON SHEET 4. 15 REMAKE 6" TYPE A FINAL IN THEATMENT ON SHEET 4. 15 REMAKE 6" TYPE A FINAL IN THEATMENT ON SHEET 4. 15 REMAKE 6" TYPE A FINAL IN THEATMENT ON SHEET 4. 15 REMAKE 6" THICK AC PAVEMENT AND REPLACE WITH 2" TOWN THEATMENT ON SHEET 4. 15 REMAKE 6" THICK AC PAVEMENT AND REPLACE WITH 2" TOWN THEATMENT ON SHEET 4. 15 REMAKE 6" THICK AC PAVEMENT AND REPLACE WITH 2" TOWN THEATMENT ON SHEET 4. 15 REMAKE 6" THICK AC PAVEMENT AND REPLACE WITH 2" TOWN THEATMENT ON SHEET 4. 15 REMAKE 6" THICK AC PAVEMENT AND REPLACE WITH 2" TOWN THEATMENT ON SHEET 4. 15 REMAKE 6" THICK AC PAVEMENT AND REPLACE WITH 2" TOWN THEATMENT ON SHEET 4. 15 REMAKE 6" THICK AC PAVEMENT AND REPLACE WITH 2" TOWN THEATMENT ON SHEET 4. 15 REMAKE 6" THICK AC PAVEMENT AND REPLACE WITH 2" TOWN THEATMENT ON SHEET 4. 15 REMAKE 6" THICK AC PAVEMENT AND REPLACE WITH 2" TOWN THEATMENT ON SHEET 4. 15 REMAKE 6" THICK AC PAVEMENT AND REPLACE WITH 2" TOWN THEATMENT ON SHEET 4. 15 REMAKE 6" THICK AC PAVEMENT AND REPLACE WITH 2" TOWN THEATMENT ON SHEET 4. 15 REMAKE 6" THICK AC PAVEMENT AND REPLACE WITH 2" TOWN THEATMENT ON SHEET 4. 15 REMAKE 6" THICK AC PAVEMENT AND REPLACE WITH 2" TOWN THEATMENT ON SHEET 4. 15 REMAKE 6" THICK AC PAVEMENT AND REPLACE WITH 2" TOWN THEATMENT ON SHEET 4. 15 REMAKE 6" THICK AC PAVEMENT AND REPLACE WITH 2" TOWN THEATMENT ON SHEET 4. 15 REMAKE 6" THICK AC PAVEMENT AND REPLACE WITH 2" TOWN THEATMENT ON SHEET 4. 15 REMAKE 6" THICK AC PAVEMENT AND REPLACE WITH 2" TOWN THEATMENT ON SHEET 4. 15 REMAKE SECMENT LIMIT + + + SLURRY SEAL (TYPE II) EX SANITARY SEWER MANHOLE 2" TYPE A HMA MILL & FILL DEPTH REPLACEMENT [14] REMOVE 6" THICK AC PAVEMENT AND REPLACE WITH 2" RHMA AND 4" TYPE A HMA IN TWO LIFTS PER FULL DEPTH HMA TREATMENT ON SHEET 4. **6** EX STORM DRAIN MANHOLE 3 LOWER MANHOLE PRIOR TO GRINDING WHERE APPLICABLE. ADJUST MANHOLE AND COVER TO FINISHED GRADE PER CSC STD DETAIL DS-5. 9 REFER TO SHEET xx-xx FOR SIGNAL LOOP REPLACEMENT PLANS. 8 EX FIRE HYDRANT [10] REMOVE 6" THICK AC PAVEMENT AND REPLACE WITH 6" TYPE A HMA IN THREE LIFTS PER FULL DEPTH HMA TREATMENT ON SHEET 4. EX WATER VALVE BOX REMOVE AC BASE FAILURE AND REPLACE WITH FULL DEPTH HMA PER DIGOUT DETAIL ON SHEET 4. SEE DIGOUT QUANTITY ON SHEET XX. [15] REMOVE 12" THICK AC PAVEMENT AND REPLACE WITH 2" RHMA AND 10" TYPE A HMA IN FIVE LIFTS PER FULL DEPTH HMA TREATMENT ON SHEET 4. EX RECYCLED WATER VALVE BOX 2° RHMA AND 10° TYPE A HMA III AC DIGOUT FULL DEPTH REPUCEMENT AND REPLACE WITH 6" SERMOVE 4° THICK AC PAVEMENT AND REPLACE WITH 11 TYPE A HMA IN FOUR LIFTS PER FULL DEPTH HMA TREATMENT ON SHEET XX. I REMOVE 8° THICK AC PAVEMENT AND REPLACE WITH 11 TYPE A HMA IN FOUR LIFTS PER FULL DEPTH HMA TREATMENT ON SHEET 4. EX MONUMENT IN ROUND BOX EX MONUMENT IN SQUARE BOX CE xx-xx-xx APPROVED BY CITY OF SANTA CLARA EX SVP MANHOLE ACCOUNT No DATE No. REVISION SVP EX SVP VAULT BOX 2026 ANNUAL STREET MAINTENANCE INITIAL DATE AND REHABILITATION PROJECT DESIGNED BY DS xx/xx/25 RACING NO Know what's below. Call before you dig. DRAWN BY HM xx/xx/25 SEE GENERAL NOTES PAVEMENT IMPROVEMENT CHECKED BY MF xx/xx/25 ON SHEET 3 PLAN


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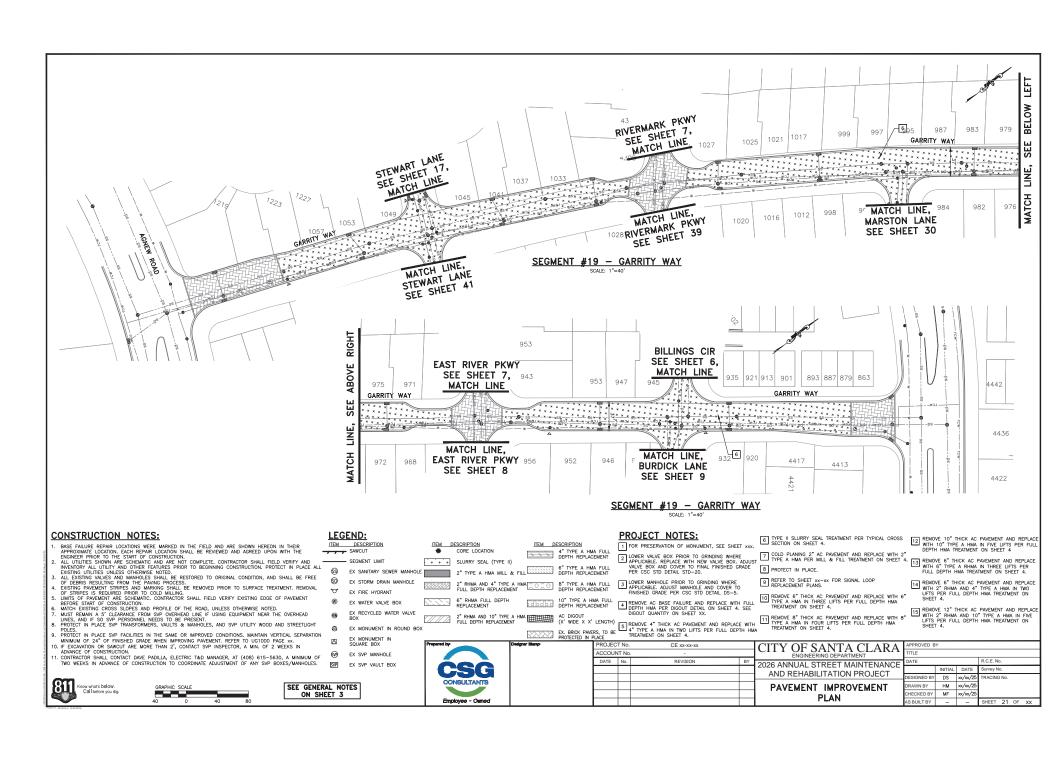


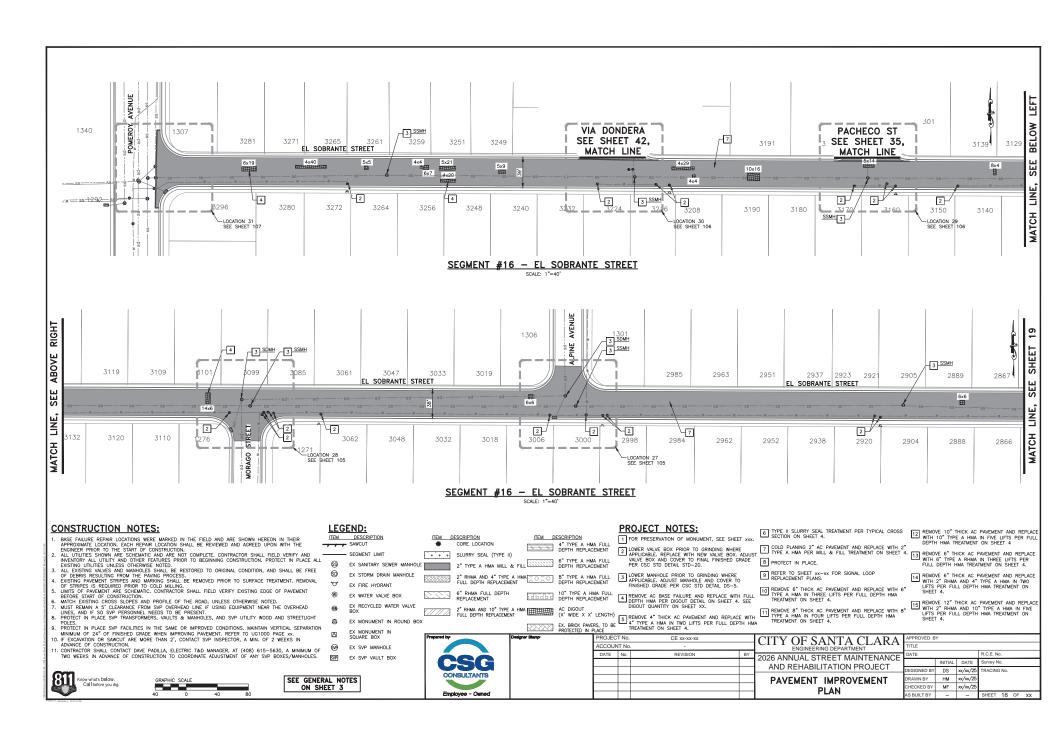


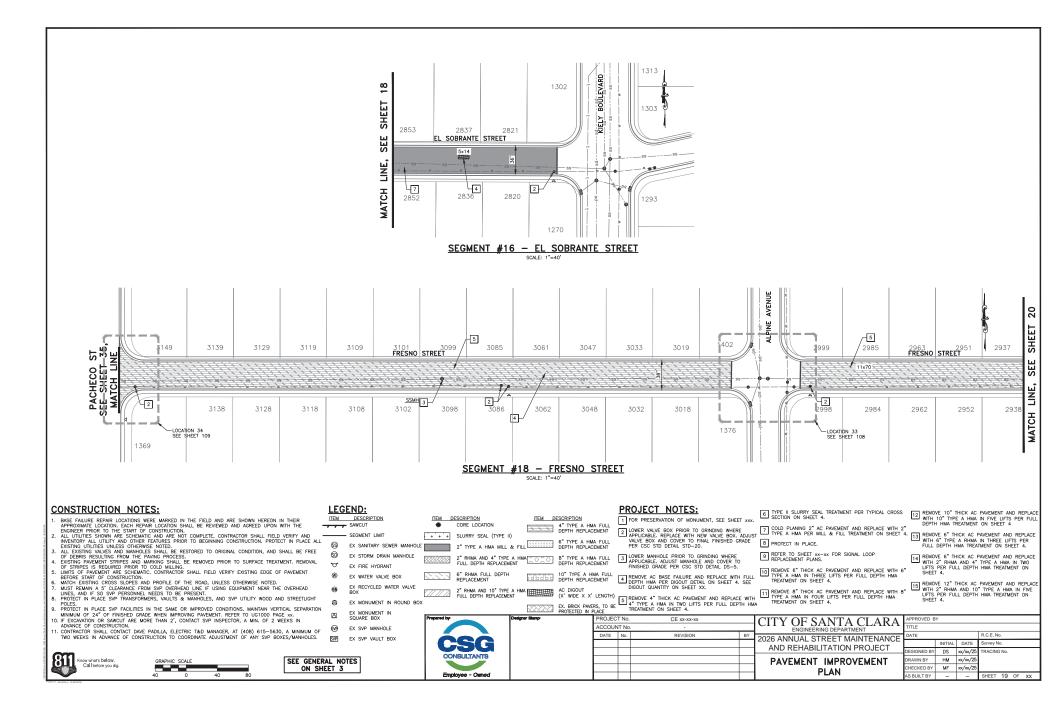


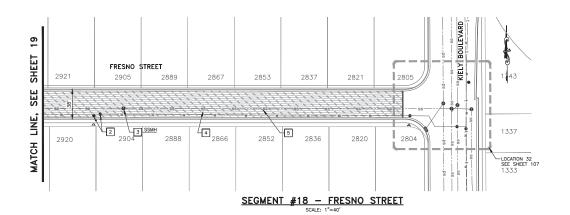

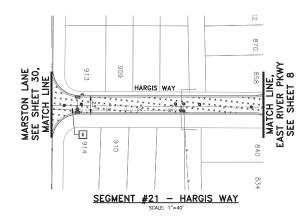


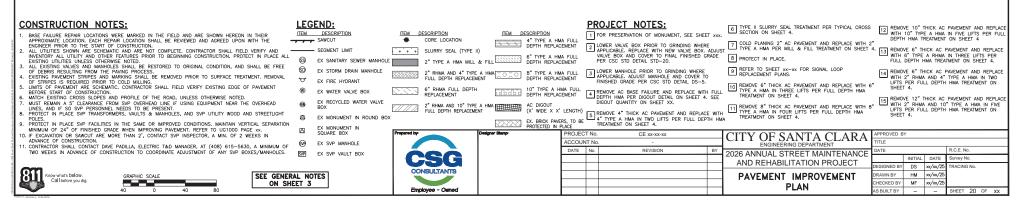


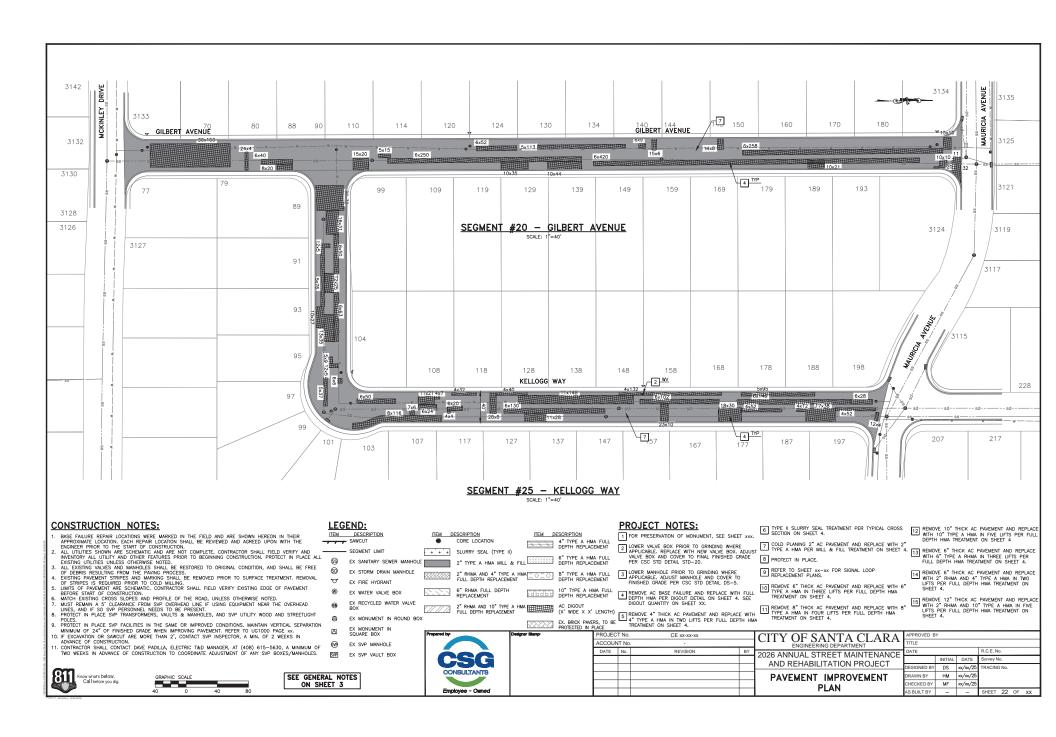


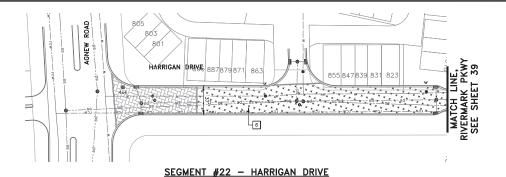


SCALE: 1"=40"

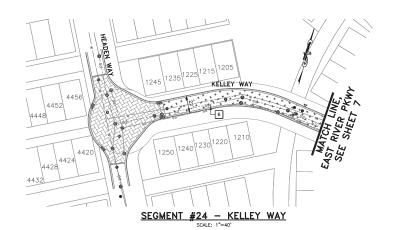


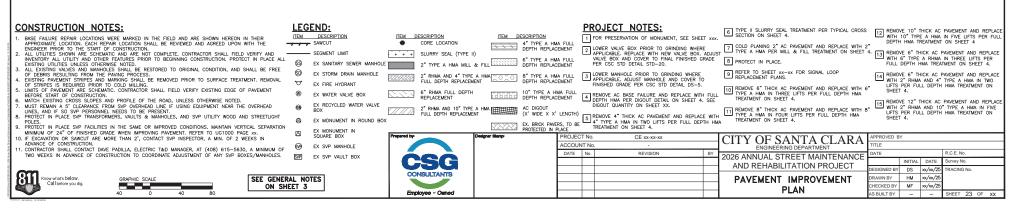


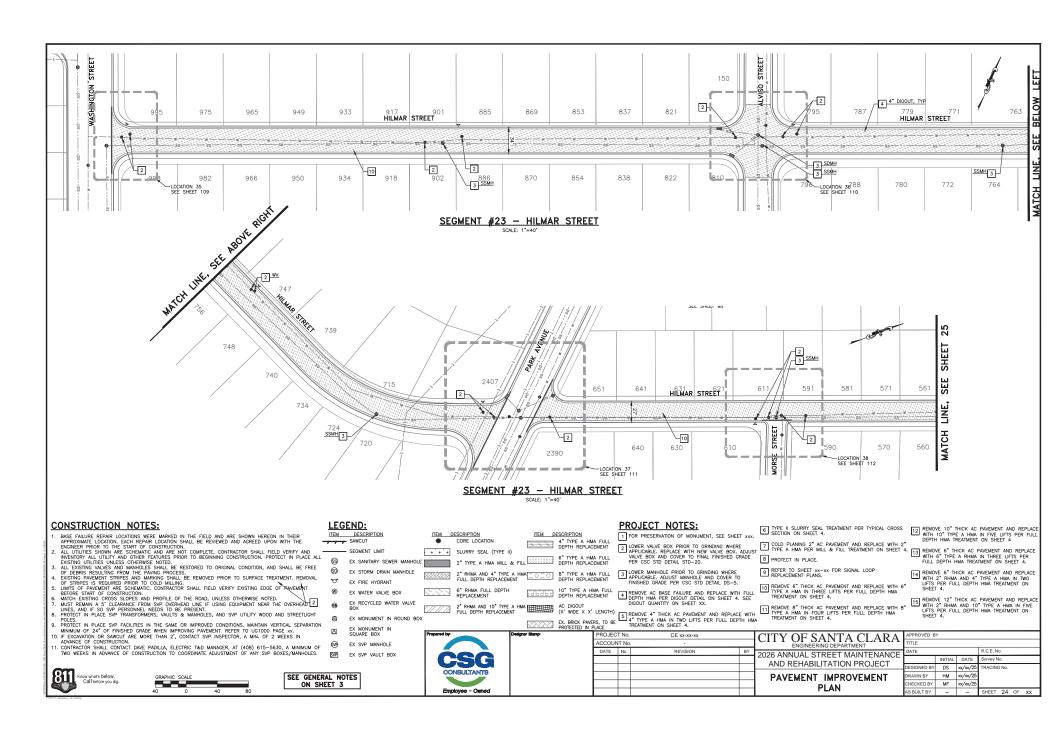


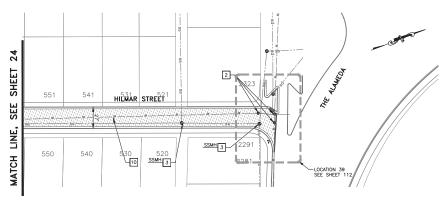


# SEGMENT #23 - HILMAR STREET SCALE: 1"=40"

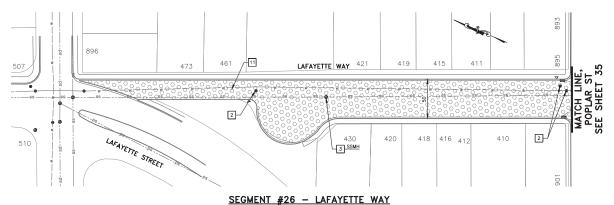


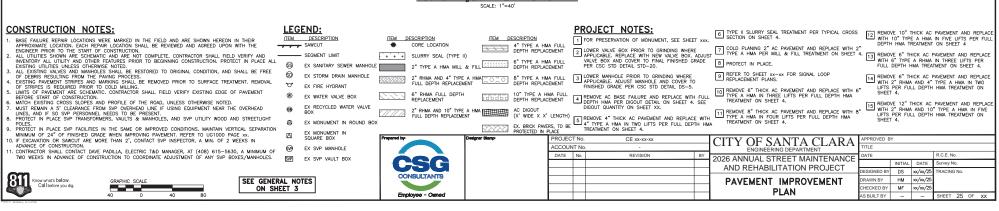


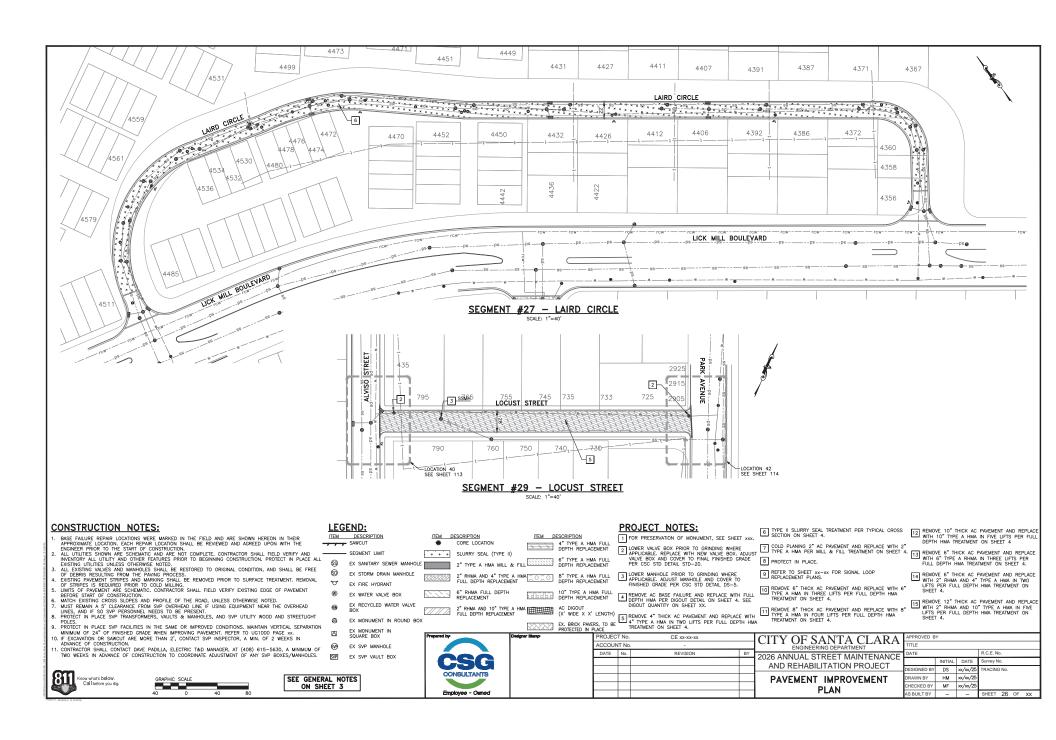


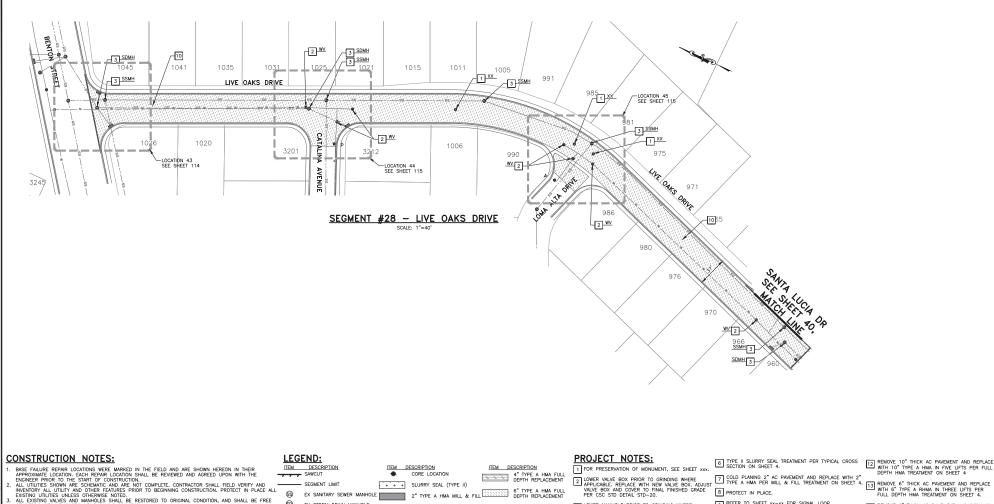





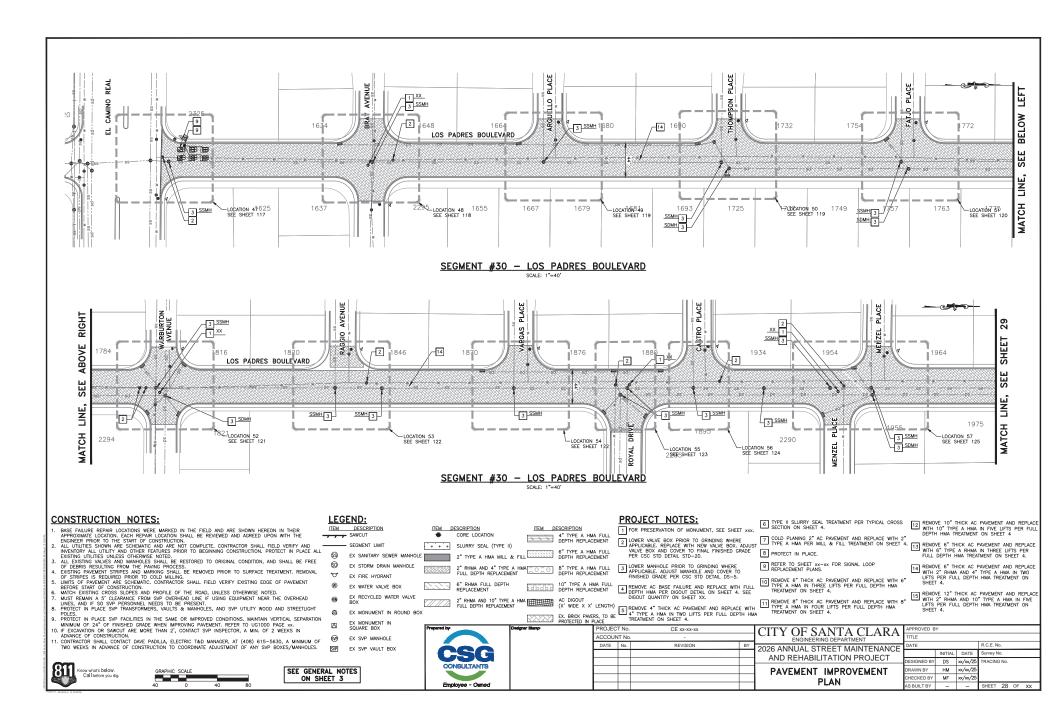


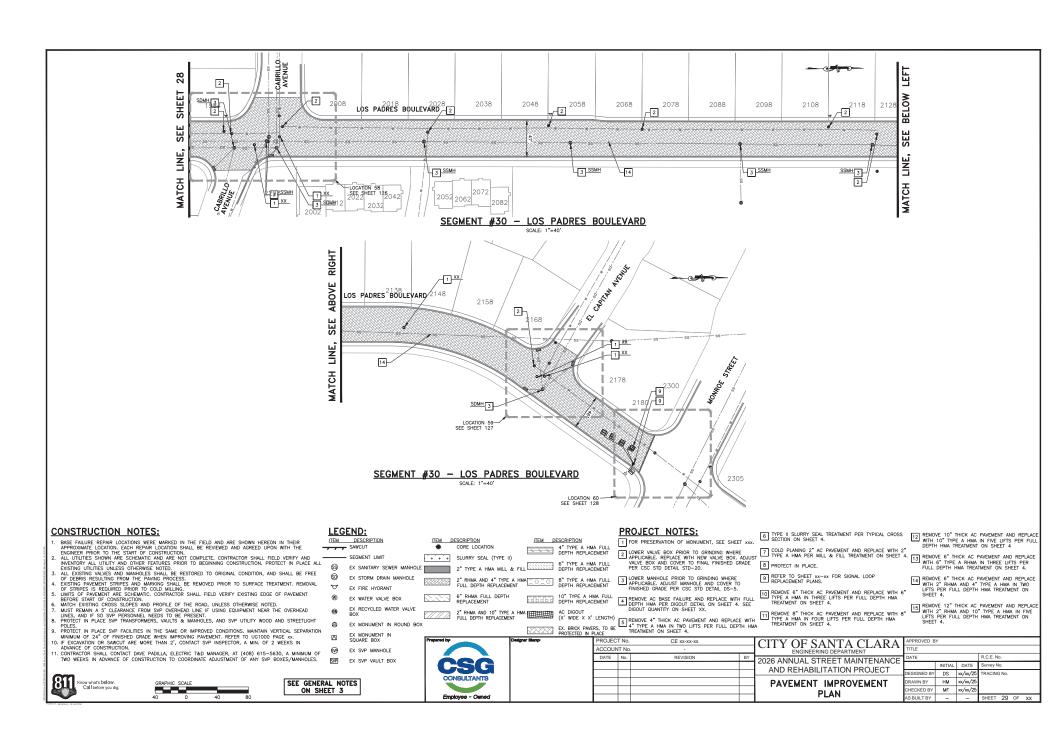


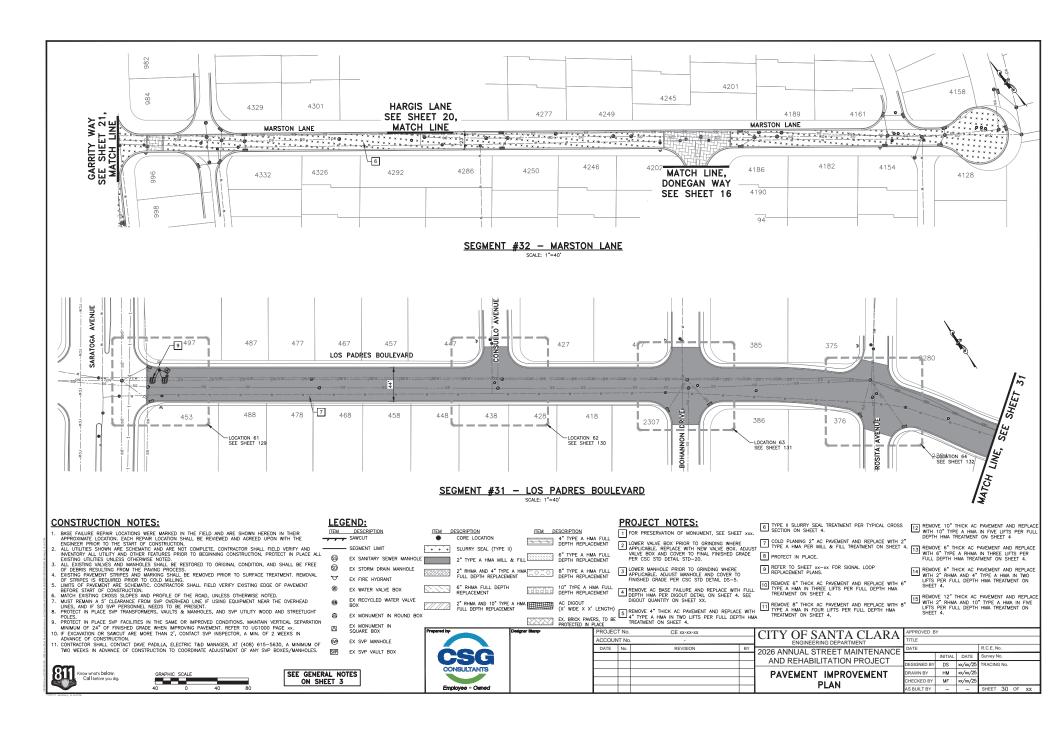


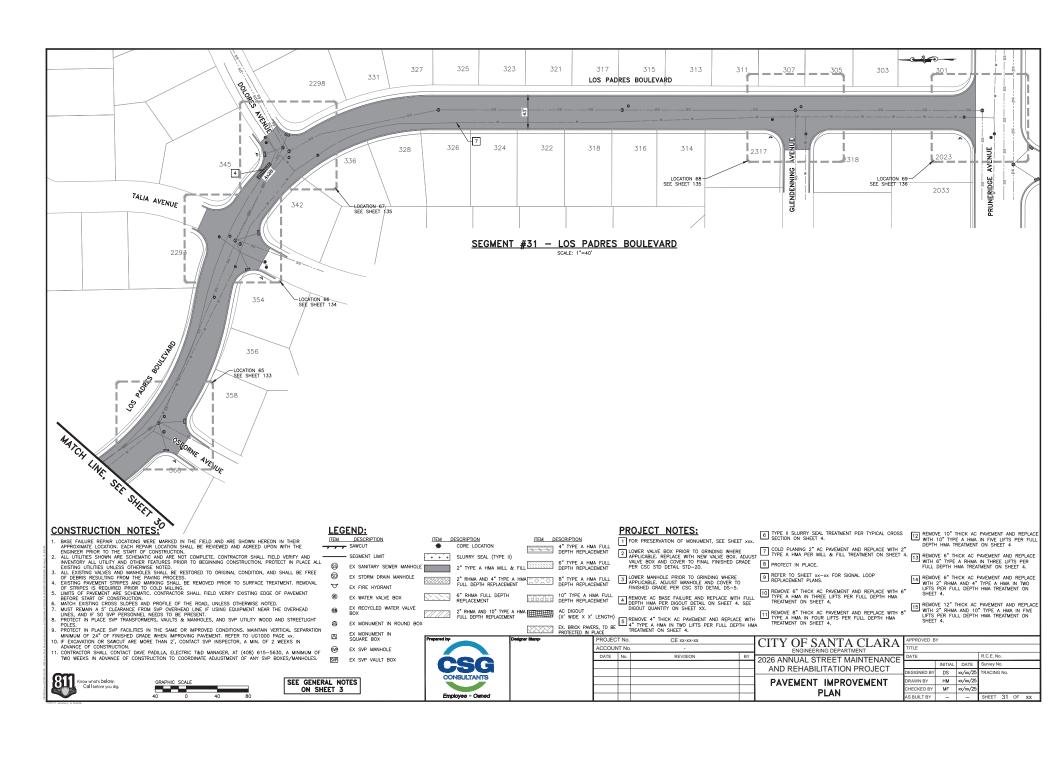


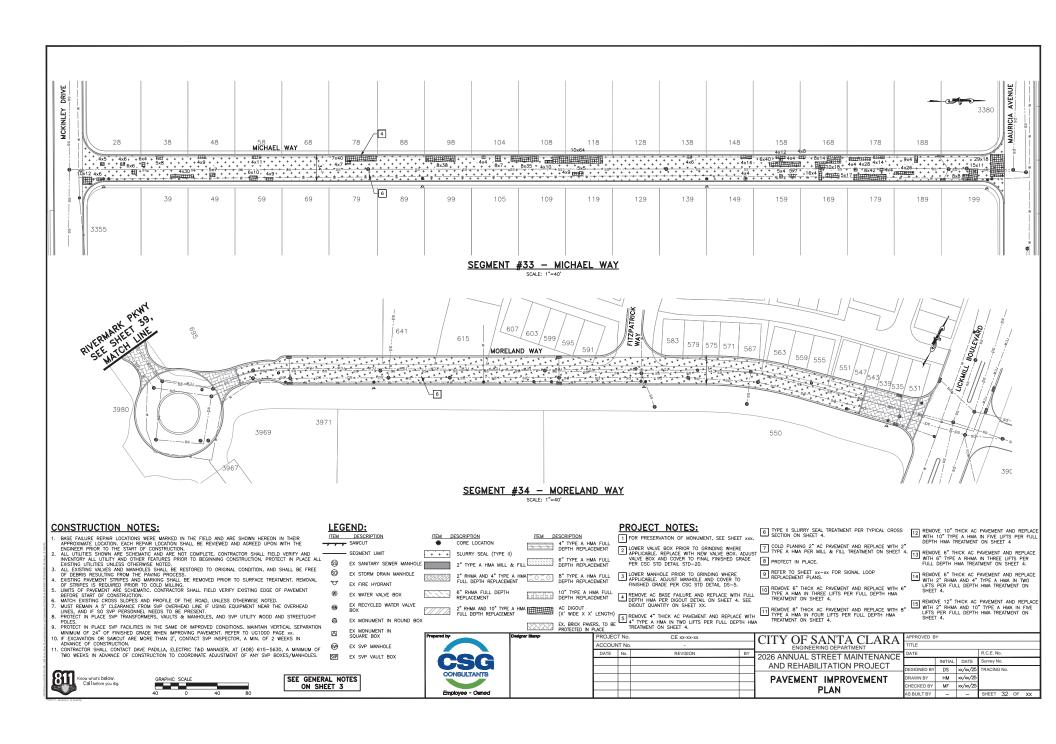


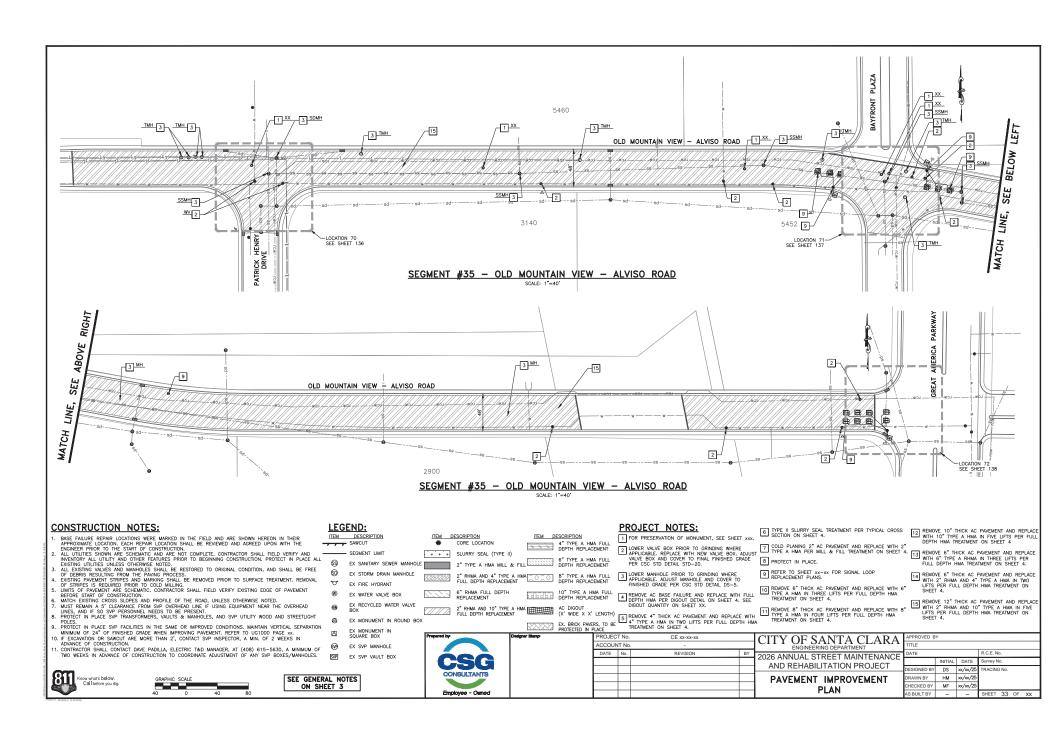


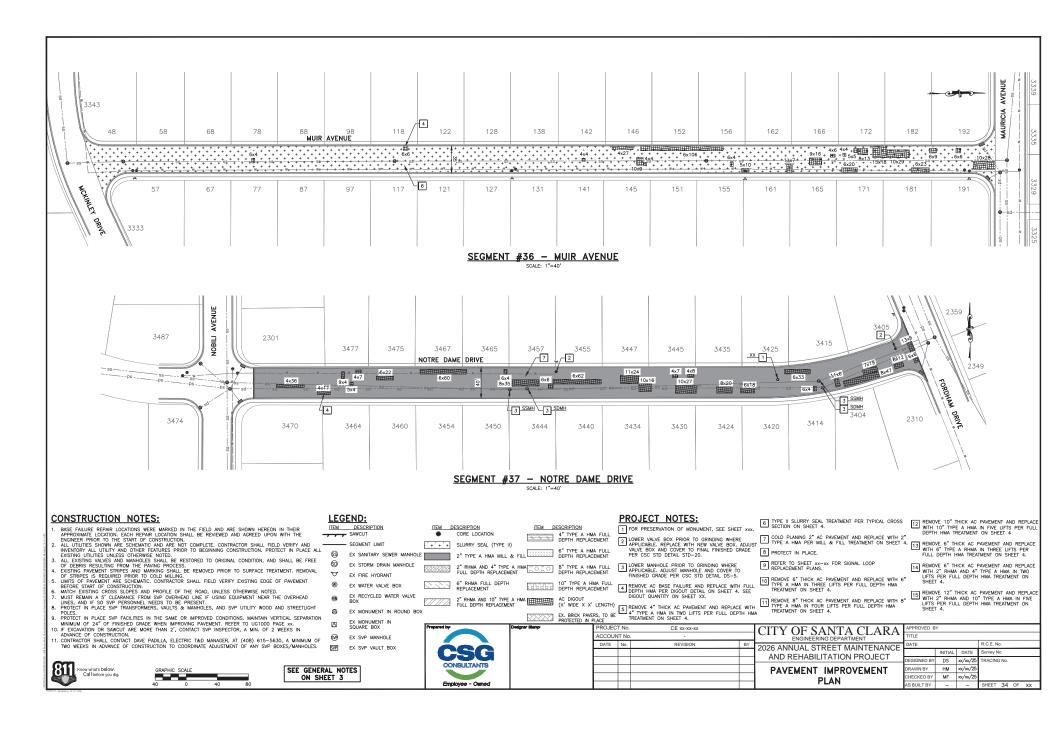

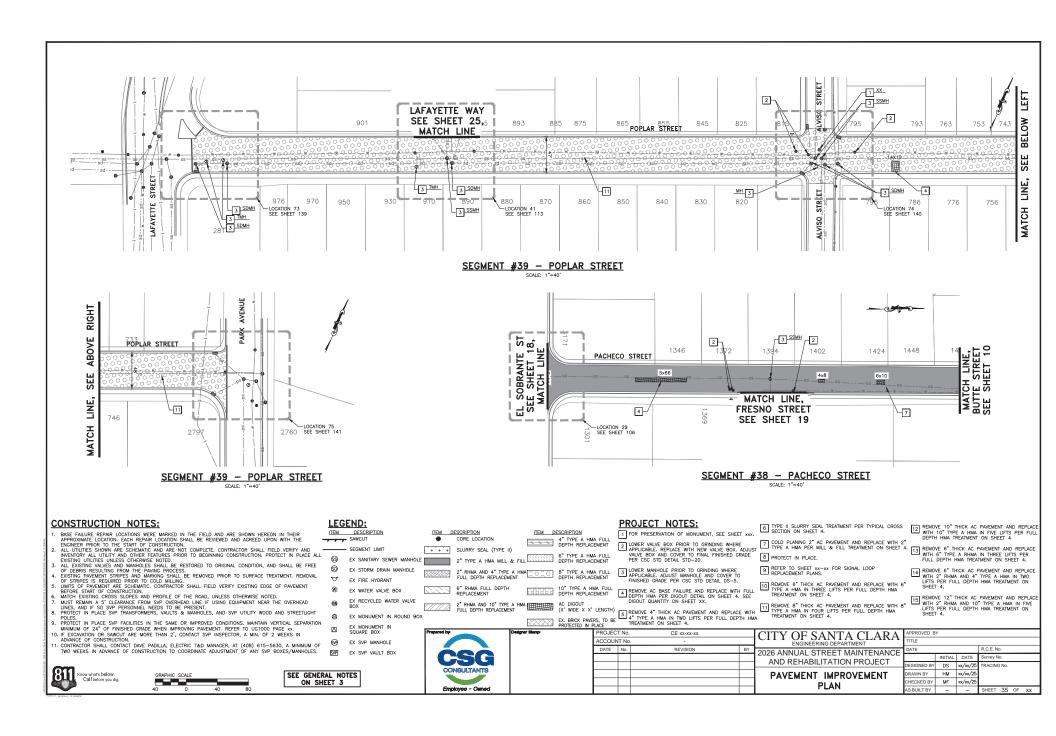


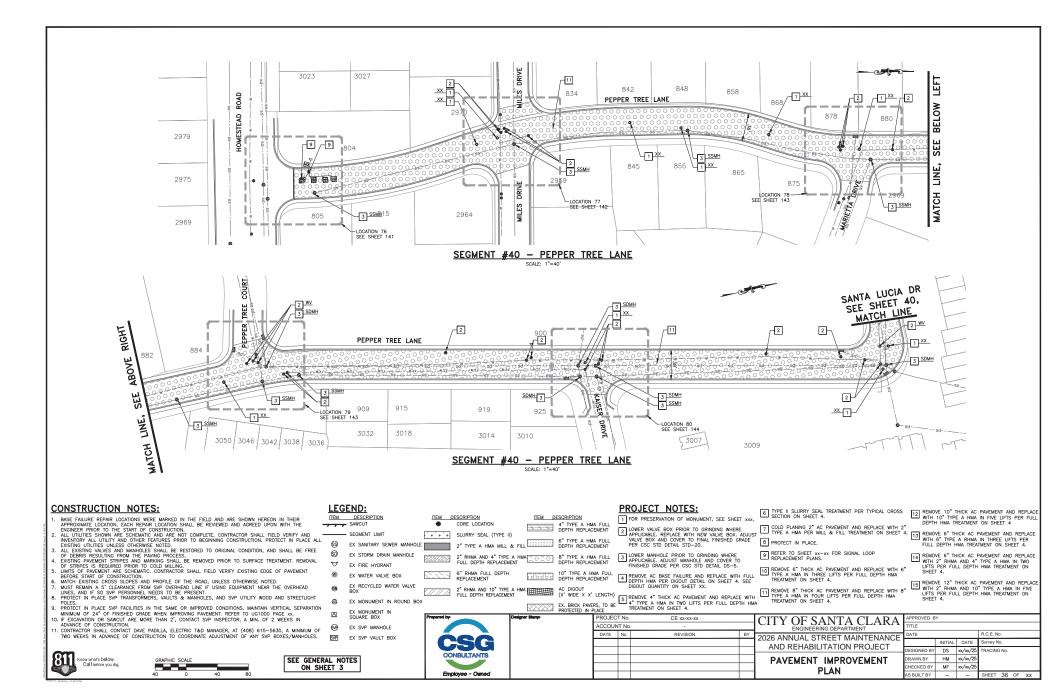

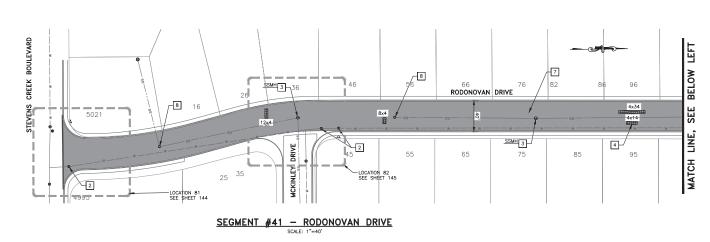

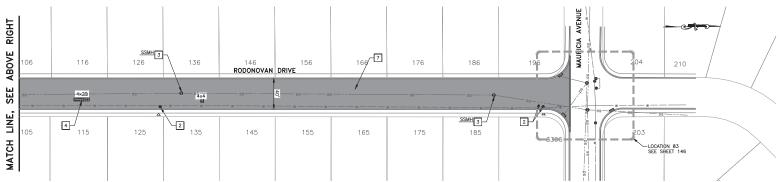


# SEGMENT #41 - RODONOVAN DRIVE SCALE: 1"=40"

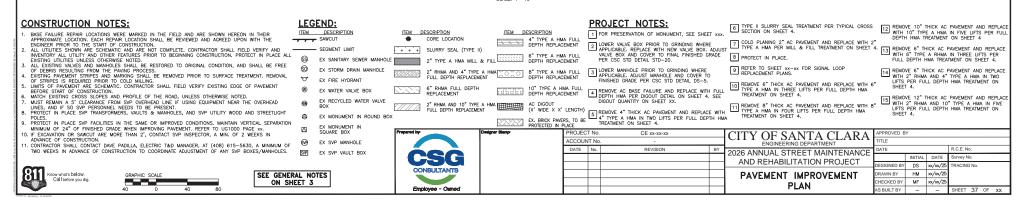






SEGMENT #42 - REGIS COURT

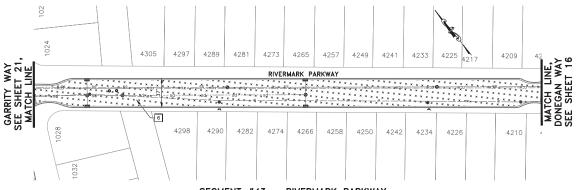


#### SEGMENT #43 - RIVERMARK PARKWAY **CONSTRUCTION NOTES: LEGEND: PROJECT NOTES:** CONSTRUCTION NOTES: 1. BASE PULLURE REPAIR LOCATIONS BERE MANKED IN THE FIELD AND ARE SHOWN HEREON IN THEIR PARKED PRICE OF THE START POPEL MONTHS HERE AND AGREED UPON WITH THE PROPERTY OF CONSTRUCTION. 2. ALL UTILITIES SHOWN ARE SCHEMATIC AND ARE NOT COMPLETE. CONTRACTOR SHALL RELD VERIFY AND MENETION FLUID UPON THE PERMITSE PRIOR TO BEGINNING CONSTRUCTION. PROFICE TO PLACE ALL SYSTING UTILITIES UNLESS OTHERWISE NOTED. 2. STING UTILITIES UNLESS OTHERWISE NOTED. SECTORED TO ORIGINAL CONDITION, AND SHALL BE FREE OF DEBIES RESULTING FROM THE PAWNS PROFICES. 4. EXISTING PAYEMENT STRIPES AND MARKING SHALL BE REMOVED PRIOR TO SURFACE TREATMENT. REMOVAL OF STRIPES IS REQUIRED PRIOR TO COLD MILLION. 5. IMITIS OF PAYEMENT ARE SCHEMATIC. CONTRACTOR SHALL FIELD VERIFY EXISTING EDGS OF PAYEMENT 6. MACHE EXISTING CROSS SLOPES AND PROFILE OF THE ROAD, UNLESS OTHERWISE NOTED. 7. MUST REMAIN A 5' CLEARANCE FROM SYP OVERHEAD LINE IF USING EQUIPMENT NEAR THE OVERHEAD LINES, AND IS SO SYP PERSONNEL NEEDS TO BE PRESENT. 8. PROTECT IN PLACE SYP TRANSFORMERS, VAULTS & MANHOLES, AND SYP UTILITY WOOD AND STREETLIGHT OF MINIMUM OF 24' OF FINISHED GRADE WHEN IMPROVING PAYEMENT. REFER TO UGIOOD PAGE XX. 10. IF EXCANATION OF SAMOUT ARE MORE THAN 2', CONTACT SYP INSPECTOR, AND, OF 2 SYP TRANSFORMERS, VAULTS & MANHOLES, AND SYP INSTITUTE OF ANN. OF 2 WEEKS IN ADVANCE OF CONSTRUCTION TO COORDINATE ADJUSTMENT OF ANY SYP BOXES/MANHOLES. 6 TYPE II SLURRY SEAL TREATMENT PER TYPICAL CROSS SECTION ON SHEET 4. [12] REMOVE 10" THICK AC PAVEMENT AND REPLACE WITH 10" TYPE A HMA IN FIVE LIFTS PER FULL DEPTH HMA TREATMENT ON SHEET 4 ITEM DESCRIPTION ITEM DESCRIPTION ITEM DESCRIPTION 1 FOR PRESERVATION OF MONUMENT, SEE SHEET xxx. COLD PLANNING 2" AC PRIMEMENT AND REPLACE WITH 2" TO THE A HMA PER MILL & FILL TREATMENT ON SHEET 4. THE A HMA PER MILL & FILL TREATMENT ON SHEET 4. THE A HMA PER MILL & FILL TREATMENT ON SHEET 4. THE A HMA PER MILL & FILL TREATMENT ON SHEET 4. CORE LOCATION 4" TYPE A HMA FULL DEPTH REPLACEMENT 2 LOWER VALVE BOX PRIOR TO GRINDING WHERE APPLICABLE. REPLACE WITH NEW VALVE BOX. ADJUS VALVE BOX AND COVER TO FINAL FINISHED GRADE PER CSC STD DETAIL STD-20. SEGMENT LIMIT SLURRY SEAL (TYPE II) 2" TYPE A HMA MILL & FILL DEPTH REPLACEMENT EX SANITARY SEWER MANHOLI 9 REFER TO SHEET xx-xx FOR SIGNAL LOOP REPLACEMENT PLANS. [14] REMOVE 6" THICK AC PAVEMENT AND REPLACE WITH 2" RHMA AND 4" TYPE A HMA IN TWO LIFTS PER FULL DEPTH HMA TREATMENT ON SHEET 4. **6** EX STORM DRAIN MANHOLE 3 LOWER MANHOLE PRIOR TO GRINDING WHERE APPLICABLE. ADJUST MANHOLE AND COVER TO FINISHED GRADE PER CSC STD DETAIL DS-5. \*\* EX FIRE HYDRANT [10] REMOVE 6" THICK AC PAVEMENT AND REPLACE WITH 6" TYPE A HMA IN THREE LIFTS PER FULL DEPTH HMA TREATMENT ON SHEET 4. 10" TYPE A HMA FULI DEPTH REPLACEMENT EX WATER VALVE BOX REMOVE AC BASE FAILURE AND REPLACE WITH FULL DEPTH HMA PER DIGOUT DETAIL ON SHEET 4. SEE DIGOUT QUANTITY ON SHEET XX. [15] REMOVE 12" THICK AC PAVEMENT AND REPLACE WITH 2" RHMA AND 10" TYPE A HMA IN FIVE LIFTS PER FULL DEPTH HMA TREATMENT ON SHEET 4. EX RECYCLED WATER VALVE BOX 11 REMOVE 8" THICK AC PAVEMENT AND REPLACE WITH 8" TYPE A HMA IN FOUR LIFTS PER FULL DEPTH HMA TREATMENT ON SHEET 4. ຝ EX MONUMENT IN ROUND BOX EX MONUMENT IN SQUARE BOX CE xx-xx-xx APPROVED BY CITY OF SANTA CLARA **⊕** EX SVP MANHOLE ACCOUNT No DATE No. REVISION SVP EX SVP VAULT BOX 2026 ANNUAL STREET MAINTENANCE INITIAL DATE AND REHABILITATION PROJECT ESIGNED BY DS xx/xx/25 RACING No DRAWN BY HM xx/xx/25 Know what's below. Call before you dig. SEE GENERAL NOTES PAVEMENT IMPROVEMENT CHECKED BY MF xx/xx/25 ON SHEET 3 PLAN AS BUILT BY

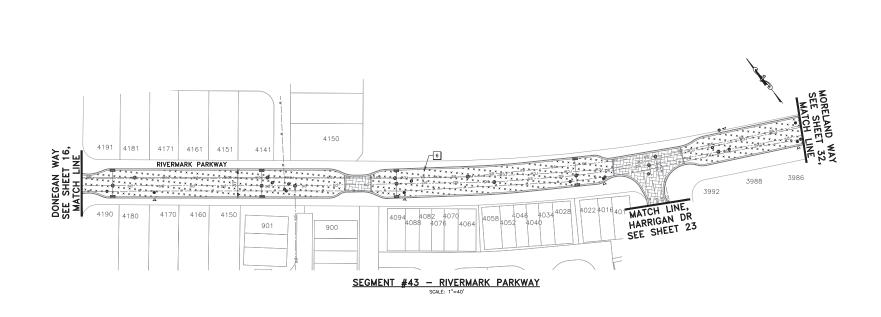

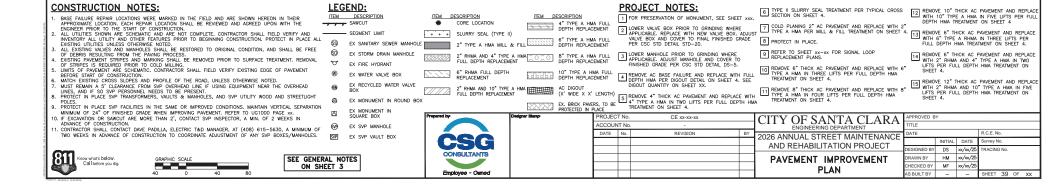

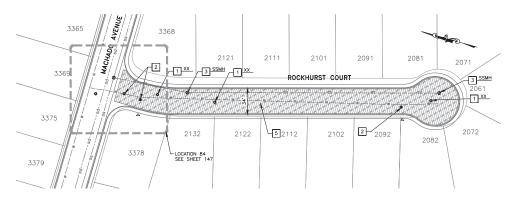



## SEGMENT #44 - ROCKHURST COURT

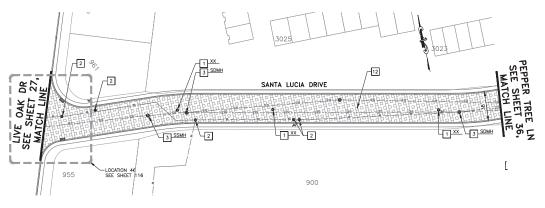



### SEGMENT #45 - SANTA LUCIA DRIVE




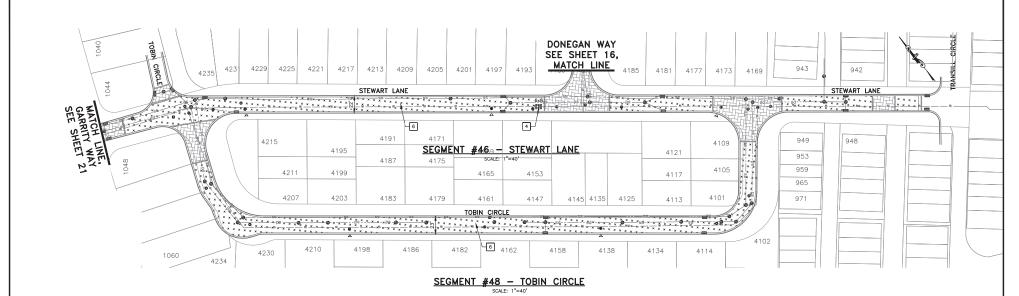

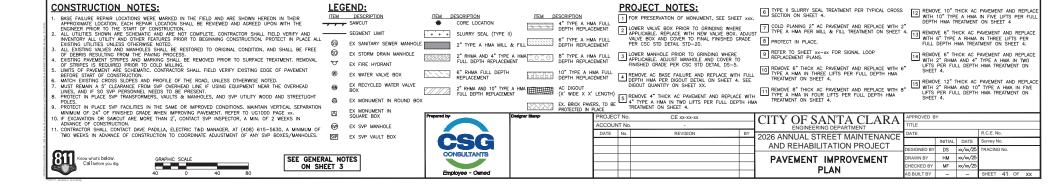

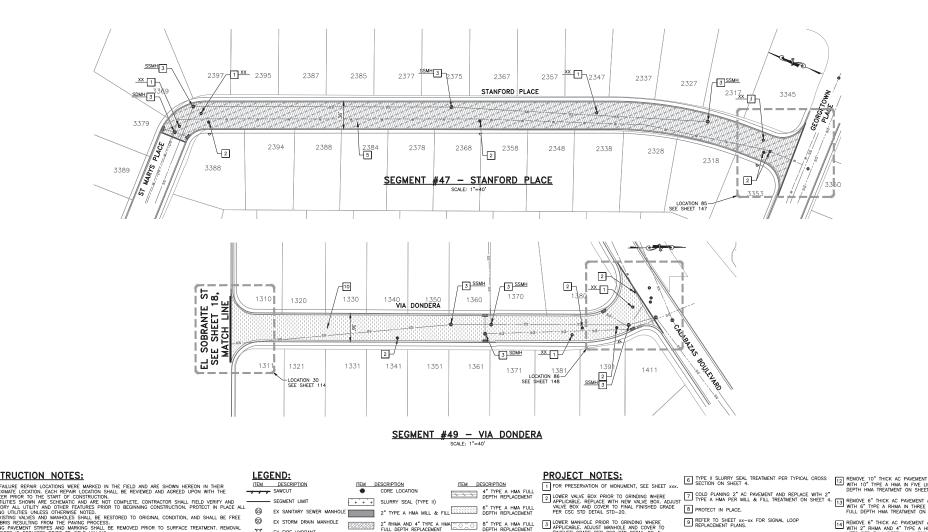


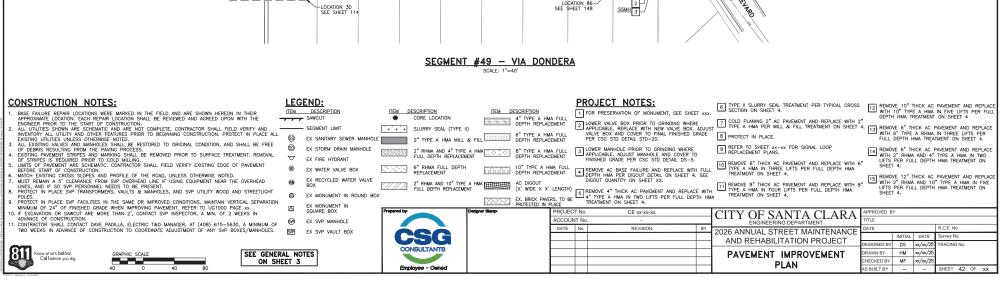

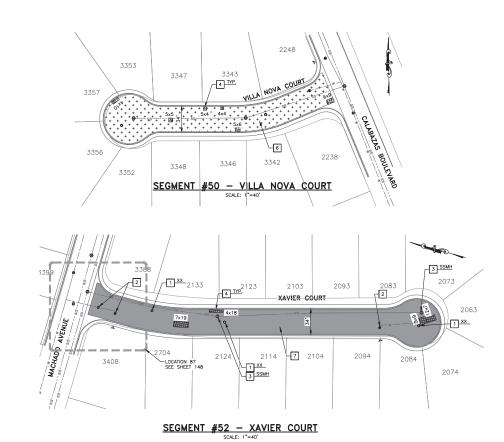

ITEM DESCRIPTION

10" TYPE A HMA FUL DEPTH REPLACEMENT

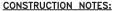

- CONSTRUCTION NOTES:

  1. BASE PULLURE REPAIR LOCATIONS BERE MANKED IN THE FIELD AND ARE SHOWN HEREON IN THEIR PROPERTY OF THE P



SEE GENERAL NOTES

**LEGEND:** 

**6** 

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SVP

ITEM DESCRIPTION

SECMENT LIMIT

EX FIRE HYDRANT

EX SVP MANHOLE

EX SVP VAULT BOX

EX WATER VALVE BOX

EX SANITARY SEWER MANHOLI

EX STORM DRAIN MANHOLE

EX RECYCLED WATER VALVE BOX

EX MONUMENT IN ROUND BOX EX MONUMENT IN SQUARE BOX

### **PROJECT NOTES:**

- 1 FOR PRESERVATION OF MONUMENT, SEE SHEET xxx. 4" TYPE A HMA FULL DEPTH REPLACEMENT
  - 2 LOWER VALVE BOX PRIOR TO GRINDING WHERE APPLICABLE. REPLACE WITH NEW VALVE BOX. ADJUS VALVE BOX AND COVER TO FINAL FINISHED GRADE PER CSC STD DETAIL STD-20.
  - 3 LOWER MANHOLE PRIOR TO GRINDING WHERE APPLICABLE. ADJUST MANHOLE AND COVER TO FINISHED GRADE PER CSC STD DETAIL DS-5.
  - REMOVE AC BASE FAILURE AND REPLACE WITH FULL DEPTH HMA PER DIGOUT DETAIL ON SHEET 4. SEE DIGOUT QUANTITY ON SHEET XX.
- CE xx-xx-xx
- 6 TYPE II SLURRY SEAL TREATMENT PER TYPICAL CROSS SECTION ON SHEET 4.
- COLD PLANNING 2" AC PRIMEMENT AND REPLACE WITH 2"

  TO THE A HMA PER MILL & FILL TREATMENT ON SHEET 4.

  THE A HMA PER MILL & FILL TREATMENT ON SHEET 4.

  THE A HMA PER MILL & FILL TREATMENT ON SHEET 4.

  THE A HMA PER MILL & FILL TREATMENT ON SHEET 4.
- 9 REFER TO SHEET xx-xx FOR SIGNAL LOOP REPLACEMENT PLANS.
- [10] REMOVE 6" THICK AC PAVEMENT AND REPLACE WITH 6" TYPE A HIMA IN THREE LIFTS PER FULL DEPTH HIMA TREATMENT ON SHEET 4.
- THE A HMA IN FOUR LIFTS PER FULL DEPTH HMA
  TREATMENT ON SHEET 4.

PLAN

- 12 REMOVE 10" THICK AC PAVEMENT AND REPLACE WITH 10" TYPE A HMA IN FIVE LIFTS PER FULL DEPTH HMA TREATMENT ON SHEET 4
- [14] REMOVE 6" THICK AC PAVEMENT AND REPLACE WITH 2" RHMA AND 4" TYPE A HMA IN TWO LIFTS PER FULL DEPTH HMA TREATMENT ON SHEET 4.
- [15] REMOVE 12" THICK AC PAVEMENT AND REPLACE WITH 2" RHMA AND 10" TYPE A HMA IN FIVE LIFTS PER FULL DEPTH HMA TREATMENT ON SHEET 4.

SHEET 43 OF XX



AS BUILT BY



ITEM DESCRIPTION

CORE LOCATION

SLURRY SEAL (TYPE II)


2" TYPE A HMA MILL & FILL

ACCOUNT No DATE No. REVISION


Know what's below. Call before you dig.




ON SHEET 3

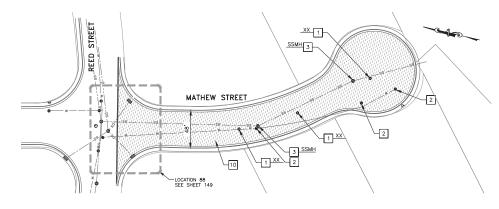



SEGMENT #53 - MATHEW STREET

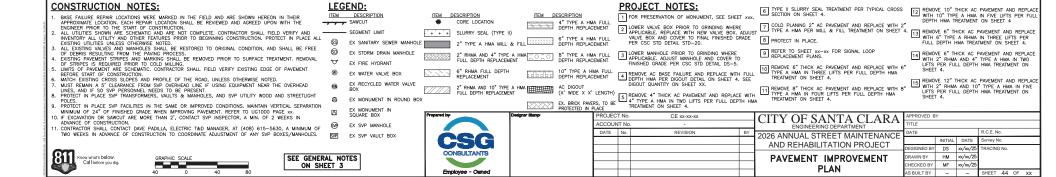


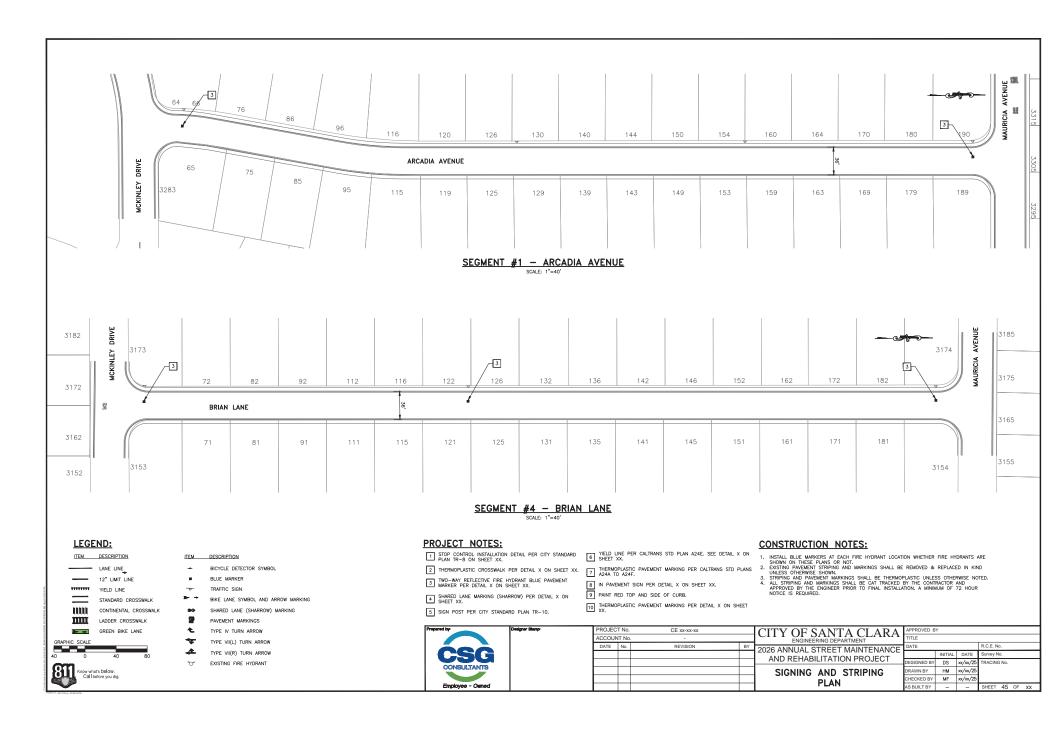




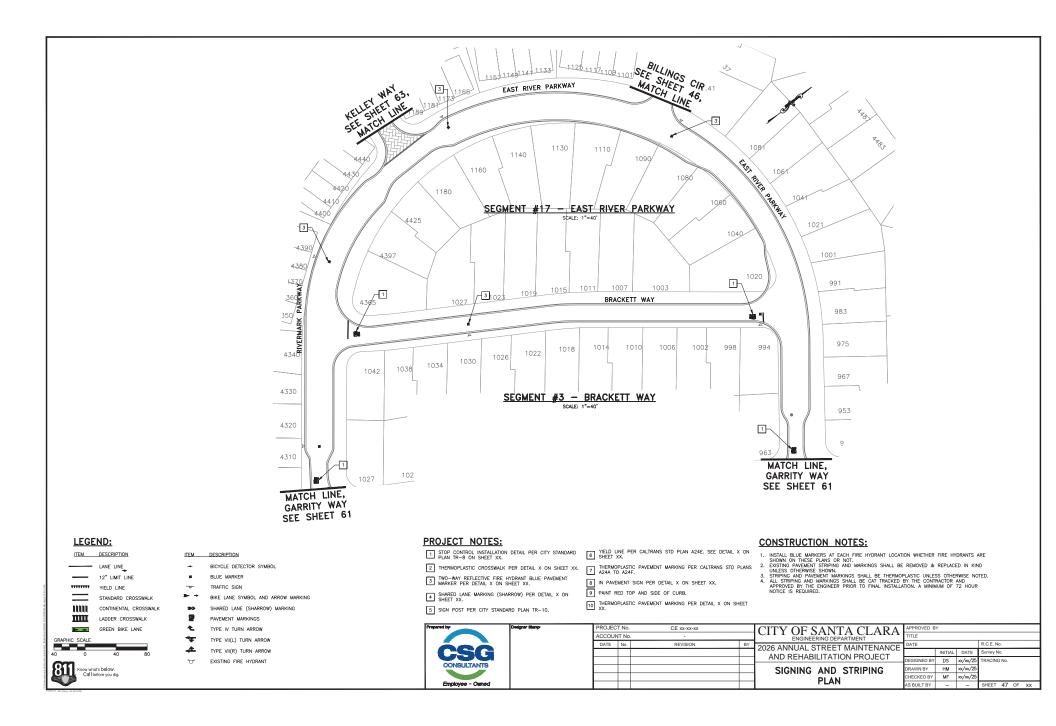

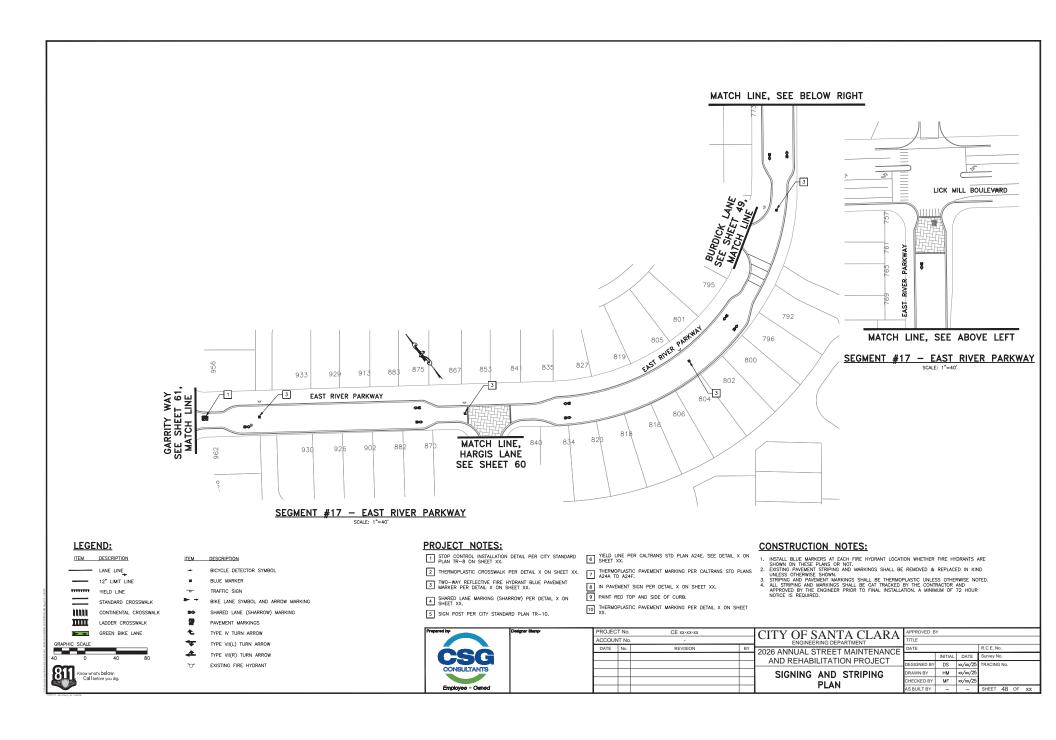

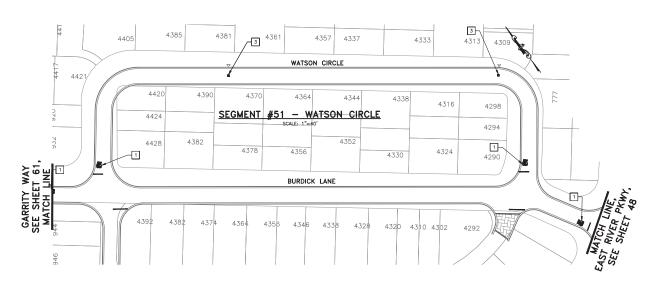



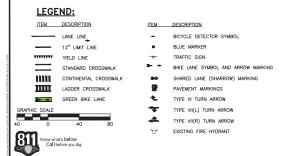



### **PROJECT NOTES:**


- TWO-WAY REFLECTIVE FIRE HYDRANT BLUE PAVEMENT MARKER PER DETAIL X ON SHEET XX.
- 4 SHARED LANE MARKING (SHARROW) PER DETAIL X ON SHEET XX.
- 5 SIGN POST PER CITY STANDARD PLAN TR-10.
- 1 STOP CONTROL INSTALLATION DETAIL PER CITY STANDARD 6 SHEET XX. 6 SHEET XX.
- 2 THERMOPLASTIC CROSSWALK PER DETAIL X ON SHEET XX. 7 THERMOPLASTIC PAVEMENT MARKING PER CALTRANS STD PLANS A24A TO A24F.
  - 8 IN PAVEMENT SIGN PER DETAIL X ON SHEET XX.
  - 9 PAINT RED TOP AND SIDE OF CURB.
  - 10 THERMOPLASTIC PAVEMENT MARKING PER DETAIL X ON SHEET XX.

- INSTALL BLUE MARKERS AT EACH FIRE HYDRANT LOCATION WHETHER FIRE HYDRANTS ARE SHOWN ON THESE PLANS OR NOT.
   ENSITING PAURZENT STRIPING AND MARKINGS SHALL BE REMOVED & REPLACED IN KIND ENSITEMATE AND PAURZENT MARKINGS SHALL BE THERMOPLASTIC UNLESS OTHERWISE NOTED.
   ALL STRIPING AND MARKINGS SHALL BE CAT TRACKED BY THE CONTRACTOR AND APPROVED BY THE ENGINEER PRIOR TO FINAL INSTALLATION. A MINIMUM OF 72 HOUR NOTICE IS REQUIRED.

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ed by Deelgner Blemp	PROJEC	CT No.	CE xx-xx-xx		CITY OF SANTA CLARA	APPROVED E	Υ		
	ACCOU	NT No			ENGINEERING DEPARTMENT	TITLE			
	DATE	No.	REVISION	BY	2026 ANNUAL STREET MAINTENANCE	DATE			R.C.E. No.
					AND REHABILITATION PROJECT		INITIAL	DATE	Survey No.
CONSULTANTS					AND KEHABIEHATION FROJECT	DESIGNED BY	DS	xx/xx/25	TRACING No.
CONSOLIANIS					SIGNING AND STRIPING	DRAWN BY	HM	xx/xx/25	
					PLAN	CHECKED BY	MF	xx/xx/25	
Employee - Owned					I LAN	AS BUILT BY	-	-	SHEET 49 OF XX

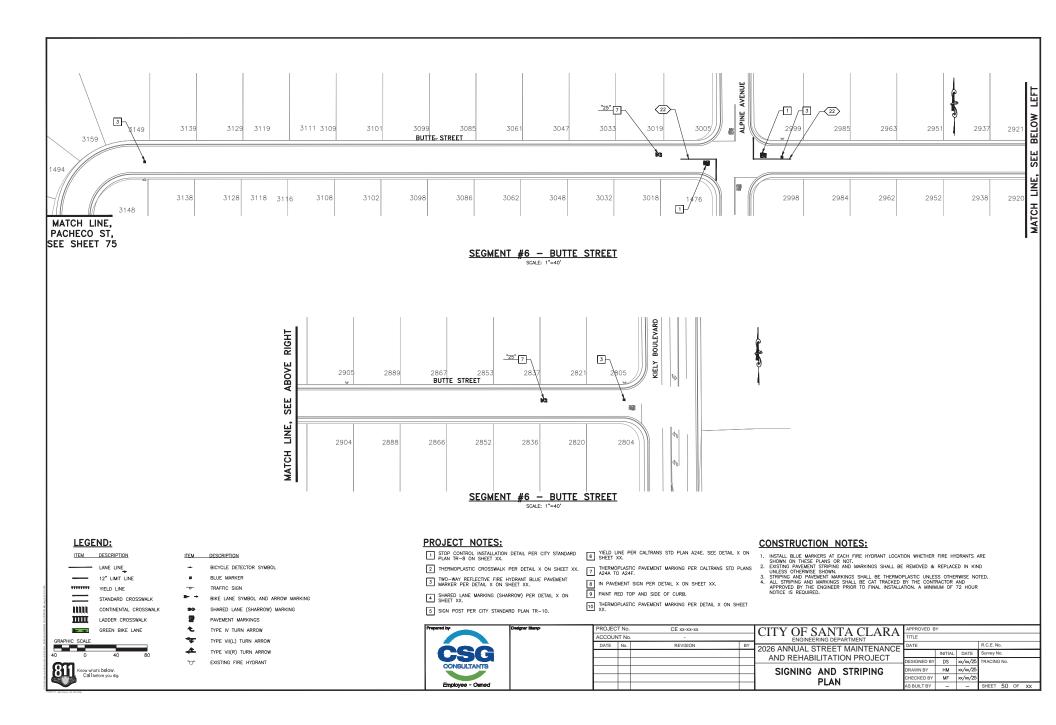

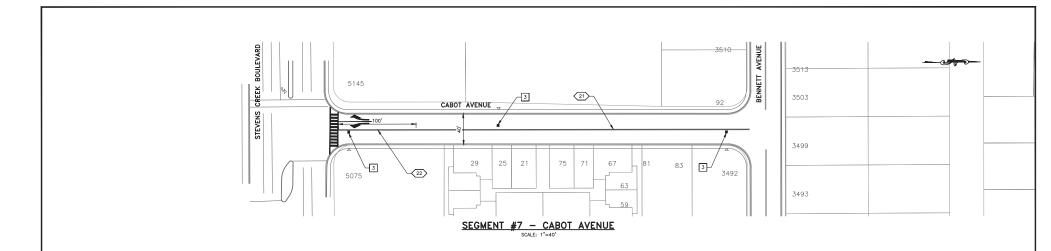

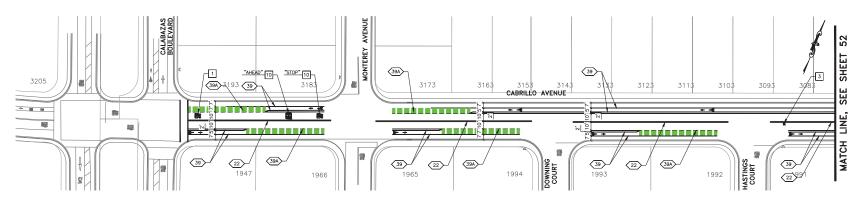

### SEGMENT #8 - CABRILLO AVENUE SCALE: 1"=40"

#### ITEM DESCRIPTION ITEM DESCRIPTION BICYCLE DETECTOR SYMBOL 12" LIMIT LINE BLUE MARKER \*\*\*\*\*\* YIELD LINE TRAFFIC SIGN STANDARD CROSSWALK BIKE LANE SYMBOL AND ARROW MARKING 11111 CONTINENTAL CROSSWALK SHARED LANE (SHARROW) MARKING ш LADDER CROSSWALK PAVEMENT MARKINGS **2** + GREEN BIKE LANE TYPE IV TURN ARROW GRAPHIC SCALE TYPE VII(L) TURN ARROW TYPE VII(R) TURN ARROW EXISTING FIRE HYDRANT Know what's below. Call before you dig.


LEGEND:


#### RECONSTRUCTION


## **PROJECT NOTES:**


- STOP CONTROL INSTALLATION DETAIL PER CITY STANDARD PLAN TR-8 ON SHEET XX.
- $\ensuremath{\mathbb{Z}}$  THERMOPLASTIC CROSSWALK PER DETAIL X ON SHEET XX.
- TWO-WAY REFLECTIVE FIRE HYDRANT BLUE PAVEMENT MARKER PER DETAIL X ON SHEET XX.
- SHARED LANE MARKING (SHARROW) PER DETAIL X ON SHEET XX.
- 5 SIGN POST PER CITY STANDARD PLAN TR-10.
- YIELD LINE PER CALTRANS STD PLAN A24E. SEE DETAIL X ON SHEET XX.
- 7 THERMOPLASTIC PAVEMENT MARKING PER CALTRANS STD PLANS A24A TO A24F.
- 8 IN PAVEMENT SIGN PER DETAIL X ON SHEET XX.
- 9 PAINT RED TOP AND SIDE OF CURB.
- $\fbox{10}$  THERMOPLASTIC PAVEMENT MARKING PER DETAIL X ON SHEET XX.


- INSTALL BLUE MARKERS AT EACH FIRE HYDRANT LOCATION WHETHER FIRE HYDRANTS ARE SHOWN ON THESE PLANS OR NOT.
   EXISTING PREMENT STRIPMS AND MARKINGS SHALL BE REMOVED & REPLACED IN KIND STRIPMS AND PAWELETT MARKINGS SHALL BE THERMOPLASTIC UNLESS OTHERWISE NOTED.
   ALL STRIPMS AND JARKINGS SHALL BE CAT TRACKED BY THE CONTRACTOR MOD APPROVED BY THE NONNEEP PRIOR TO FINAL INSTALLATION. A MINIMUM OF 72 HOUR NOTICE IS REQUIRED.

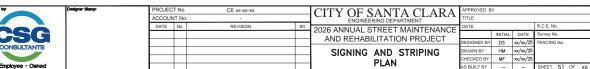

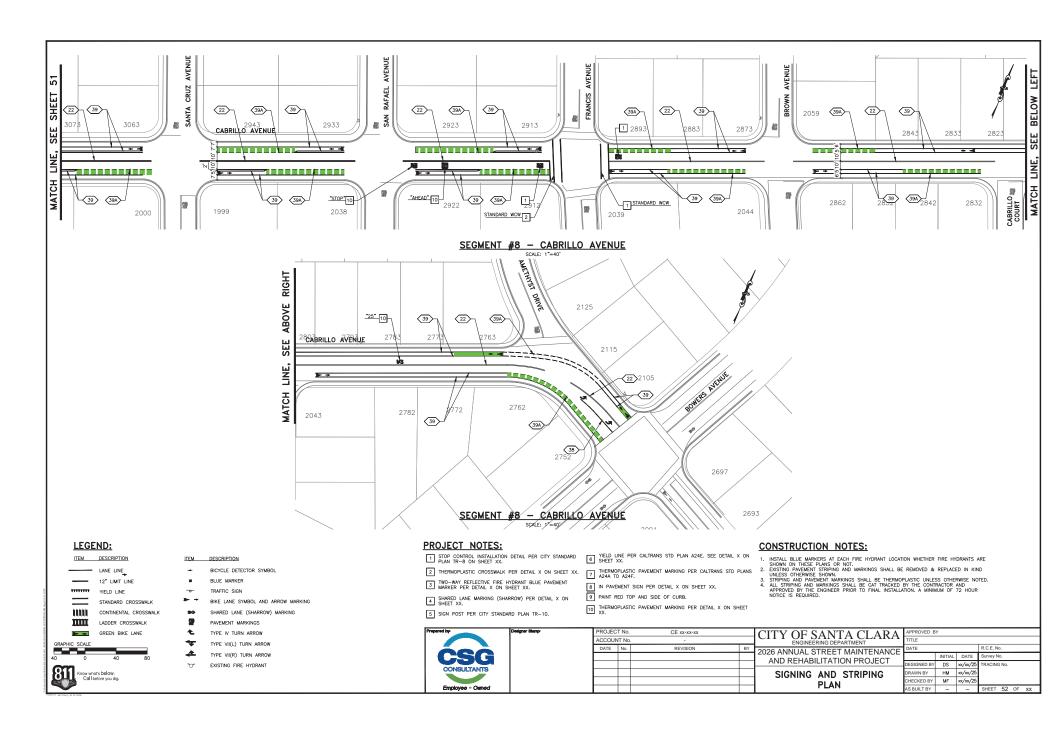


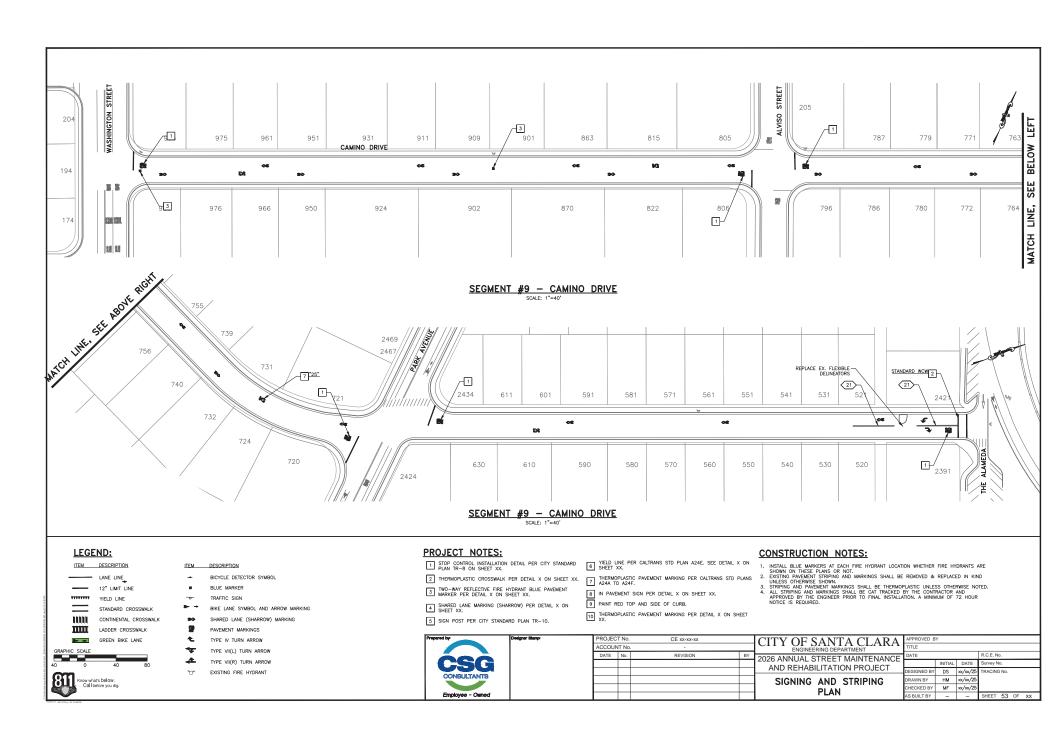


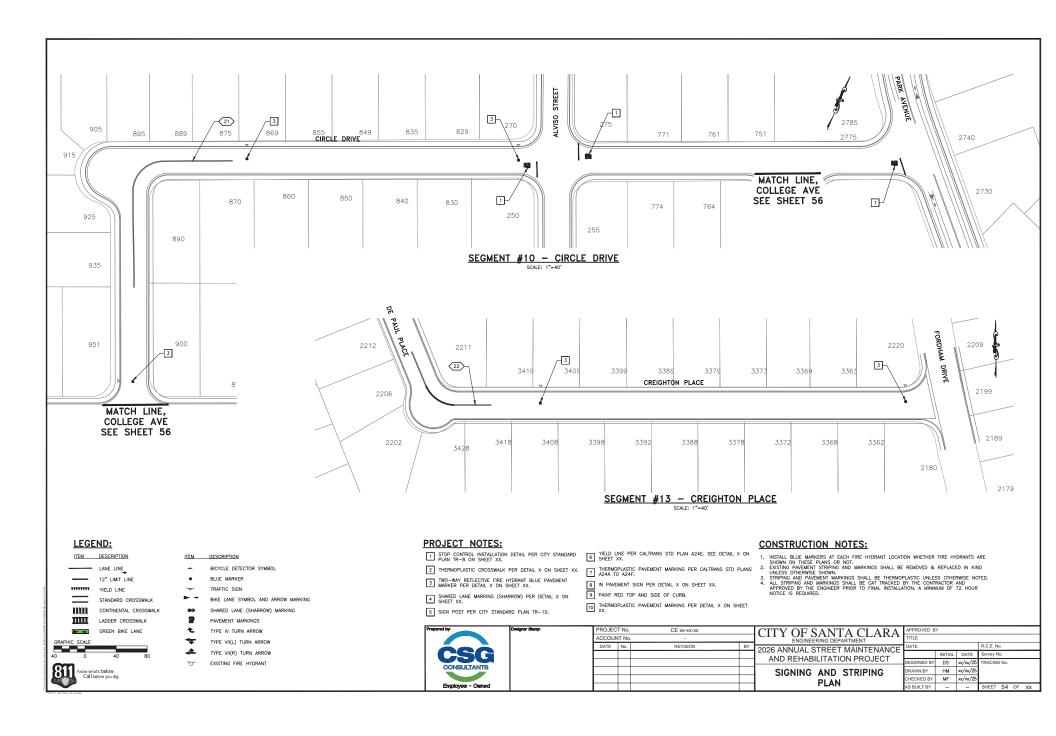


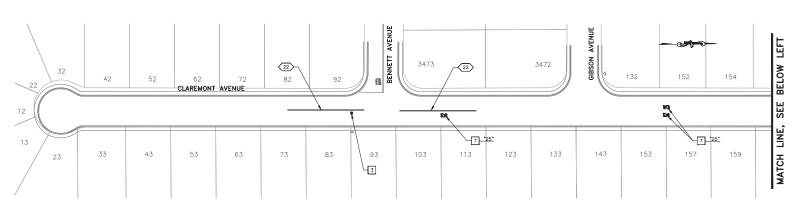



# SEGMENT #11 - CLAREMONT AVENUE SCALE: 1"=40"

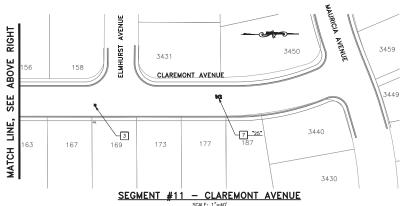

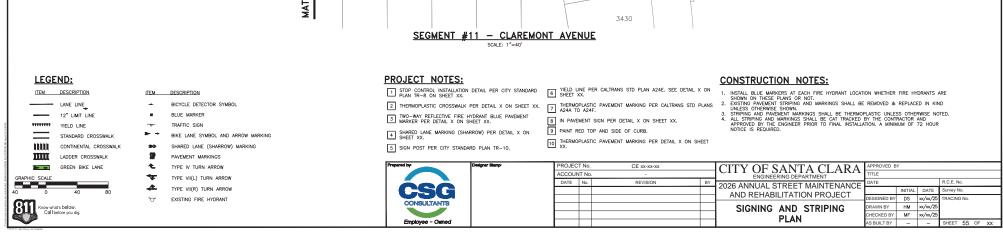

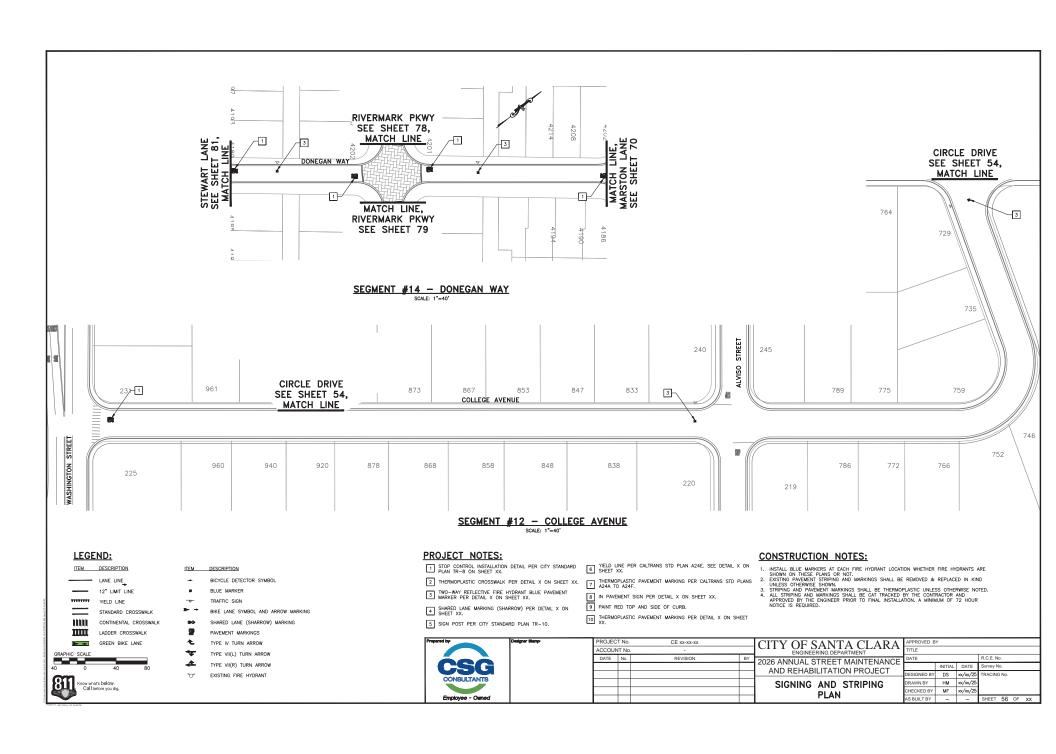

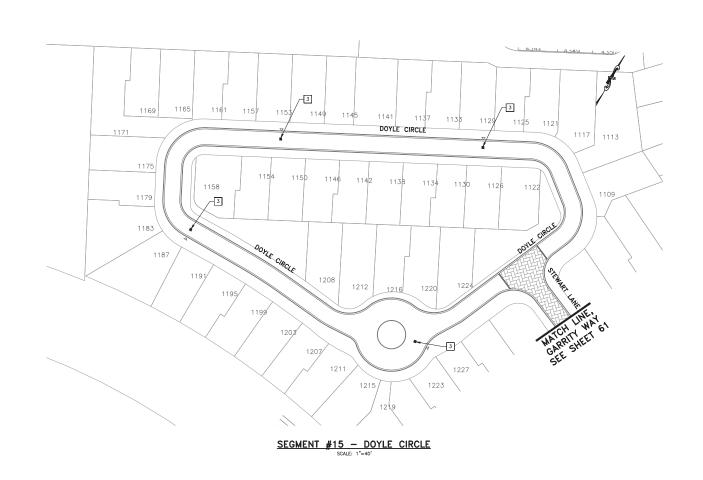

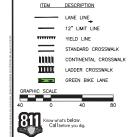

LEGEND:

ITEM DESCRIPTION

BLUE MARKER

TRAFFIC SIGN

PAVEMENT MARKINGS

TYPE VII(L) TURN ARROW TYPE VII(R) TURN ARROW EXISTING FIRE HYDRANT

BICYCLE DETECTOR SYMBOL

BIKE LANE SYMBOL AND ARROW MARKING

SHARED LANE (SHARROW) MARKING

### **PROJECT NOTES:**


- TWO-WAY REFLECTIVE FIRE HYDRANT BLUE PAVEMENT MARKER PER DETAIL X ON SHEET XX.
- 4 SHARED LANE MARKING (SHARROW) PER DETAIL X ON SHEET XX.
- 5 SIGN POST PER CITY STANDARD PLAN TR-10.
- 1 STOP CONTROL INSTALLATION DETAIL PER CITY STANDARD 6 SHEET XX. 6 SHEET XX.
- 2 THERMOPLASTIC CROSSWALK PER DETAIL X ON SHEET XX. 7 THERMOPLASTIC PAVEMENT MARKING PER CALTRANS STD PLANS A24A TO A24F.
  - 8 IN PAVEMENT SIGN PER DETAIL X ON SHEET XX.
  - 9 PAINT RED TOP AND SIDE OF CURB.
  - $\fbox{10}$  THERMOPLASTIC PAVEMENT MARKING PER DETAIL X ON SHEET XX.


- INSTALL BUE MARKERS AT EACH FIRE HYDRANT LOCATION WHETHER FIRE HYDRANTS ARE SHOUND ON THE STATEMENT AND MARKINGS SHALL BE REMOVED & REPLACED IN KIND UNLESS OTHERWISE SHOWN.
   STRIPING AND PAWEMENT MARKINGS SHALL BE THERMOPLASTIC UNLESS OTHERWISE NOTED.
   ALL STRIPING AND MARKINGS SHALL BE THERMOPLASTIC UNLESS OTHERWISE NOTED.
   ALL STRIPING AND MARKINGS SHALL BE OF TRACKED BY THE CONTRACTOR MAY NOTED IN TRACKED BY THE CONTRACTOR MAY NOTED IN TRACHING THE REQUIRED.





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ACCOUN	IT No		
DATE	No.	REVISION	BY
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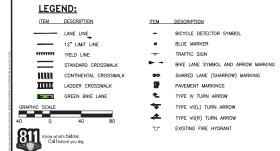
CITY OF SANTA CLARA	APPROVED BY									
ENGINEERING DEPARTMENT	TITLE									
2026 ANNUAL STREET MAINTENANCE	DATE			R.C.E. No.						
AND REHABILITATION PROJECT		INITIAL	DATE	Survey No.						
AND REHABILITATION PROJECT	DESIGNED BY	DS	xx/xx/25	TRACING No.						
SIGNING AND STRIPING	DRAWN BY	нм	xx/xx/25							
PLAN	CHECKED BY	MF	xx/xx/25							
FLAN	AS BUILT BY	-	-	SHEET 57 OF XX						



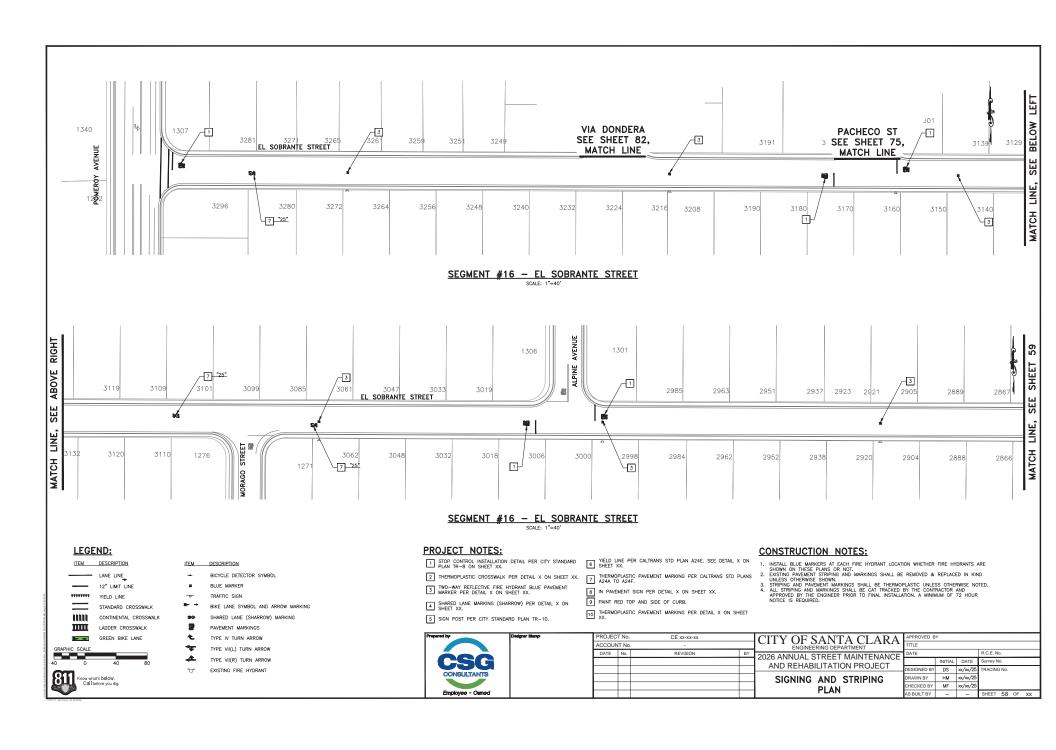

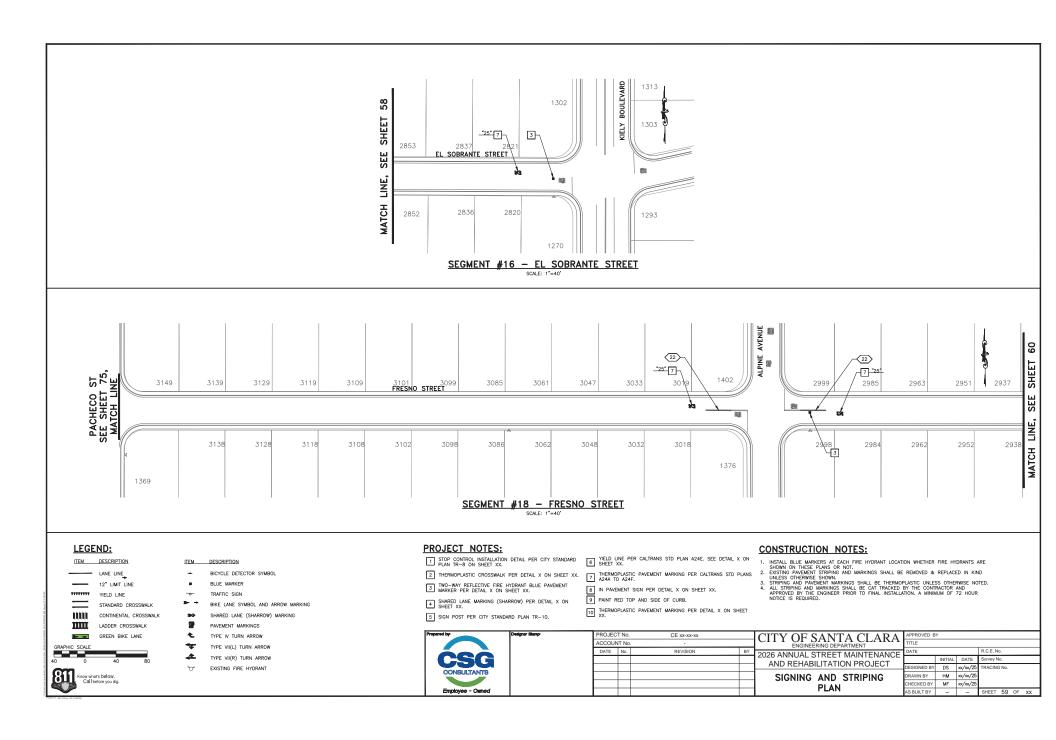

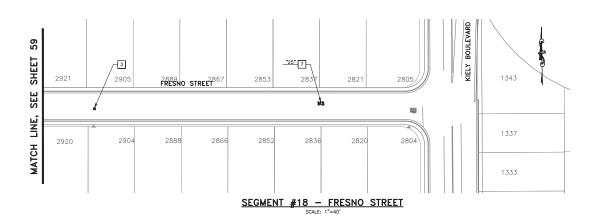

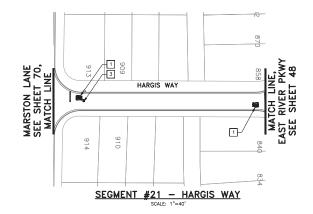

### **PROJECT NOTES:**

- 2 THERMOPLASTIC CROSSWALK PER DETAIL X ON SHEET XX.
- TWO-WAY REFLECTIVE FIRE HYDRANT BLUE PAVEMENT MARKER PER DETAIL X ON SHEET XX.
- 4 SHARED LANE MARKING (SHARROW) PER DETAIL X ON SHEET XX.
- 5 SIGN POST PER CITY STANDARD PLAN TR-10.
- 1 STOP CONTROL INSTALLATION DETAIL PER CITY STANDARD 6 SHEET XX. 6 SHEET XX.
  - 7 THERMOPLASTIC PAVEMENT MARKING PER CALTRANS STD PLANS A24A TO A24F.
  - 8 IN PAVEMENT SIGN PER DETAIL X ON SHEET XX.

### **CONSTRUCTION NOTES:**

- INSTALL BLUE MARKERS AT EACH FIRE HYDRANT LOCATION WHETHER FIRE HYDRANTS ARE SHOWN ON THESE FLANS OR NOT.
   SHOWN ON THESE FLANS OR NOT.
   SHOWN ON THESE FLANS OR AND MARKINGS SHALL BE REMOVED & REPLACED IN KIND LINESS OTHERWISE SHOWN.
   STRIPPING AND PARKINGS SHALL BE CT THERMOPLASTIC UNLESS OTHERWISE NOTED.
   ALL STRIPPING AND MARKINGS SHALL BE CAT TRACKED BY THE CONTRACTOR AND APPROVED BY THE ENDINEER PRIOR TO FINAL INSTALLATION. A MINIMUM OF 72 HOUR NOTICE IS REQUIRED.

APPROVED BY

INITIAL DATE

DESIGNED BY DS xx/xx/25

DRAWN BY HM xx/xx/25


CHECKED BY MF xx/xx/25 AS BUILT BY


Survey No.


SHEET 60 OF XX

9 PAINT RED TOP AND SIDE OF CURB. 10 THERMOPLASTIC PAVEMENT MARKING PER DETAIL X ON SHEET XX.


by	Designer Stemp	PROJEC*		CE xx-xx-xx		CITY OF SANTA CLARA
		DATE	No.	REVISION	BY	2026 ANNUAL STREET MAINTENANCE
JSG						AND REHABILITATION PROJECT
CONSULTANTS						SIGNING AND STRIPING
						PLAN
Employee - Owned						

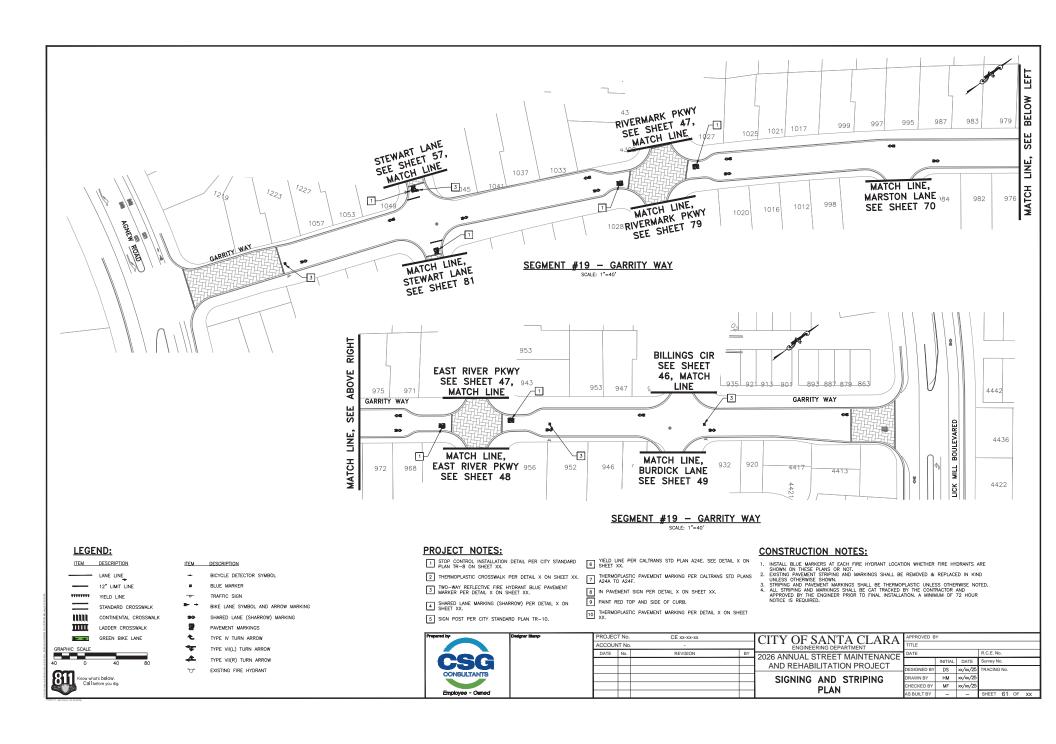


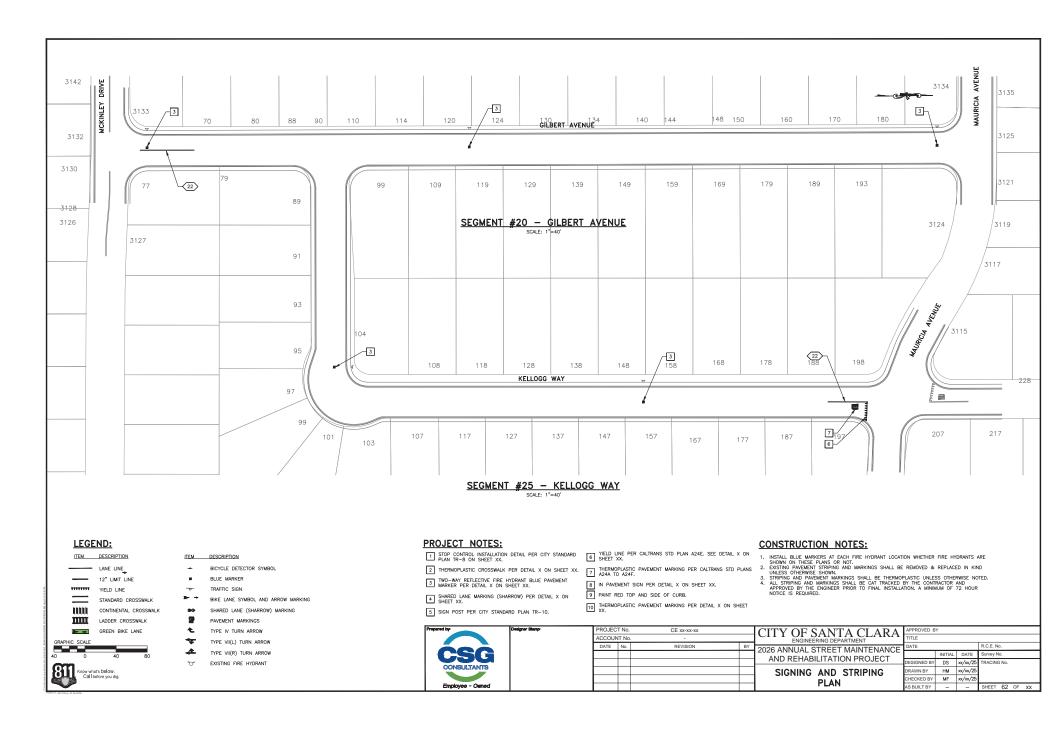

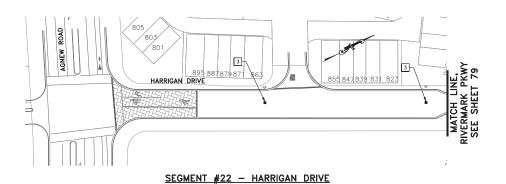

SCALE: 1"=40'

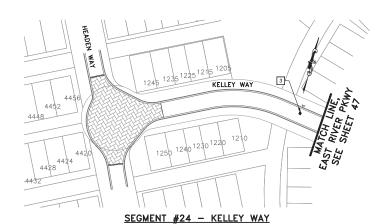

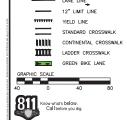

LEGEND:

ITEM DESCRIPTION

ITEM

DESCRIPTION BICYCLE DETECTOR SYMBOL

BLUE MARKER

TRAFFIC SIGN

BIKE LANE SYMBOL AND ARROW MARKING

SHARED LANE (SHARROW) MARKING

TYPE VII(L) TURN ARROW TYPE VII(R) TURN ARROW EXISTING FIRE HYDRANT

## **PROJECT NOTES:**


- STOP CONTROL INSTALLATION DETAIL PER CITY STANDARD PLAN TR-8 ON SHEET XX.
- TWO-WAY REFLECTIVE FIRE HYDRANT BLUE PAVEMENT MARKER PER DETAIL X ON SHEET XX.
- 4 SHARED LANE MARKING (SHARROW) PER DETAIL X ON SHEET XX.
- 5 SIGN POST PER CITY STANDARD PLAN TR-10.
- YIELD LINE PER CALTRANS STD PLAN A24E. SEE DETAIL X ON SHEET XX.
- 7 THERMOPLASTIC PAVEMENT MARKING PER CALTRANS STD PLANS A24A TO A24F.
- 8 IN PAVEMENT SIGN PER DETAIL X ON SHEET XX.
- 9 PAINT RED TOP AND SIDE OF CURB.
- 10 THERMOPLASTIC PAVEMENT MARKING PER DETAIL X ON SHEET XX.


- INSTALL BLUE MARKERS AT EACH FIRE HYDRANT LOCATION WHETHER FIRE HYDRANTS ARE SHOWN ON THESE FLANS OR NOT.
   SHOWN ON THESE FLANS OR NOT.
   SHOWN ON THESE FLANS OR AND MARKINGS SHALL BE REMOVED & REPLACED IN KIND LINESS OTHERWISE SHOWN.
   STRIPPING AND PARKINGS SHALL BE CT THERMOPLASTIC UNLESS OTHERWISE NOTED.
   ALL STRIPPING AND MARKINGS SHALL BE CAT TRACKED BY THE CONTRACTOR AND APPROVED BY THE ENDINEER PRIOR TO FINAL INSTALLATION. A MINIMUM OF 72 HOUR NOTICE IS REQUIRED.



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CITY OF SANTA CLARA	APPROVED BY								
ENGINEERING DEPARTMENT	TITLE								
2026 ANNUAL STREET MAINTENANCE	DATE			R.C.E. No.					
		INITIAL DATE Survey No.							
AND REHABILITATION PROJECT	DESIGNED BY	DS	xx/xx/25	TRACING No.					
SIGNING AND STRIPING	DRAWN BY	нм	xx/xx/25						
PLAN	CHECKED BY	MF	xx/xx/25						
FLAN	AS BUILT BY	-	-	SHEET 63 OF XX					




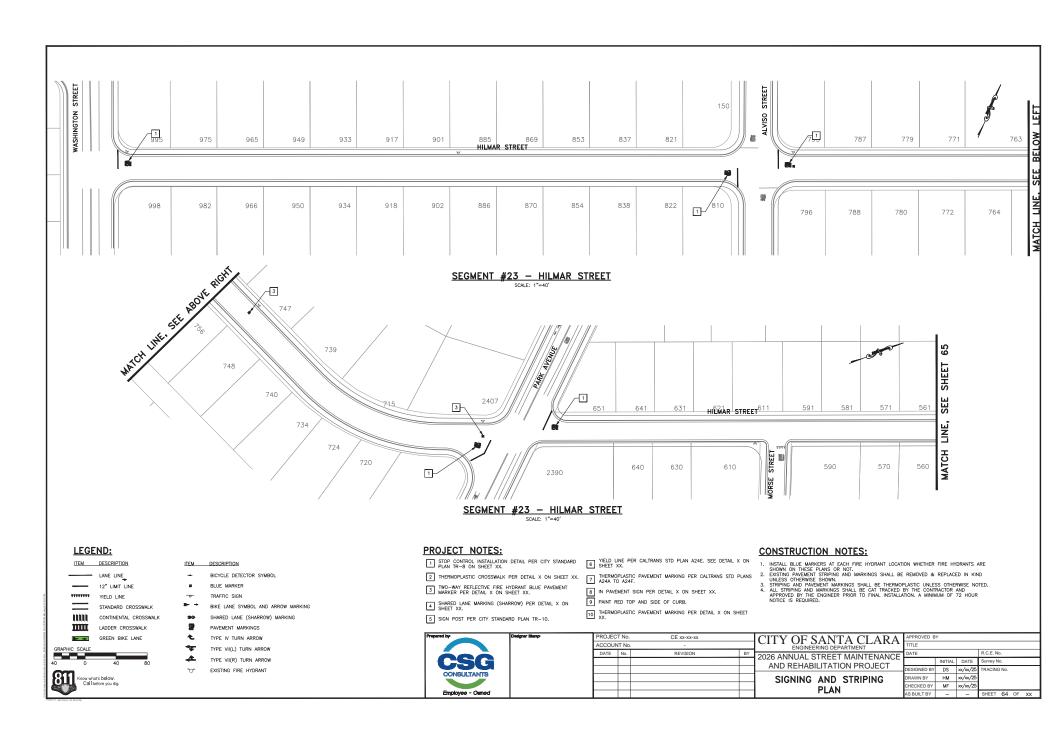
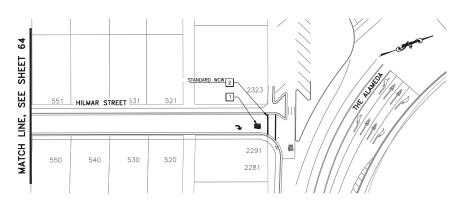
### SEGMENT #23 - HILMAR STREET

896 3 461 421 419 415 411 MATCH LINE, POPLAR ST SEE SHEET 75 507 473 LAFAYETTE WAY 3 418 416 412 430 410 "YIELD" 7 901

## SEGMENT #26 - LAFAYETTE WAY

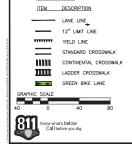

LEGEND:

#### ITEM DESCRIPTION

- BICYCLE DETECTOR SYMBOL
- BLUE MARKER
- TRAFFIC SIGN
- BIKE LANE SYMBOL AND ARROW MARKING
- SHARED LANE (SHARROW) MARKING
- PAVEMENT MARKINGS TYPE IV TURN ARROW
- TYPE VII(L) TURN ARROW
- TYPE VII(R) TURN ARROW EXISTING FIRE HYDRANT

**PROJECT NOTES:** 

STOP CONTROL INSTALLATION DETAIL PER CITY STANDARD PLAN TR-8 ON SHEET XX.

2 THERMOPLASTIC CROSSWALK PER DETAIL X ON SHEET XX.

TWO-WAY REFLECTIVE FIRE HYDRANT BLUE PAVEMENT MARKER PER DETAIL X ON SHEET XX.

4 SHARED LANE MARKING (SHARROW) PER DETAIL X ON SHEET XX.

5 SIGN POST PER CITY STANDARD PLAN TR-10.


### PROJECT No ACCOUNT No DATE No. REVISION


10 THERMOPLASTIC PAVEMENT MARKING PER DETAIL X ON SHEET XX.


8 IN PAVEMENT SIGN PER DETAIL X ON SHEET XX.

9 PAINT RED TOP AND SIDE OF CURB.

- YIELD LINE PER CALTRANS STD PLAN A24E. SEE DETAIL X ON SHEET XX.
- 7 THERMOPLASTIC PAVEMENT MARKING PER CALTRANS STD PLANS A24A TO A24F.
- INSTALL BLUE MARKERS AT EACH FIRE HYDRANT LOCATION WHETHER FIRE HYDRANTS ARE SHOWN ON THESE PLANS OR NOT.
   SUSTINE PREMENT STRIPPING AND MARKINGS SHALL BE REMOVED & REPLACED IN KIND CONTROL OF THE PROPERTY OF THE P
  - CE xx-xx-xx CITY OF SANTA CLARA APPROVED BY 2026 ANNUAL STREET MAINTENANCE INITIAL DATE Survey No. AND REHABILITATION PROJECT DESIGNED BY DS xx/xx/25 DRAWN BY HM xx/xx/25 SIGNING AND STRIPING CHECKED BY MF xx/xx/25 PLAN AS BUILT BY SHEET 65 OF XX

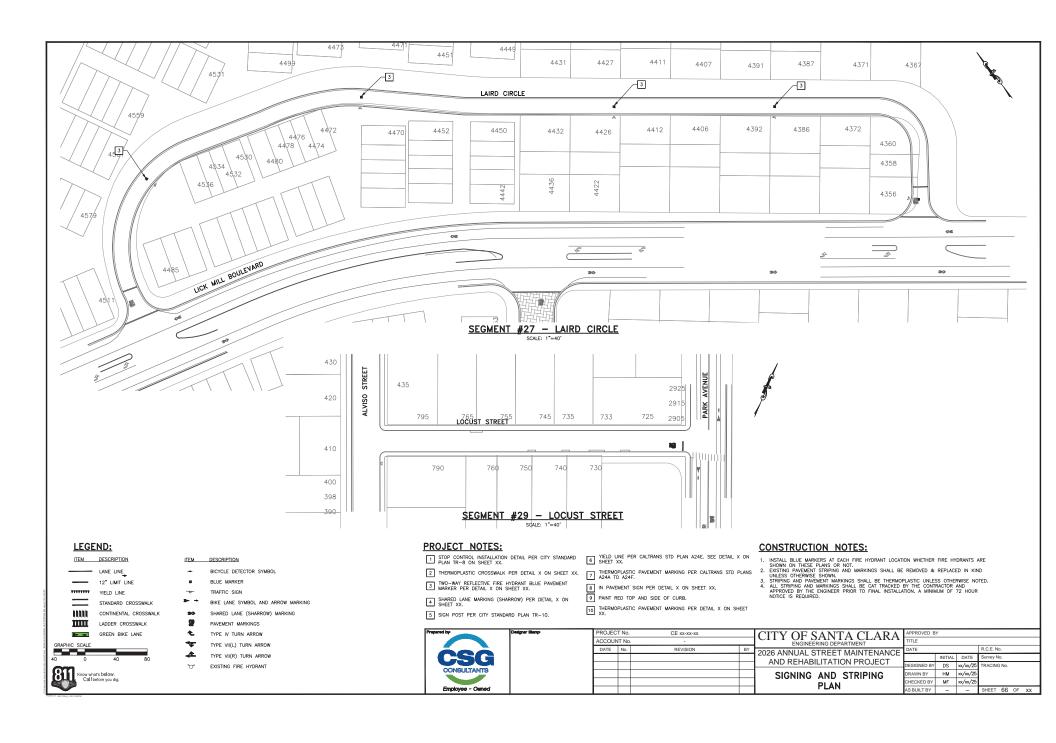

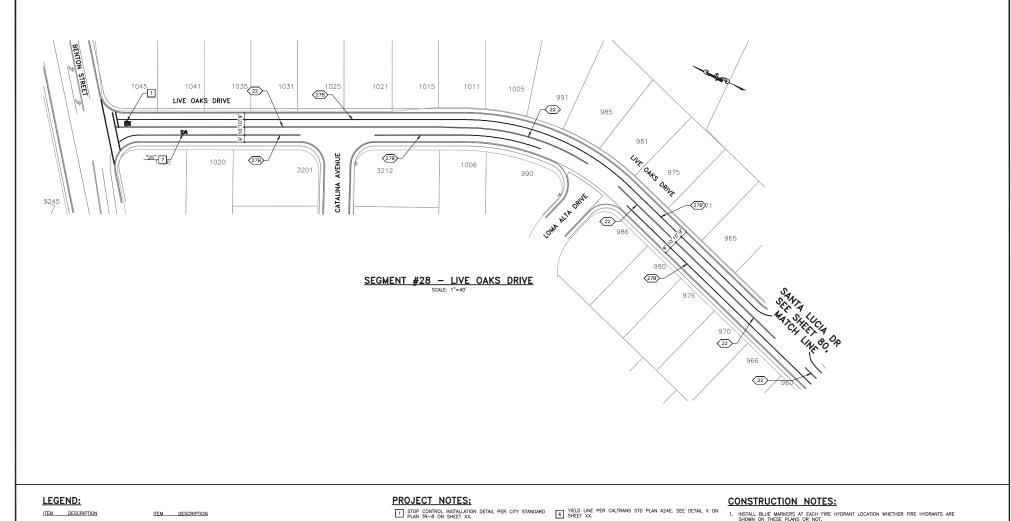

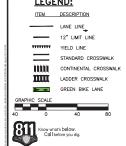

BICYCLE DETECTOR SYMBOL

BIKE LANE SYMBOL AND ARROW MARKING

SHARED LANE (SHARROW) MARKING

BLUE MARKER

TRAFFIC SIGN

PAVEMENT MARKINGS

TYPE IV TURN ARROW TYPE VII(L) TURN ARROW TYPE VII(R) TURN ARROW EXISTING FIRE HYDRANT


- TWO-WAY REFLECTIVE FIRE HYDRANT BLUE PAVEMENT MARKER PER DETAIL X ON SHEET XX.
- SHARED LANE MARKING (SHARROW) PER DETAIL X ON SHEET XX.
- 5 SIGN POST PER CITY STANDARD PLAN TR-10.
- THERMOPLASTIC PAVEMENT MARKING PER CALTRANS STD PLANS A24A TO A24F.
- 8 IN PAVEMENT SIGN PER DETAIL X ON SHEET XX.
- 9 PAINT RED TOP AND SIDE OF CURB.
- 10 THERMOPLASTIC PAVEMENT MARKING PER DETAIL X ON SHEET XX.

- INSTALL BUE MARKERS AT EACH FIRE HYDRANT LOCATION WHETHER FIRE HYDRANTS ARE SHOUND ON THE STATEMENT AND MARKINGS SHALL BE REMOVED & REPLACED IN KIND UNLESS OTHERWISE SHOWN.
   STRIPING AND PAWEMENT MARKINGS SHALL BE THERMOPLASTIC UNLESS OTHERWISE NOTED.
   ALL STRIPING AND MARKINGS SHALL BE THERMOPLASTIC UNLESS OTHERWISE NOTED.
   ALL STRIPING AND MARKINGS SHALL BE OF TRACKED BY THE CONTRACTOR MAY NOTED IN TRACKED BY THE CONTRACTOR MAY NOTED IN TRACHING THE REQUIRED.


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ı	CONSULTANTS
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ı	Employee - Owned

C		CE xx-xx-xx	T No.	PROJEC
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CITY OF SANTA CLARA	APPROVED BY									
ENGINEERING DEPARTMENT	TITLE									
2026 ANNUAL STREET MAINTENANCE	DATE			R.C.E. No.						
AND REHABILITATION PROJECT		INITIAL	DATE	Survey No.						
AND REHABILITATION PROJECT	DESIGNED BY	DS	xx/xx/25	TRACING No.						
SIGNING AND STRIPING	DRAWN BY	НМ	xx/xx/25	İ						
PLAN	CHECKED BY	MF	xx/xx/25							
FLAN	AS BUILT BY	-	-	SHEET 67 OF XX						

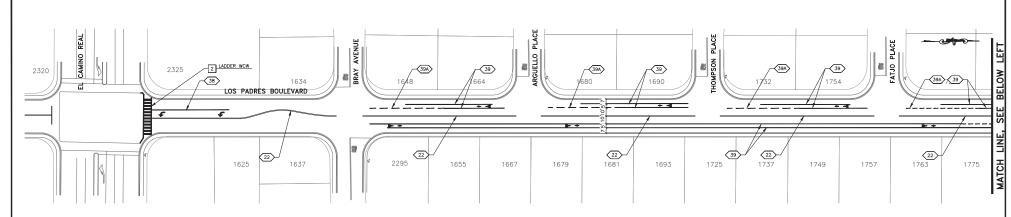

#### SEGMENT #30 - LOS PADRES BOULEVARD SCALE: 1"=40"



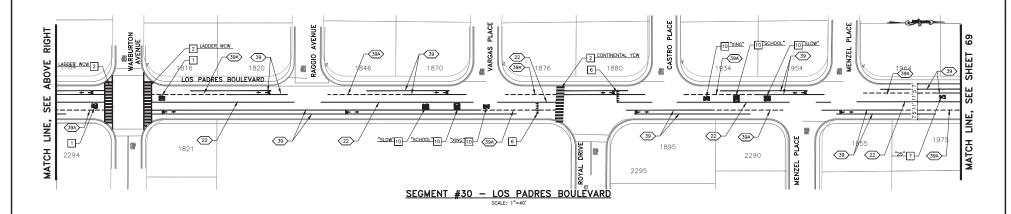



12" LIMIT LINE YIELD LINE

STANDARD CROSSWALK 11111 CONTINENTAL CROSSWALK

LADDER CROSSWALK

GREEN BIKE LANE

inow what's below. Call before you dig.

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**2** +

#### ITEM DESCRIPTION

- BICYCLE DETECTOR SYMBOL
- BLUE MARKER
- TRAFFIC SIGN
- BIKE LANE SYMBOL AND ARROW MARKING
- SHARED LANE (SHARROW) MARKING


- TYPE VII(L) TURN ARROW
- TYPE VII(R) TURN ARROW EXISTING FIRE HYDRANT

### **PROJECT NOTES:**

- STOP CONTROL INSTALLATION DETAIL PER CITY STANDARD PLAN TR-8 ON SHEET XX.
- $\ensuremath{\mathbb{Z}}$  THERMOPLASTIC CROSSWALK PER DETAIL X ON SHEET XX.
- TWO-WAY REFLECTIVE FIRE HYDRANT BLUE PAVEMENT MARKER PER DETAIL X ON SHEET XX.
- SHARED LANE MARKING (SHARROW) PER DETAIL X ON SHEET XX.
- 5 SIGN POST PER CITY STANDARD PLAN TR-10.
- YIELD LINE PER CALTRANS STD PLAN A24E. SEE DETAIL X ON SHEET XX.
- 8 IN PAVEMENT SIGN PER DETAIL X ON SHEET XX.
- 9 PAINT RED TOP AND SIDE OF CURB.
- $\fbox{10}$  THERMOPLASTIC PAVEMENT MARKING PER DETAIL X ON SHEET XX.


- NOTALL BUE MARKERS AT EACH FIRE HYDRANT LOCATION WHETHER FIRE HYDRANTS ARE SHOWN ON THESE PLANE OF THE PROPERTY OF THE PR

red by	Designer Blemp	PROJEC	T No.	CE xx-xx-xx		CITY OF SANTA CLARA	APPROVED B	Y		
		ACCOUN	NT No			ENGINEERING DEPARTMENT	TITLE			
		DATE	No.	REVISION	BY	2026 ANNUAL STREET MAINTENANCE	DATE			R.C.E. No.
						AND REHABILITATION PROJECT		INITIAL	DATE	Survey No.
00101121120						AND REHABILITATION PROJECT	DESIGNED BY	DS	xx/xx/25	TRACING No.
CONSULTANTS						SIGNING AND STRIPING	DRAWN BY	нм	xx/xx/25	
							CHECKED BY	MF	xx/xx/25	
Employee - Owned						FLAN	AS BUILT BY	-	-	SHEET 68 OF XX

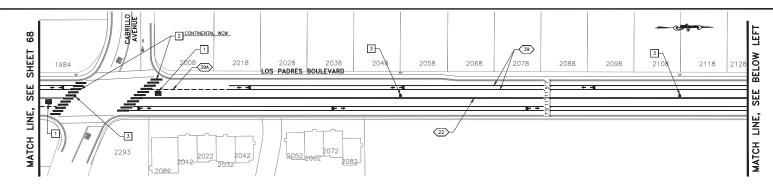

### SEGMENT #30 - LOS PADRES BOULEVARD

SCALE: 1"=40"

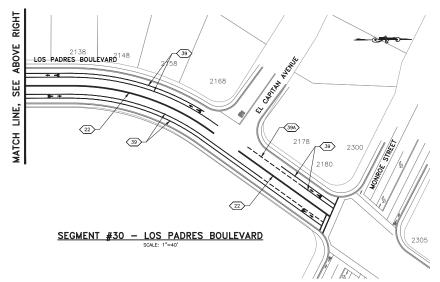

### LEGEND:

ITEM DESCRIPTION

12" LIMIT LINE \*\*\*\*\*\*\* YIELD LINE

STANDARD CROSSWALK CONTINENTAL CROSSWALK LADDER CROSSWALK

GREEN BIKE LANE

11111

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Know what's below. Call before you dig.

#### ITEM DESCRIPTION

- BICYCLE DETECTOR SYMBOL
- BLUE MARKER
- TRAFFIC SIGN
- BIKE LANE SYMBOL AND ARROW MARKING
- SHARED LANE (SHARROW) MARKING
- PAVEMENT MARKINGS
- TYPE VII(L) TURN ARROW TYPE VII(R) TURN ARROW
- EXISTING FIRE HYDRANT

### **PROJECT NOTES:**

- 2 THERMOPLASTIC CROSSWALK PER DETAIL X ON SHEET XX.
- TWO-WAY REFLECTIVE FIRE HYDRANT BLUE PAVEMENT MARKER PER DETAIL X ON SHEET XX.
- $\boxed{\textbf{4}}$  SHARED LANE MARKING (SHARROW) PER DETAIL X ON SHEET XX.
- 5 SIGN POST PER CITY STANDARD PLAN TR-10.
- TOP CONTROL INSTALLATION DETAIL PER CITY STANDARD

  6 SHEET XX.


  6 SHEET XX.
  - 7 THERMOPLASTIC PAVEMENT MARKING PER CALTRANS STD PLANS A24A TO A24F.
  - 8 IN PAVEMENT SIGN PER DETAIL X ON SHEET XX.
  - 9 PAINT RED TOP AND SIDE OF CURB.
  - $\fbox{10}$  THERMOPLASTIC PAVEMENT MARKING PER DETAIL X ON SHEET XX.


### **CONSTRUCTION NOTES:**


- INSTALL BLUE MARKERS AT EACH FIRE HYDRANT LOCATION WHETHER FIRE HYDRANTS ARE SHOWN ON THESE PLANS OR NOT.
   EXISTING PREMENT STRIPMS AND MARKINGS SHALL BE REMOVED & REPLACED IN KIND STRIPMS AND PAWELETT MARKINGS SHALL BE THERMOPLASTIC UNLESS OTHERWISE NOTED.
   ALL STRIPMS AND JARKINGS SHALL BE CAT TRACKED BY THE CONTRACTOR MOD APPROVED BY THE NONNEEP PRIOR TO FINAL INSTALLATION. A MINIMUM OF 72 HOUR NOTICE IS REQUIRED.


lby	Designer Blemp:	PROJEC	T No.	CE xx-xx-xx
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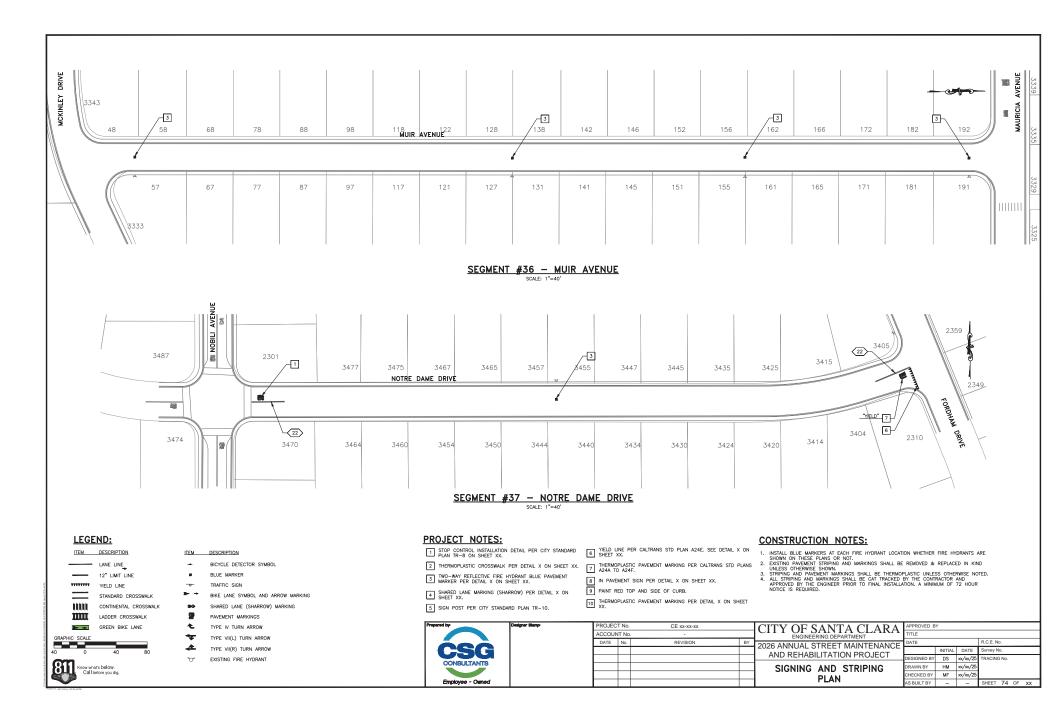
CITY OF SANTA CLARA 2026 ANNUAL STREET MAINTENANCE INITIAL DATE AND REHABILITATION PROJECT DESIGNED BY DS xx/xx/25 DRAWN BY HM xx/xx/25 SIGNING AND STRIPING CHECKED BY MF xx/xx/25 PLAN AS BUILT BY




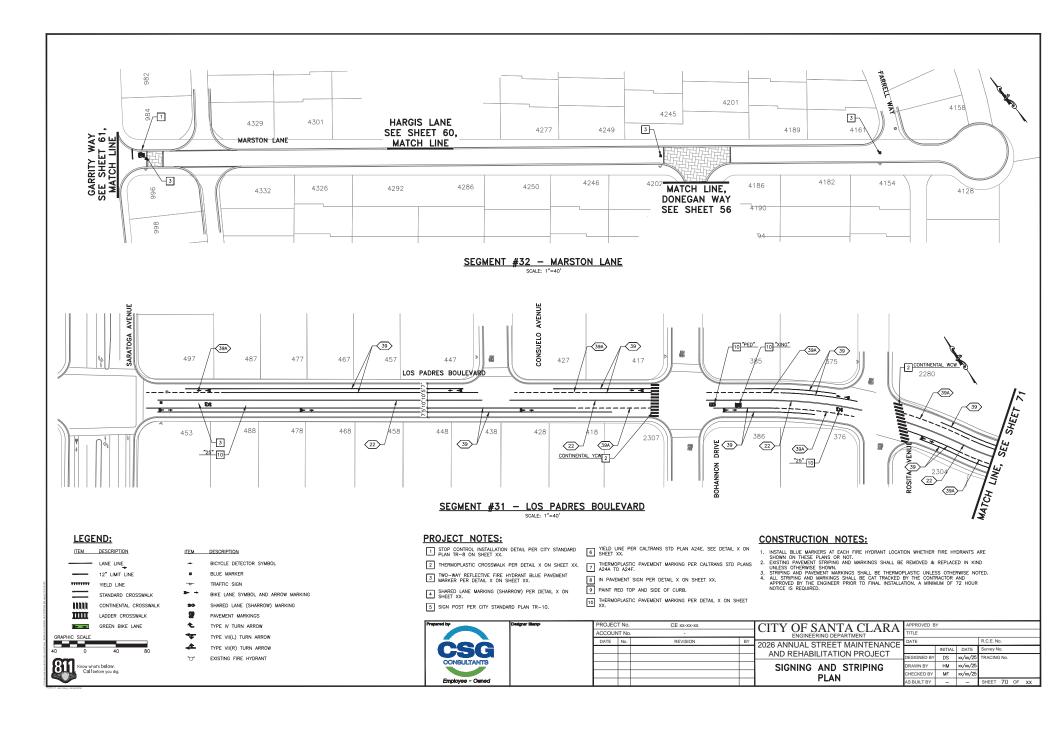


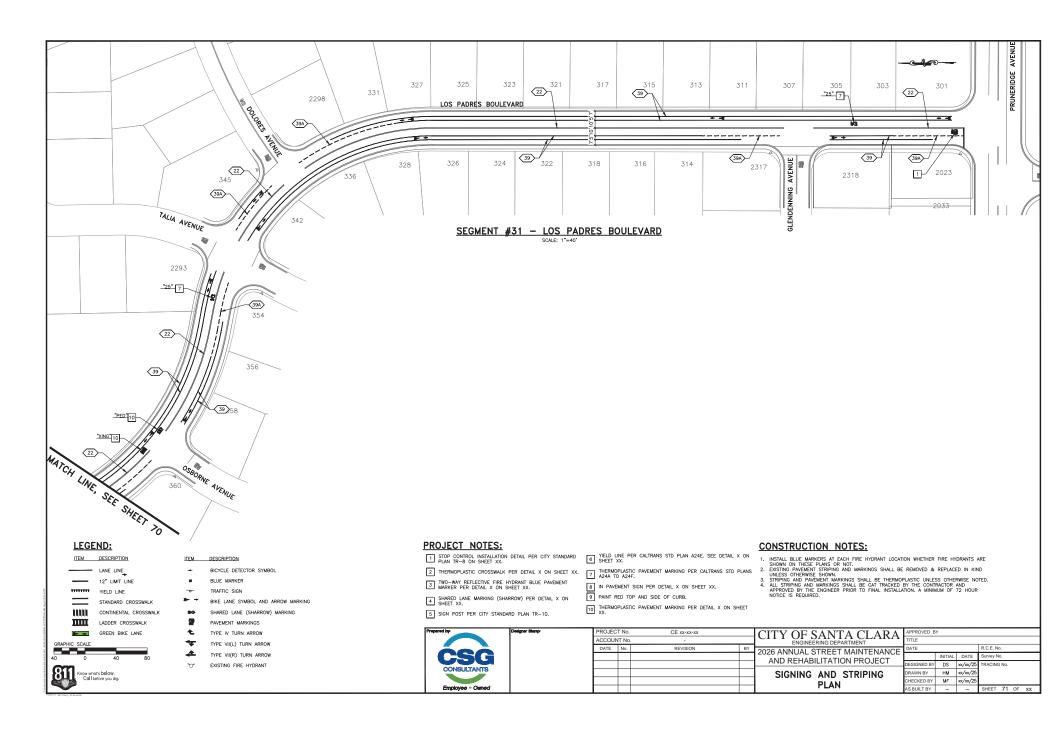


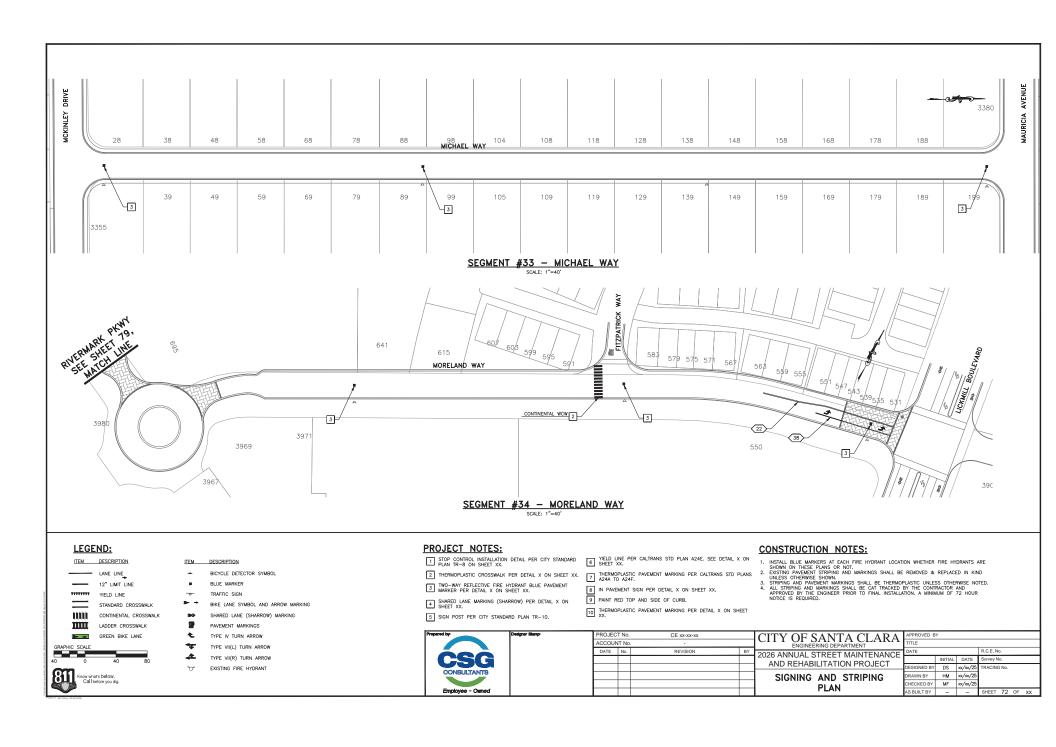

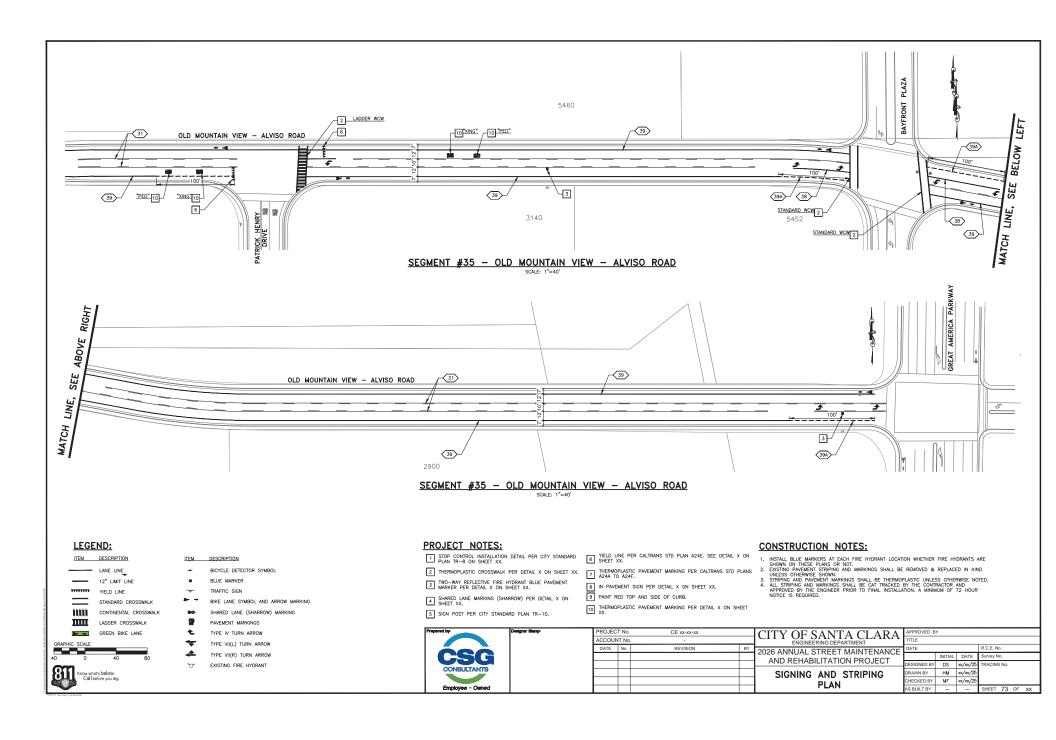

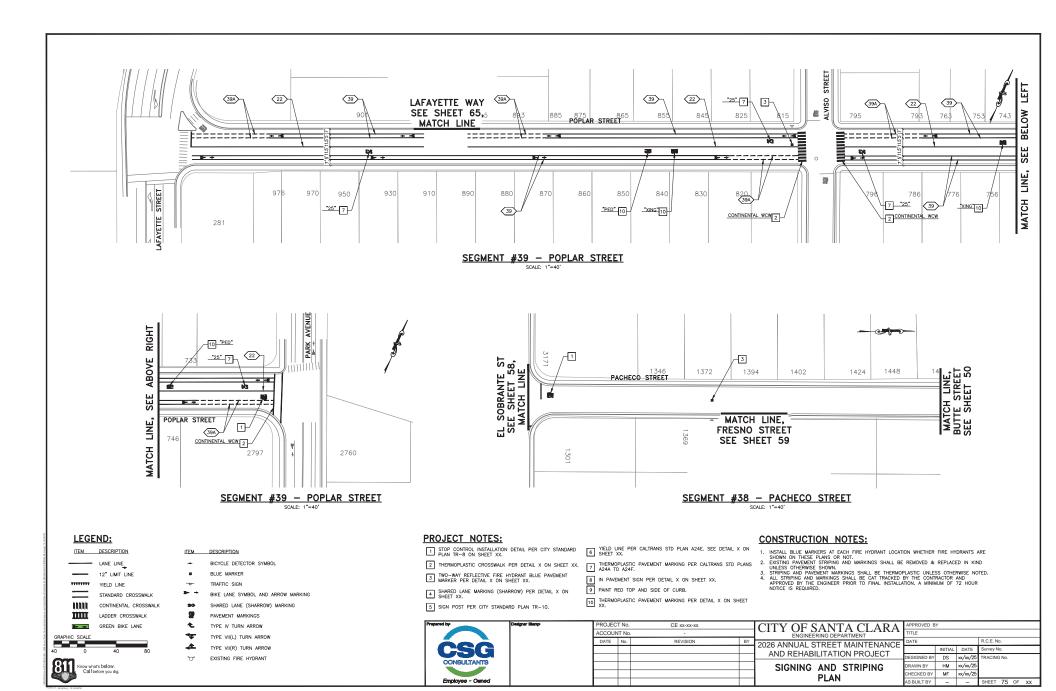

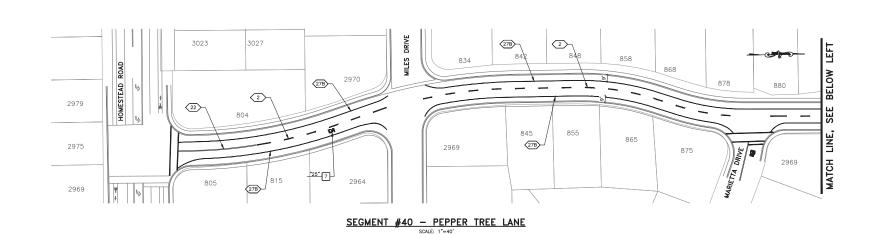

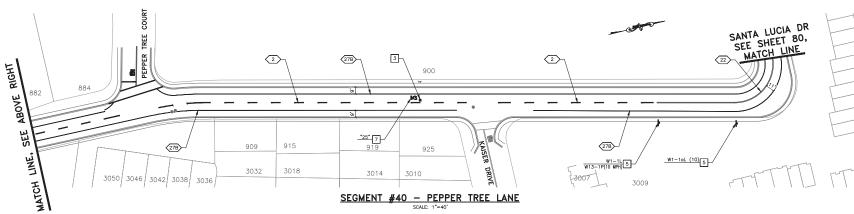

APPROVED BY

AS BUILT BY


INITIAL DATE


DESIGNED BY DS xx/xx/25

DRAWN BY HM xx/xx/25


CHECKED BY MF xx/xx/25


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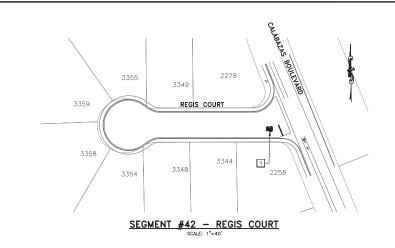


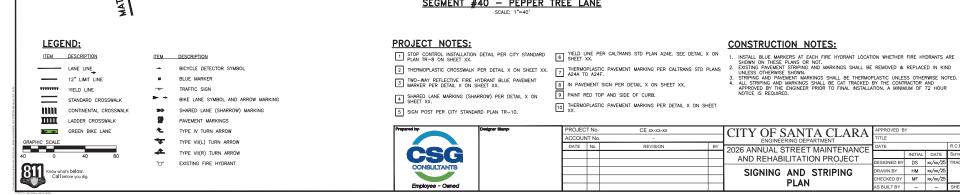


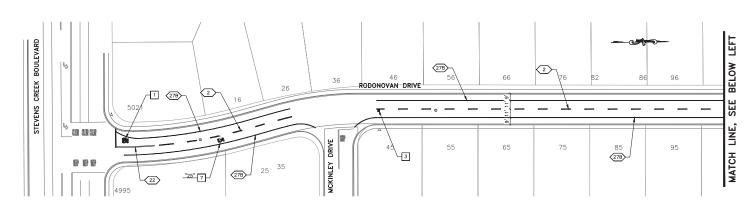
#### SEGMENT #41 - RODONOVAN DRIVE SCALE: 1"=40'



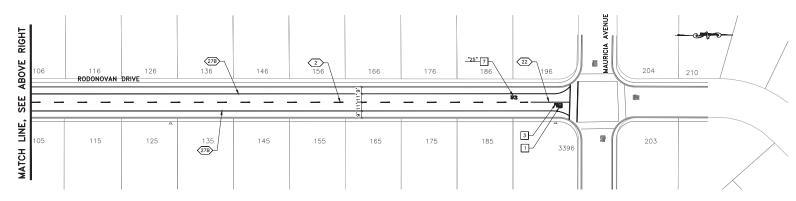

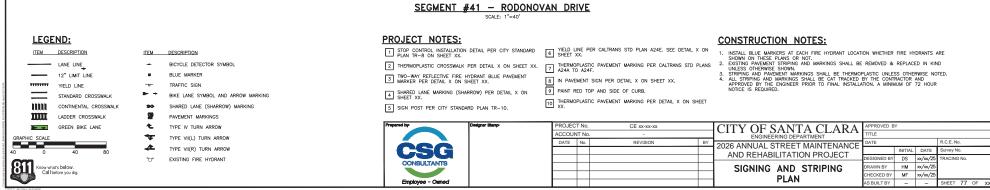

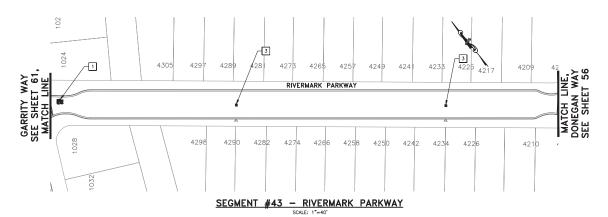

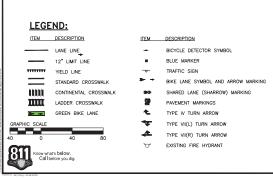



### **PROJECT NOTES:**

- 2 THERMOPLASTIC CROSSWALK PER DETAIL X ON SHEET XX.
- TWO-WAY REFLECTIVE FIRE HYDRANT BLUE PAVEMENT MARKER PER DETAIL X ON SHEET XX.
- $\begin{tabular}{lll} 4 & SHARED LANE MARKING (SHARROW) PER DETAIL X ON SHEET XX. \end{tabular}$
- 5 SIGN POST PER CITY STANDARD PLAN TR-10.
- 1 STOP CONTROL INSTALLATION DETAIL PER CITY STANDARD 6 SHEET XX. 6 SHEET XX.
  - THERMOPLASTIC PAVEMENT MARKING PER CALTRANS STD PLANS A24A TO A24F.
  - 8 IN PAVEMENT SIGN PER DETAIL X ON SHEET XX.
  - 9 PAINT RED TOP AND SIDE OF CURB.
  - $\fbox{10}$  THERMOPLASTIC PAVEMENT MARKING PER DETAIL X ON SHEET XX.

- INSTALL BLUE MARKERS AT EACH FIRE HYDRANT LOCATION WHETHER FIRE HYDRANTS ARE SHOWN ON THESE FLANS OR NOT.
   SHOWN ON THESE FLANS OR AND MARKINGS SHALL BE REMOVED & REPLACED IN KIND UNLESS OTHERWISE SHOWN.
   STRIPPING AND PAWEMENT MARKINGS SHALL BE THERMOPLASTIC UNLESS OTHERWISE NOTED.
   ALL STRIPPING AND MARKINGS SHALL BE CATTRACKED BY THE CONTRACTOR AND APPROVED BY THE KNONLEY PRIOR TO FINAL INSTALLATION. A MINIMUM OF 72 HOUR WONCE IS REQUIRED.

ered by	Designer Blemp:	PROJEC	T No.	CE xx-xx-xx		CITY OF SANTA CLARA	APPROVED B	′		
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		DATE	No.	REVISION	BY	2026 ANNUAL STREET MAINTENANCE			R.C.E. No.	
					AND REHABILITATION PROJECT		INITIAL	DATE	Survey No.	
CONSULTANTS						AND REHABILITATION PROJECT	DESIGNED BY	DS	xx/xx/25	TRACING No.
CONSULIANTS						SIGNING AND STRIPING	DRAWN BY	нм	xx/xx/25	
						PLAN	CHECKED BY	MF	xx/xx/25	
Employee - Owned						FLAN	AS BUILT BY	-	-	SHEET 78 OF XX

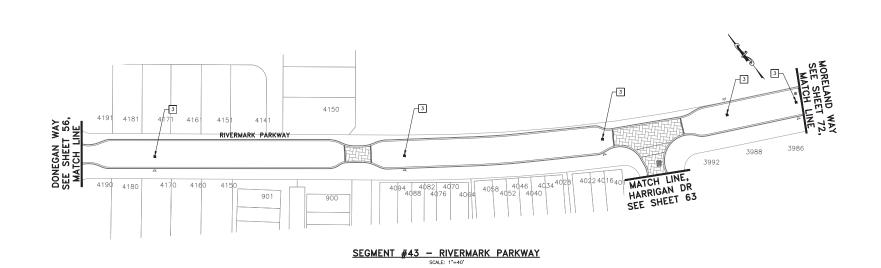

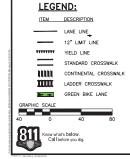

ITEM

DESCRIPTION BICYCLE DETECTOR SYMBOL

BLUE MARKER

TRAFFIC SIGN

BIKE LANE SYMBOL AND ARROW MARKING

SHARED LANE (SHARROW) MARKING

TYPE VII(L) TURN ARROW TYPE VII(R) TURN ARROW EXISTING FIRE HYDRANT

## **PROJECT NOTES:**

2 THERMOPLASTIC CROSSWALK PER DETAIL X ON SHEET XX.

TWO-WAY REFLECTIVE FIRE HYDRANT BLUE PAVEMENT MARKER PER DETAIL X ON SHEET XX.

4 SHARED LANE MARKING (SHARROW) PER DETAIL X ON SHEET XX.

5 SIGN POST PER CITY STANDARD PLAN TR-10.

1 STOP CONTROL INSTALLATION DETAIL PER CITY STANDARD 6 SHEET XX. 6 SHEET XX.

THERMOPLASTIC PAVEMENT MARKING PER CALTRANS STD PLANS A24A TO A24F.


8 IN PAVEMENT SIGN PER DETAIL X ON SHEET XX.

9 PAINT RED TOP AND SIDE OF CURB.  $\fbox{10}$  THERMOPLASTIC PAVEMENT MARKING PER DETAIL X ON SHEET XX.


INSTALL BLUE MARKERS AT EACH FIRE HYDRANT LOCATION WHETHER FIRE HYDRANTS ARE SHOWN ON THESE PLANS OR NOT.
 EMSTING PARKEMENT STRIPING AND MARKINGS SHALL BE REMOVED & REPLACED IN KIND EMBELS.
 STRIPING AND PARKEMENT MARKINGS SHALL BE THERMOPLASTIC UNLESS OTHERWISE NOTED.
 ALL STRIPING AND MARKINGS SHALL BE CAT TRACKED BY THE CONTRACTOR AND APPROVED BY THE ENGINEER PRIOR TO FINAL INSTALLATION. A MINIMUM OF 72 HOUR NOTICE IS REQUIRED.

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CONSULTANTS	
Employee - Owned	

PROJEC	T No.	CE xx-xx-xx		CITY OF SANTA CLARA	APPROVED BY			
ACCOUNT No		ENGINEERING DEPARTMENT	TITLE					
DATE	No.	REVISION	BY	2026 ANNUAL STREET MAINTENANCE			R.C.E. No.	
				AND REHABILITATION PROJECT SIGNING AND STRIPING		INITIAL	DATE	Survey No.
					DESIGNED BY	DS	xx/xx/25	TRACING No.
					DRAWN BY	нм	xx/xx/25	
					CHECKED BY	MF	xx/xx/25	
				FLAN	AS BUILT BY	_	-	SHEET 79 OF XX

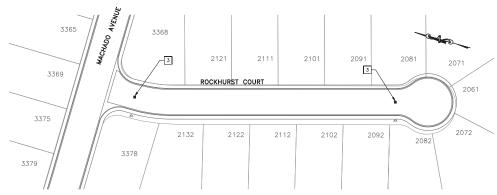

## SEGMENT #44 - ROCKHURST COURT

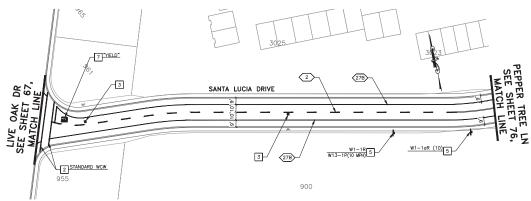

# SEGMENT #45 - SANTA LUCIA DRIVE



#### DESCRIPTION

- BICYCLE DETECTOR SYMBOL
- BLUE MARKER
- TRAFFIC SIGN
- BIKE LANE SYMBOL AND ARROW MARKING
- SHARED LANE (SHARROW) MARKING

- TYPE VII(L) TURN ARROW
- TYPE VII(R) TURN ARROW
- EXISTING FIRE HYDRANT


## **PROJECT NOTES:**

- 2 THERMOPLASTIC CROSSWALK PER DETAIL X ON SHEET XX.
- TWO-WAY REFLECTIVE FIRE HYDRANT BLUE PAVEMENT MARKER PER DETAIL X ON SHEET XX.
- $\begin{tabular}{lll} 4 & SHARED LANE MARKING (SHARROW) PER DETAIL X ON SHEET XX. \end{tabular}$
- 5 SIGN POST PER CITY STANDARD PLAN TR-10.
- 1 STOP CONTROL INSTALLATION DETAIL PER CITY STANDARD 6 SHEET XX. 6 SHEET XX.
  - THERMOPLASTIC PAVEMENT MARKING PER CALTRANS STD PLANS A24A TO A24F.
  - 8 IN PAVEMENT SIGN PER DETAIL X ON SHEET XX.
  - 9 PAINT RED TOP AND SIDE OF CURB.
  - 10 THERMOPLASTIC PAVEMENT MARKING PER DETAIL X ON SHEET XX.


#### **CONSTRUCTION NOTES:**


- INSTALL BLUE MARKERS AT EACH FIRE HYDRANT LOCATION WHETHER FIRE HYDRANTS ARE SHOWN ON THESE FLANS OR NOT.
   SUSTINE PREMENT STRIPPING AND MARKINGS SHALL BE REMOVED & REPLACED IN KIND CHARLES AND PAWEMENT MARKINGS SHALL BE THERMOPLASTIC UNLESS OTHER AND APPROVED BY THE MORKINGS SHALL BE CAT TRACKED BY THE CONTRACTION APPROVED BY THE NOINCE PRIOR TO FINAL INSTALLATION. A MINIMUM OF 72 HOUR MOTICE IS REQUIRED.


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		ACCOUN	IT No				TITLE			
		DATE	No.	REVISION	BY		DATE			R.C.E. No.
<b>9</b> >- € 1						AND REHABILITATION PROJECT		INITIAL	DATE	Survey No.
CONSULTANTS						AND REHABILITATION PROJECT	DESIGNED BY	DS	xx/xx/25	TRACING No.
CONSULIARIS						SIGNING AND STRIPING	DRAWN BY	HM	xx/xx/25	l
						PLAN	CHECKED BY	MF	xx/xx/25	
Employee - Owned						FLAN	AS BUILT BY	-	-	SHEET 80 OF XX

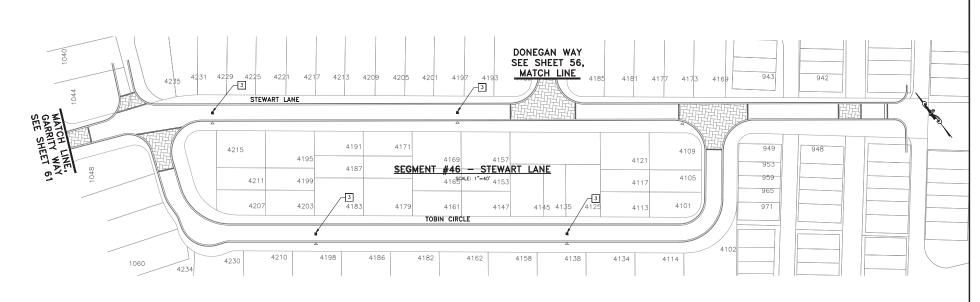




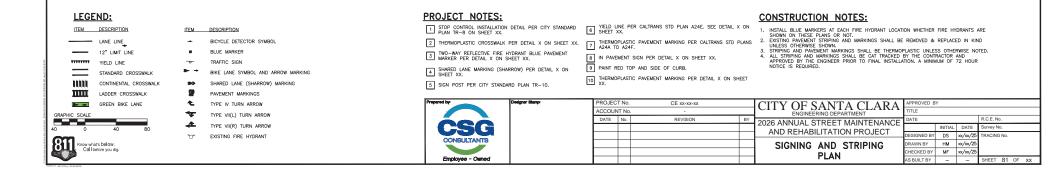


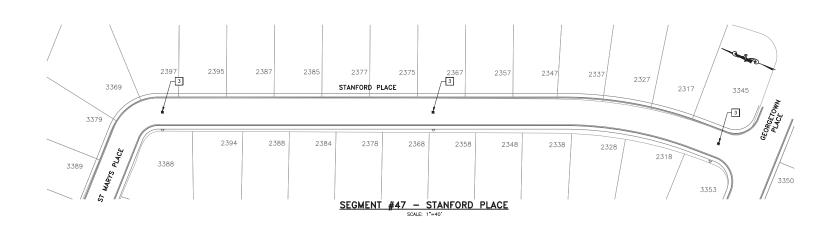


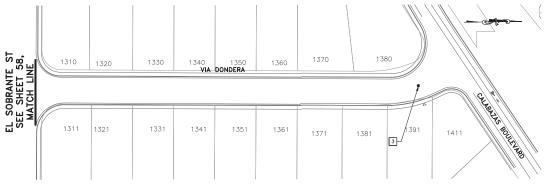


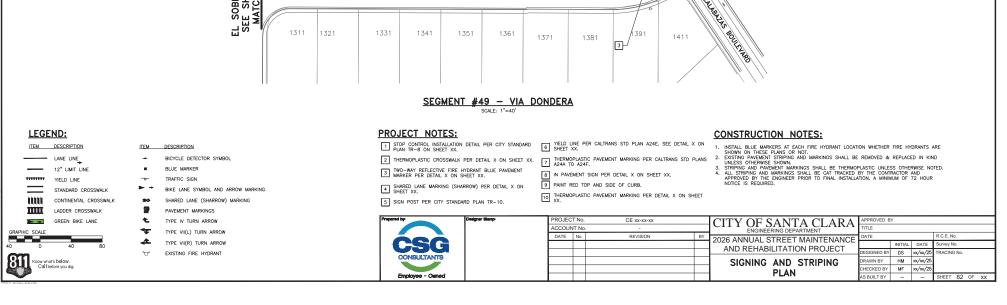



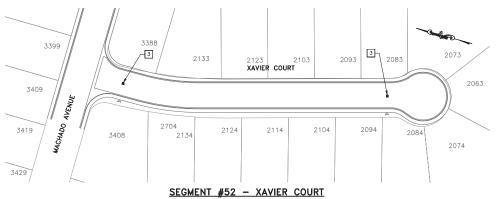

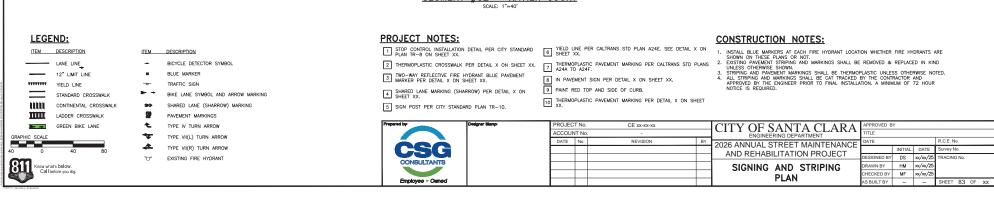

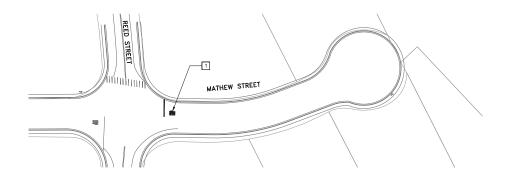

SEGMENT #53 - MATHEW STREET

SCALE: 1"=40'



12" LIMIT LINE TTTTTTTT

STANDARD CROSSWALK CONTINENTAL CROSSWALK ш

LADDER CROSSWALK GREEN BIKE LANE



ITEM DESCRIPTION

BICYCLE DETECTOR SYMBOL

BLUE MARKER

TRAFFIC SIGN

BIKE LANE SYMBOL AND ARROW MARKING

SHARED LANE (SHARROW) MARKING

PAVEMENT MARKINGS

TYPE VII(L) TURN ARROW

TYPE VII(R) TURN ARROW

EXISTING FIRE HYDRANT

#### **PROJECT NOTES:**


- TWO-WAY REFLECTIVE FIRE HYDRANT BLUE PAVEMENT MARKER PER DETAIL X ON SHEET XX.
- 4 SHARED LANE MARKING (SHARROW) PER DETAIL X ON SHEET XX.
- 5 SIGN POST PER CITY STANDARD PLAN TR-10.
- 1 STOP CONTROL INSTALLATION DETAIL PER CITY STANDARD 6 SHEET XX. 6 SHEET XX.
- 2 THERMOPLASTIC CROSSWALK PER DETAIL X ON SHEET XX. 7 THERMOPLASTIC PAVEMENT MARKING PER CALTRANS STD PLANS A24A TO A24F.
  - 8 IN PAVEMENT SIGN PER DETAIL X ON SHEET XX.
  - 9 PAINT RED TOP AND SIDE OF CURB.
  - $\fbox{10}$  THERMOPLASTIC PAVEMENT MARKING PER DETAIL X ON SHEET XX.


## **CONSTRUCTION NOTES:**


- INSTALL BLUE MARKERS AT EACH FIRE HYDRANT LOCATION WHETHER FIRE HYDRANTS ARE SHOWN ON THESE PLANS OR NOT.
   ENSITING PAURZENT STRIPING AND MARKINGS SHALL BE REMOVED & REPLACED IN KIND ENSITEMATE AND PAVEMENT MARKINGS SHALL BE THERMOPLASTIC UNLESS OTHERWISE NOTED.
   ALL STRIPING AND MARKINGS SHALL BE CAT TRACKED BY THE CONTRACTOR AND APPROVED BY THE ENGINEER PRIOR TO FINAL INSTALLATION. A MINIMUM OF 72 HOUR NOTICE IS REQUIRED.


PROJECT No. CE xx-xx-xx ACCOUNT No DATE No. REVISION

CITY OF SANTA CLARA 2026 ANNUAL STREET MAINTENANCE INITIAL DATE Survey No. AND REHABILITATION PROJECT DESIGNED BY DS xx/xx/25 DRAWN BY HM xx/xx/25 CHECKED BY MF xx/xx/25 SIGNING AND STRIPING PLAN AS BUILT BY - -SHEET 84 OF XX

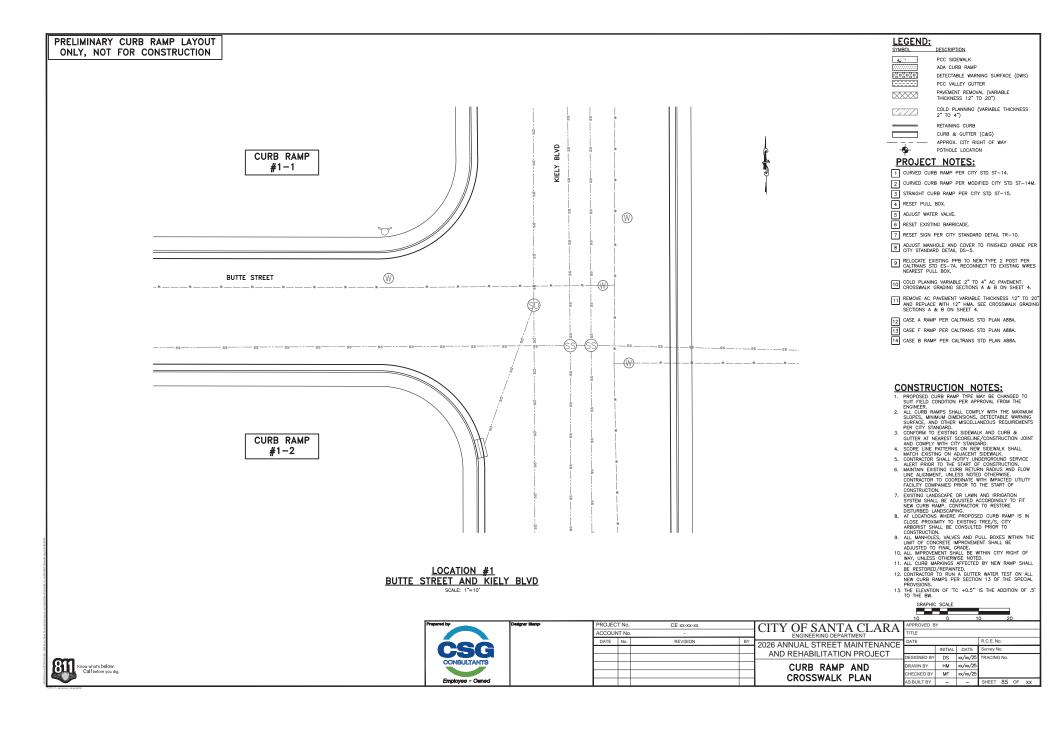

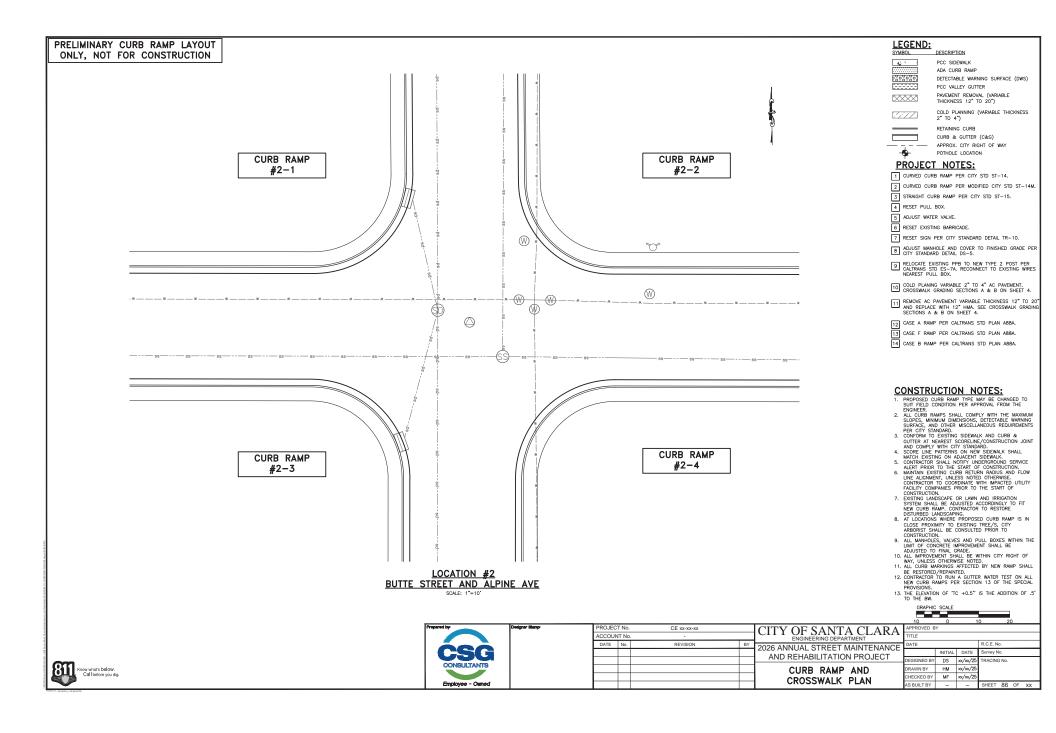

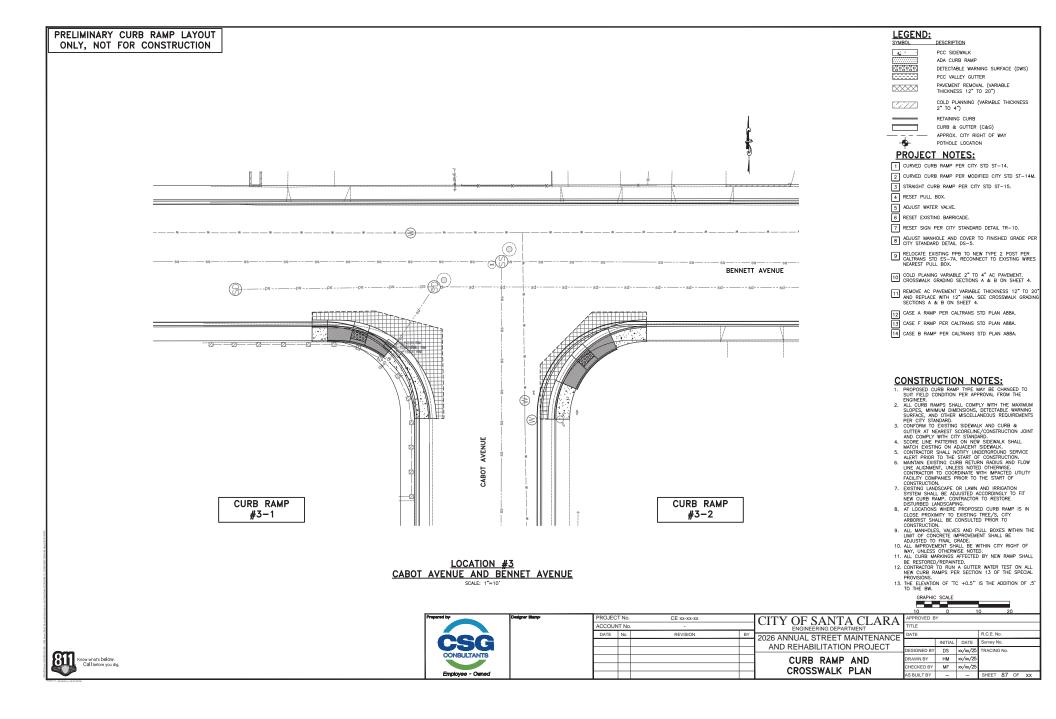

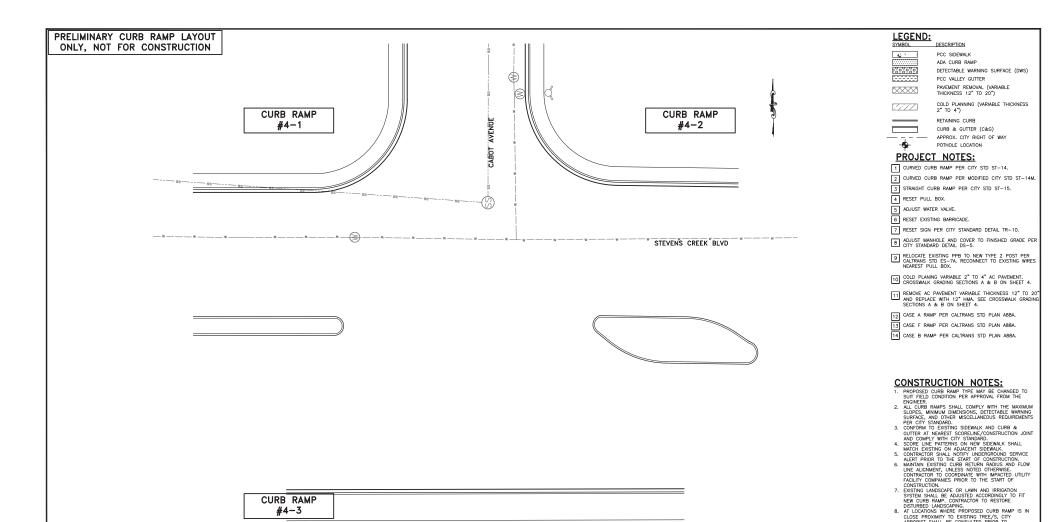

**LOCATION #4** CABOT AVENUE AND STEVENS CREEK BLVD

SCALE: 1"=10"

Prepared by
Á
<b>USU</b>
CONSULTANTS
Employee - Owned
Employee - Owned

CURB RAMP #4-3

PROJEC	T No.	CE xx-xx-xx		
ACCOUNT No.				
DATE	No.	REVISION	BY	

AT LOCATIONS WHERE PROPOSED CURB RAMP IS NO CLOSE PROMITY TO EXISTING TREE/S. CITY ARRONEST SHALL BE CONSULTED PRIOR TO ARRONEST SHALL BE CONSULTED PRIOR TO ALL MANH-PLOSE, VALVES AND PULL BOXES WITHIN THE LIMIT OF CONCRETE IMPROVEMENT SHALL BE ADJUSTED TO FINAL GRADE SHALL BE STANDED TO FINAL GRADE SHALL BE RESTORED/REPAINTED.

1. ALL CURB MARKINGS AFFECTED BY NEW RAMP SHALL BE RESTORED/REPAINTED.

1. CONTRACTOR TO RUN A GUITER WATER TEST ON ALL NEW CURB RAMPS PER SECTION 13 OF THE SPECIAL SHALL BE SHALL


CURB RAMP AND


CROSSWALK PLAN


13. THE ELEVATION OF 'TC +0.5" IS THE ADDITION OF .5' TO THE BW. GRAPHIC SCALE


CITY OF SANTA CLARA 2026 ANNUAL STREET MAINTENANCE INITIAL DATE urvey No. AND REHABILITATION PROJECT DESIGNED BY DS xx/xx/25 DRAWN BY HM xx/xx/25 CHECKED BY MF xx/xx/25 AS BUILT BY SHEET 88 OF XX




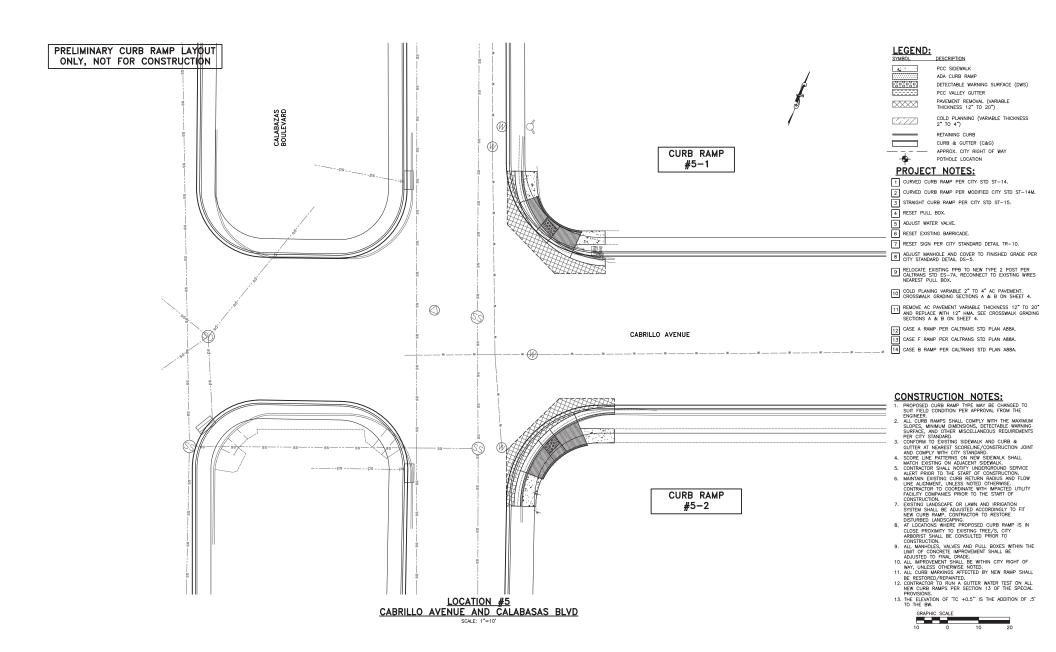


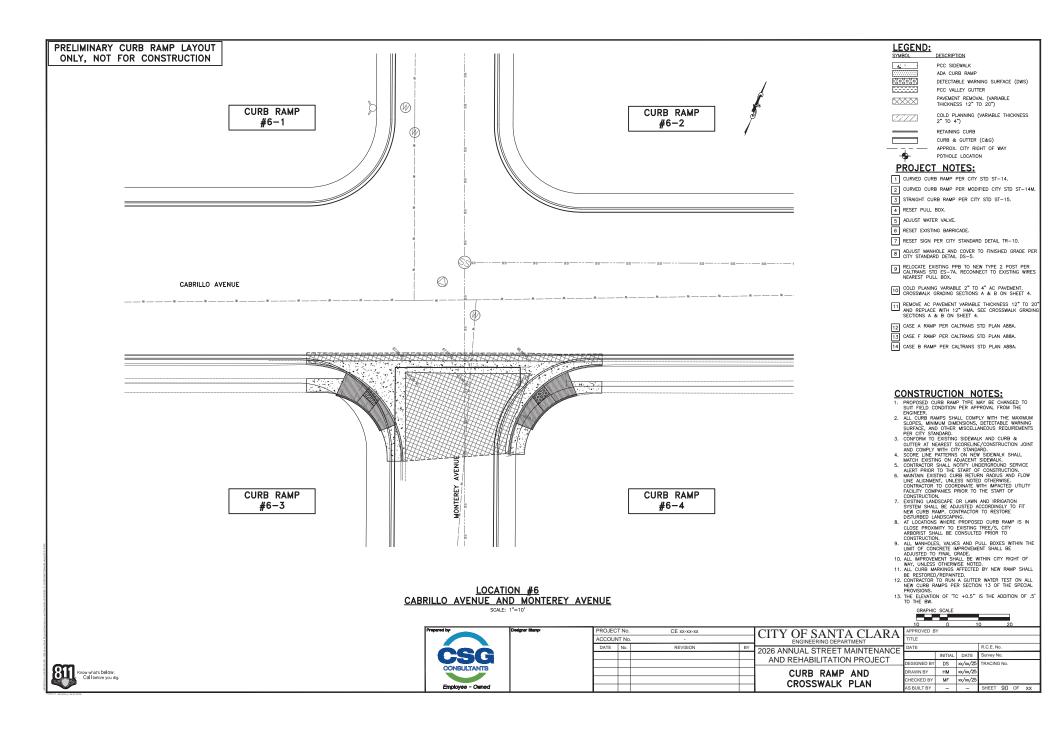


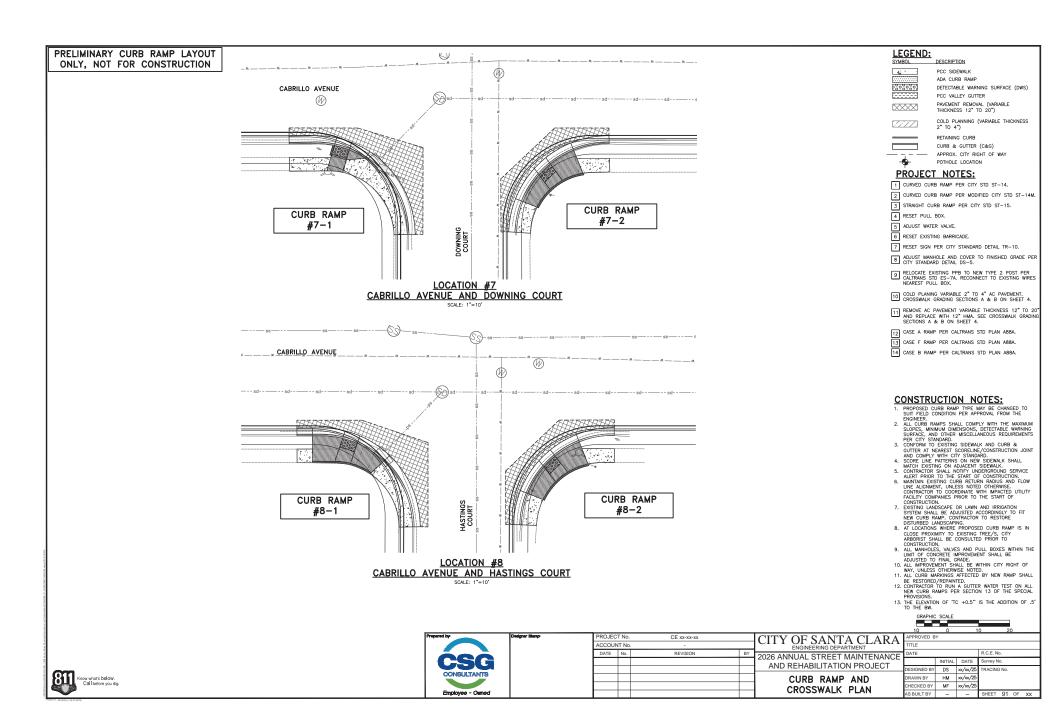


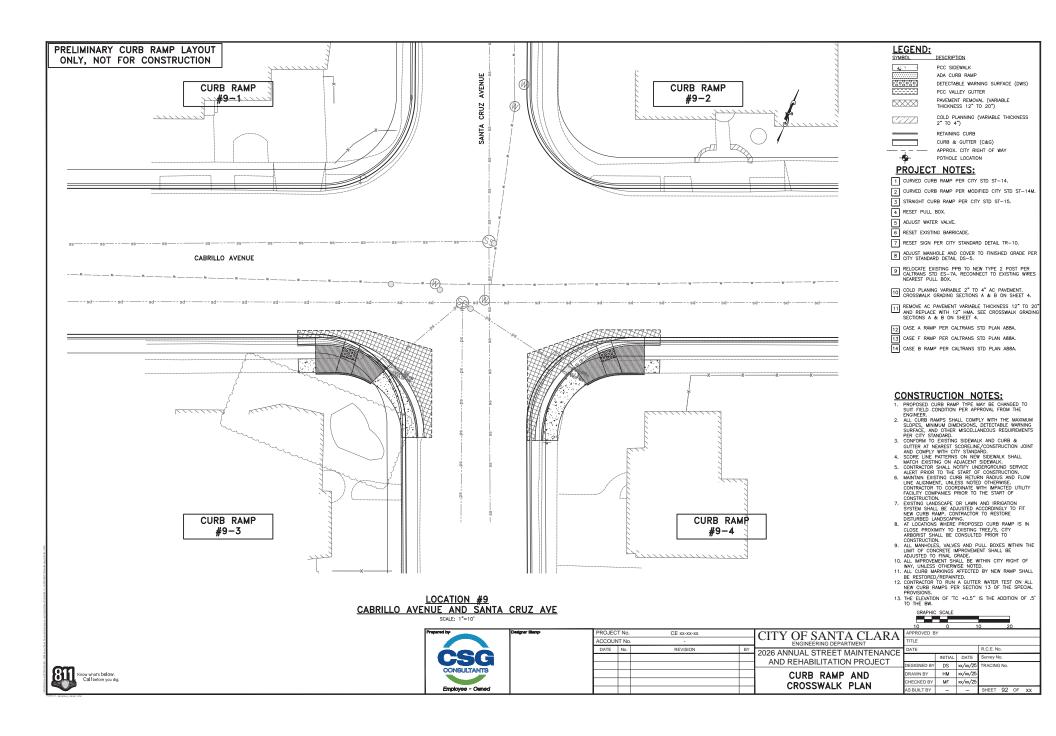

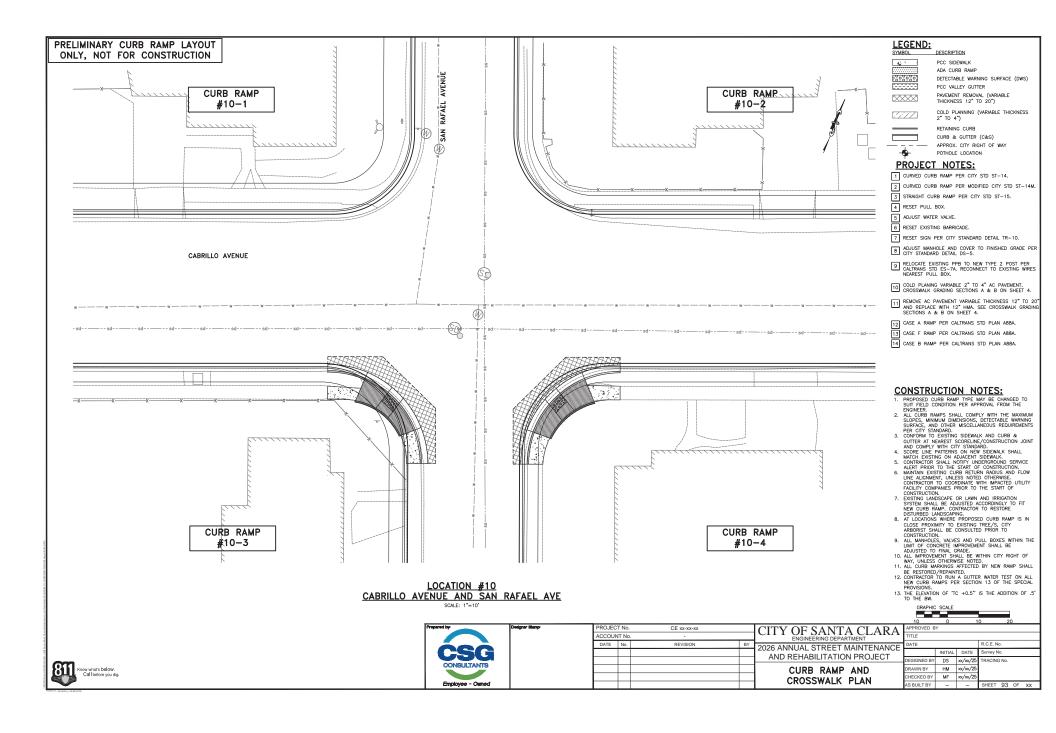

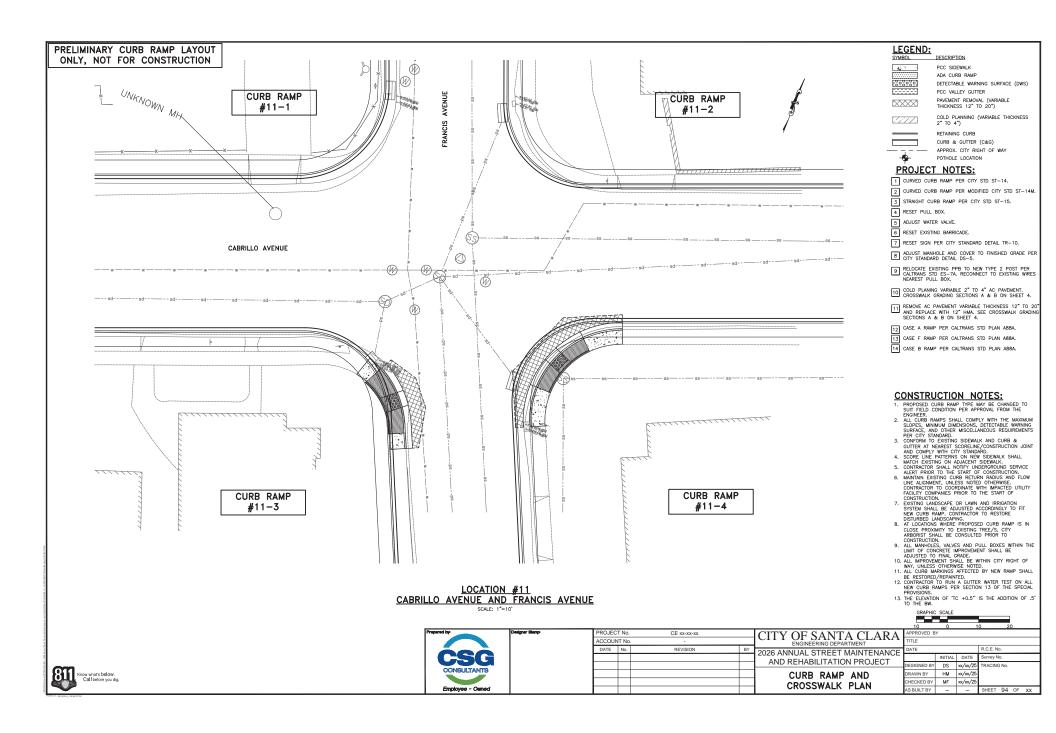


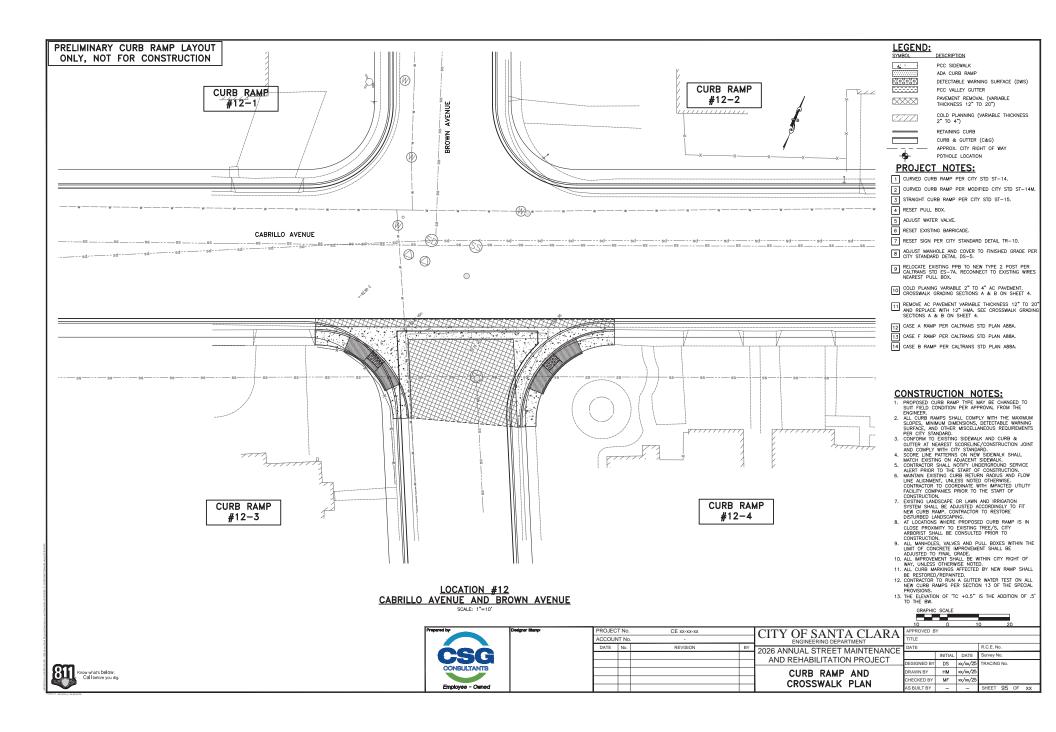

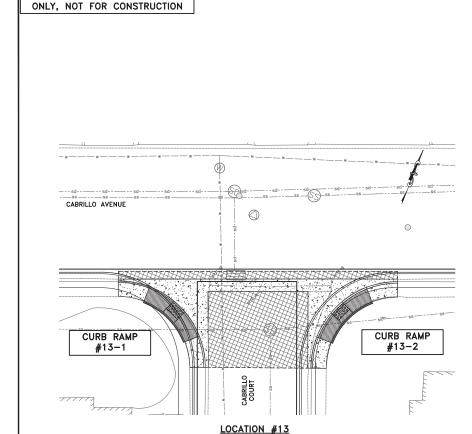

CABRILLO AVENUE AND CABRILLO COURT

PRELIMINARY CURB RAMP LAYOUT

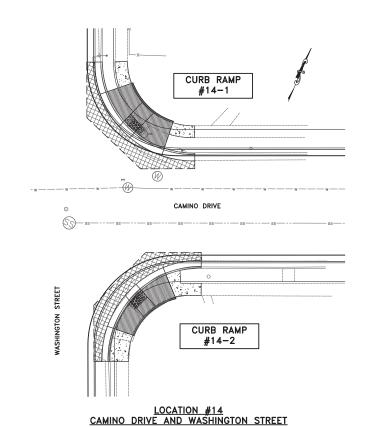

• POTHOLE LOCATION **PROJECT NOTES:** 

DESCRIPTION

PCC SIDEWALK ADA CURB RAMP

DETECTABLE WARNING SURFACE (DWS) PCC VALLEY GUTTER PAVEMENT REMOVAL (VARIABLE THICKNESS 12" TO 20")

COLD PLANNING (VARIABLE THICKNESS 2" TO 4")

1 CURVED CURB RAMP PER CITY STD ST-14.

RETAINING CURB CURB & GUTTER (C&G) APPROX. CITY RIGHT OF WAY

2 CURVED CURB RAMP PER MODIFIED CITY STD ST-14M.

3 STRAIGHT CURB RAMP PER CITY STD ST-15.

4 RESET PULL BOX.

LEGEND:

5808080

*577* 

5 ADJUST WATER VALVE.

6 RESET EXISTING BARRICADE.

7 RESET SIGN PER CITY STANDARD DETAIL TR-10.

B ADJUST MANHOLE AND COVER TO FINISHED GRADE PER CITY STANDARD DETAIL DS-5.

9 RELOCATE EXISTING PPB TO NEW TYPE 2 POST PER CALTRANS STD ES-7A. RECONNECT TO EXISTING WIRES NEAREST PULL BOX.

10 COLD PLANING VARIABLE 2" TO 4" AC PAVEMENT. CROSSWALK GRADING SECTIONS A & B ON SHEET 4.

11 REMOVE AC PAVEMENT VARIABLE THICKNESS 12" TO 20" AND REPLACE WITH 12" HMA. SEE CROSSWALK GRADING SECTIONS A & B ON SHEET 4.

12 CASE A RAMP PER CALTRANS STD PLAN A88A.

13 CASE F RAMP PER CALTRANS STD PLAN A88A.

14 CASE B RAMP PER CALTRANS STD PLAN A88A.

## **CONSTRUCTION NOTES:**

PROPOSED CURB RAMP TYPE MAY BE CHANGED TO SUIT FIELD CONDITION PER APPROVAL FROM THE

1. PEGINOSED CURB MAMP TYPE MAY BE CHANGED IN DEPONDED TO THE STATE CONTION OF APPROVAL FROM THE BURNERS.

2. ALL CURB RAMPS SHALL COMPLY WITH THE MAXIMUM SUPERS, MINIMUM DIMENSIONS, DETECTABLE WARNING SUPERACE, AND OTHER MISCELLANGOUS REQUIREMENTS.

3. CONFORM TO EXISTING SIDEMAK AND CURB A GUITTER AT NEAREST SCORELINE/CONSTRUCTION JOINT AND COMPLY WITH CITY STANDARD.

4. SCOPE LINE PATTERNS ON NEW SIDEMAK SHALL AND ADDRESS TO THE STATE OF CONSTRUCTION.

5. CONTRACTOR SHALL NOTHY UNDERGROUND SERVICE ALEET PRIOR TO THE START OF CONSTRUCTION.

6. MAINTAIN EXISTING CURB RETURN RADIUS AND FLOW LINE ALIGNMENT, UNLESS NOTED OTHERWISE.

6. CONTRACTOR SHALL NOTHY UNDERGROUND SERVICE OF CONSTRUCTION.

7. EXISTING CURB RETURN RADIUS AND FLOW LINE ALIGNMENT, UNLESS NOTED OTHERWISE.

7. EXISTING CURB REFORM TO THE START OF CONSTRUCTION.

7. EXISTING CURB REPORT TO THE START OF CONSTRUCTION.

8. AT LOCATIONS WHERE PROPOSED CURB RAMP IS IN CLOSE PROXYMITY TO EXISTING LANGESCHING TO TERESTORE.

AT LOCATIONS WHERE PROPOSED CURB RAMP IS NO CLOSE PROMITY TO EXISTING TREE/S. CITY ARRONEST SHALL BE CONSULTED PRIOR TO ARRONEST SHALL BE CONSULTED PRIOR TO ALL MANH-PLOSE, VALVES AND PULL BOXES WITHIN THE LIMIT OF CONCRETE IMPROVEMENT SHALL BE ADJUSTED TO FINAL GRADE SHALL BE STANDED TO FINAL GRADE SHALL BE RESTORED/REPAINTED.

1. ALL CURB MARKINGS AFFECTED BY NEW RAMP SHALL BE RESTORED/REPAINTED.

1. CONTRACTOR TO RUN A GUITER WATER TEST ON ALL NEW CURB RAMPS PER SECTION 13 OF THE SPECIAL SHALL BE SHALL


13. THE ELEVATION OF 'TC +0.5" IS THE ADDITION OF .5' TO THE BW. CRAPHIC SCALE





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	DATE	No.	REVISION	BY


CITY OF SANTA CLARA 2026 ANNUAL STREET MAINTENANCE INITIAL DATE AND REHABILITATION PROJECT DESIGNED BY DS xx/xx/25 DRAWN BY HM xx/xx/25 CURB RAMP AND CHECKED BY MF xx/xx/25 CROSSWALK PLAN




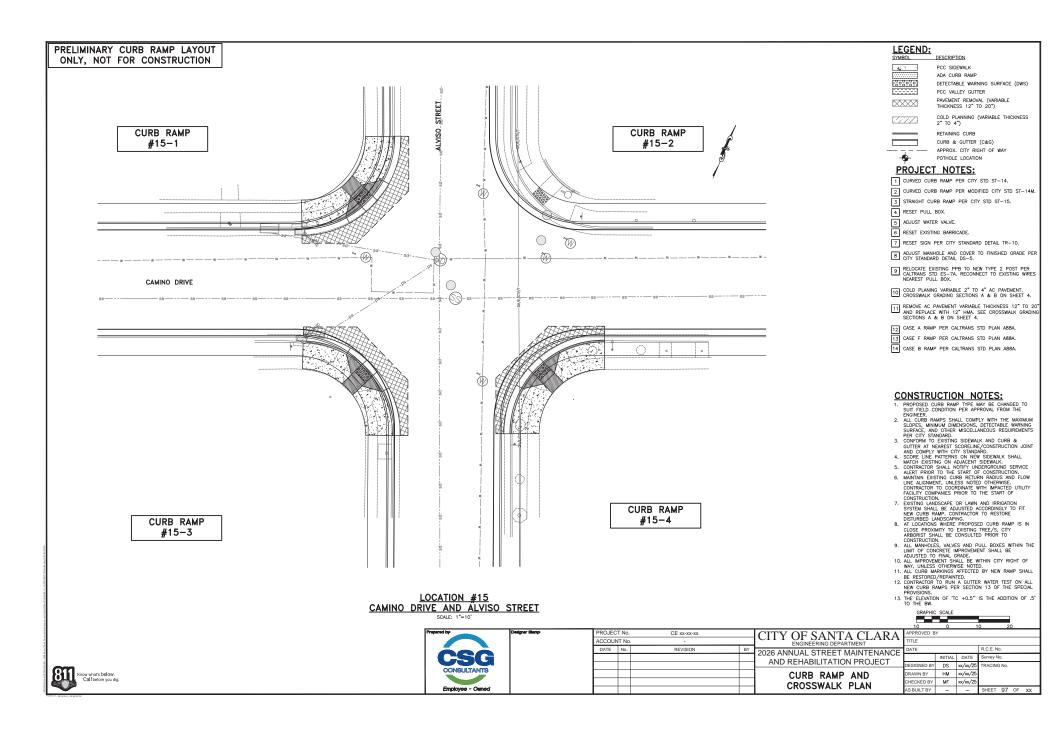


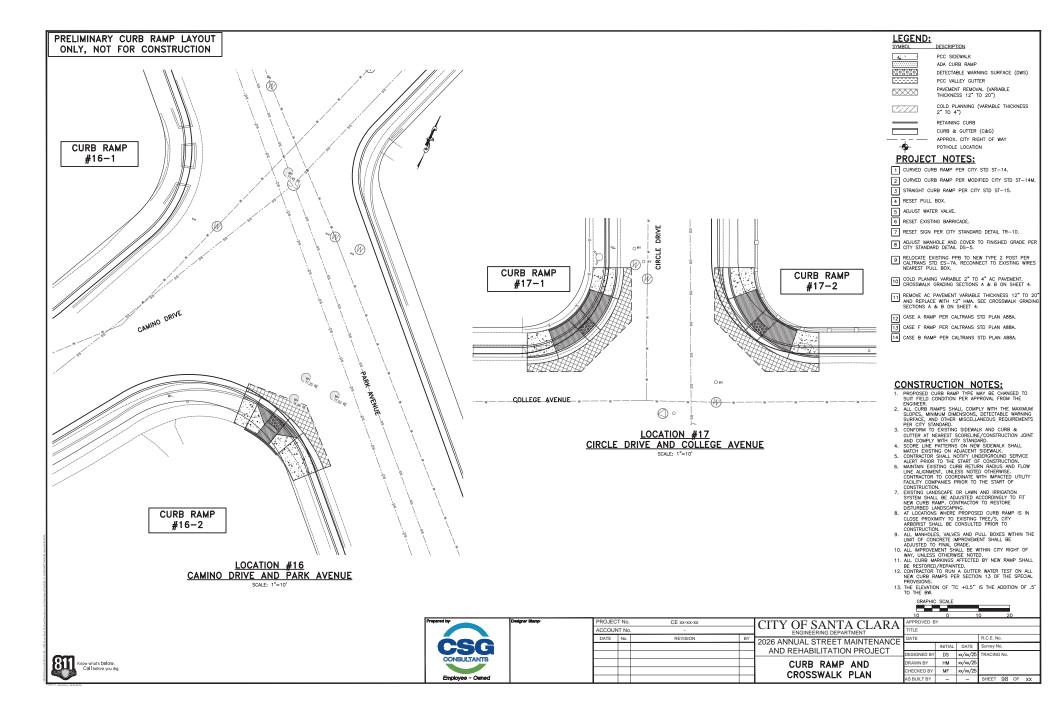

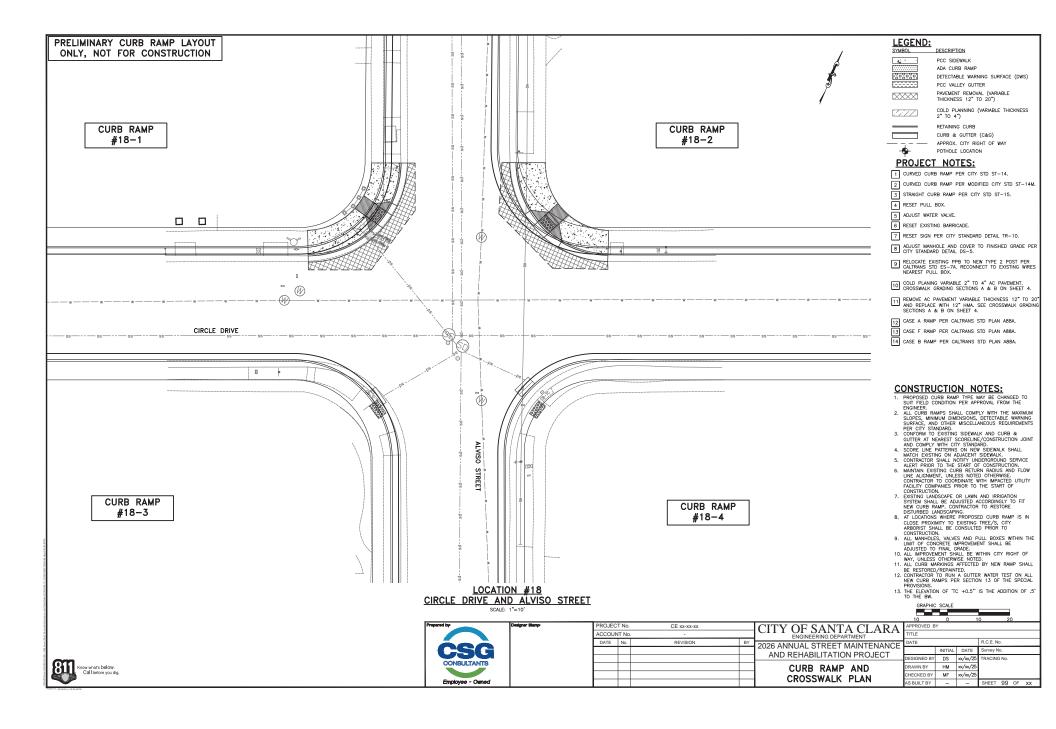

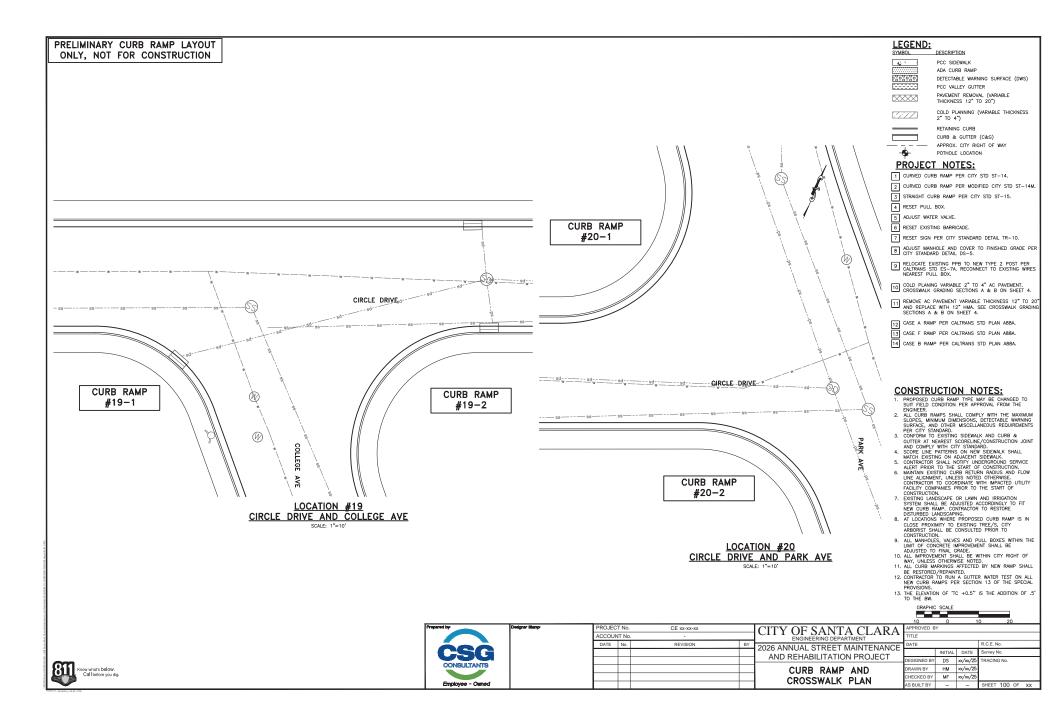

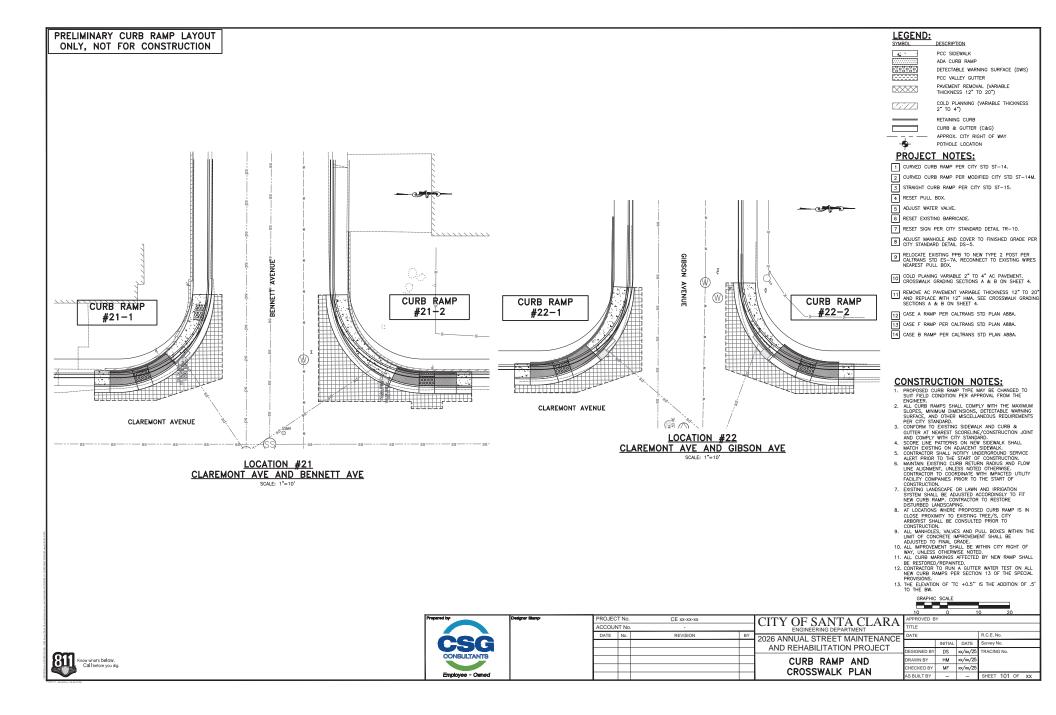

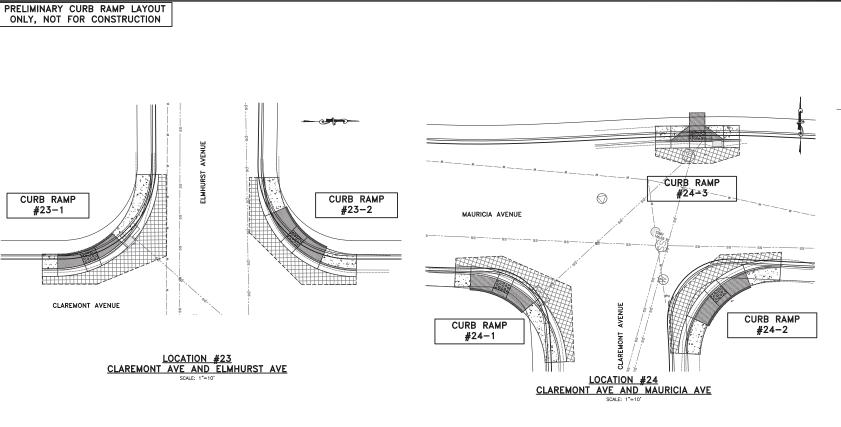

LEGEND: DESCRIPTION

PCC SIDEWALK

ADA CURB RAMP 5808080 DETECTABLE WARNING SURFACE (DWS)

PCC VALLEY GUTTER

PAVEMENT REMOVAL (VARIABLE THICKNESS 12" TO 20") 

COLD PLANNING (VARIABLE THICKNESS 2" TO 4") 5773 RETAINING CURB

CURB & GUTTER (C&G) APPROX. CITY RIGHT OF WAY POTHOLE LOCATION

#### **PROJECT NOTES:**

- 1 CURVED CURB RAMP PER CITY STD ST-14.
- 2 CURVED CURB RAMP PER MODIFIED CITY STD ST-14M.
- 3 STRAIGHT CURB RAMP PER CITY STD ST-15.
- 4 RESET PULL BOX.
- 5 ADJUST WATER VALVE.
- 6 RESET EXISTING BARRICADE.
- 7 RESET SIGN PER CITY STANDARD DETAIL TR-10.
- B ADJUST MANHOLE AND COVER TO FINISHED GRADE PER CITY STANDARD DETAIL DS-5.
- 9 RELOCATE EXISTING PPB TO NEW TYPE 2 POST PER CALTRANS STD ES-7A. RECONNECT TO EXISTING WIRES NEAREST PULL BOX.
- 10 COLD PLANING VARIABLE 2" TO 4" AC PAVEMENT. CROSSWALK GRADING SECTIONS A & B ON SHEET 4.
- 11 REMOVE AC PAVEMENT VARIABLE THICKNESS 12" TO 20" AND REPLACE WITH 12" HMA. SEE CROSSWALK GRADING SECTIONS A & B ON SHEET 4.
- 12 CASE A RAMP PER CALTRANS STD PLAN A88A.
- 13 CASE F RAMP PER CALTRANS STD PLAN A88A.
- 14 CASE B RAMP PER CALTRANS STD PLAN A88A.

## **CONSTRUCTION NOTES:**

- PROPOSED CURB RAMP TYPE MAY BE CHANGED TO SUIT FIELD CONDITION PER APPROVAL FROM THE

- 1. PEGINOSED CURB MAMP TYPE MAY BE CHANGED IN DEPONDED TO THE STATE CONTION OF APPROVAL FROM THE BURNERS.

  2. ALL CURB RAMPS SHALL COMPLY WITH THE MAXIMUM SUPERS, MINIMUM DIMENSIONS, DETECTABLE WARNING SUPERACE, AND OTHER MISCELLANGOUS REQUIREMENTS.

  3. CONFORM TO EXISTING SIDEMAK AND CURB A GUITTER AT NEAREST SCORELINE/CONSTRUCTION JOINT AND COMPLY WITH CITY STANDARD.

  4. SCOPE LINE PATTERNS ON NEW SIDEMAK SHALL AND ADDRESS TO THE STATE OF CONSTRUCTION.

  5. CONTRACTOR SHALL NOTHY UNDERGROUND SERVICE ALEET PRIOR TO THE START OF CONSTRUCTION.

  6. MAINTAIN EXISTING CURB RETURN RADIUS AND FLOW LINE ALIGNMENT, UNLESS NOTED OTHERWISE.

  6. CONTRACTOR SHALL NOTHY UNDERGROUND SERVICE OF CONSTRUCTION.

  7. EXISTING CURB RETURN RADIUS AND FLOW LINE ALIGNMENT, UNLESS NOTED OTHERWISE.

  7. EXISTING CURB REFORM TO THE START OF CONSTRUCTION.

  7. EXISTING CURB REPORT TO THE START OF CONSTRUCTION.

  8. AT LOCATIONS WHERE PROPOSED CURB RAMP IS IN CLOSE PROXYMITY TO EXISTING LANGESCHING TO TERESTORE.

- AT LOCATIONS WHERE PROPOSED CURB RAMP IS NO CLOSE PROMITY TO EXISTING TREE/S. CITY ARRONEST SHALL BE CONSULTED PRIOR TO ARRONEST SHALL BE CONSULTED PRIOR TO ALL MANH-PLOSE, VALVES AND PULL BOXES WITHIN THE LIMIT OF CONCRETE IMPROVEMENT SHALL BE ADJUSTED TO FINAL GRADE SHALL BE STANDED TO FINAL GRADE SHALL BE RESTORED/REPAINTED.

  1. ALL CURB MARKINGS AFFECTED BY NEW RAMP SHALL BE RESTORED/REPAINTED.

  1. CONTRACTOR TO RUN A GUITER WATER TEST ON ALL NEW CURB RAMPS PER SECTION 13 OF THE SPECIAL SHALL BE SHALL

- 13. THE ELEVATION OF 'TC +0.5" IS THE ADDITION OF .5' TO THE BW. CRAPHIC SCALE




PROJECT No CE xx-xx-xx ACCOUNT No DATE No. REVISION


CITY OF SANTA CLARA 2026 ANNUAL STREET MAINTENANCE AND REHABILITATION PROJECT CURB RAMP AND


CROSSWALK PLAN

INITIAL DATE urvey No. DESIGNED BY DS xx/xx/25 DRAWN BY HM xx/xx/25 CHECKED BY MF xx/xx/25 AS BUILT BY



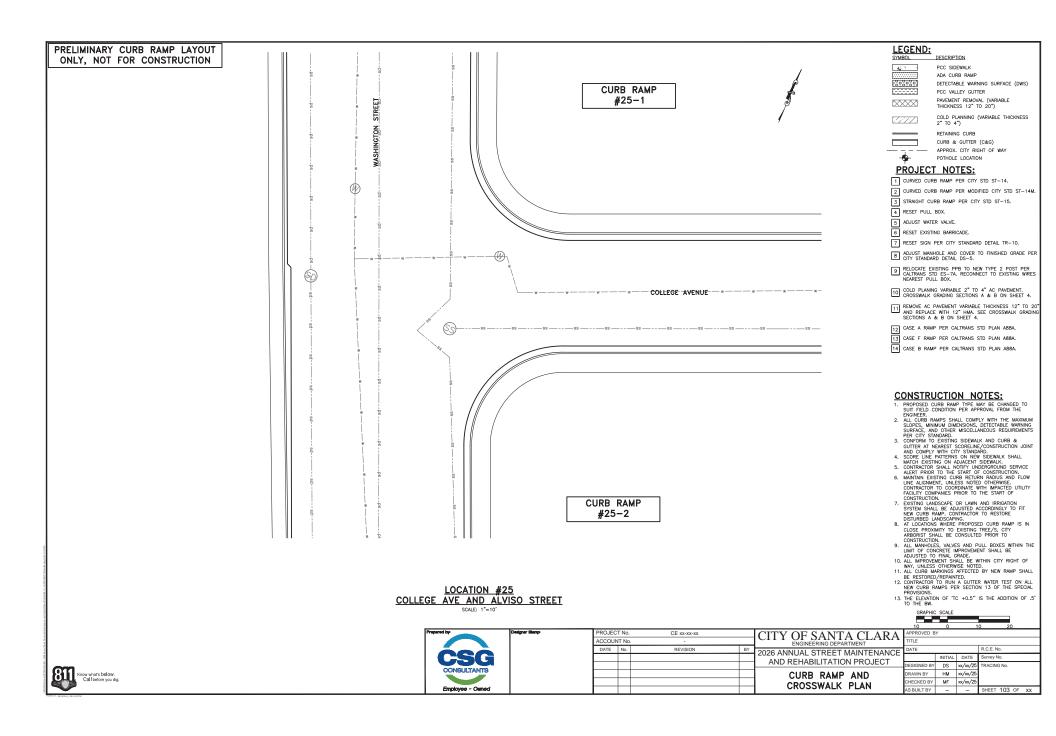

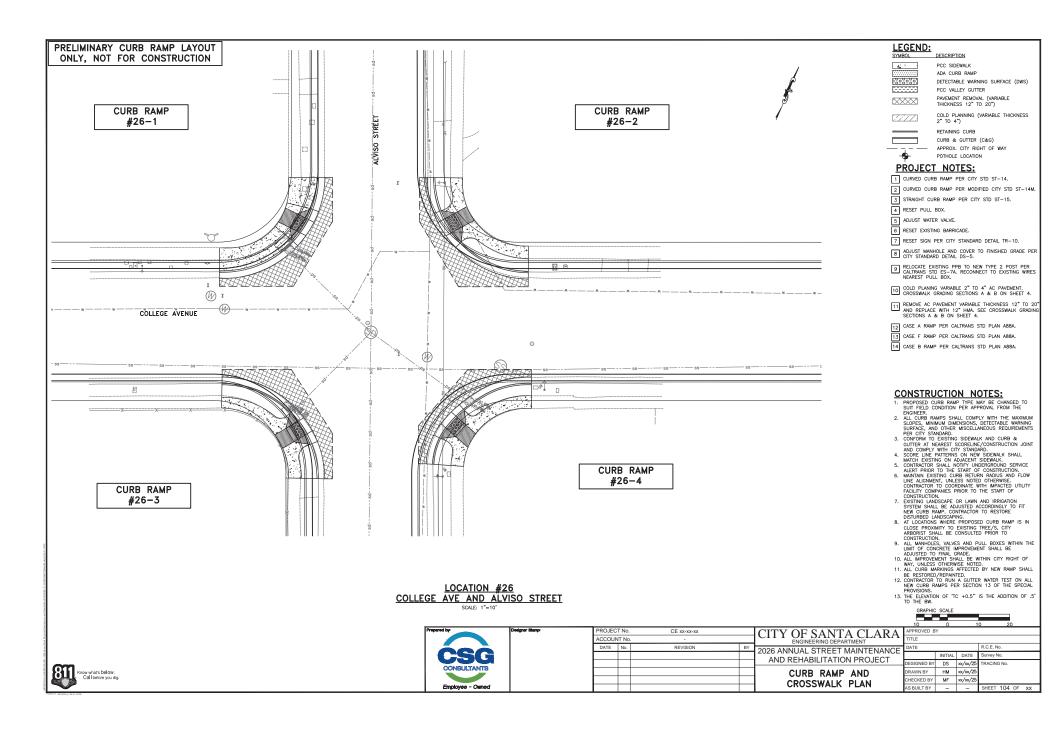

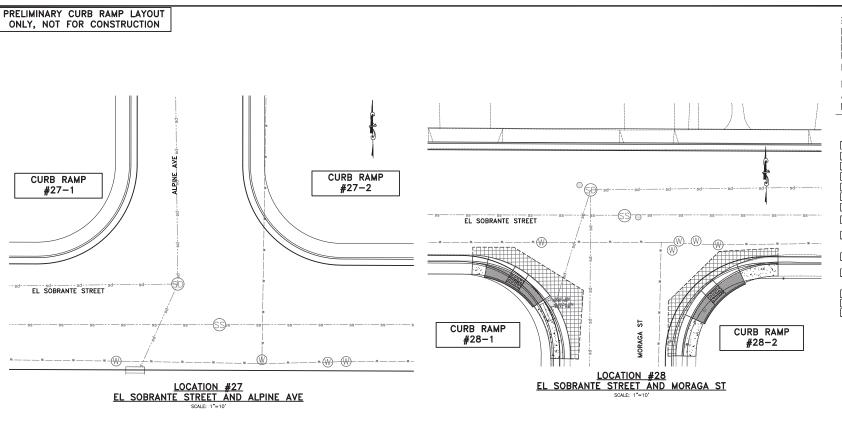

LEGEND: DESCRIPTION

PCC SIDEWALK

ADA CURB RAMP

5808080 DETECTABLE WARNING SURFACE (DWS) PCC VALLEY GUTTER

PAVEMENT REMOVAL (VARIABLE THICKNESS 12" TO 20") 

COLD PLANNING (VARIABLE THICKNESS 2" TO 4") RETAINING CURB

CURB & GUTTER (C&G) APPROX. CITY RIGHT OF WAY POTHOLE LOCATION

#### **PROJECT NOTES:**

- 1 CURVED CURB RAMP PER CITY STD ST-14.
- 2 CURVED CURB RAMP PER MODIFIED CITY STD ST-14M.
- 3 STRAIGHT CURB RAMP PER CITY STD ST-15.
- 4 RESET PULL BOX.
- 5 ADJUST WATER VALVE.
- 6 RESET EXISTING BARRICADE.
- 7 RESET SIGN PER CITY STANDARD DETAIL TR-10.
- B ADJUST MANHOLE AND COVER TO FINISHED GRADE PER CITY STANDARD DETAIL DS-5.
- 9 RELOCATE EXISTING PPB TO NEW TYPE 2 POST PER CALTRANS STD ES-7A. RECONNECT TO EXISTING WIRES NEAREST PULL BOX.
- 10 COLD PLANING VARIABLE 2" TO 4" AC PAVEMENT. CROSSWALK GRADING SECTIONS A & B ON SHEET 4.
- 11 REMOVE AC PAVEMENT VARIABLE THICKNESS 12" TO 20" AND REPLACE WITH 12" HMA. SEE CROSSWALK GRADING SECTIONS A & B ON SHEET 4.
- 12 CASE A RAMP PER CALTRANS STD PLAN A88A.
- 13 CASE F RAMP PER CALTRANS STD PLAN A88A.
- 14 CASE B RAMP PER CALTRANS STD PLAN A88A.

## **CONSTRUCTION NOTES:**

- PROPOSED CURB RAMP TYPE MAY BE CHANGED TO SUIT FIELD CONDITION PER APPROVAL FROM THE

- 1. PEGINOSED CURB MAMP TYPE MAY BE CHANGED IN DEPONDED TO THE STATE CONTION OF APPROVAL FROM THE BURNERS.

  2. ALL CURB RAMPS SHALL COMPLY WITH THE MAXIMUM SUPERS, MINIMUM DIMENSIONS, DETECTABLE WARNING SUPERACE, AND OTHER MISCELLANGOUS REQUIREMENTS.

  3. CONFORM TO EXISTING SIDEMAK AND CURB A GUITTER AT NEAREST SCORELINE/CONSTRUCTION JOINT AND COMPLY WITH CITY STANDARD.

  4. SCOPE LINE PATTERNS ON NEW SIDEMAK SHALL AND ADDRESS TO THE STATE OF CONSTRUCTION.

  5. CONTRACTOR SHALL NOTHY UNDERGROUND SERVICE ALEET PRIOR TO THE START OF CONSTRUCTION.

  6. MAINTAIN EXISTING CURB RETURN RADIUS AND FLOW LINE ALIGNMENT, UNLESS NOTED OTHERWISE.

  6. CONTRACTOR SHALL NOTHY UNDERGROUND SERVICE OF CONSTRUCTION.

  7. EXISTING CURB RETURN RADIUS AND FLOW LINE ALIGNMENT, UNLESS NOTED OTHERWISE.

  7. EXISTING CURB REFORM TO THE START OF CONSTRUCTION.

  7. EXISTING CURB REPORT TO THE START OF CONSTRUCTION.

  8. AT LOCATIONS WHERE PROPOSED CURB RAMP IS IN CLOSE PROXYMITY TO EXISTING LANGESCHING TO TERESTORE.

- AT LOCATIONS WHERE PROPOSED CURB RAMP IS NO CLOSE PROMITY TO EXISTING TREE/S. CITY ARRONEST SHALL BE CONSULTED PRIOR TO ARRONEST SHALL BE CONSULTED PRIOR TO ALL MANH-PLOSE, VALVES AND PULL BOXES WITHIN THE LIMIT OF CONCRETE IMPROVEMENT SHALL BE ADJUSTED TO FINAL GRADE SHALL BE STANDED TO FINAL GRADE SHALL BE RESTORED/REPAINTED.

  1. ALL CURB MARKINGS AFFECTED BY NEW RAMP SHALL BE RESTORED/REPAINTED.

  1. CONTRACTOR TO RUN A GUITER WATER TEST ON ALL NEW CURB RAMPS PER SECTION 13 OF THE SPECIAL SHALL BE SHALL

- 13. THE ELEVATION OF 'TC +0.5" IS THE ADDITION OF .5' TO THE BW.






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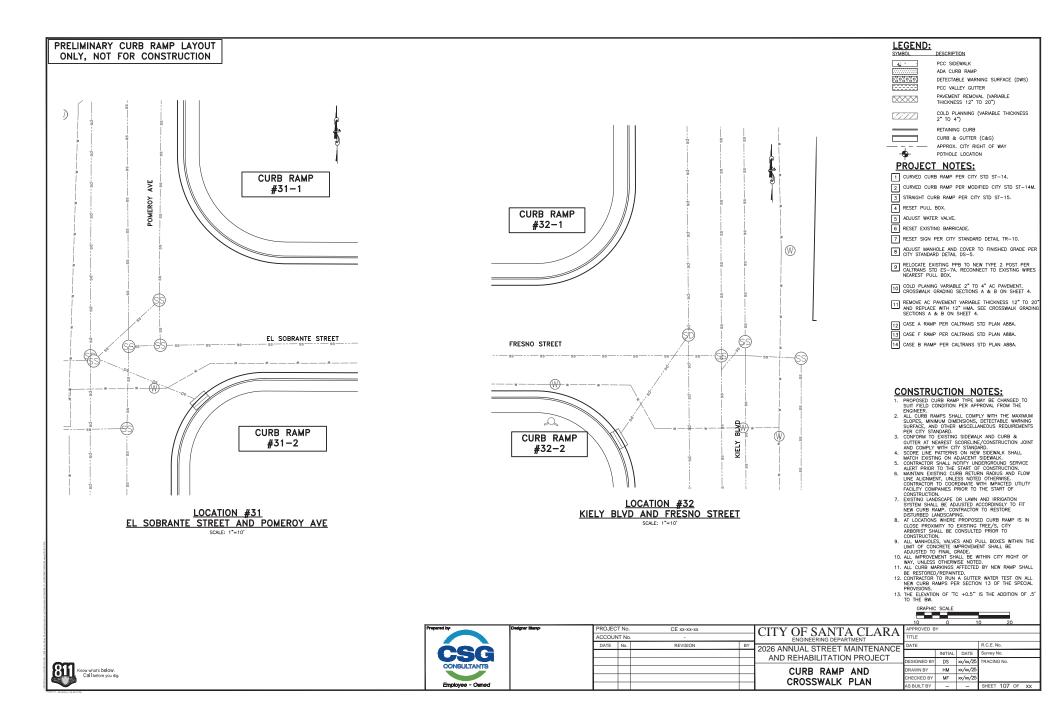
CITY OF SANTA CLARA 2026 ANNUAL STREET MAINTENANCE AND REHABILITATION PROJECT CURB RAMP AND


CROSSWALK PLAN


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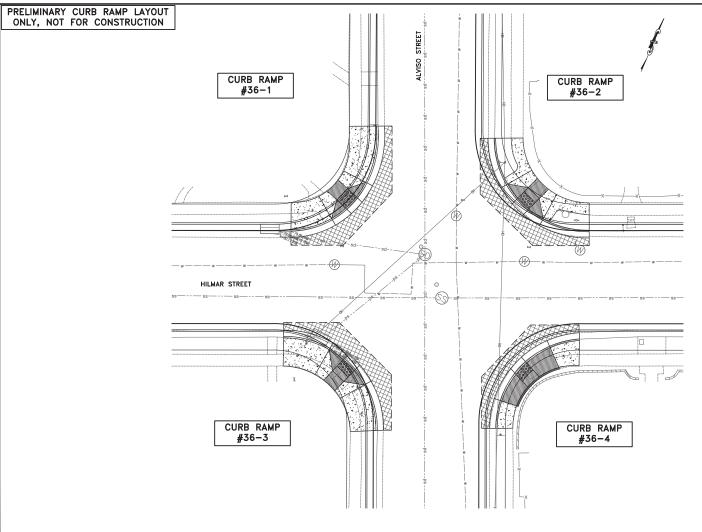






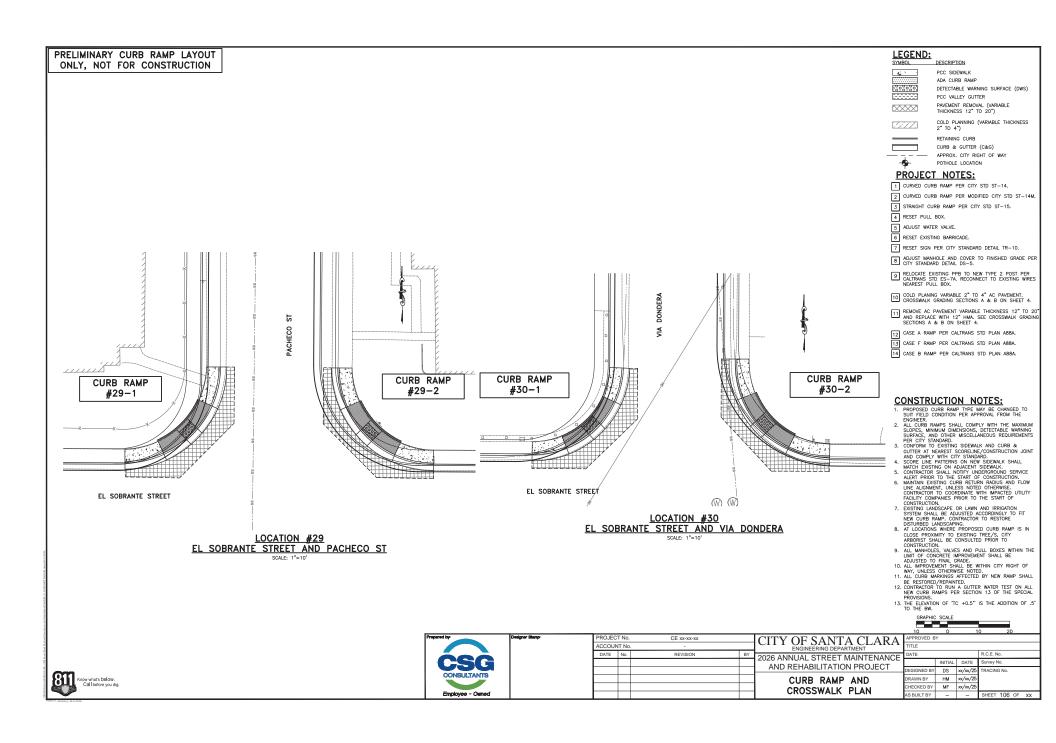

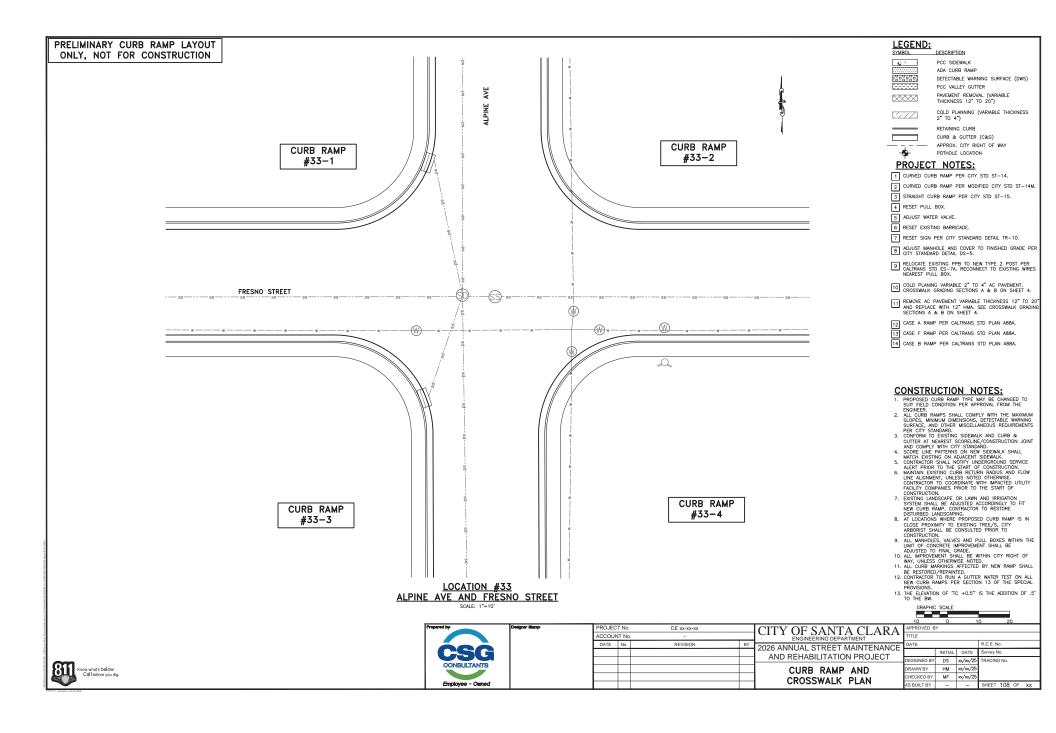

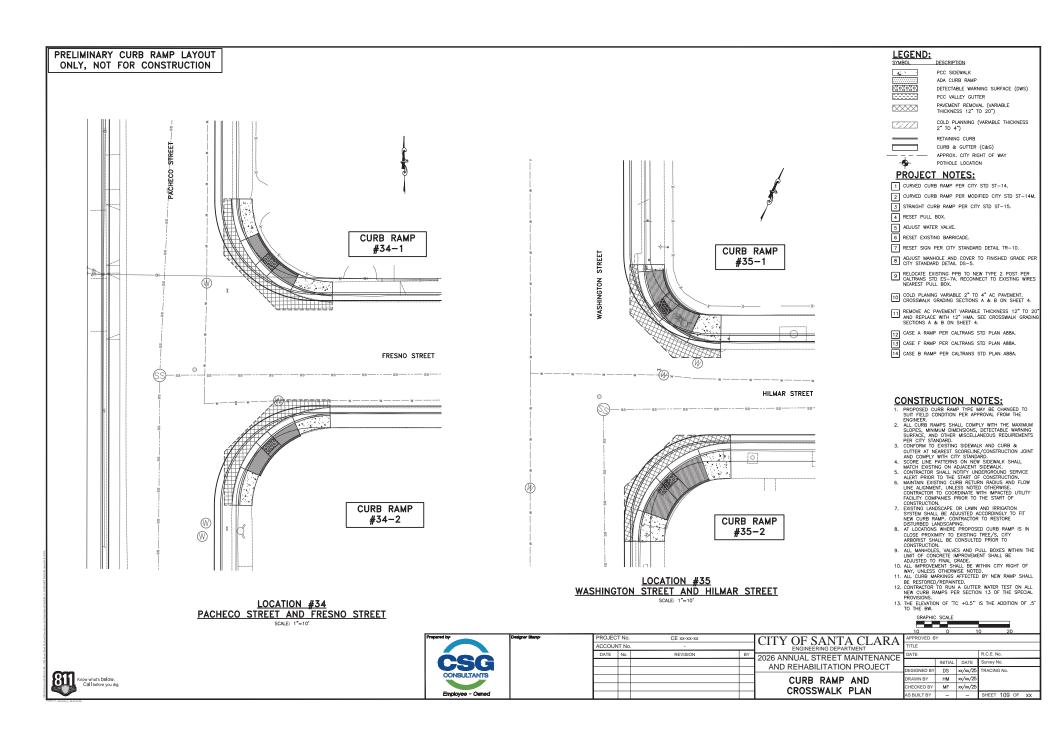

LOCATION #36 HILMAR STREET AND ÄLVISO STREET LEGEND:

DESCRIPTION PCC SIDEWALK

ADA CURB RAMP

DETECTABLE WARNING SURFACE (DWS) PCC VALLEY GUTTER

PAVEMENT REMOVAL (VARIABLE THICKNESS 12" TO 20") 

COLD PLANNING (VARIABLE THICKNESS 2" TO 4")

RETAINING CURB CURB & GUTTER (C&G) APPROX. CITY RIGHT OF WAY

## **PROJECT NOTES:**

- POTHOLE LOCATION 1 CURVED CURB RAMP PER CITY STD ST-14.
- 2 CURVED CURB RAMP PER MODIFIED CITY STD ST-14M.
- 3 STRAIGHT CURB RAMP PER CITY STD ST-15.
- 4 RESET PULL BOX.
- 5 ADJUST WATER VALVE.
- 6 RESET EXISTING BARRICADE.
- 7 RESET SIGN PER CITY STANDARD DETAIL TR-10.
- B ADJUST MANHOLE AND COVER TO FINISHED GRADE PER CITY STANDARD DETAIL DS-5.
- 9 RELOCATE EXISTING PPB TO NEW TYPE 2 POST PER CALTRANS STD ES-7A. RECONNECT TO EXISTING WIRES NEAREST PULL BOX.
- 10 COLD PLANING VARIABLE 2" TO 4" AC PAVEMENT. CROSSWALK GRADING SECTIONS A & B ON SHEET 4.
- [11] REMOVE AC PAVEMENT VARIABLE THICKNESS 12" TO 20"
  AND REPLACE WITH 12" HMA. SEE CROSSWALK GRADING SECTIONS A & B ON SHEET 4.
- 12 CASE A RAMP PER CALTRANS STD PLAN A88A.
- 13 CASE F RAMP PER CALTRANS STD PLAN A88A.
- 14 CASE B RAMP PER CALTRANS STD PLAN A88A.

#### **CONSTRUCTION NOTES:**

- PROPOSED CURB RAMP TYPE MAY BE CHANGED TO SUIT FIELD CONDITION PER APPROVAL FROM THE

- 1. PROPOSED CURE MAMP TYPE MAY BE CHANGED IN SEMENTARY CONDITION FOR APPROVAL FROM THE ENDINEER.

  2. ALL CURB RAMPS SHALL COMPLY WITH THE MAXIMUM DIMENSION, DETECTABLE WARNING SURFACE, AND OTHER MISCELLANEOUS REQUIREMENTS.

  3. CONFORM TO EXISTING SUBJECTABLE WARNING SURFACE, AND OTHER MISCELLANEOUS REQUIREMENTS.

  3. CONFORM TO EXISTING SUBJECTABLE WARNING SINTAL AND COMPLY WITH CITY STANDARD.

  4. SCONE LINE FAITERIS ON NEW SUBWALL SHALL AND COMPLY WITH CITY STANDARD.

  5. CONTRACTOR SHALL NOTHER TANDARD SERVICE ALERT PRIOR TO THE START OF CONSTRUCTION.

  5. CONTRACTOR SHALL NOTHER WAS DECOUNTED TO THE START OF CONSTRUCTION.

  5. MANTAIN AUSTRING CURB RETURN RADIUS AND FLOW LINE ALGAMENT, UNLESS NOTED OTHERWISE.

  5. CONTRACTOR SHALL NOTHER WAS DECOUNTED TO THE START OF CONSTRUCTION.

  5. EXISTING CURB RESULTS ACCORDINGLY OF IT SHALL - AT LOCATIONS WHERE PROPOSED CURB RAMP IS NO CLOSE PROMITY TO EXISTING TREE/S. CITY ARRONEST SHALL BE CONSULTED PRIOR TO ARRONEST SHALL BE CONSULTED PRIOR TO ALL MANH-PLOSE, VALVES AND PULL BOXES WITHIN THE LIMIT OF CONCRETE IMPROVEMENT SHALL BE ADJUSTED TO FINAL GRADE SHALL BE STANDED TO FINAL GRADE SHALL BE RESTORED/REPAINTED.

  1. ALL CURB MARKINGS AFFECTED BY NEW RAMP SHALL BE RESTORED/REPAINTED.

  1. CONTRACTOR TO RUN A GUITER WATER TEST ON ALL NEW CURB RAMPS PER SECTION 13 OF THE SPECIAL SHALL BE SHALL

- 13. THE ELEVATION OF 'TC +0.5" IS THE ADDITION OF .5' TO THE BW. CRAPHIC SCALE




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CITY OF SANTA CLARA 2026 ANNUAL STREET MAINTENANCE AND REHABILITATION PROJECT


CURB RAMP AND CROSSWALK PLAN


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PRELIMINARY CURB RAMP LAYOUT ONLY, NOT FOR CONSTRUCTION



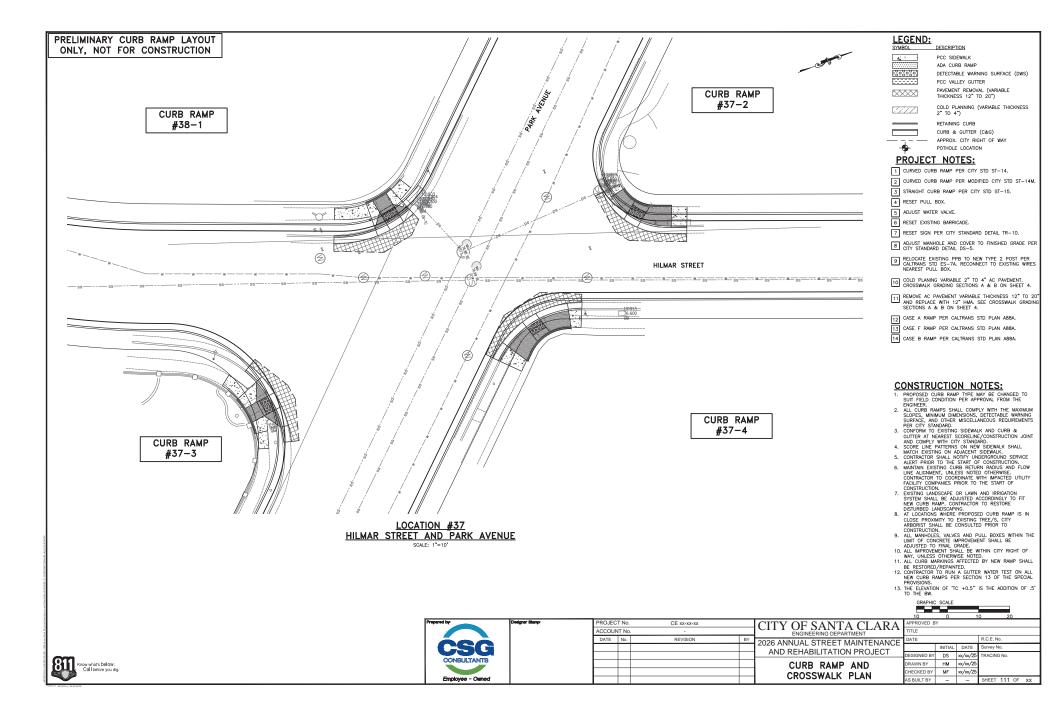

LOCATION #39 HILMAR STREET AND THE ALAMEDA SCALE: 1"=10"

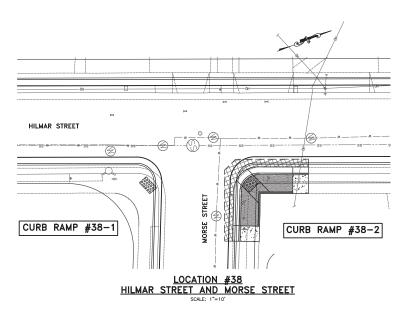LEGEND:

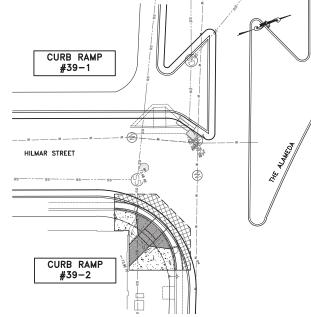DESCRIPTION PCC SIDEWALK

ADA CURB RAME

DETECTABLE WARNING SURFACE (DWS) PCC VALLEY GUTTER

PAVEMENT REMOVAL (VARIABLE THICKNESS 12" TO 20") 

COLD PLANNING (VARIABLE THICKNESS 2" TO 4")

RETAINING CURB CURB & GUTTER (C&G) APPROX. CITY RIGHT OF WAY • POTHOLE LOCATION

## **PROJECT NOTES:**

- 1 CURVED CURB RAMP PER CITY STD ST-14.
- 2 CURVED CURB RAMP PER MODIFIED CITY STD ST-14M.
- 3 STRAIGHT CURB RAMP PER CITY STD ST-15.
- 4 RESET PULL BOX.
- 5 ADJUST WATER VALVE.
- 6 RESET EXISTING BARRICADE.
- 7 RESET SIGN PER CITY STANDARD DETAIL TR-10.
- B ADJUST MANHOLE AND COVER TO FINISHED GRADE PER CITY STANDARD DETAIL DS-5.
- 9 RELOCATE EXISTING PPB TO NEW TYPE 2 POST PER CALTRANS STD ES-7A. RECONNECT TO EXISTING WIRES NEAREST PULL BOX.
- 10 COLD PLANING VARIABLE 2" TO 4" AC PAVEMENT. CROSSWALK GRADING SECTIONS A & B ON SHEET 4.
- [11] REMOVE AC PAVEMENT VARIABLE THICKNESS 12" TO 20"
  AND REPLACE WITH 12" HMA. SEE CROSSWALK GRADING SECTIONS A & B ON SHEET 4.
- 12 CASE A RAMP PER CALTRANS STD PLAN A88A.
- 13 CASE F RAMP PER CALTRANS STD PLAN A88A.
- 14 CASE B RAMP PER CALTRANS STD PLAN A88A.

## **CONSTRUCTION NOTES:**

- PROPOSED CURB RAMP TYPE MAY BE CHANGED TO SUIT FIELD CONDITION PER APPROVAL FROM THE

- 1. PEGINOSED CURB MAMP TYPE MAY BE CHANGED IN DEPONDED TO THE STATE CONTION OF APPROVAL FROM THE BURNERS.

  2. ALL CURB RAMPS SHALL COMPLY WITH THE MAXIMUM SUPERS, MINIMUM DIMENSIONS, DETECTABLE WARNING SUPERACE, AND OTHER MISCELLANGOUS REQUIREMENTS.

  3. CONFORM TO EXISTING SIDEMAK AND CURB A GUITTER AT NEAREST SCORELINE/CONSTRUCTION JOINT AND COMPLY WITH CITY STANDARD.

  4. SCOPE LINE PATTERNS ON NEW SIDEMAK SHALL AND ADDRESS TO THE STATE OF CONSTRUCTION.

  5. CONTRACTOR SHALL NOTHY UNDERGROUND SERVICE ALEET PRIOR TO THE START OF CONSTRUCTION.

  6. MAINTAIN EXISTING CURB RETURN RADIUS AND FLOW LINE ALIGNMENT, UNLESS NOTED OTHERWISE.

  6. CONTRACTOR SHALL NOTHY UNDERGROUND SERVICE OF CONSTRUCTION.

  7. EXISTING CURB RETURN RADIUS AND FLOW LINE ALIGNMENT, UNLESS NOTED OTHERWISE.

  7. EXISTING CURB REFORM TO THE START OF CONSTRUCTION.

  7. EXISTING CURB REPORT TO THE START OF CONSTRUCTION.

  8. AT LOCATIONS WHERE PROPOSED CURB RAMP IS IN CLOSE PROXYMITY TO EXISTING LANGESCHING TO TERESTORE.

- AT LOCATIONS WHERE PROPOSED CURB RAMP IS NO CLOSE PROMITY TO EXISTING TREE/S. CITY ARRONEST SHALL BE CONSULTED PRIOR TO ARRONEST SHALL BE CONSULTED PRIOR TO ALL MANH-PLOSE, VALVES AND PULL BOXES WITHIN THE LIMIT OF CONCRETE IMPROVEMENT SHALL BE ADJUSTED TO FINAL GRADE SHALL BE STANDED TO FINAL GRADE SHALL BE RESTORED/REPAINTED.

  1. ALL CURB MARKINGS AFFECTED BY NEW RAMP SHALL BE RESTORED/REPAINTED.

  1. CONTRACTOR TO RUN A GUITER WATER TEST ON ALL NEW CURB RAMPS PER SECTION 13 OF THE SPECIAL SHALL BE SHALL

- 13. THE ELEVATION OF 'TC +0.5" IS THE ADDITION OF .5' TO THE BW. CRAPHIC SCALE




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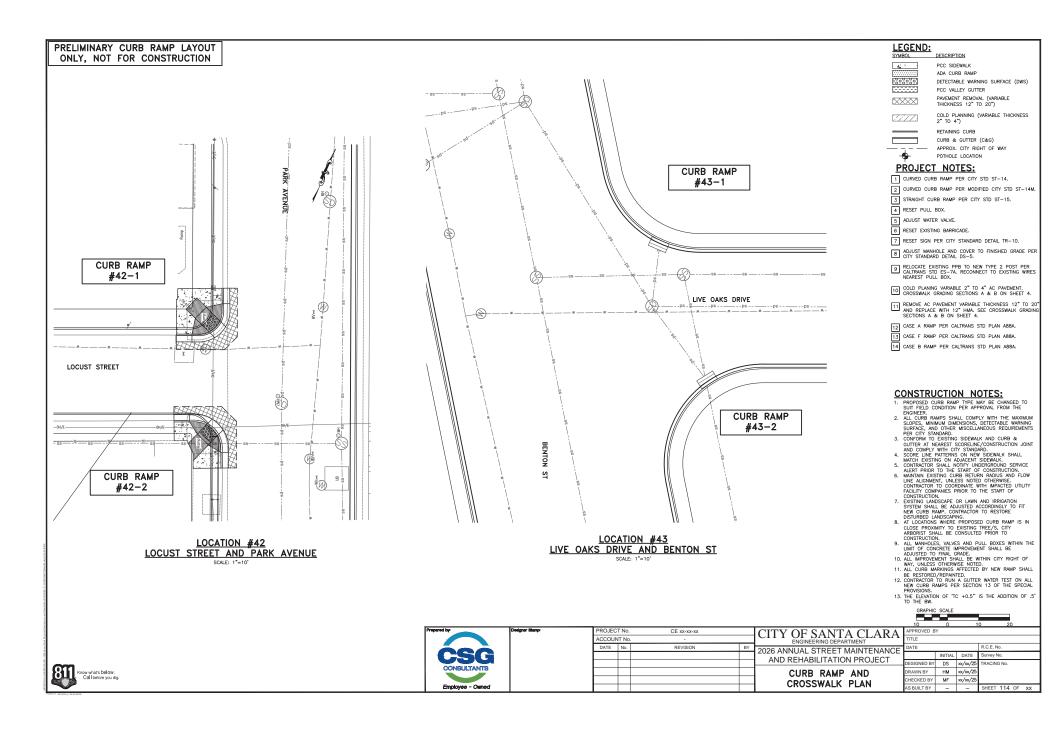
CITY OF SANTA CLARA 2026 ANNUAL STREET MAINTENANCE AND REHABILITATION PROJECT


CURB RAMP AND CROSSWALK PLAN


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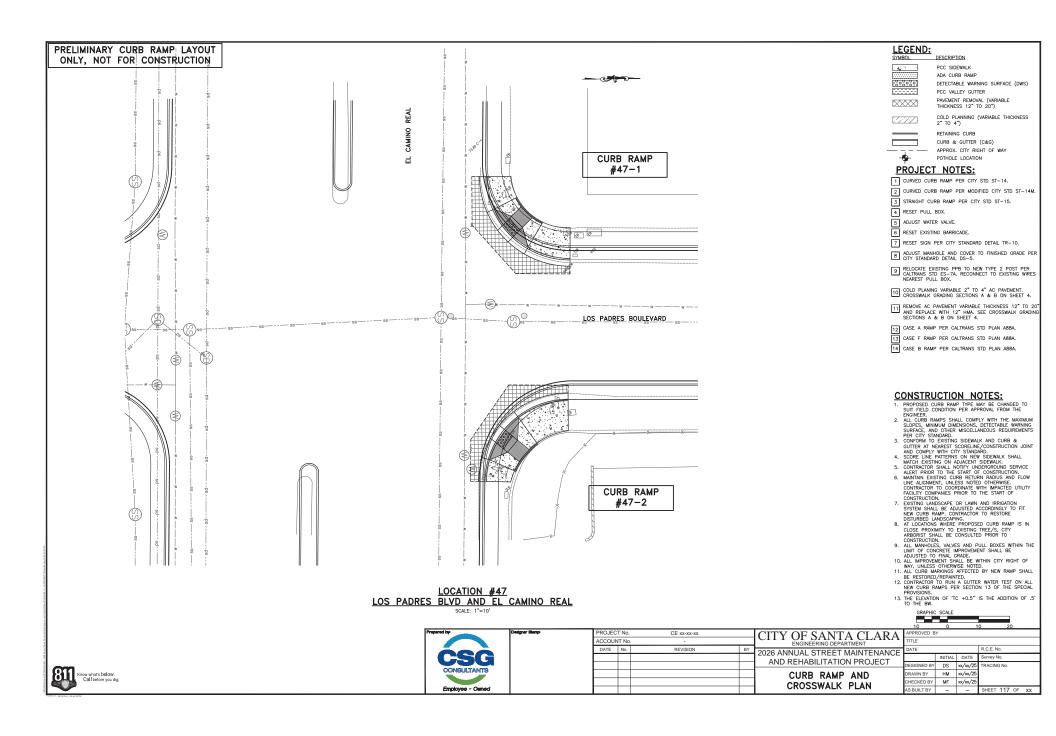








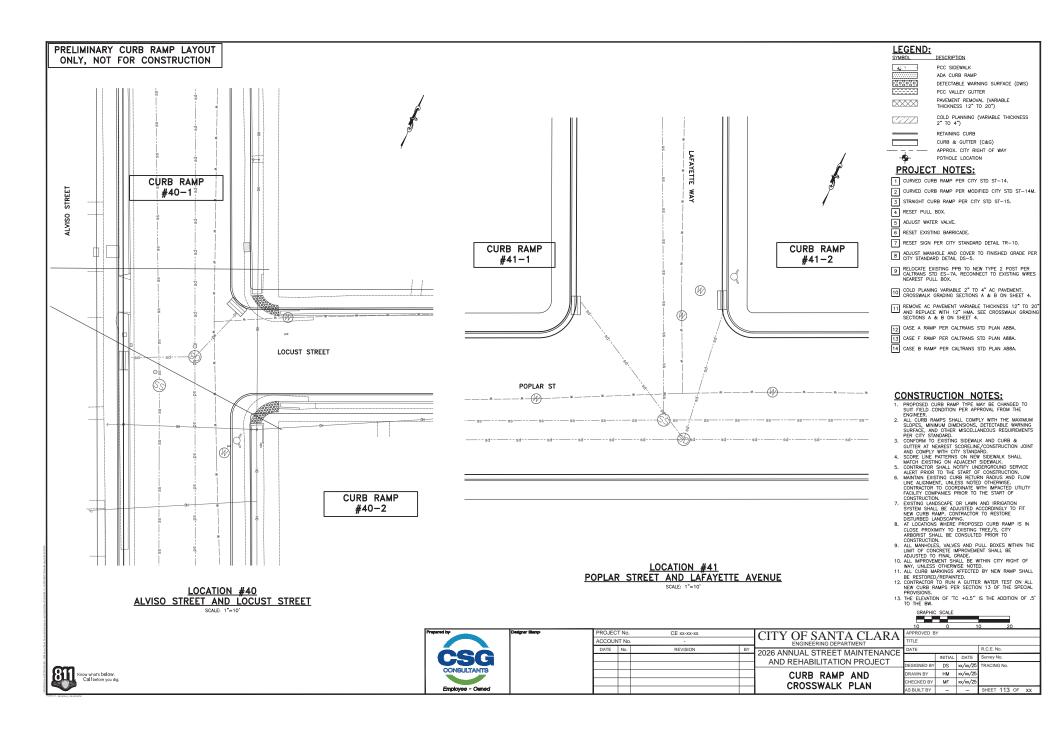

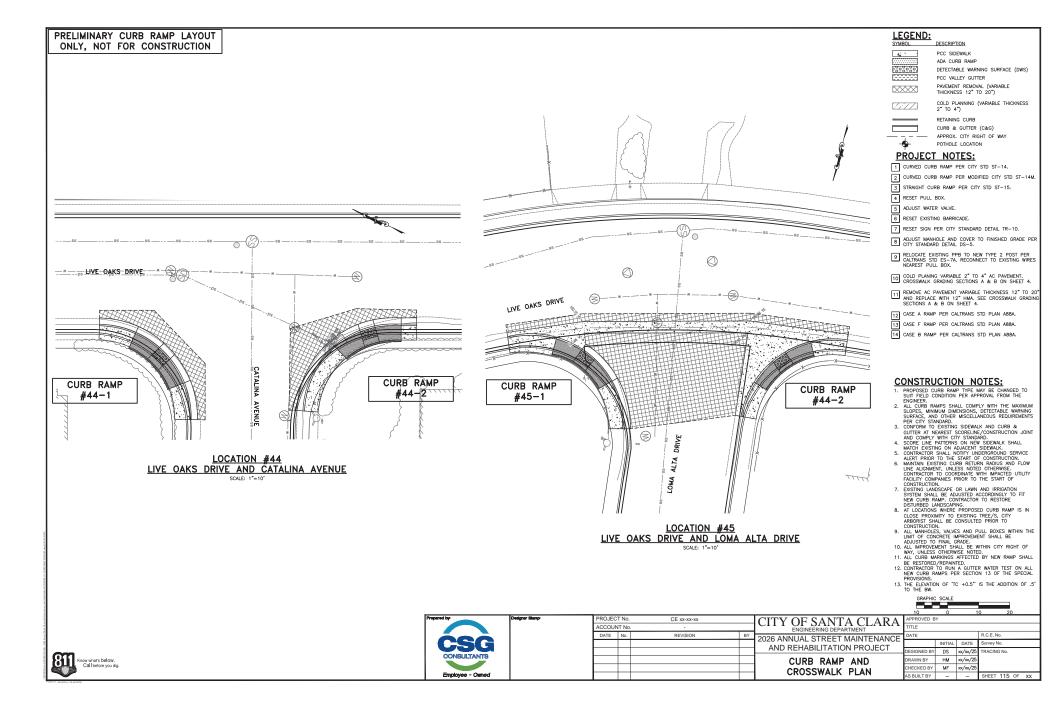

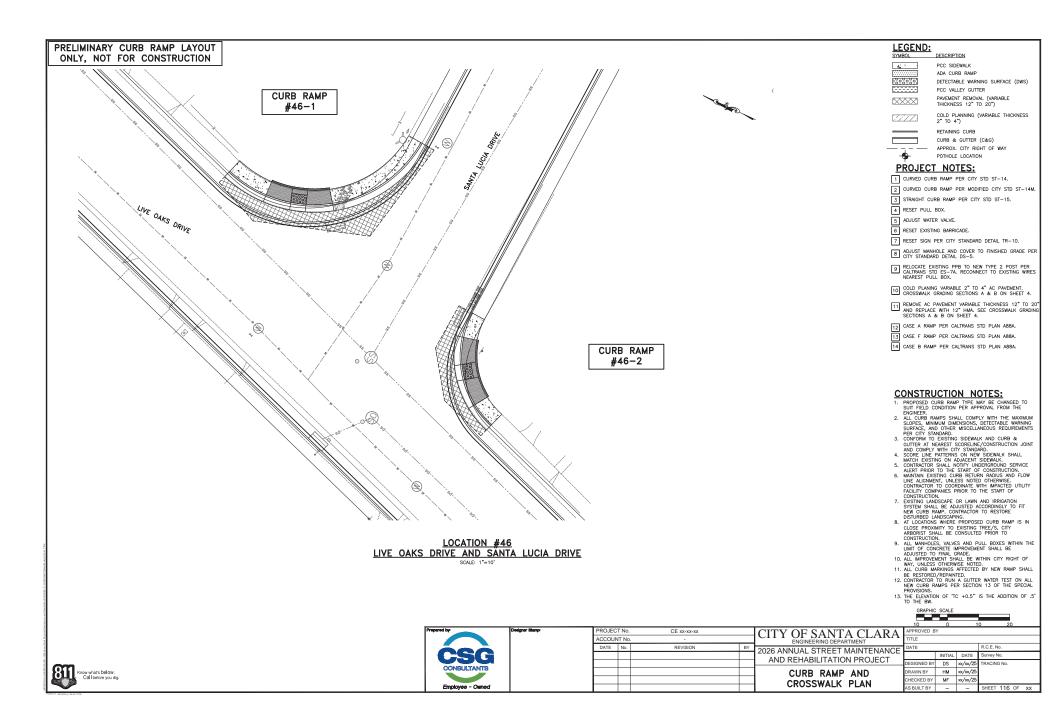

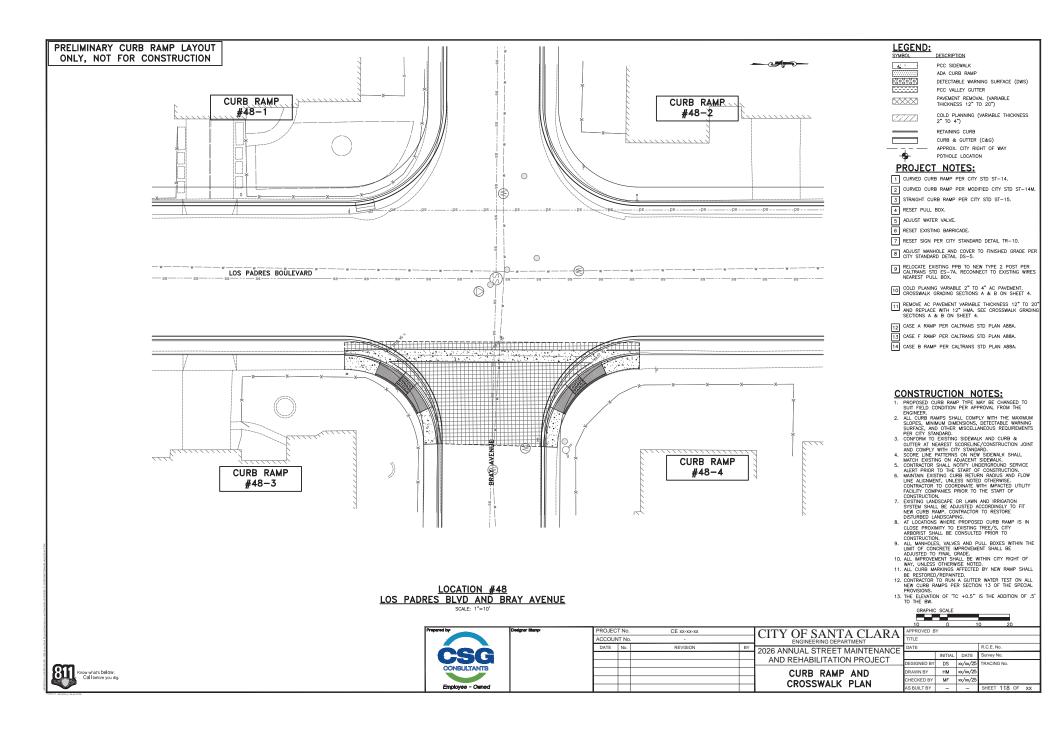

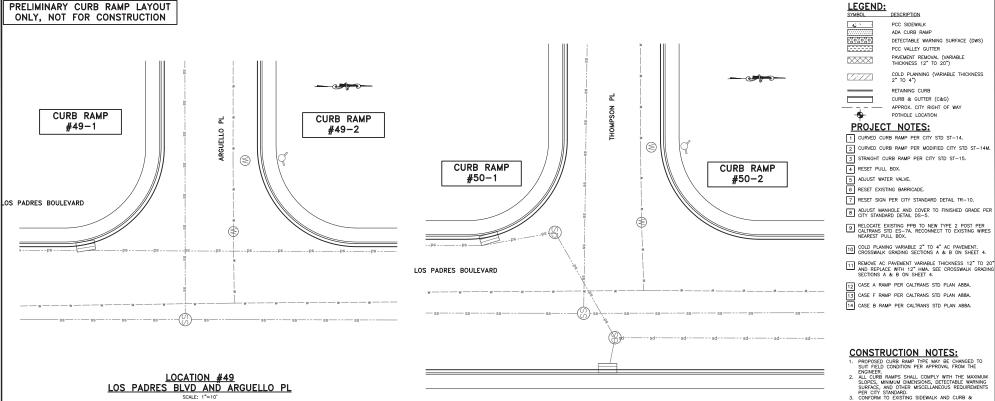

LOCATION #50 LOS PADRES BLVD AND THOMPSON PL SCALE: 1"=10

**CONSTRUCTION NOTES:** 

DESCRIPTION

PCC SIDEWALK ADA CURB RAMP

RETAINING CURB CURB & GUTTER (C&G) APPROX. CITY RIGHT OF WAY

POTHOLE LOCATION

DETECTABLE WARNING SURFACE (DWS) PCC VALLEY GUTTER PAVEMENT REMOVAL (VARIABLE THICKNESS 12" TO 20")

COLD PLANNING (VARIABLE THICKNESS 2" TO 4")

PROPOSED CURB RAMP TYPE MAY BE CHANGED TO SUIT FIELD CONDITION PER APPROVAL FROM THE

1. PEGINDSED CURB MAMP TYPE MAY BE CHANGED IN DEPONDED TO THE STATE CONTION OF APPROVAL FROM THE BURNERS.

2. ALL CURB RAMPS SHALL COMPLY WITH THE MAXIMUM DIMENSION, DETECTABLE WARNING SUPEACH, AND OTHER MISCELLANGOUS REQUIREMENTS.

3. CONTORN TO EXISTING SIDEMAK AND CURB A GUITTER AT NEAREST SCORELINE/CONSTRUCTION JOINT AND COMPLY WITH CITY STANDARD.

4. SCOPE LINE PATTERNS ON NEW SIDEMAK SHALL AND ADDRESS WITH STANDARD AND ADDRESS TO THE STATE OF CONSTRUCTION.

5. CONTRACTOR SHALL NOTHEY UNDERGROUND SERVICE ALEET PRIOR TO THE STATE OF CONSTRUCTION.

6. MAINTAIN EXISTING CURB RETURN RADIUS AND FLOW LINE ALIGNMENT, UNLESS NOTED OTHERWISE. TO CONTRACTOR SHALL NOTHEY OF DEWNIES.

6. CONTRACTOR SHALL NOTHEY ONE OF THE STATE OF CONSTRUCTION.

7. EXISTING CURB REFORE TO THE STATE OF CONSTRUCTION.

8. AT LOCATIONS WHERE PROPOSED CURB RAMP IS IN CLOSE PROVAMILY DE RESTORE TO THE STATE OF INSTRUCTION.

8. AT LOCATIONS WHERE PROPOSED CURB RAMP IS IN CLOSE PROVAMILY TO EXERTING THE SETS OF THE STATE.

AT LOCATIONS WHERE PROPOSED CURB RAMP IS NO CLOSE PROMITY TO EXISTING TREE/S. CITY ARRONEST SHALL BE CONSULTED PRIOR TO ARRONEST SHALL BE CONSULTED PRIOR TO ALL MANH-PLOSE, VALVES AND PULL BOXES WITHIN THE LIMIT OF CONCRETE IMPROVEMENT SHALL BE ADJUSTED TO FINAL GRADE SHALL BE SHALL BE SHALL BE WITHIN CITY RIGHT OF THE SHALL BE RESTORED/REPAINTED.

1. ALL CURB MARKINGS AFFECTED BY NEW RAMP SHALL BE RESTORED/REPAINTED.

1. CONTRACTOR TO RUN A GUITER WATER TEST ON ALL NEW CURB RAMPS PER SECTION 13 OF THE SPECIAL SHALL BE SHAL

13. THE ELEVATION OF 'TC +0.5" IS THE ADDITION OF .5' TO THE BW.

GRAPHIC SCALE




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CITY OF SANTA CLARA 2026 ANNUAL STREET MAINTENANCE INITIAL DATE urvey No. AND REHABILITATION PROJECT DESIGNED BY DS xx/xx/25 DRAWN BY HM xx/xx/25 CHECKED BY MF xx/xx/25

CURB RAMP AND

CROSSWALK PLAN



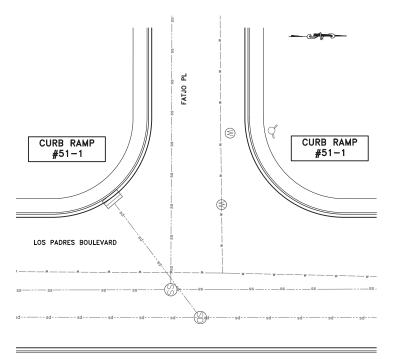

LOCATION #51 LOS PADRES BLVD AND FATJO PL LEGEND: DESCRIPTION

43.5 PCC SIDEWALK

ADA CURB RAMP 5808080

DETECTABLE WARNING SURFACE (DWS) PCC VALLEY GUTTER

PAVEMENT REMOVAL (VARIABLE THICKNESS 12" TO 20") 

COLD PLANNING (VARIABLE THICKNESS 2" TO 4") 5773 RETAINING CURB

CURB & GUTTER (C&G) APPROX. CITY RIGHT OF WAY • POTHOLE LOCATION

#### **PROJECT NOTES:**

- 1 CURVED CURB RAMP PER CITY STD ST-14.
- 2 CURVED CURB RAMP PER MODIFIED CITY STD ST-14M.
- 3 STRAIGHT CURB RAMP PER CITY STD ST-15.
- 4 RESET PULL BOX.
- 5 ADJUST WATER VALVE.
- 6 RESET EXISTING BARRICADE.
- 7 RESET SIGN PER CITY STANDARD DETAIL TR-10.
- B ADJUST MANHOLE AND COVER TO FINISHED GRADE PER CITY STANDARD DETAIL DS-5.
- 9 RELOCATE EXISTING PPB TO NEW TYPE 2 POST PER CALTRANS STD ES-7A. RECONNECT TO EXISTING WIRES NEAREST PULL BOX.
- 10 COLD PLANING VARIABLE 2" TO 4" AC PAVEMENT. CROSSWALK GRADING SECTIONS A & B ON SHEET 4.
- 11 REMOVE AC PAVEMENT VARIABLE THICKNESS 12" TO 20"
  AND REPLACE WITH 12" HMA. SEE CROSSWALK GRADING SECTIONS A & B ON SHEET 4.
- 12 CASE A RAMP PER CALTRANS STD PLAN A88A.
- 13 CASE F RAMP PER CALTRANS STD PLAN A88A.
- 14 CASE B RAMP PER CALTRANS STD PLAN A88A.

## **CONSTRUCTION NOTES:**

- PROPOSED CURB RAMP TYPE MAY BE CHANGED TO SUIT FIELD CONDITION PER APPROVAL FROM THE

- 1. PROPOSED CURR MAMP TYPE MAY BE CHANGED IN SEMENTARY CONDITION FOR APPROVAL FROM THE MAXIMUM SLOPES, MINIMUM DIMENSIONS, DETECTABLE WARNING SUPERACE, AND OTHER MISCELLANGOUS REQUIREMENTS OF A CONFIDENT OF EXISTING SIDEMAL AND CURR AS GUTTER AT NEAREST SCORELINE/CONSTRUCTION JOINT AND COMPLY WITH CITY STANDARD.

  4. SCOPE LINE PATTERNS ON NEW SIDEMAL SHALL AND COMPLY WITH CITY STANDARD.

  5. CONTRACTOR SHALL NOTIFY UNDERFROUND SERVICE ALERT PRIOR TO THE START OF CONSTRUCTION.

  6. MANTAIN EXISTING CURR FEITUR RADIUS AND ELOW LIVE ALIGNMENT, UNLESS NOTICE OTHERWISE.

  6. CONTRACTOR SHALL NOTIFY UNDERFROUND SERVICE OF CONSTRUCTION.

  6. MANTAIN EXISTING CURR FEITUR RADIUS AND ELOW LIVE ALIGNMENT, UNLESS NOTICE OTHERWISE.

  6. CONTRACTOR SHALL NOTIFY OF THE START OF CONSTRUCTION.

  6. STANDARD STANDARD SHORT OF THE START OF CONSTRUCTION.

  6. STANDARD SHALL SHORT OF CONTRACTOR TO RESTORE DISTURBED LANDSCAPING.

  6. AT LOCATIONS WHERE PROPOSED CURR RAMP IS IN CLOSE PROXYMITY TO EXSTING LEEPS, CITY
- AT LOCATIONS WHERE PROPOSED CURB RAMP IS NO CLOSE PROMITY TO EXISTING TREE/S. CITY ARRONEST SHALL BE CONSULTED PRIOR TO ARRONEST SHALL BE CONSULTED PRIOR TO ALL MANH-PLOSE, VALVES AND PULL BOXES WITHIN THE LIMIT OF CONCRETE IMPROVEMENT SHALL BE ADJUSTED TO FINAL GRADE SHALL BE SHALL BE SHALL BE WITHIN CITY RIGHT OF THE SHALL BE RESTORED/REPAINTED.

  1. ALL CURB MARKINGS AFFECTED BY NEW RAMP SHALL BE RESTORED/REPAINTED.

  1. CONTRACTOR TO RUN A GUITER WATER TEST ON ALL NEW CURB RAMPS PER SECTION 13 OF THE SPECIAL SHALL BE SHAL

- 13. THE ELEVATION OF 'TC +0.5" IS THE ADDITION OF .5' TO THE BW.

GRAPHIC SCALE




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CITY OF SANTA CLARA 2026 ANNUAL STREET MAINTENANCE AND REHABILITATION PROJECT

CURB RAMP AND CROSSWALK PLAN

INITIAL DATE urvey No. DESIGNED BY DS xx/xx/25 DRAWN BY HM xx/xx/25 CHECKED BY MF xx/xx/25 AS BUILT BY



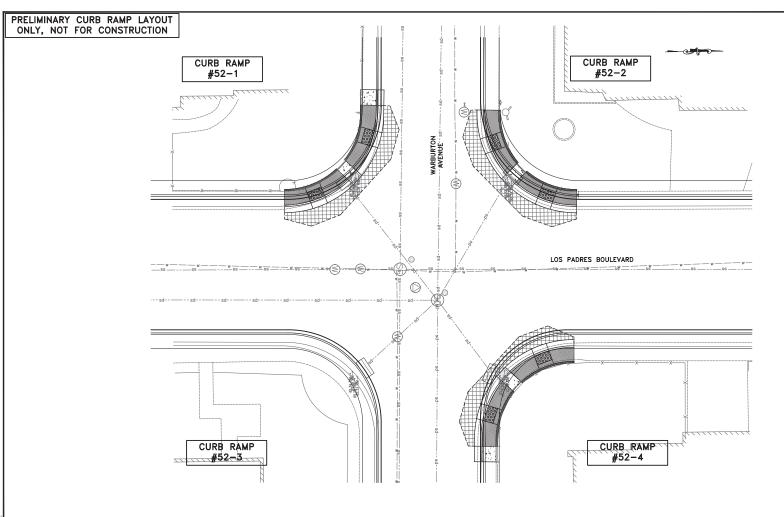

LOCATION #52 LOS PADRES BLVD AND WARBURTON AVENUE LEGEND:

DESCRIPTION PCC SIDEWALK

ADA CURB RAME

5000000 DETECTABLE WARNING SURFACE (DWS)

PCC VALLEY GUTTER PAVEMENT REMOVAL (VARIABLE THICKNESS 12" TO 20") 

COLD PLANNING (VARIABLE THICKNESS 2" TO 4")

RETAINING CURB CURB & GUTTER (C&G) APPROX. CITY RIGHT OF WAY • POTHOLE LOCATION

## **PROJECT NOTES:**

- 1 CURVED CURB RAMP PER CITY STD ST-14.
- 2 CURVED CURB RAMP PER MODIFIED CITY STD ST-14M.
- 3 STRAIGHT CURB RAMP PER CITY STD ST-15.
- 4 RESET PULL BOX.
- 5 ADJUST WATER VALVE.
- 6 RESET EXISTING BARRICADE.
- 7 RESET SIGN PER CITY STANDARD DETAIL TR-10.
- B ADJUST MANHOLE AND COVER TO FINISHED GRADE PER CITY STANDARD DETAIL DS-5.
- 9 RELOCATE EXISTING PPB TO NEW TYPE 2 POST PER CALTRANS STD ES-7A. RECONNECT TO EXISTING WIRES NEAREST PULL BOX.
- 10 COLD PLANING VARIABLE 2" TO 4" AC PAVEMENT. CROSSWALK GRADING SECTIONS A & B ON SHEET 4.
- [11] REMOVE AC PAVEMENT VARIABLE THICKNESS 12" TO 20"
  AND REPLACE WITH 12" HMA. SEE CROSSWALK GRADING SECTIONS A & B ON SHEET 4.
- 12 CASE A RAMP PER CALTRANS STD PLAN A88A.
- 13 CASE F RAMP PER CALTRANS STD PLAN A88A.
- 14 CASE B RAMP PER CALTRANS STD PLAN A88A.

#### **CONSTRUCTION NOTES:**

- PROPOSED CURB RAMP TYPE MAY BE CHANGED TO SUIT FIELD CONDITION PER APPROVAL FROM THE

- 1. PROPOSED CURE MAMP TYPE MAY BE CHANGED IN SEMENTARY CONDITION FOR APPROVAL FROM THE ENDINEER.

  2. ALL CURB RAMPS SHALL COMPLY WITH THE MAXIMUM DIMENSION, DETECTABLE WARNING SURFACE, AND OTHER MISCELLANEOUS REQUIREMENTS.

  3. CONFORM TO EXISTING SUBJECTABLE WARNING SURFACE, AND OTHER MISCELLANEOUS REQUIREMENTS.

  3. CONFORM TO EXISTING SUBJECTABLE WARNING SINTAL AND COMPLY WITH CITY STANDARD.

  4. SCONE LINE FAITERIS ON NEW SUBWAY. SHALL AND COMPLY WITH CITY STANDARD.

  5. CONTRACTOR SHALL NOTHER TANDARD SERVICE ALERT PRIOR TO THE START OF CONSTRUCTION.

  5. CONTRACTOR SHALL NOTHER WAS DECOUNTED TO THE START OF CONSTRUCTION.

  5. MANTAIN AUSTRING CURB RETURN RADIUS AND FLOW LINE ALGAMENT, UNLESS NOTED OTHERWISE.

  5. CONTRACTOR SHALL NOTHER WAS DECOUNTED TO THE START OF CONSTRUCTION.

  5. EXISTING CURB RESULTS ACCORDINGLY OF IT SHALL 
- AT LOCATIONS WHERE PROPOSED CURB RAMP IS NO CLOSE PROMITY TO EXISTING TREE/S. CITY ARRONEST SHALL BE CONSULTED PRIOR TO ARRONEST SHALL BE CONSULTED PRIOR TO ALL MANH-PLOSE, VALVES AND PULL BOXES WITHIN THE LIMIT OF CONCRETE IMPROVEMENT SHALL BE ADJUSTED TO FINAL GRADE SHALL BE SHALL BE SHALL BE WITHIN CITY RIGHT OF THE SHALL BE RESTORED/REPAINTED.

  1. ALL CURB MARKINGS AFFECTED BY NEW RAMP SHALL BE RESTORED/REPAINTED.

  1. CONTRACTOR TO RUN A GUITER WATER TEST ON ALL NEW CURB RAMPS PER SECTION 13 OF THE SPECIAL SHALL BE SHAL

- 13. THE ELEVATION OF 'TC +0.5" IS THE ADDITION OF .5' TO THE BW. GRAPHIC SCAL




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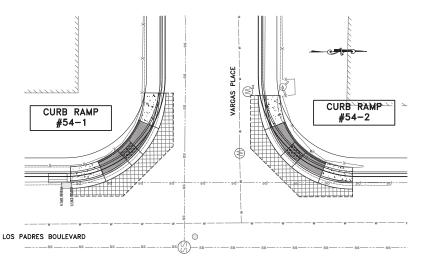
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CURB RAMP AND CROSSWALK PLAN DRAWN BY HM xx/xx/25 CHECKED BY MF xx/xx/25 AS BUILT BY SHEET 121 OF XX





LOCATION #53 LOS PADRES BLVD AND RAGGIO AVENUE SCALE: 1"=10"

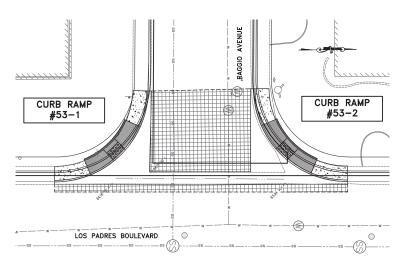

LOCATION #54 LOS PADRES BLVD AND VARGAS PLACE LEGEND: DESCRIPTION

40 1 PCC SIDEWALK

ADA CURB RAMP

5808080 DETECTABLE WARNING SURFACE (DWS) PCC VALLEY GUTTER

PAVEMENT REMOVAL (VARIABLE THICKNESS 12" TO 20") 

COLD PLANNING (VARIABLE THICKNESS 2" TO 4")

RETAINING CURB CURB & GUTTER (C&G) APPROX. CITY RIGHT OF WAY POTHOLE LOCATION

**PROJECT NOTES:** 

- 1 CURVED CURB RAMP PER CITY STD ST-14.
- 2 CURVED CURB RAMP PER MODIFIED CITY STD ST-14M.
- 3 STRAIGHT CURB RAMP PER CITY STD ST-15.
- 4 RESET PULL BOX.
- 5 ADJUST WATER VALVE.
- 6 RESET EXISTING BARRICADE.
- 7 RESET SIGN PER CITY STANDARD DETAIL TR-10.
- B ADJUST MANHOLE AND COVER TO FINISHED GRADE PER CITY STANDARD DETAIL DS-5.
- RELOCATE EXISTING PPB TO NEW TYPE 2 POST PER CALTRANS STD ES-7A. RECONNECT TO EXISTING WIRES NEAREST PULL BOX.
- 10 COLD PLANING VARIABLE 2" TO 4" AC PAVEMENT. CROSSWALK GRADING SECTIONS A & B ON SHEET 4.
- 11 REMOVE AC PAVEMENT VARIABLE THICKNESS 12" TO 20" AND REPLACE WITH 12" HMA. SEE CROSSWALK GRADING SECTIONS A & B ON SHEET 4.
- 12 CASE A RAMP PER CALTRANS STD PLAN A88A.
- 13 CASE F RAMP PER CALTRANS STD PLAN A88A.
- 14 CASE B RAMP PER CALTRANS STD PLAN A88A.

## **CONSTRUCTION NOTES:**

- PROPOSED CURB RAMP TYPE MAY BE CHANGED TO SUIT FIELD CONDITION PER APPROVAL FROM THE

- 1. PEGINDSED CURB MAMP TYPE MAY BE CHANGED IN DEPONDED TO THE STATE CONTION OF APPROVAL FROM THE BURNERS.

  2. ALL CURB RAMPS SHALL COMPLY WITH THE MAXIMUM DIMENSION, DETECTABLE WARNING SUPEACH, AND OTHER MISCELLANGOUS REQUIREMENTS.

  3. CONTORN TO EXISTING SIDEMAK AND CURB A GUITTER AT NEAREST SCORELINE/CONSTRUCTION JOINT AND COMPLY WITH CITY STANDARD.

  4. SCOPE LINE PATTERNS ON NEW SIDEMAK SHALL AND ADDRESS WITH STANDARD AND ADDRESS TO THE STATE OF CONSTRUCTION.

  5. CONTRACTOR SHALL NOTHEY UNDERGROUND SERVICE ALEET PRIOR TO THE STATE OF CONSTRUCTION.

  6. MAINTAIN EXISTING CURB RETURN RADIUS AND FLOW LINE ALIGNMENT, UNLESS NOTED OTHERWISE. TO CONTRACTOR SHALL NOTHEY OF DEWNIES.

  6. CONTRACTOR SHALL NOTHEY ONE OF THE STATE OF CONSTRUCTION.

  7. EXISTING CURB REFORE TO THE STATE OF CONSTRUCTION.

  8. AT LOCATIONS WHERE PROPOSED CURB RAMP IS IN CLOSE PROVAMILY DE RESTORE TO THE STATE OF INSTRUCTION.

  8. AT LOCATIONS WHERE PROPOSED CURB RAMP IS IN CLOSE PROVAMILY TO EXERTING THE SETS OF THE STATE.
- AT LOCATIONS WHERE PROPOSED CURB RAMP IS NO CLOSE PROMITY TO EXISTING TREE/S. CITY ARRONEST SHALL BE CONSULTED PRIOR TO ARRONEST SHALL BE CONSULTED PRIOR TO ALL MANH-PLOSE, VALVES AND PULL BOXES WITHIN THE LIMIT OF CONCRETE IMPROVEMENT SHALL BE ADJUSTED TO FINAL GRADE SHALL BE SHALL BE SHALL BE WITHIN CITY RIGHT OF THE SHALL BE RESTORED/REPAINTED.

  1. ALL CURB MARKINGS AFFECTED BY NEW RAMP SHALL BE RESTORED/REPAINTED.

  1. CONTRACTOR TO RUN A GUITER WATER TEST ON ALL NEW CURB RAMPS PER SECTION 13 OF THE SPECIAL SHALL BE SHAL

urvey No.

13. THE ELEVATION OF 'TC +0.5" IS THE ADDITION OF .5' TO THE BW. CRAPHIC SCALE




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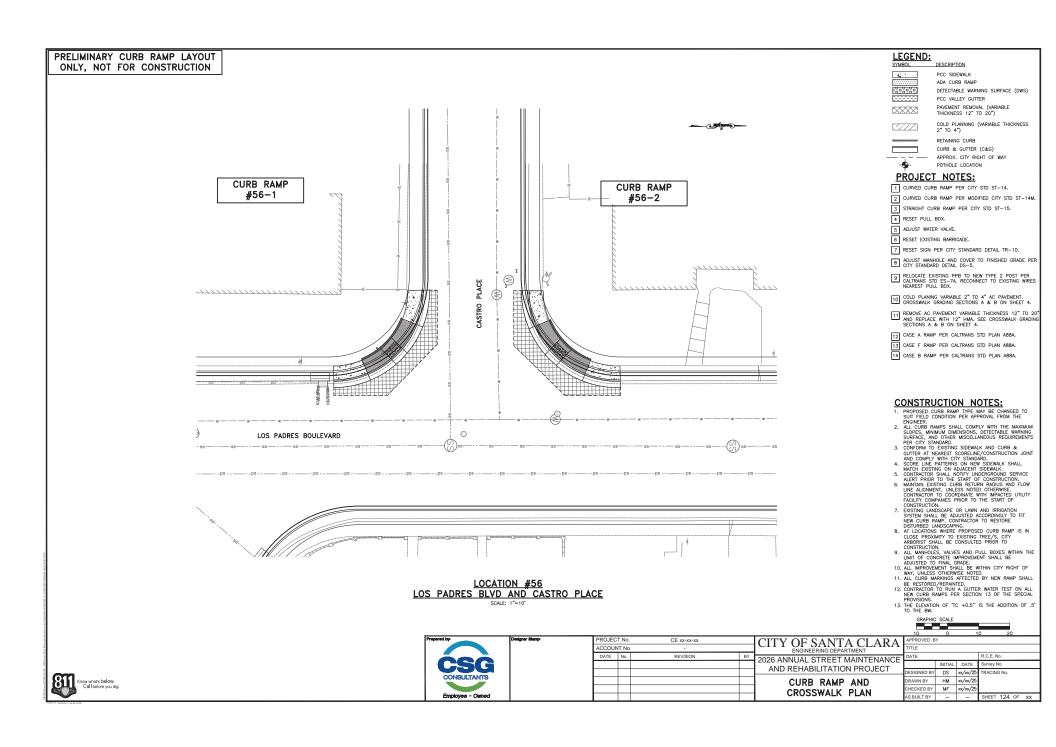
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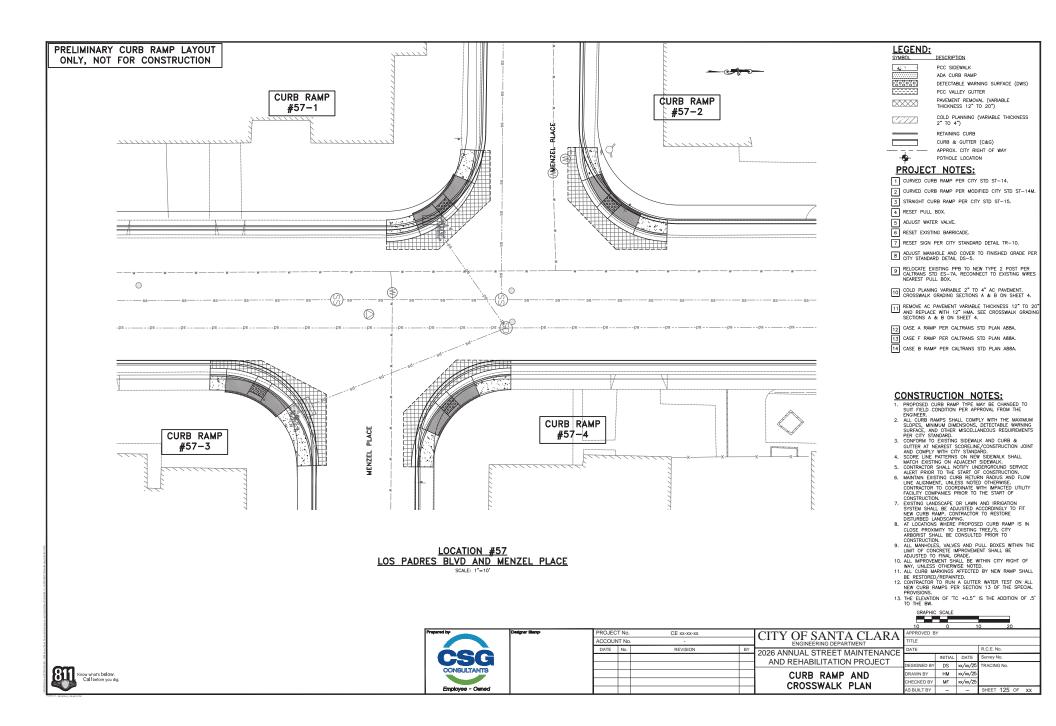
CROSSWALK PLAN


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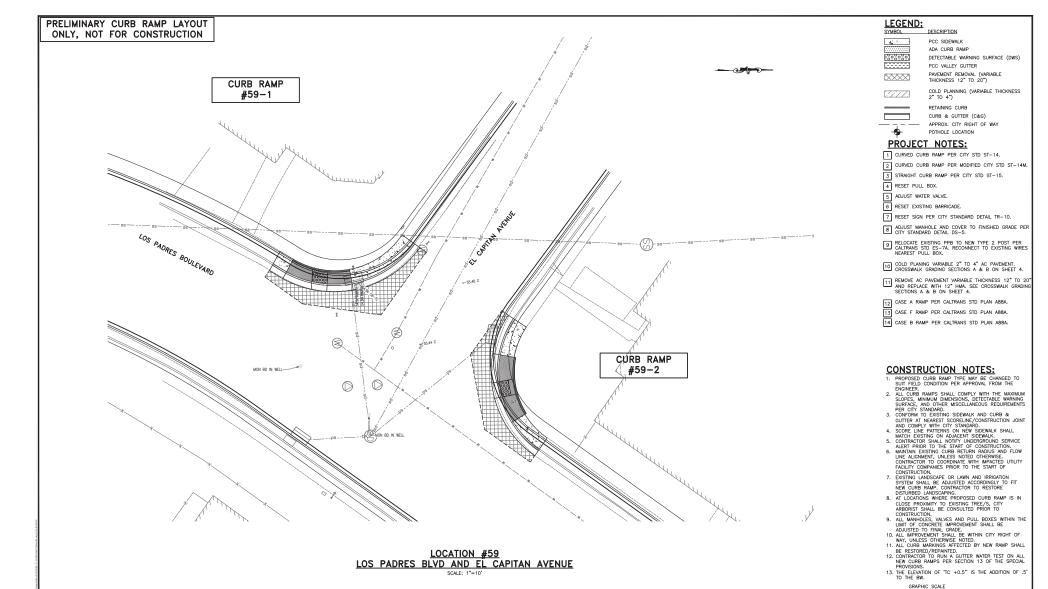








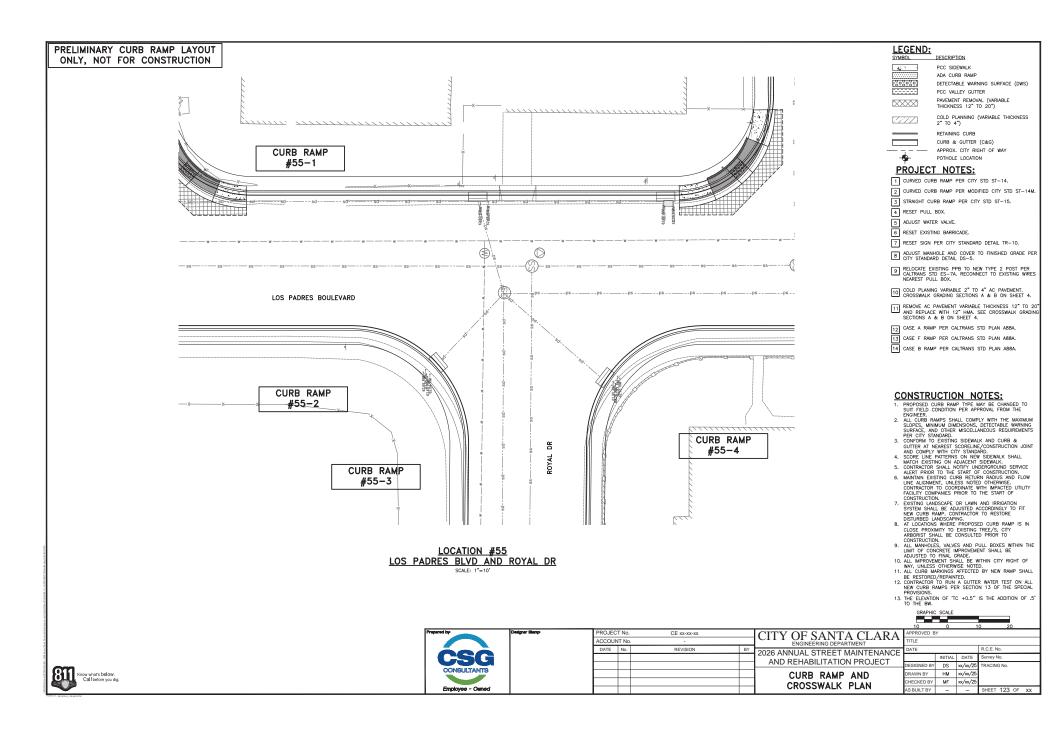

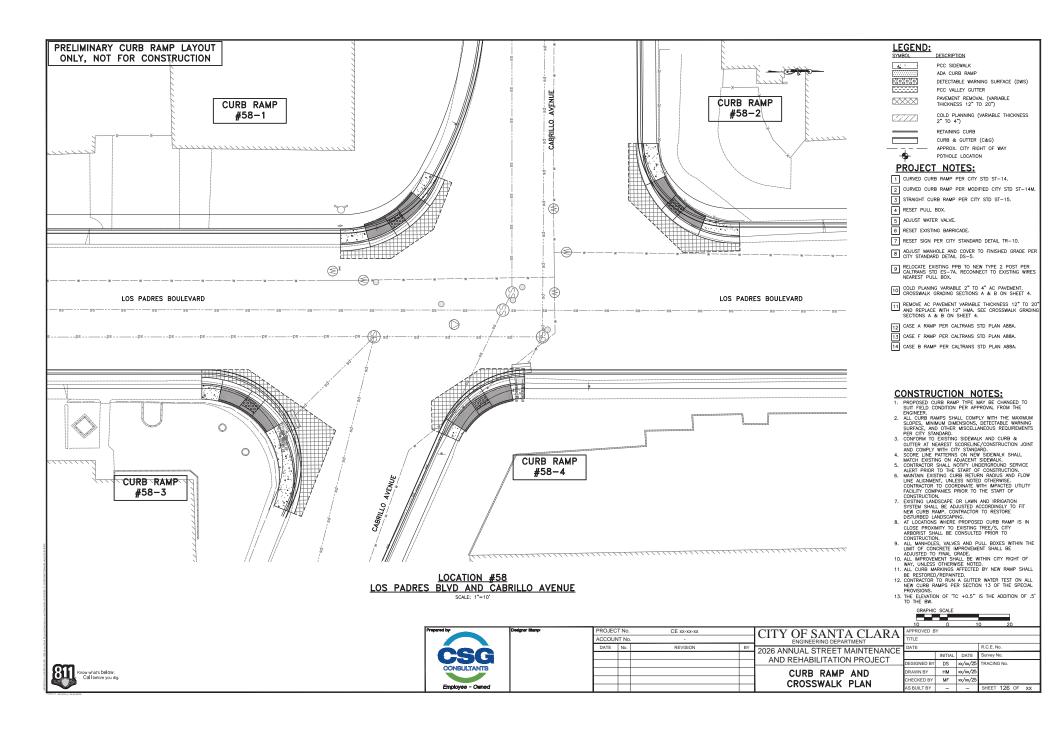




Know what's below. Call before you dig.

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CITY OF SANTA CLARA 2026 ANNUAL STREET MAINTENANCE INITIAL DATE urvey No. AND REHABILITATION PROJECT DESIGNED BY DS xx/xx/25 DRAWN BY HM xx/xx/25

CURB RAMP AND CHECKED BY MF xx/xx/25 CROSSWALK PLAN

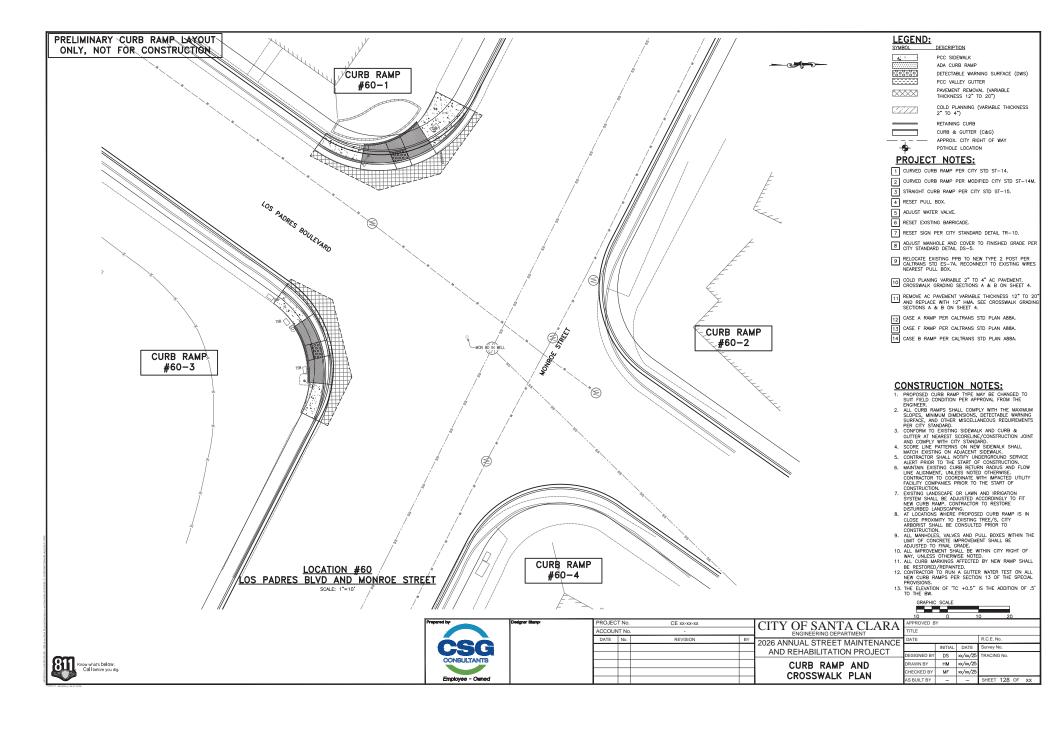

# PRELIMINARY CURB RAMP LAYOUT ONLY, NOT FOR CONSTRUCTION AVENUE SARATOGA CURB RAMP #61-1 LOS PADRES BLVD (A) CURB RAMP #61-2

LOCATION #61 LOS PADRES BLVD AND SARATOGA AVENUE SCALE: 1"=10"

LEGEND:

DESCRIPTION PCC SIDEWALK

ADA CURB RAME 5808080 DETECTABLE WARNING SURFACE (DWS)

PCC VALLEY GUTTER PAVEMENT REMOVAL (VARIABLE THICKNESS 12" TO 20") 

COLD PLANNING (VARIABLE THICKNESS 2" TO 4")

RETAINING CURB CURB & GUTTER (C&G) APPROX. CITY RIGHT OF WAY • POTHOLE LOCATION

#### **PROJECT NOTES:**

- 1 CURVED CURB RAMP PER CITY STD ST-14.
- 2 CURVED CURB RAMP PER MODIFIED CITY STD ST-14M.
- 3 STRAIGHT CURB RAMP PER CITY STD ST-15.
- 4 RESET PULL BOX.
- 5 ADJUST WATER VALVE.
- 6 RESET EXISTING BARRICADE.
- 7 RESET SIGN PER CITY STANDARD DETAIL TR-10.
- B ADJUST MANHOLE AND COVER TO FINISHED GRADE PER CITY STANDARD DETAIL DS-5.
- 9 RELOCATE EXISTING PPB TO NEW TYPE 2 POST PER CALTRANS STD ES-7A. RECONNECT TO EXISTING WIRES NEAREST PULL BOX.
- 10 COLD PLANING VARIABLE 2" TO 4" AC PAVEMENT. CROSSWALK GRADING SECTIONS A & B ON SHEET 4.
- [11] REMOVE AC PAVEMENT VARIABLE THICKNESS 12" TO 20"
  AND REPLACE WITH 12" HMA. SEE CROSSWALK GRADING SECTIONS A & B ON SHEET 4.
- 12 CASE A RAMP PER CALTRANS STD PLAN A88A.
- 13 CASE F RAMP PER CALTRANS STD PLAN A88A.
- 14 CASE B RAMP PER CALTRANS STD PLAN A88A.

#### **CONSTRUCTION NOTES:**

- PROPOSED CURB RAMP TYPE MAY BE CHANGED TO SUIT FIELD CONDITION PER APPROVAL FROM THE

- 1. PROPOSED CURE MAMP TYPE MAY BE CHANGED IN SEMENTARY CONDITION FOR APPROVAL FROM THE ENDINEER.

  2. ALL CURB RAMPS SHALL COMPLY WITH THE MAXIMUM DIMENSION, DETECTABLE WARNING SURFACE, AND OTHER MISCELLANEOUS REQUIREMENTS.

  3. CONFORM TO EXISTING SUBJECTABLE WARNING SURFACE, AND OTHER MISCELLANEOUS REQUIREMENTS.

  3. CONFORM TO EXISTING SUBJECTABLE WARNING SINTAL AND COMPLY WITH CITY STANDARD.

  4. SCONE LINE FAITERIS ON NEW SUBWAY. SHALL AND COMPLY WITH CITY STANDARD.

  5. CONTRACTOR SHALL NOTHER TANDARD SERVICE ALERT PRIOR TO THE START OF CONSTRUCTION.

  5. CONTRACTOR SHALL NOTHER WAS DECOUNTED TO THE START OF CONSTRUCTION.

  5. MANTAIN AUSTRING CURB RETURN RADIUS AND FLOW LINE ALGAMENT, UNLESS NOTED OTHERWISE.

  5. CONTRACTOR SHALL NOTHER WAS DECOUNTED TO THE START OF CONSTRUCTION.

  5. EXISTING CURB RESULTS ACCORDINGLY OF IT SHALL - AT LOCATIONS WHERE PROPOSED CURB RAMP IS NO CLOSE PROMITY TO EXISTING TREE/S. CITY ARRONEST SHALL BE CONSULTED PRIOR TO ARRONEST SHALL BE CONSULTED PRIOR TO ALL MANH-PLOSE, VALVES AND PULL BOXES WITHIN THE LIMIT OF CONCRETE IMPROVEMENT SHALL BE ADJUSTED TO FINAL GRADE SHALL BE SHALL BE SHALL BE WITHIN CITY RIGHT OF THE SHALL BE RESTORED/REPAINTED.

  1. ALL CURB MARKINGS AFFECTED BY NEW RAMP SHALL BE RESTORED/REPAINTED.

  1. CONTRACTOR TO RUN A GUITER WATER TEST ON ALL NEW CURB RAMPS PER SECTION 13 OF THE SPECIAL SHALL BE SHAL

- 13. THE ELEVATION OF 'TC +0.5" IS THE ADDITION OF .5' TO THE BW.

GRAPHIC SCALE




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2026 ANNUAL STREET MAINTENANCE AND REHABILITATION PROJECT CURB RAMP AND CROSSWALK PLAN

CITY OF SANTA CLARA INITIAL DATE urvey No. DESIGNED BY DS xx/xx/25 DRAWN BY HM xx/xx/25 CHECKED BY MF xx/xx/25 SHEET 145 OF XX AS BUILT BY



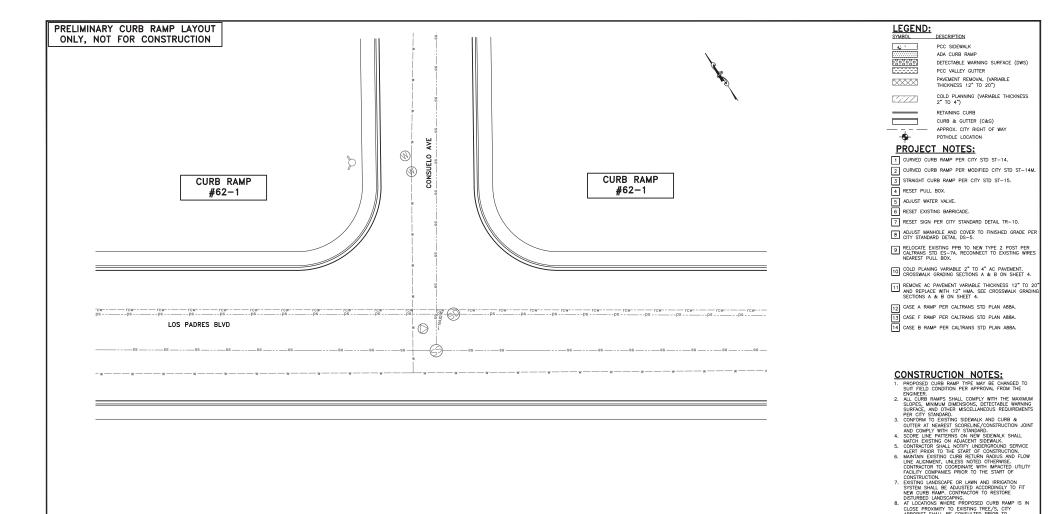

# LOCATION #62 LOS PADRES BLVD AND CONSUELO AVE

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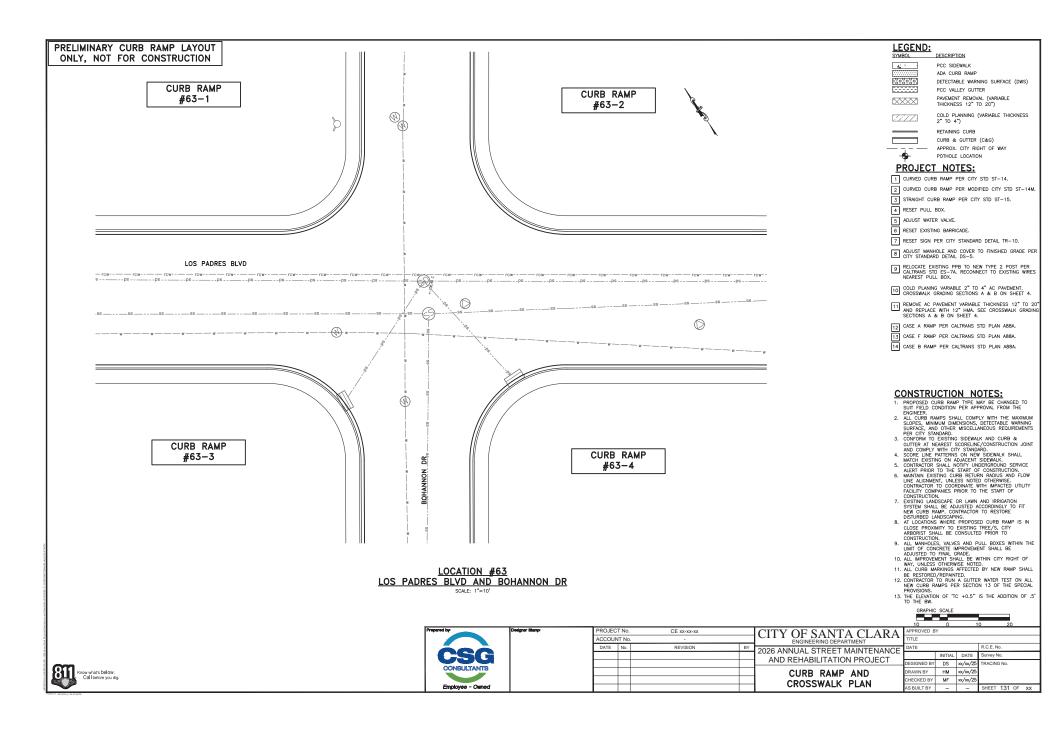
 AT LOCATIONS WHERE PROPOSED CURB RAMP IS NO CLOSE PROMITY TO EXISTING TREE/S. CITY ARRONEST SHALL BE CONSULTED PRIOR TO ARRONEST SHALL BE CONSULTED PRIOR TO ALL MANH-PLOSE, VALVES AND PULL BOXES WITHIN THE LIMIT OF CONCRETE IMPROVEMENT SHALL BE ADJUSTED TO FINAL GRADE SHALL BE SHALL BE SHALL BE WITHIN CITY RIGHT OF THE SHALL BE RESTORED/REPAINTED.


1. ALL CURB MARKINGS AFFECTED BY NEW RAMP SHALL BE RESTORED/REPAINTED.


1. CONTRACTOR TO RUN A GUITER WATER TEST ON ALL NEW CURB RAMPS PER SECTION 13 OF THE SPECIAL SHALL BE SHAL 13. THE ELEVATION OF 'TC +0.5" IS THE ADDITION OF .5' TO THE BW. GRAPHIC SCALE CITY OF SANTA CLARA


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CITY OF SANTA CLARA	APPROVED B	Y		
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2026 ANNUAL STREET MAINTENANCE	DATE			R.C.E. No.
AND REHABILITATION PROJECT		INITIAL	DATE	Survey No.
AND REHABILITATION PROJECT	DESIGNED BY	DS	xx/xx/25	TRACING No.
CURB RAMP AND	DRAWN BY	нм	xx/xx/25	
CROSSWALK PLAN	CHECKED BY	MF	xx/xx/25	
CRUSSWALK FLAN	AS BUILT BY	-	-	SHEET 130 OF XX







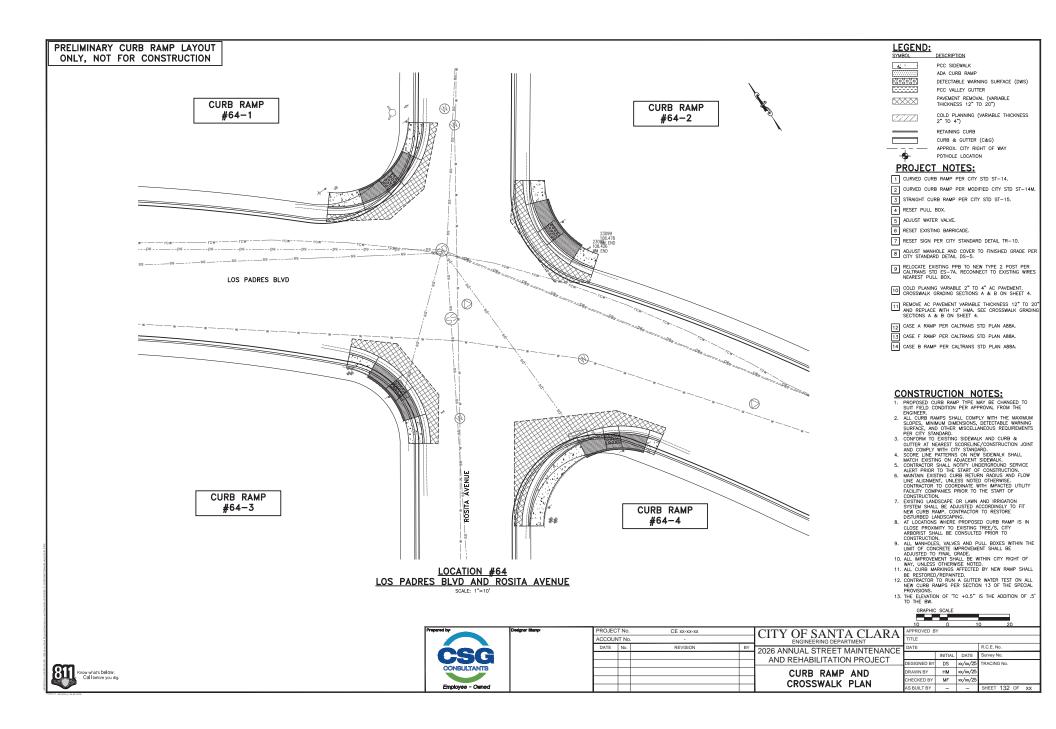


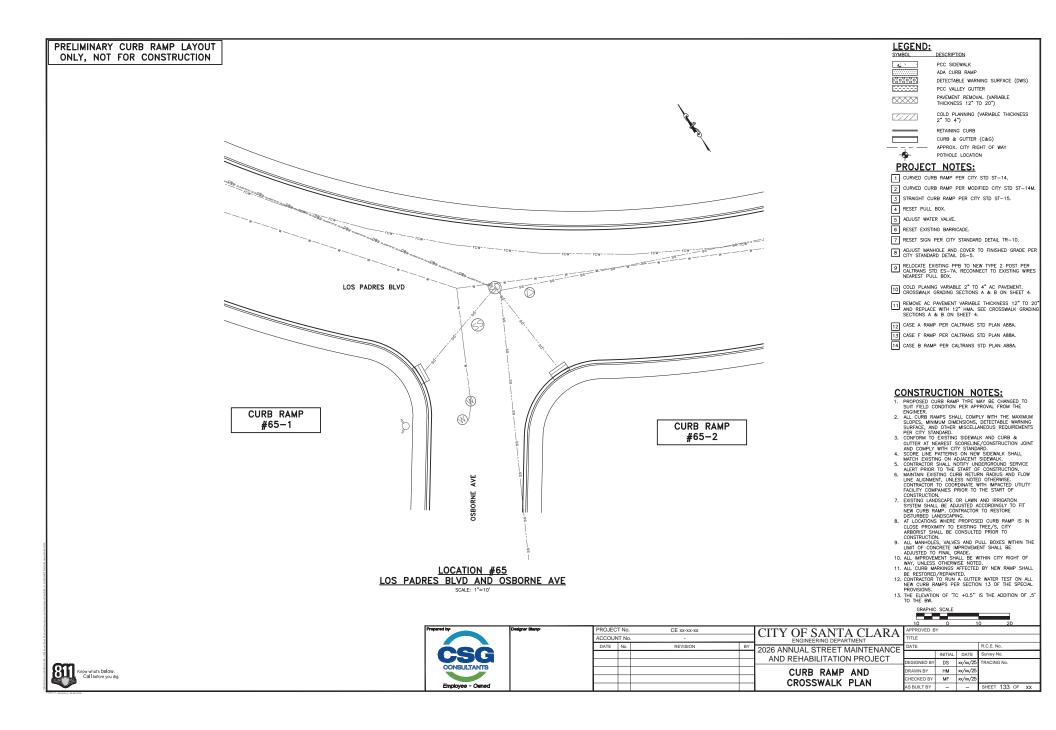

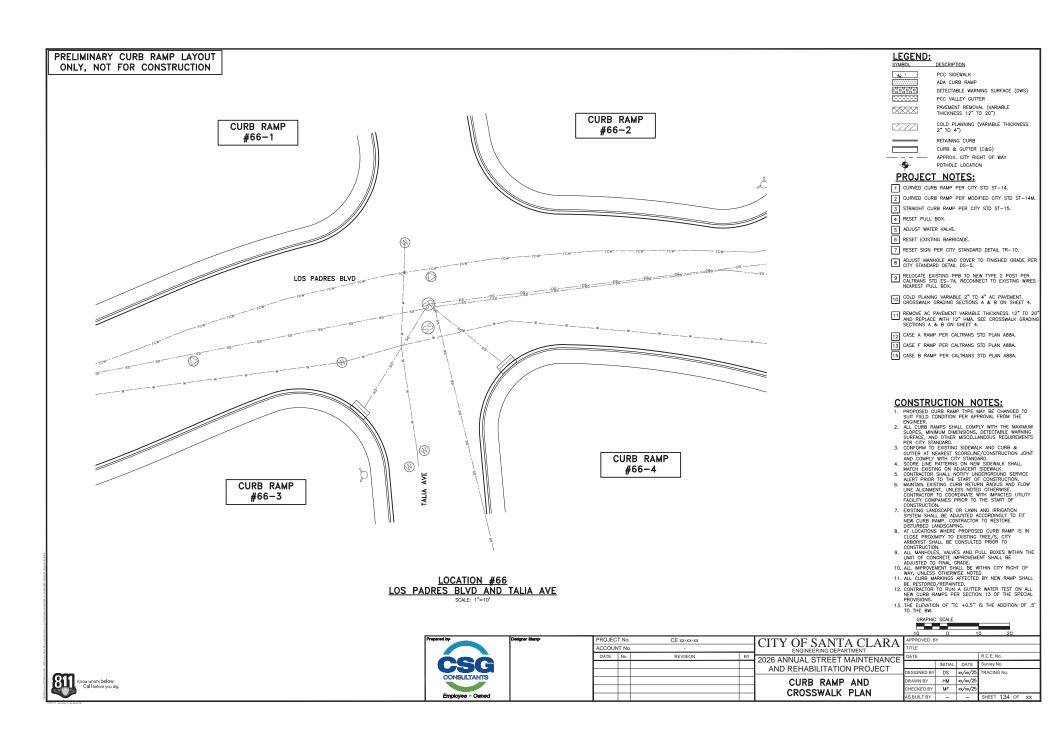

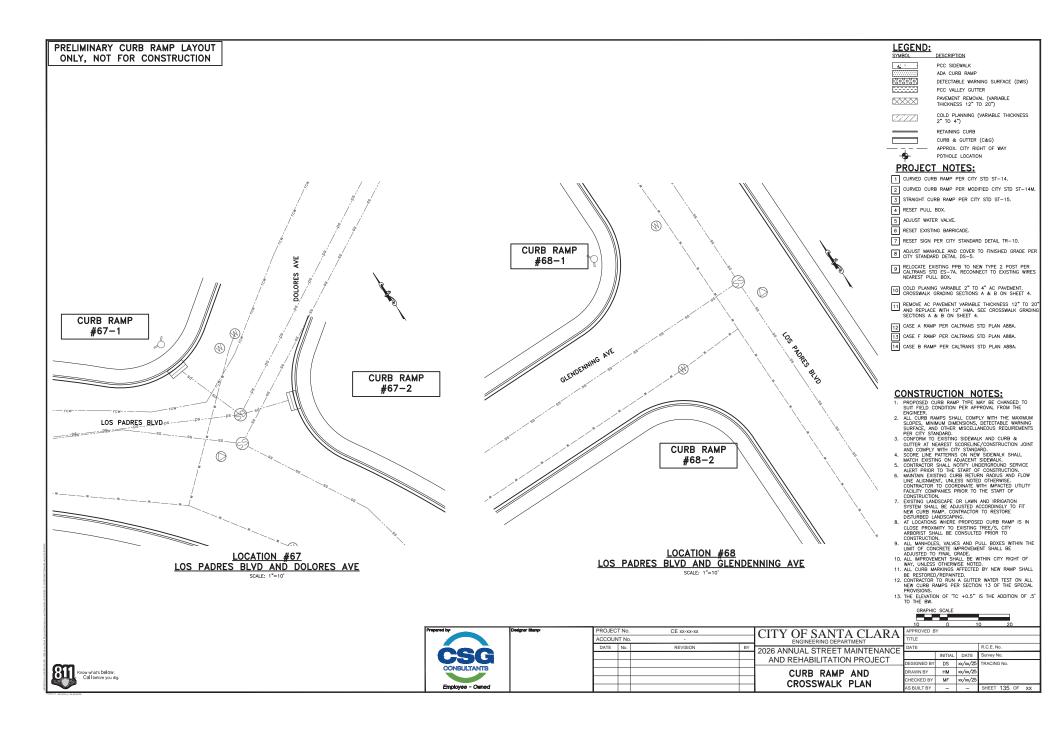

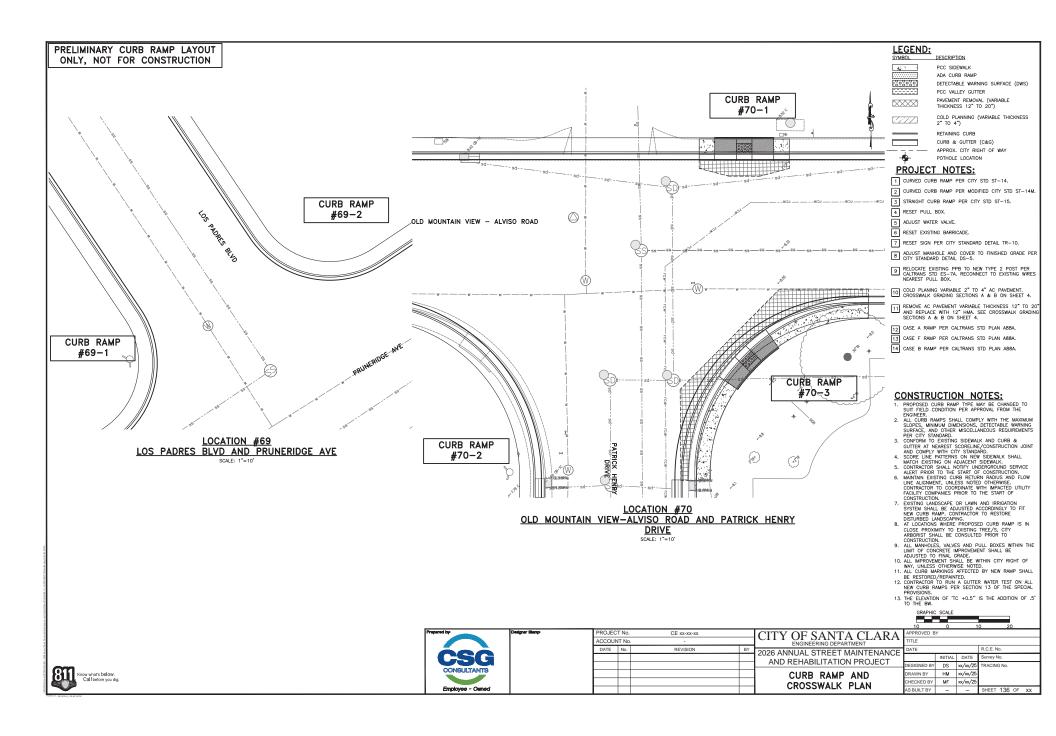

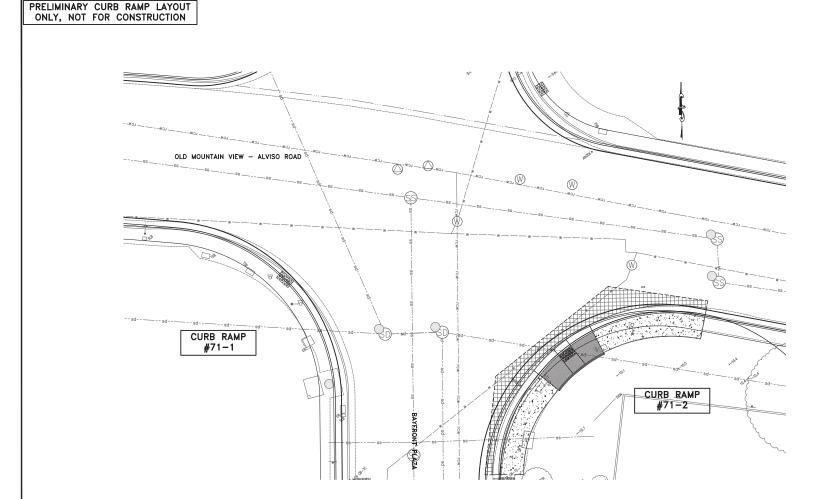

LOCATION #71 OLD MOUNTAIN VIEW-ALVISO ROAD AND BAYFRONT PLAZA LEGEND:

DESCRIPTION PCC SIDEWALK

ADA CURB RAMP 5808080

DETECTABLE WARNING SURFACE (DWS) PCC VALLEY GUTTER

PAVEMENT REMOVAL (VARIABLE THICKNESS 12" TO 20") 

COLD PLANNING (VARIABLE THICKNESS 2" TO 4") 577

RETAINING CURB CURB & GUTTER (C&G) APPROX. CITY RIGHT OF WAY POTHOLE LOCATION

**PROJECT NOTES:** 

- 1 CURVED CURB RAMP PER CITY STD ST-14.
- 2 CURVED CURB RAMP PER MODIFIED CITY STD ST-14M.
- 3 STRAIGHT CURB RAMP PER CITY STD ST-15.
- 4 RESET PULL BOX.
- 5 ADJUST WATER VALVE.
- 6 RESET EXISTING BARRICADE.
- 7 RESET SIGN PER CITY STANDARD DETAIL TR-10.
- B ADJUST MANHOLE AND COVER TO FINISHED GRADE PER CITY STANDARD DETAIL DS-5.
- 9 RELOCATE EXISTING PPB TO NEW TYPE 2 POST PER CALTRANS STD ES-7A. RECONNECT TO EXISTING WIRES NEAREST PULL BOX.
- 10 COLD PLANING VARIABLE 2" TO 4" AC PAVEMENT. CROSSWALK GRADING SECTIONS A & B ON SHEET 4.
- [11] REMOVE AC PAVEMENT VARIABLE THICKNESS 12" TO 20"
  AND REPLACE WITH 12" HMA. SEE CROSSWALK GRADING SECTIONS A & B ON SHEET 4.
- 12 CASE A RAMP PER CALTRANS STD PLAN A88A.
- 13 CASE F RAMP PER CALTRANS STD PLAN A88A.
- 14 CASE B RAMP PER CALTRANS STD PLAN A88A.

# **CONSTRUCTION NOTES:**

- PROPOSED CURB RAMP TYPE MAY BE CHANGED TO SUIT FIELD CONDITION PER APPROVAL FROM THE

- 1. PEGINDSED CURB MAMP TYPE MAY BE CHANGED IN DEPONDED TO THE STATE CONTION OF APPROVAL FROM THE BURNERS.

  2. ALL CURB RAMPS SHALL COMPLY WITH THE MAXIMUM DIMENSION, DETECTABLE WARNING SUPEACH, AND OTHER MISCELLANGOUS REQUIREMENTS.

  3. CONTORN TO EXISTING SIDEMAK AND CURB A GUITTER AT NEAREST SCORELINE/CONSTRUCTION JOINT AND COMPLY WITH CITY STANDARD.

  4. SCOPE LINE PATTERNS ON NEW SIDEMAK SHALL AND ADDRESS WITH STANDARD AND ADDRESS TO THE STATE OF CONSTRUCTION.

  5. CONTRACTOR SHALL NOTHEY UNDERGROUND SERVICE ALEET PRIOR TO THE STATE OF CONSTRUCTION.

  6. MAINTAIN EXISTING CURB RETURN RADIUS AND FLOW LINE ALIGNMENT, UNLESS NOTED OTHERWISE. TO CONTRACTOR SHALL NOTHEY OF DEWNIES.

  6. CONTRACTOR SHALL NOTHEY ONE OF THE STATE OF CONSTRUCTION.

  7. EXISTING CURB REFORE TO THE STATE OF CONSTRUCTION.

  8. AT LOCATIONS WHERE PROPOSED CURB RAMP IS IN CLOSE PROVAMILY DE RESTORE TO THE STATE OF INSTRUCTION.

  8. AT LOCATIONS WHERE PROPOSED CURB RAMP IS IN CLOSE PROVAMILY TO EXERTING THE SETS OF THE STATE.
- AT LOCATIONS WHERE PROPOSED CURB RAMP IS NO CLOSE PROMITY TO EXISTING TREE/S. CITY ARRONEST SHALL BE CONSULTED PRIOR TO ARRONEST SHALL BE CONSULTED PRIOR TO ALL MANH-PLOSE, VALVES AND PULL BOXES WITHIN THE LIMIT OF CONCRETE IMPROVEMENT SHALL BE ADJUSTED TO FINAL GRADE SHALL BE SHALL BE SHALL BE WITHIN CITY RIGHT OF THE SHALL BE RESTORED/REPAINTED.

  1. ALL CURB MARKINGS AFFECTED BY NEW RAMP SHALL BE RESTORED/REPAINTED.

  1. CONTRACTOR TO RUN A GUITER WATER TEST ON ALL NEW CURB RAMPS PER SECTION 13 OF THE SPECIAL SHALL BE SHAL

13. THE ELEVATION OF 'TC +0.5" IS THE ADDITION OF .5' TO THE BW. GRAPHIC SCALE





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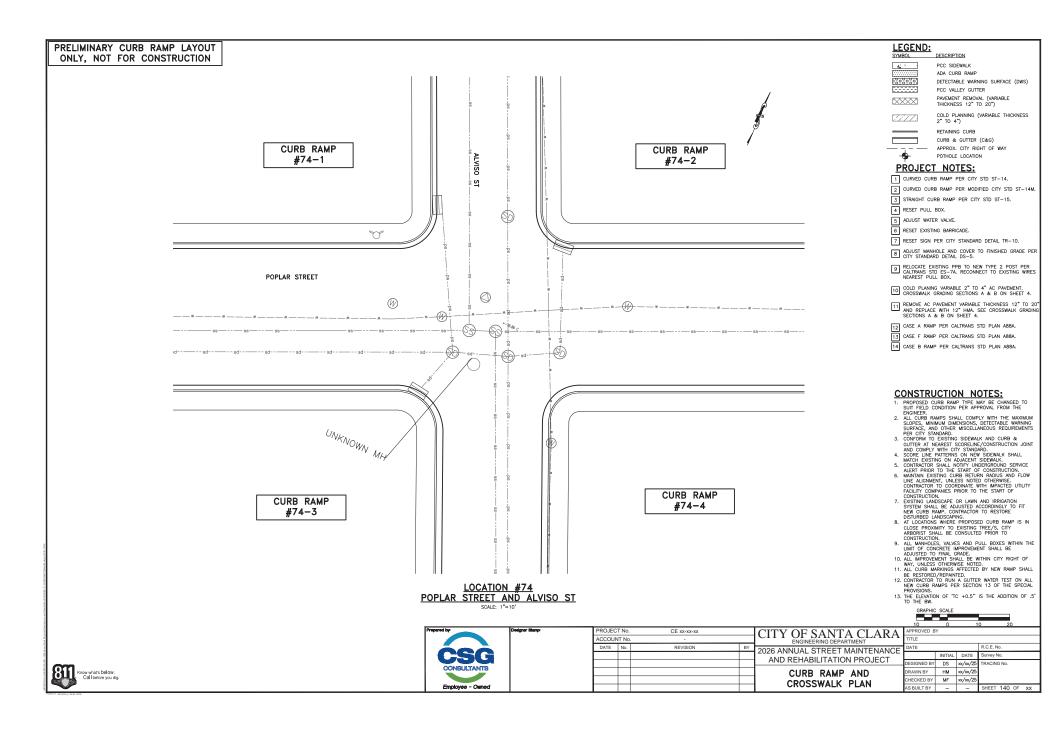
CITY OF SANTA CLAF 2026 ANNUAL STREET MAINTENAN AND REHABILITATION PROJECT CURB RAMP AND CROSSWALK PLAN


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PCC SIDEWALK

ADA CURB RAMP DETECTABLE WARNING SURFACE (DWS)

PCC VALLEY GUTTER PAVEMENT REMOVAL (VARIABLE THICKNESS 12" TO 20")

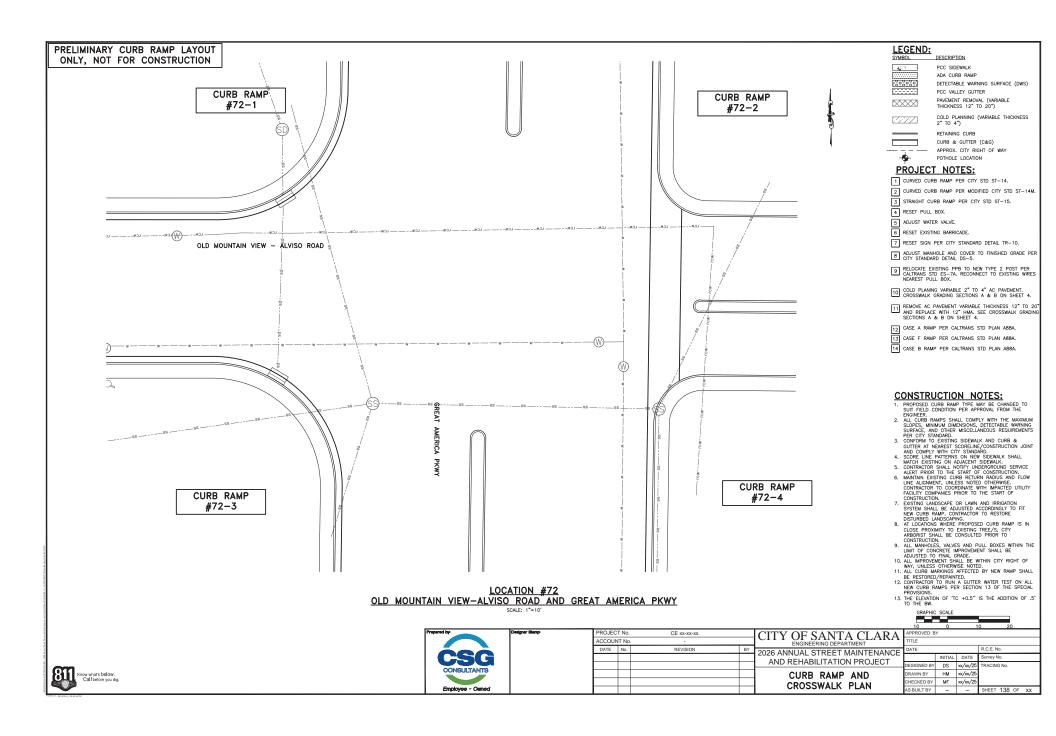COLD PLANNING (VARIABLE THICKNESS 2" TO 4")

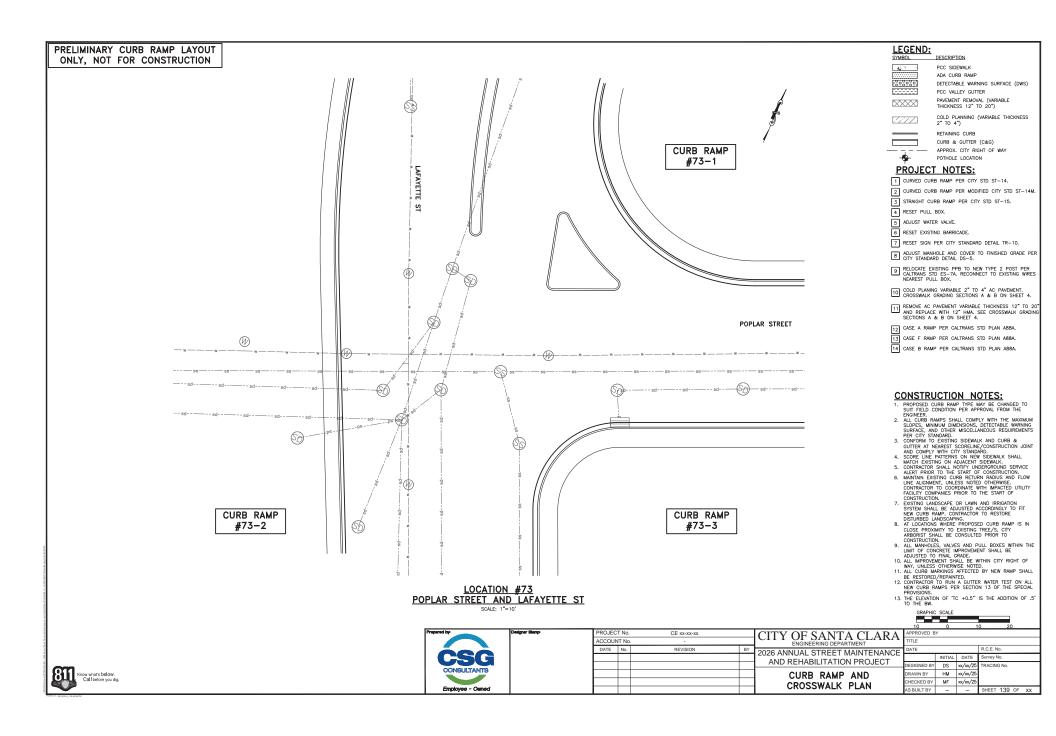RETAINING CURB

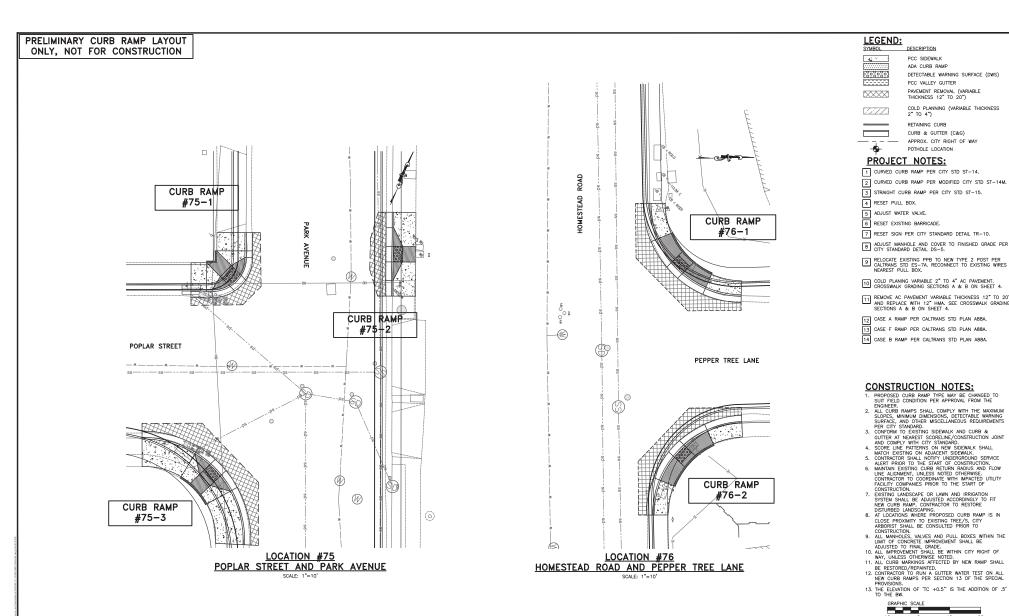CURB & GUTTER (C&G) APPROX. CITY RIGHT OF WAY POTHOLE LOCATION

#### **PROJECT NOTES:**

- 1 CURVED CURB RAMP PER CITY STD ST-14.
- 3 STRAIGHT CURB RAMP PER CITY STD ST-15.

- 6 RESET EXISTING BARRICADE.

- B ADJUST MANHOLE AND COVER TO FINISHED GRADE PER CITY STANDARD DETAIL DS-5.
- [11] REMOVE AC PAVEMENT VARIABLE THICKNESS 12" TO 20"
  AND REPLACE WITH 12" HMA. SEE CROSSWALK GRADING SECTIONS A & B ON SHEET 4.
- 12 CASE A RAMP PER CALTRANS STD PLAN A88A.
- 13 CASE F RAMP PER CALTRANS STD PLAN A88A.
- 14 CASE B RAMP PER CALTRANS STD PLAN A88A.

## **CONSTRUCTION NOTES:**

- PROPOSED CURB RAMP TYPE MAY BE CHANGED TO SUIT FIELD CONDITION PER APPROVAL FROM THE

- 13. THE ELEVATION OF 'TC +0.5" IS THE ADDITION OF .5' TO THE BW.


SHEET 141 OF XX





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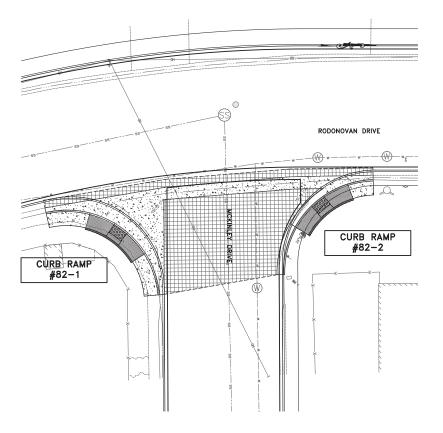
CITY OF SANTA CLARA 2026 ANNUAL STREET MAINTENANCE INITIAL DATE AND REHABILITATION PROJECT DESIGNED BY DS xx/xx/25 DRAWN BY HM xx/xx/25 CURB RAMP AND CHECKED BY MF xx/xx/25 CROSSWALK PLAN AS BUILT BY





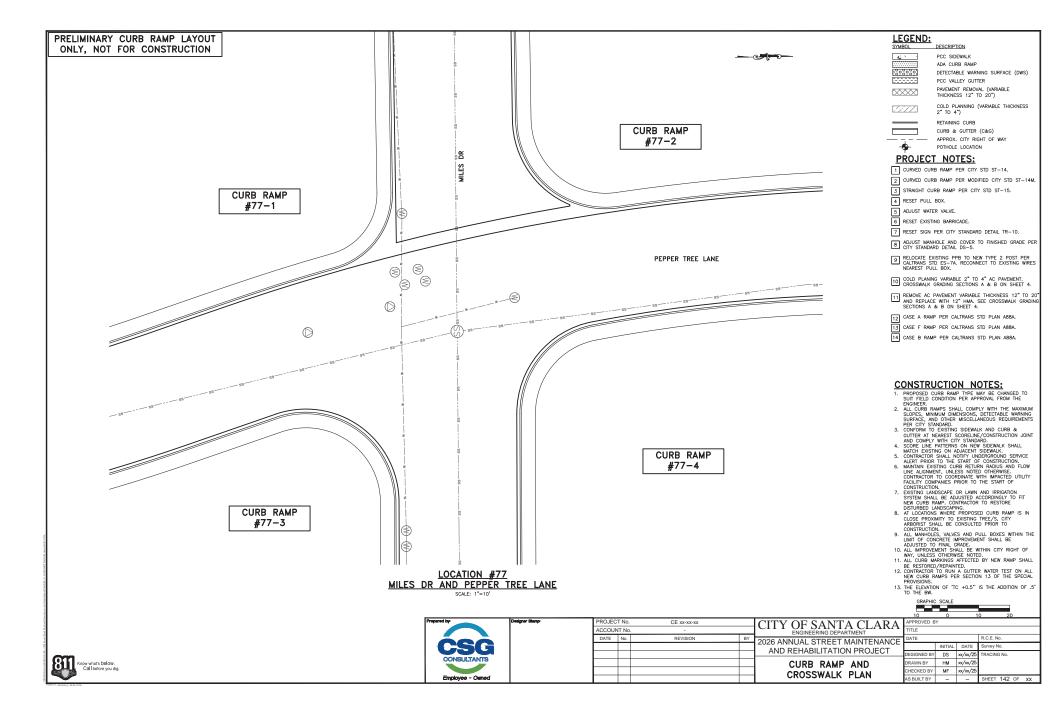

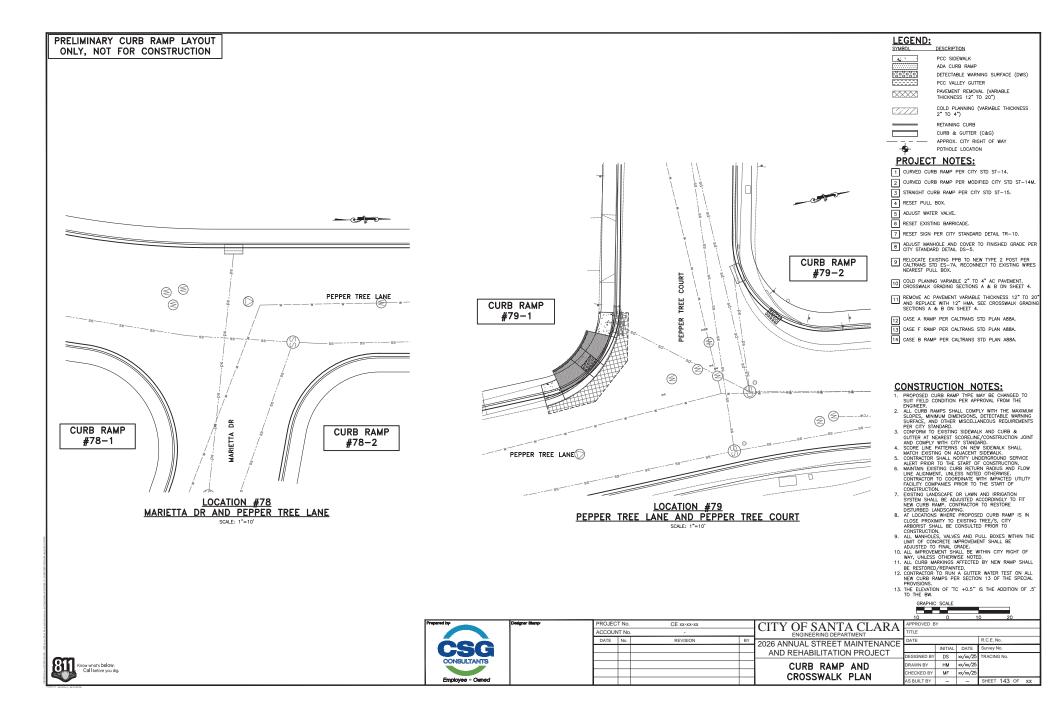

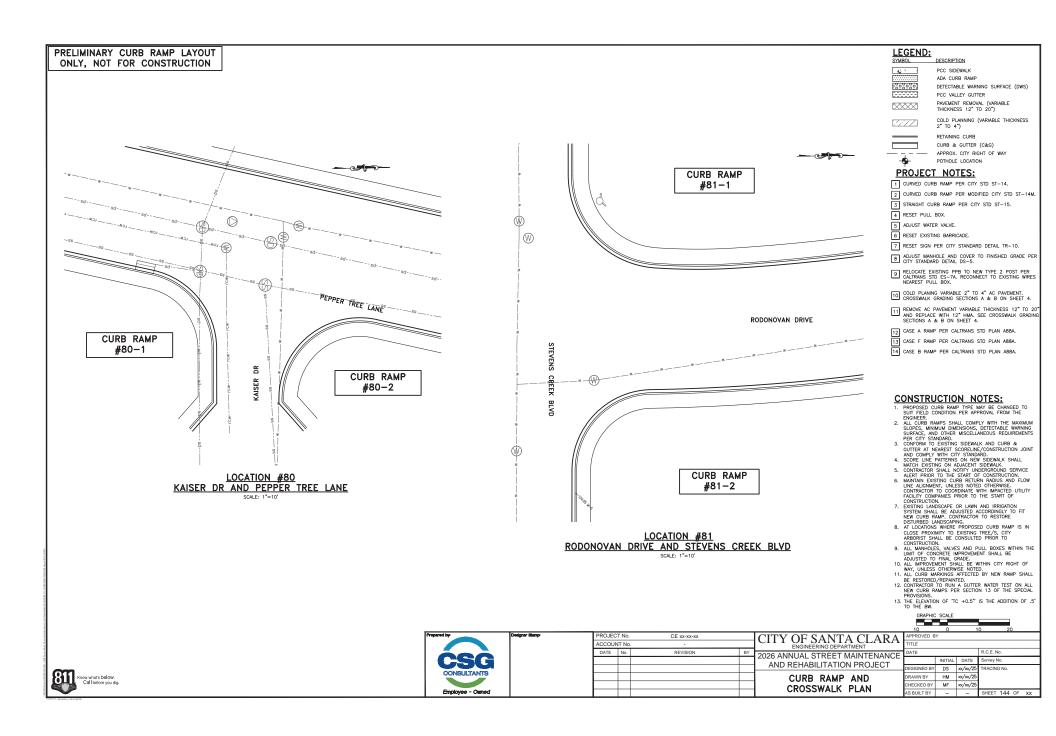

LOCATION #82 RODONOVAN DRIVE AND MCKINLEY DRIVE

LEGEND:

DESCRIPTION PCC SIDEWALK

ADA CURB RAME DETECTABLE WARNING SURFACE (DWS)

PCC VALLEY GUTTER PAVEMENT REMOVAL (VARIABLE THICKNESS 12" TO 20") 

COLD PLANNING (VARIABLE THICKNESS 2" TO 4")

RETAINING CURB CURB & GUTTER (C&G) APPROX. CITY RIGHT OF WAY

**PROJECT NOTES:** 

- POTHOLE LOCATION 1 CURVED CURB RAMP PER CITY STD ST-14.
- 2 CURVED CURB RAMP PER MODIFIED CITY STD ST-14M.
- 3 STRAIGHT CURB RAMP PER CITY STD ST-15.
- 4 RESET PULL BOX.

•

- 5 ADJUST WATER VALVE.
- 6 RESET EXISTING BARRICADE.
- 7 RESET SIGN PER CITY STANDARD DETAIL TR-10.
- B ADJUST MANHOLE AND COVER TO FINISHED GRADE PER CITY STANDARD DETAIL DS-5.
- 9 RELOCATE EXISTING PPB TO NEW TYPE 2 POST PER CALTRANS STD ES-7A. RECONNECT TO EXISTING WIRES NEAREST PULL BOX.
- 10 COLD PLANING VARIABLE 2" TO 4" AC PAVEMENT. CROSSWALK GRADING SECTIONS A & B ON SHEET 4.
- [1] REMOVE AC PAVEMENT VARIABLE THICKNESS 12" TO 20"
  AND REPLACE WITH 12" HMA. SEE CROSSWALK GRADING SECTIONS A & B ON SHEET 4.
- 12 CASE A RAMP PER CALTRANS STD PLAN A88A.
- 13 CASE F RAMP PER CALTRANS STD PLAN A88A.
- 14 CASE B RAMP PER CALTRANS STD PLAN A88A.

## **CONSTRUCTION NOTES:**

- PROPOSED CURB RAMP TYPE MAY BE CHANGED TO SUIT FIELD CONDITION PER APPROVAL FROM THE

- 1. PROPOSED CURR MAMP TYPE MAY BE CHANGED IN SEMENTARY CONDITION FOR APPROVAL FROM THE MAXIMUM SLOPES, MINIMUM DIMENSIONS, DETECTABLE WARNING SUPERACE, AND OTHER MISCELLANGOUS REQUIREMENTS OF A CONFIDENT OF EXISTING SIDEMAL AND CURR AS GUTTER AT NEAREST SCORELINE/CONSTRUCTION JOINT AND COMPLY WITH CITY STANDARD.

  4. SCOPE LINE PATTERNS ON NEW SIDEMAL SHALL AND COMPLY WITH CITY STANDARD.

  5. CONTRACTOR SHALL NOTIFY UNDERFROUND SERVICE ALERT PRIOR TO THE START OF CONSTRUCTION.

  6. MANTAIN EXISTING CURR FEITUR RADIUS AND ELOW LIVE ALIGNMENT, UNLESS NOTICE OTHERWISE.

  6. CONTRACTOR SHALL NOTIFY UNDERFROUND SERVICE OF CONSTRUCTION.

  6. MANTAIN EXISTING CURR FEITUR RADIUS AND ELOW LIVE ALIGNMENT, UNLESS NOTICE OTHERWISE.

  6. CONTRACTOR SHALL NOTIFY OF THE START OF CONSTRUCTION.

  6. STANDARD STANDARD SHORT OF THE START OF CONSTRUCTION.

  6. STANDARD SHALL SHORT OF CONTRACTOR TO RESTORE DISTURBED LANDSCAPING.

  6. AT LOCATIONS WHERE PROPOSED CURR RAMP IS IN CLOSE PROXYMITY TO EXSTING LEEPS, CITY

- AT LOCATIONS WHERE PROPOSED CURB RAMP IS NO CLOSE PROMITY TO EXISTING TREE/S. CITY ARRONEST SHALL BE CONSULTED PRIOR TO ARRONEST SHALL BE CONSULTED PRIOR TO ALL MANH-PLOSE, VALVES AND PULL BOXES WITHIN THE LIMIT OF CONCRETE IMPROVEMENT SHALL BE ADJUSTED TO FINAL GRADE SHALL BE SHALL BE SHALL BE WITHIN CITY RIGHT OF THE SHALL BE RESTORED/REPAINTED.

  1. ALL CURB MARKINGS AFFECTED BY NEW RAMP SHALL BE RESTORED/REPAINTED.

  1. CONTRACTOR TO RUN A GUITER WATER TEST ON ALL NEW CURB RAMPS PER SECTION 13 OF THE SPECIAL SHALL BE SHAL

13. THE ELEVATION OF 'TC +0.5" IS THE ADDITION OF .5' TO THE BW. GRAPHIC SCALE





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CITY OF SANTA CLA 2026 ANNUAL STREET MAINTENA AND REHABILITATION PROJECT CURB RAMP AND CROSSWALK PLAN


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LOCATION #84 ROCKHURST CT AND MACHADO AVE



LOCATION #85 STANFORD PLACE AND GEORGETOWN PLACE

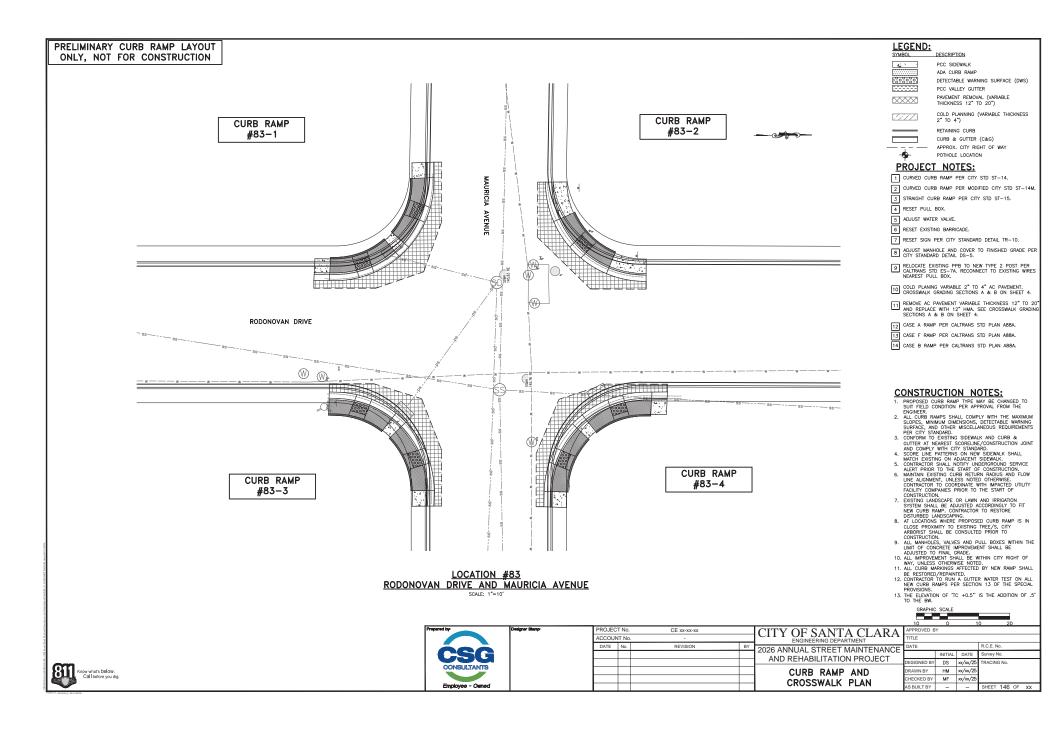LEGEND:

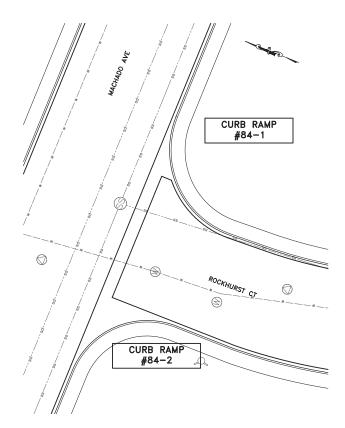DESCRIPTION PCC SIDEWALK

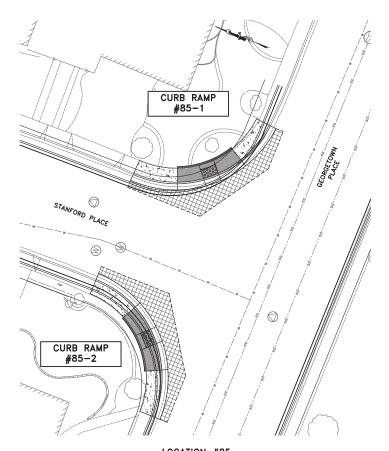ADA CURB RAMP 5000000 DETECTABLE WARNING SURFACE (DWS)

PCC VALLEY GUTTER PAVEMENT REMOVAL (VARIABLE THICKNESS 12" TO 20") 

COLD PLANNING (VARIABLE THICKNESS 2" TO 4")

RETAINING CURB CURB & GUTTER (C&G) APPROX. CITY RIGHT OF WAY

**PROJECT NOTES:** 

- 1 CURVED CURB RAMP PER CITY STD ST-14.

POTHOLE LOCATION

- 2 CURVED CURB RAMP PER MODIFIED CITY STD ST-14M. 3 STRAIGHT CURB RAMP PER CITY STD ST-15.
- 4 RESET PULL BOX.
- 5 ADJUST WATER VALVE.
- 6 RESET EXISTING BARRICADE.
- 7 RESET SIGN PER CITY STANDARD DETAIL TR-10.
- B ADJUST MANHOLE AND COVER TO FINISHED GRADE PER CITY STANDARD DETAIL DS-5.
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- 10 COLD PLANING VARIABLE 2" TO 4" AC PAVEMENT. CROSSWALK GRADING SECTIONS A & B ON SHEET 4.
- [11] REMOVE AC PAVEMENT VARIABLE THICKNESS 12" TO 20"
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- 12 CASE A RAMP PER CALTRANS STD PLAN A88A.
- 13 CASE F RAMP PER CALTRANS STD PLAN A88A.
- 14 CASE B RAMP PER CALTRANS STD PLAN A88A.

## **CONSTRUCTION NOTES:**

- PROPOSED CURB RAMP TYPE MAY BE CHANGED TO SUIT FIELD CONDITION PER APPROVAL FROM THE

- 1. PEGINDSED CURB MAMP TYPE MAY BE CHANGED IN DEPONDED TO THE STATE CONTION OF APPROVAL FROM THE BURNERS.

  2. ALL CURB RAMPS SHALL COMPLY WITH THE MAXIMUM DIMENSION, DETECTABLE WARNING SUPEACH, AND OTHER MISCELLANGOUS REQUIREMENTS.

  3. CONTORN TO EXISTING SIDEMAK AND CURB A GUITTER AT NEAREST SCORELINE/CONSTRUCTION JOINT AND COMPLY WITH CITY STANDARD.

  4. SCOPE LINE PATTERNS ON NEW SIDEMAK SHALL AND ADDRESS WITH STANDARD AND ADDRESS TO THE STATE OF CONSTRUCTION.

  5. CONTRACTOR SHALL NOTHEY UNDERGROUND SERVICE ALEET PRIOR TO THE STATE OF CONSTRUCTION.

  6. MAINTAIN EXISTING CURB RETURN RADIUS AND FLOW LINE ALIGNMENT, UNLESS NOTED OTHERWISE. TO CONTRACTOR SHALL NOTHEY OF DEWNIES.

  6. CONTRACTOR SHALL NOTHEY ONE OF THE STATE OF CONSTRUCTION.

  7. EXISTING CURB REFORE TO THE STATE OF CONSTRUCTION.

  8. AT LOCATIONS WHERE PROPOSED CURB RAMP IS IN CLOSE PROVAMILY DE RESTORE TO THE STATE OF INSTRUCTION.

  8. AT LOCATIONS WHERE PROPOSED CURB RAMP IS IN CLOSE PROVAMILY TO EXERTING THE SETS OF THE STATE.

- AT LOCATIONS WHERE PROPOSED CURB RAMP IS NO CLOSE PROMITY TO EXISTING TREE/S. CITY ARRONEST SHALL BE CONSULTED PRIOR TO ARRONEST SHALL BE CONSULTED PRIOR TO ALL MANH-PLOSE, VALVES AND PULL BOXES WITHIN THE LIMIT OF CONCRETE IMPROVEMENT SHALL BE ADJUSTED TO FINAL GRADE SHALL BE SHALL BE SHALL BE WITHIN CITY RIGHT OF THE SHALL BE RESTORED/REPAINTED.

  1. ALL CURB MARKINGS AFFECTED BY NEW RAMP SHALL BE RESTORED/REPAINTED.

  1. CONTRACTOR TO RUN A GUITER WATER TEST ON ALL NEW CURB RAMPS PER SECTION 13 OF THE SPECIAL SHALL BE SHAL

13. THE ELEVATION OF 'TC +0.5" IS THE ADDITION OF .5' TO THE BW. GRAPHIC SCAL

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CONSULTANTS
Employee - Owned


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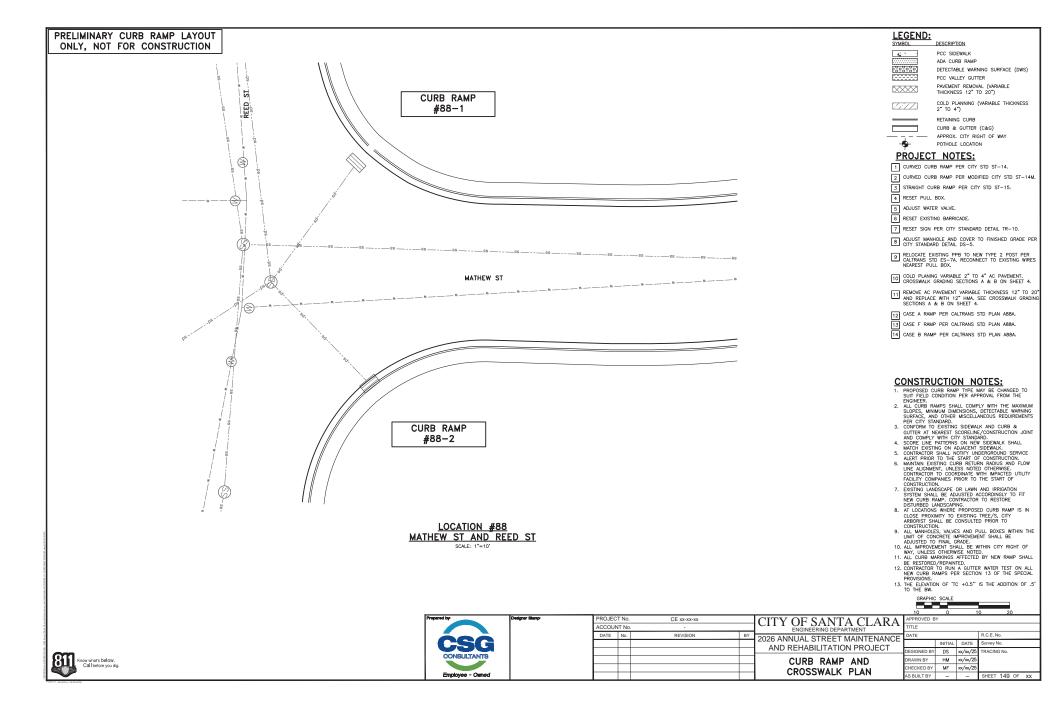
CITY OF SANTA CLARA 2026 ANNUAL STREET MAINTENANCE AND REHABILITATION PROJECT


CURB RAMP AND CROSSWALK PLAN

INITIAL DATE DESIGNED BY DS xx/xx/25 DRAWN BY HM xx/xx/25 CHECKED BY MF xx/xx/25





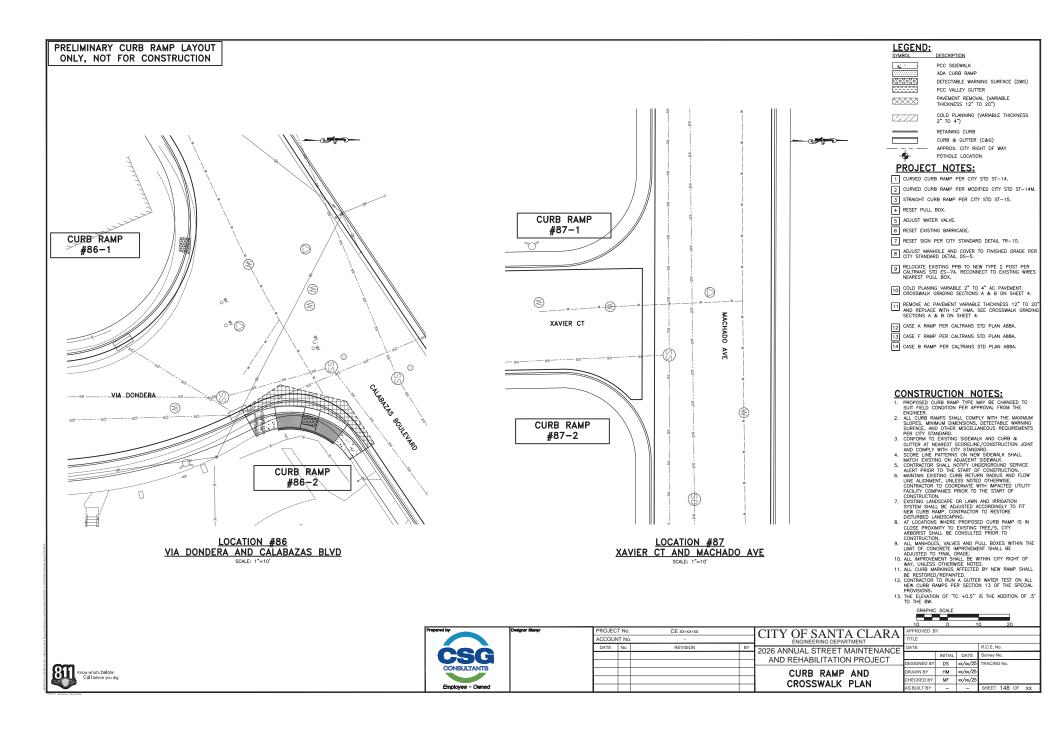

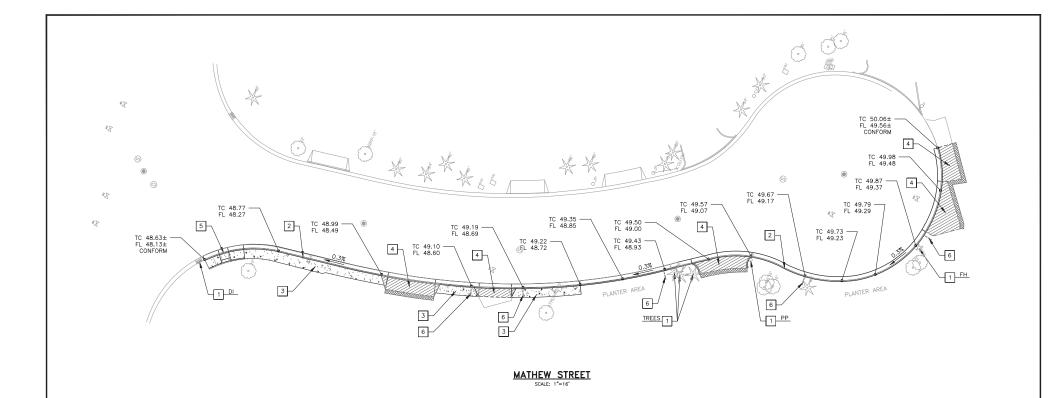

# LEGEND:

SYMBOL DESCRIPTION PCC SIDEWALK PCC DRIVEWAY CURB & GUTTER (C&G) 12" HMA CONFORM SAWCUT

3" PIPE CURB OUTLET

# **PROJECT NOTES:**

- 1 PROTECT IN PLACE.
- 3 REMOVE AND REPLACE EXISTING CONCRETE SIDEWALK PER CITY STD DWG ST-12.
- REMOVE AND REPLACE EXISTING PCC DRIVEWAY PER CITY STD DWG ST-4.
- 5 REMOVE AND REPLACE EXISTING PCC CURB RAMP PER CITY STD DWG ST-14,
- $\fbox{6}$  REMOVE AND REPLACE EXISTING 3" PIPE CURB OUTLET PER CITY STD SD-1.

# **CONSTRUCTION NOTES:**

- CONTRACTOR SHALL NOTIFY UNDERGROUND SERVICE ALERT PRIOR TO THE START OF CONSTRUCTION. CONTRACTOR TO COORDINATE WITH IMPACTED UTILITY FACILITY COMPANIES PRIOR TO THE START OF CONSTRUCTION.

   EXISTING LANDSCAPE OR LAWN AND IRRIGATION SYSTEM SHALL BE ADJUSTED ACCORDINGLY.

  ALLOCATIONS IN CLOSE PROVINCE TO CONSTRUCTION.

- ACCORDINGLY.

  3. AT LOCATIONS IN CLOSE PROXIMITY TO EXISTING TREE/S, CITY ARBORIST SHALL BE CONSULTED PRIOR TO CONSTRUCTION.

  4. ALL MANHOLES, VALVES AND PULL BOXES WITHIN THE LIMIT OF IMPROVEMENT SHALL BE ADJUSTED TO FINAL GRADE.


  5. ALL IMPROVEMENT SHALL BE WITHIN CITY RIGHT OF WAY.


  6. ALL EXISTING FACILITIES SHALL BE PROTECTED IN PLACE UNLESS OTHERWISE NOTED.


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CITY OF SANTA CLARA 2026 ANNUAL STREET MAINTENANCE INITIAL DATE AND REHABILITATION PROJECT DESIGNED BY DS xx/xx/25 DRAWN BY HM xx/xx/25 MATHEW STREET CHECKED BY MF xx/xx/25 **C&G REPLACEMENT** 





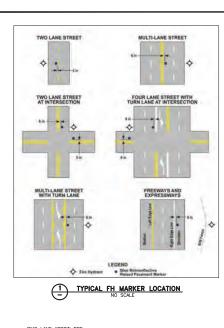

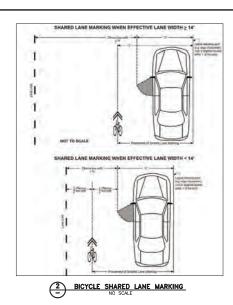

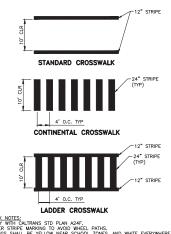CROSSWALK NOTES:


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1. COMETY WITH CALIFIANS TO FLAM PLAFE

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1. COMETY PLAFE TYPICAL CROSSWALK MARKINGS
NO SCALE




IN PAVEMENT SIGN DETAIL


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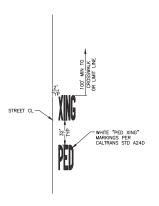


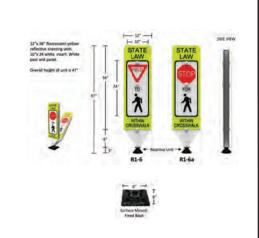




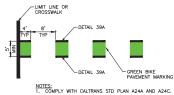



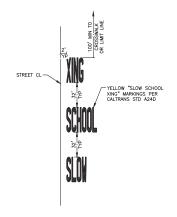




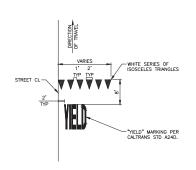



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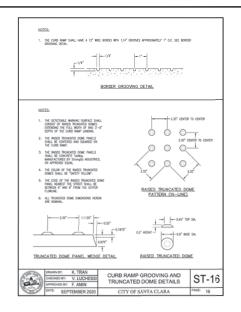
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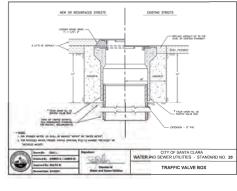
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Ė					COUNT NO. ENGINEERING DEPARTMENT ATE NO. REVISION BY 2026 ANNUAL STREET MAINTENANCE AND REHABILITATION PROJECT CONSTRUCTION DETAILS	COUNT NO. ENGINEERING DEPARTMENT ATE NO. REVISION BY 2026 ANNUAL STREET MAINTENANCE AND REHABILITATION PROJECT  DESIGNED BY DRAWM BY DRAWM BY	COUNT No.	COUNT NO.	COUNT No.	COUNT No.





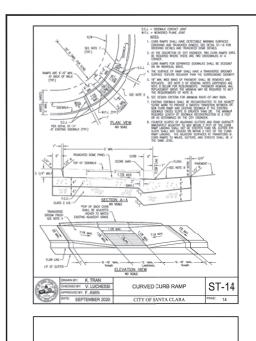

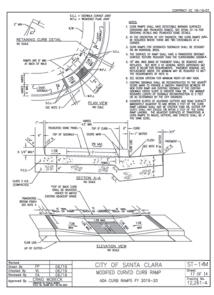

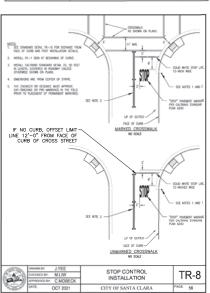

SHEET 152 OF XX



1. FOUR (4) LOOPS FOR LETT AND RIGHT TURN LANES, THREE (3) LOOPS FOR STRAIGHT THROUGH LOOPS TO BE OUT IN A 6"HE" QUID CONFIGURATION. LOOP MIRKS SHILL BE WERFIED BY CITY TRAFFIC STAFF (72 HOURS ADMINISE INTENDATION REQUIRES) UNLESS CHIEDRINS MOTED. 3. DETECTOR LOOPS SHALL BE THPE "Q". DETECTOR LOOP WIRE SHALL BE THPE 1. LEND IN CARLE SHALL CONFORM TO THPE IL LOOP WRING IS TO BE WIRAPPED IN A 3-4-3 CONTOLINATION. 5. SELANT SHALL BE HOT MELT RUBBEIZED ASPHALT. FINISHED PRODUCT MUST BE AT A MINIMUM STREET LENGL OR ABOVE.

- DIRECTION OF TRAFFIC



	PROJEC	T No.	CE xx-xx-xx		CITY OF SANTA CLARA	APPROVED B	Y		
	ACCOUN	IT No			ENGINEERING DEPARTMENT	TITLE			
	DATE	No.	REVISION	BY	2026 ANNUAL STREET MAINTENANCE	DATE			R.C.E. No.
					AND REHABILITATION PROJECT		INITIAL	DATE	Survey No.
					AND REHABILITATION PROJECT	DESIGNED BY	DS	xx/xx/25	TRACING No.
					CONCERNICATION DETAILS	DRAWN BY	НМ	xx/xx/25	l
					CONSTRUCTION DETAILS	CHECKED BY	MF	xx/xx/25	
						AS BUILT BY	-	-	SHEET 152
_									

now what's below. Call before you dig.

## **Construction Best Management Practices (BMPs)**

Construction projects are required to implement year-round stormwater BMPs.

#### Materials & Waste Management



#### Non-Hazardous Materials

- D Berm and cover stockpiles of sand, dirt or other construction material with tarps when rain is forecast or when they are not in use,
- Use (but don't overuse) reclaimed water for dust control.
- ☐ Ensure dust control water doesn't leave site or discharge to storm

#### Hazardous Materials

- ☐ Label all hazardous materials and hazardous wastes (such as pesticides, paints, thinners, solvents, fuel, oil, and antifreeze) in accordance with City, County, State and Federal regulations.
- ☐ Store buzardous materials and wastes in water birbt containers, store in appropriate secondary containment, and cover them at the end of every work day or during wet weather or when rain is forecast.
- ☐ Follow manufacturer's application instructions for hazardous naterials and do not use more than necessary. Do not apply chemicals outdoors when rain is forecast within 24 hours.
- ☐ Arrange for appropriate disposal of all hazardous wastes.

#### Waste Management

- ☐ Cover and maintain dumpsters. Check frequently for leaks. Place dumpsters under roofs or cover with tarps or plastic sheeting secured around the outside of the dumpster. A plastic liner is recommended to prevent leaks. Never clean out a dampster by hosing it down on the
- D Place portable toilets away from storm drains. Make sure they are in good working order. Check frequently for leaks.
- Dispose of all wastes and demolition debris properly. Recycle terials and wastes that can be recycled, including solvents, waterbased paints, vehicle fluids, broken asphalt and concrete, wood, and cleared vegetation.
- Disnose of limid residues from mints thinners, solvents, whose and cleaning fluids as hazardous waste
- ☐ Keep site free of litter (e.g. lunch items, eigarette butts).
- D Prevent litter from uncovered loads by covering loads that are being transported to and from site.

#### Construction Entrances and Perimeter

- ☐ Establish and maintain effective perimeter controls and stabilize all construction entrances and exits to sufficiently control erosion and sediment discharges from site and tracking off site.
- ☐ Sweep or vacuum any street tracking immediately and secure diment source to prevent further tracking. Never hose down streets to clean up tracking

#### Equipment Management & Spill Control



#### Maintenance and Parking

- Designate an area of the construction site, well away from streams or storm drain inlets and fitted with appropriate BMPs, for auto and equipment parking, and storage.
- Perform major maintenance, repair jobs, and vehicle and equipment washing off site.
- ☐ If refueling or vehicle maintenance must be done onsite, work in a bermed area away from storm drains and over a drip pan or drop cloths big enough to collect fluids. Recycle or dispose of fluids as hazardous waste.
- If vehicle or equipment cleaning must be done onsite. clean with water only in a bermed area that will not allow rinse water to run into gutters, streets, storm drains, or surface waters.
- Do not clean vehicle or equipment onsite using soaps. solvents, degreasers, or steam cleaning equipment, and do not use diesel oil to lubricate equipment or parts

#### Spill Prevention and Control

- G Keep spill cleanup materials (e.g., rags, absorbems and cat litter) available at the construction site at all times. Maintain all vehicles and heavy equipment. Inspect frequently for and repair leaks. Use drip pans to catch
- leaks until repairs are made. Clean up leaks, drips and other spills immediately and dispose of cleanup materials properly.
- Use dry cleanup methods whenever possible (absorbent materials, car litter and/or rags).
- ☐ Sweep up spilled dry materials immediately. Never attempt to "wash them away" with water, or bury
- Clean up spills on dirt areas by digging up and properly disposing of contaminated soil
- Report significant spills to the appropriate local spill esponse agencies immediately. If the spill poses a significant hazrd to human health and safety, property or the environment, you must report it to the Stat Office of Emergency Services, (800) 852-7550 (24

#### Earthmoving



#### Grading and Earthwork ☐ Schedule grading and excavation work

- during dry weather. Stabilize all denuded areas, install and maintain temporary erosion controls (such as erosion control fabric or bonded fiber
- matrix) until vegetation is established. Remove existing vegetation only when absolutely necessary, plant temporary vegetation for ension control on slones or where construction is not immediately
- Prevent sediment from migrating offsite and protect storm drain inlets, drainage courses and streams by installing and maintaining appropriate BMPs (i.e. silt fences, gravel bags, fiber rolls, temporary swales, etc.).
- Reen excavated soil on site and transfer it. to dump trucks on site, not in the streets.

#### Contaminated Soils

- Abandoned wells

- ☐ If any of the following conditions are observed, test for contamination and contact the Regional Water Quality Connol Board:
- Unusual soil conditions, discoloration, or odor.
- Abandoned imderground tanks:
- Buried barrels, debris, or trash.
- ☐ If the above conditions are observed. document any signs of potential contamination and clearly mark them so they are not distrurbed by construction activities.

#### Landscaping

- ☐ Protect stockpiled landscaping materials from wind and rain by storing them under tarps all year-round.
- ☐ Stack bagged material on pallets and under cover.
- Discontinue application of any erodible landscape material within 2 days before a forecast rain event or during wet weather.

#### Concrete Management and Dewatering



#### Concrete Management

- Store both dry and wet materials under cover, protected from rainfull and runolT and away from storm drains or waterways. Store materials off the ground, on pallets. Protect dry materials from wind.
- ☐ Wash down exposed aggregate concrete only when the wash water can (1) flow onto a dirt area; (2) drain onto a bermed surface from which it can be pumped and disnosed of properly; or (3) block any storm drain inlets and vacuum washwater from the gutter. If possible, sweep first.
- ☐ Wash out concrete equipment/trucks offsite or in a designated washout area onsite; where the water will flow into a temporary waste pit, and make sure wash water does not leach into the underlying soil. (See CASQA Construction BMP Handbook for properly designed concrete washouts.)

- Discharges of groundwater or captured runoff from dewatering operations must be properly managed and disposed. When possible, send dewatering discharge to landscaped area or sanitary sewer. If discharging to the sanitary sewer, call your local wastewater treatment plant.
- ☐ Divert run-on water from offsite away from all disturbed areas.
- ☐ When dewatering, notify and obtain approval from the local municipality before discharging water to a street gutter or storm drain. Filtration or diversion through a basin tank, or sediment trap may be required.
- In areas of known or suspected contamination, call your local agency to determine whether the ground water must be tested. Pumped groundwater may need to be collected and hauled off-site for treatment and proper disposal.

### Paving/Asphalt Work



- Avoid paving and seal coating in wer weather or when rain is forecast, to prevent materials that have not cared from contacting stormwater runoff.
- Cover storm drain inlets and manhales when applying seal coat, slurry seal, fog
- ☐ Collect and recycle or properly dispose of excess abrasive gravel or sand. Do NOT sweep or wash it into gutters.

#### Sawcutting & Asphalt/Concrete Removal

- Protect storm drain inlets during saw
- If saw out slurry enters a catch basin, clean it up immediately.
- ☐ Shovel or vacuum saw cut slurry deposits and remove from the site. When making saw cuts, use as little water as possible, Sweep up, and properly dispose of all

#### Painting & Paint Removal



#### Painting Cleanup and Removal

- ☐ Never clean brushes or rinse paint containers into a street, gutter, storm drain, or stream
- U For water-based paints, paint out brushes to the extent possible, and rinse into a drain that goes to the sanitary sewer. Never pour paint down a storm drain
- Tor oil-based paints, paint out brushes to the extent possible and clean with thinner or solvent in a proper container. Filter and reuse thinners and solvents. Dispose of excess liquids as hazardous waste
- ☐ Sweep up or collect paint chips and dust from non-hazardous dry stripping and sand blasting into plastic drop cloths and dispose of as trash.
- Chemical paint stripping residue and chips and dust from marine paints or paints containing lead, mercury, or tributyltin must be disposed of as hazardous waste Lead based paint removal requires a state certified contractor.



Storm drain polluters may be liable for fines of up to \$10,000 per day!



CE xx-xx-xx ACCOUNT NO DATE No. REVISION

CITY OF SANTA CLARA 2026 ANNUAL STREET MAINTENANCE AND REHABILITATION PROJECT CONSTRUCTION BEST

INITIAL DATE ESIGNED BY DS xx/xx/25 RACING NO RAWN BY HM xx/xx/25 HECKED BY MF xx/xx/2 MANAGEMENT PRACTICES (BMPs)





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## Agenda Report

25-1083 Agenda Date: 10/27/2025

## REPORT TO BICYCLE AND PEDESTRIAN ADVISORY COMMITTEE

### **SUBJECT**

Revise Traffic Calming Policy from 1999; Review, Revise, and Update City's Neighborhood Traffic Calming Program (Chan)

## BACKGROUND

Bicycle and Pedestrian Advisory Committee (BPAC) Member Kratz and former BPAC Member Casamajor requested to have BPAC review, revise, and update the City's Neighborhood Traffic Calming Program (Attachments 1 and 2).

The City's Neighborhood Traffic Calming Program (NTCP) was approved in 1999 by City Council. It was designed to improve safety and livability in residential streets by addressing speeding, cutthrough traffic, visibility issues, and intersection control concerns. Its goals include protecting pedestrians and bicyclists, reducing collisions, and minimizing noise and safety hazards, thereby enhancing overall neighborhood quality of life. The program uses a mix of enforcement, engineering solutions (such as radar speed signs, striping, high-visibility crosswalks, speed humps, traffic circles, and chokers), and community engagement to develop effective solutions. Residents can submit concerns, after which the City evaluates traffic conditions, seeks neighborhood input, and implements agreed-upon calming measures.

### DISCUSSION

As part of the ongoing Vision Zero Study, the City has identified the NTCP for a comprehensive update to align with modern traffic calming practices and strengthen community engagement in support of Vision Zero goals. The update will focus on incorporating best-practice design tools, revising thresholds for resident support, and streamlining processes to more effectively respond to neighborhood concerns. It will also evaluate how the program integrates with citywide safety goals and multimodal planning initiatives.

Work on the NTCP update is anticipated to begin in Summer 2026. The process will include community outreach meetings, workshops, and presentations to City commissions to gather input and recommendations. This collaborative approach is intended to create a more transparent, equitable, and responsive program while advancing the City's proposed Vision Zero commitment to eliminate traffic-related fatalities and serious injuries.

Written by: Steve Chan, Transportation Manager, Public Works Approved by: Michael Liw, Assistant Director/City Engineer, Public Works

## ATTACHMENT

1. Work Plan Topic Request Form - Review, Revise and Update City's Neighborhood Traffic Calming Program (Kratz)

25-1083 Agenda Date: 10/27/2025

2. Work Plan Topic Request Form - Revise Traffic Calming Policy from 1999 (Casamajor)

## Item #15



### **DEPARTMENT OF PUBLIC WORKS - TRAFFIC ENGINEERING DIVISION**

1500 Warburton Ave, Santa Clara, CA 95050

Tel: 408.615.3000 Fax: 408-983-0931 Email: engineering@santaclaraca.gov

## Bicycle and Pedestrian Advisory Committee Annual Work Plan Topic Request Form

Requestor Name:	ken kratz	July 26, 2024					
Proposed Topic Title:	Review, revise and update City's Neighborhood	d Traffic Calming Program					
	Background and Discussion: Please provide justification regarding how this topic pertains to the Bicycle and Pedestrian Advisory Committee's roles and responsibilities:						
Calming Program (NT)	nake recommendations to revise and update the CCP). BPAC recommendations to be circulated to value and approval prior to submission to the City Coun	arious city advisory					
	pedestrian safety as well as the safety of other street vehicle speeds in our city.	eet users because traffic					

Revised: 7/28/2021 Page 1 of 1



### **DEPARTMENT OF PUBLIC WORKS - TRAFFIC ENGINEERING DIVISION**

1500 Warburton Ave, Santa Clara, CA 95050

**Tel**: 408.615.3000 **Fax**: 408-983-0931 Email: engineering@santaclaraca.gov

## Bicycle and Pedestrian Advisory Committee Annual Work Plan Topic Request Form

Requestor Name:	Jane Casamajor	Date:	7/10/23				
Proposed Topic Title:	Proposed Topic Title: Revise traffic calming policy from 1999						
	esion: Please provide justification regarding how this top y Committee's roles and responsibilities:	oic perta	ins to the Bicycle				
	e course of this year we have raised the issue that of date and does not serve modern needs for lival						
I would like this group council for approval.	to review and revise the traffic calming policy for s	ubmiss	ion to the city				

Revised: 7/28/2021 Page 1 of 1



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## Agenda Report

25-1080 Agenda Date: 10/27/2025

## REPORT TO BICYCLE AND PEDESTRIAN ADVISORY COMMITTEE

## **SUBJECT**

San Tomas Aquino Creek Trail Closures, Detours, and Public Noticing for Upcoming Major Events (Chan)

## **BACKGROUND**

Major stadium events are scheduled for 2026, including Super Bowl 60 and the FIFA World Cup. These events are expected to draw larger crowds, including visitors from outside the region, and carry a higher public profile than typical stadium activities. As a result, enhanced security measures will be required, which are anticipated to necessitate longer periods of closure for the San Tomas Aguino Creek Trail than those typically associated with regular stadium events.

## DISCUSSION

City staff has begun coordination with the NFL regarding logistical planning for Super Bowl 60, scheduled for February 2026. In contrast, FIFA has not yet engaged the city regarding transportation planning for World Cup events scheduled for June and July 2026.

These high-profile events are expected to require extended closures of the San Tomas Aquino Creek Trail adjacent to the stadium, most likely exceeding typical closure durations for stadium events. Specific pedestrian and bicycle detours are currently being developed by NFL with input from the City to maintain safe and efficient travel around the area during these events. Due to the sensitive security nature of these events, the city has been advised that planning details cannot be publicly released at this time; however, the information will be shared in a timely manner once it can be made public.

Written by: Steve Chan, Transportation Manager, Public Works

Approved by: Michael Liw, Assistant Director/City Engineer, Public Works



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## Agenda Report

25-1082 Agenda Date: 10/27/2025

## REPORT TO BICYCLE AND PEDESTRIAN ADVISORY COMMITTEE

## **SUBJECT**

Report on Funding Opportunities (Garcia)

## **BACKGROUND**

In July 2024, Bicycle and Pedestrian Advisory Committee (BPAC) Member Kratz requested to have BPAC discuss funding opportunities for bicycle and pedestrian programs and infrastructure (Attachment 1).

## **DISCUSSION**

Bicycle and pedestrian infrastructure projects and programs are initiated by several sources including:

- General Plan
- Specific and Precise Master Plans
- City-wide Bicycle Master Plan
- City-wide Pedestrian Master Plan
- Specific Roadway Corridor Bicycle/Pedestrian/Complete Streets Plans
- Vision Zero Plan (Future)
- ADA Self Evaluation and Transition Plan
- Annual Street Maintenance and Rehabilitation Projects
- Multi-jurisdictional and Agency Partner Projects
- Private Developer Projects and Improvements
- Resident/Community Requests

Infrastructure improvements developed from these sources are often grouped into a single project that can be done more efficiently, such as installing curb ramps at multiple intersections or completing school safety improvements at several locations. In order for projects to be completed or programs to be initiated, a funding source or multiple funding sources need to be identified. Funding sources for bicycle and pedestrian projects can provided by the following:

- General Fund
- Infrastructure Bond Measure
- Traffic Dedicated Funding (Gas Tax)
- Development Traffic Fees
- Developer Improvements
- Grants

25-1082 Agenda Date: 10/27/2025

Infrastructure projects are often broken up into phases to be completed in a reasonable timeline and manageable budget. Phases usually consist of an analysis / planning phase, design phase, and construction phase. Although, it may be advantageous to combine phases into a single project.

Projects initiated by the City are included in the Adopted Biennial Capital Improvement Program (CIP) Budget document that details the projects and identifies funding sources. Projects included in the document may be fully funded, partially funded, or completely unfunded. For bicycle and pedestrian projects identified in City plans or CIP projects that lack full funding, City staff look for funding opportunities through other means such as private developments and grants.

Private developments may be conditioned for full or partial responsibility for bicycle and pedestrian improvements if there is a correlation between the development and the facility. A recent example of developer installed improvements are sidewalks, ramps, and bike lanes in the Tasman East area. In addition, new developments must pay a Traffic Impact Fee based on the size of the development. A part of the fees collected is dedicated to citywide bicycle and pedestrian projects. Information about the Traffic Impact Fee can be found at:

<a href="https://www.santaclaraca.gov/our-city/departments-g-z/public-works/engineering/traffic-engineering/transportation-studies-master-plans/transportation-analysis-policy-update>"> thttps://www.santaclaraca.gov/our-city/departments-g-z/public-works/engineering/traffic-engineering/transportation-studies-master-plans/transportation-analysis-policy-update>"> thttps://www.santaclaraca.gov/our-city/departments-g-z/public-works/engineering/traffic-engineering/traffic-engineering/traffic-engineering/transportation-studies-master-plans/transportation-analysis-policy-update>"> thttps://www.santaclaraca.gov/our-city/departments-g-z/public-works/engineering/traffic-engineering/traffic-engineering/transportation-studies-master-plans/transportation-analysis-policy-update>"> thttps://www.santaclaraca.gov/our-city/departments-g-z/public-works/engineering/transportation-analysis-policy-update>"> thttps://www.santaclaraca.gov/our-city/departments-g-z/public-works/engineering/transportation-analysis-policy-update>"> thttps://www.santaclaraca.gov/our-city/departments-g-z/public-works/engineering/traffic-

Grants offer another funding source for bicycle and pedestrian projects and programs. Government grants are offered at a federal, state, regional, or local level. Generally, federal and state grants fund major regional construction projects, but are more competitive to obtain a grant award. For example, the US Department of Transportation 2025 Better Utilizing Investments to Leverage Development (BUILD) Grant Program had 102 grant applications from California and only one of the applicants from California was chosen for funding. Similarly, the California Transportation Commission has a statewide Active Transportation Program (ATP) Grant Program. In 2024, the program received 277 applications, and 13 projects were selected for funding from across the state and an additional 37 funded through regional funds. However, none of the projects selected were from Santa Clara County.

Typically, grant programs announce open grants through a Notice of Funding Opportunity (NOFO). The NOFO details the amount of money total available for the grant program, the funding range available for each project, the amount needed to be contributed by the local agency (called a local match), the goals of the grant program, the requirements of the grant application and scoring rubric, the grant application deadline, the date the grant award is expected to be announced, the dates when funding will become available, and the deadline to spend the grant. City staff evaluate the NOFO to determine if any of the bicycle and pedestrian projects in need of funding are applicable to the grant. The goal of this evaluation is to identify projects that not only qualify for submission but also have a strong potential to compete successfully for funding. If it is determined that a project fits a grant program and would have a competitive application, staff will work on the grant application. Grant applications require significant effort and staff resources to develop, as grantors often require extensive and detailed quantitative measures. These applications can be lengthy and typically include:

- Project narrative including project description and history of the project
- Project outreach showing community support for the project (this may include obtaining letters of support from other jurisdictions and agencies, government representatives, school districts,

25-1082 Agenda Date: 10/27/2025

neighborhood groups, advocacy groups, etc.)

- Project maps showing the location of the project and the need for the project
- Traffic data, including collision data, supporting the need for the project
- Project concept plans
- Grant specific cost benefit analysis for the Project
- Project schedule that shows how the project will comply with grant deadlines
- Project cost estimates including local funding match

Local funding grants also include a non-competitive source that is typically funded by a voter approved tax. Another opportunity for government funding is through federal earmarks, which are projects funded through congressionally directed spending bills and are administered by government representatives.

A table with examples of grant funding sources that are used for bicycle and pedestrian projects is provided in Attachment 2.

Note that current bicycle and pedestrian projects funded by grants are presented at each BPAC meeting as part of the grant activity update. Additionally, an annual report is presented to BPAC showing the status of priority bicycle projects listed in the Bicycle Master Plan as well as the status of priority pedestrian projects listed in the Pedestrian Master Plan.

Written by: Ralph Garcia, Senior Civil Engineer, Public Works

Reviewed by: Carol Shariat, Principal Transportation Planner, Public Works

Reviewed by: Steve Chan, Transportation Manager, Public Works

Approved by: Michael Liw, Assistant Director/City Engineer, Public Works

### **ATTACHMENTS**

- 1. Work Plan Topic Request Form Report on Funding Opportunities (Kratz)
- 2. Examples of Bicycle and Pedestrian Project Grants



### **DEPARTMENT OF PUBLIC WORKS - TRAFFIC ENGINEERING DIVISION**

1500 Warburton Ave, Santa Clara, CA 95050

Tel: 408.615.3000 Fax: 408-983-0931 Email: engineering@santaclaraca.gov

## Bicycle and Pedestrian Advisory Committee Annual Work Plan Topic Request Form

Requestor Name: Ken Kratz Date: July 26, 2024

Proposed Topic Title: report on funding opportunities

Background and Discussion: Please provide justification regarding how this topic pertains to the Bicycle and Pedestrian Advisory Committee's roles and responsibilities:

City staff to provide a yearly report documenting present and future opportunities to fund public and private improvements for bicycle and pedestrian programs and infrastructure, including public and private sources, and make a yearly presentation based on the report to BPAC and the public. The report and presentation shall include but not be limited to present and future efforts to fund improvements from public sources, such as Federal, State and local programs, as well as private funding sources, such as development fees, hospitals, philanthropy and Universities.

CalBike and the League of American Bicyclists (LAB) has compiled lists of funding opportunities that may be new to BPAC members, city staff and the public: https://www.calbike.org/resources/funding\_sources/ & https://bikeleague.org/wp-content/uploads/2023/03/PayingForInnovativeInfrastructure.pdf.

Items found on the CalBike and League of American Bicyclists websites:

#### Public:

#### Federal:

Congestion Mitigation and Air Quality (CMAQ)Improvement Program, Rivers, Trails, and Conservation Assistance Program, Community Development Block Grants (CDBG)

Highway Safety Improvement Program (HSIP), Surface Transportation Program (STP)

Transportation Investment Generating Economic Recovery (TIGER) Discretionary Grant, Transportation Alternatives Program

#### State

Safe Routes to School, State multi-modal fund, State bicycle and pedestrian grants,

Active Transportation program, Clean Mobility Options Pilot Program (CMO; for Under-resourced communities), Land and Water Conservation Fund, Recreational Trails program Non-motorized, Vehicle Registration Fees, Vehicle transfer Fees,

#### Local/Regional:

Business Improvement Districts, General Obligation Bonds, Local Capital Improvement Programs, Regional Bike Program funds, Tax Increment Financing (TIF), Transportation Fund for Clean Air (Bay Area, California), Unspecified city funds, Voter-approved sales taxes (purchases) or other levies (income tax imposed by a city), General Fund, Local Planning Assistance Grants, Public/Private Partnerships, Severance Fees, Bond Measures, Business Improvement Districts, Regional bike program funds, Tax increment financing (TIF), Voter-approved sales taxes, parking meter revenues, user fees (e.g., bike lockers and automated bicycle parking at transit stations), Business Improvement Districts, Benefit Assessment Districts, Property taxes and Bonds, Impact Fees and Developer Mitigation tied to vehicle trip generation, City new construction requirements (e.g., developers to dedicate land for widening roads to provide bike lane).

#### Private:

Developers (Developer Impact Fees & Traffic Impact Studies), Hospitals (pay for public infrastructure to access hospital [e.g., path at corner to access Kaiser]), Philanthropy (e.g., Adopt-a-Path program [private funds in exchange for public recognition]), Universities (e.g., better connections to Santa Clara University and Mission College).

Revised: 7/28/2021 Page 1 of 1

### **Examples of Bicycle and Pedestrian Project Grants**

	Competitive or Non-				
Program	competitive	Funding Purposes	Grant Range	Recurrence	Previous Santa Clara Projects
<u>Federal</u>					
Safe Streets for All	Competitive	Traffic Safety Planning and Implementation	\$100K - \$5 million (planning) \$2.5 - \$25 million (implementation)	Annual	Vision Zero Plan
Better Utilizing Investments to Leverage Development (BUILD) (Formerly TIGER and RAISE)	Competitive	Planning and Capital Projects	Up to \$25 million (planning) \$5 - \$25 million (capital)	Annual	None
Federal Earmarks	Competitive	Projects or Programs	N/A	N/A	De La Cruz, Lick Mill, and Scott Bicycle Project
<u>State</u>					
Office of Traffic Safety (OTS)	Competitive	Safety Programs	Less than \$100K (Typ.)	Annual	Vision Zero Safety Campaign, Safe Routes to School/Helmets, Traffic Safety Enforcement
Active Transportation Program (ATP)	Competitive	Projects to Encourage Biking and Walking	\$250K min.	Biennial	None
Sustainable Transportation Planning (STP)	Competitive	Transportation Planning Grants	\$100K - \$700K	Annual	Pruneridge Complete Streets Plan
<u>Regional</u>					
OBAG	Competitive	MTC Regional Transportation Plan Implementation	\$500K min.	Varies	Central Santa Clara Bicycle and Pedestrian Improvement Project
<u>Local</u>					
TDA	Non-competitive	Bicycle and Pedestrian Projects	~100-170K (based on taxes and population)	Annual	High priority curb ramps
Measure B Bike and Ped Planning Grant	Competitive	Bicycle and Pedestrian Planning for Measure B Projects	\$50K - 50% of available funds	~2-4 years	Monroe, De La Cruz-Coleman, and Walsh/ Martin Bicycle Planning Projects
Measure B Bike and Ped Capital Projects	Competitive	Bicycle and Pedestrian Projects for Measure B Projects	\$50K - 50% of available funds	~10 years	Lafayette Street Class IV Bicycle Facilities
Measure B Education and Encouragement	Non-competitive	Activities included in Measure B	~75-150K (based on taxes and population)	Biennial	Safe Routes to School

Note: Grant information based on previous programs. Grant programs may change funding, recurrence, and requirements in future cycles.



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## Agenda Report

25-1071 Agenda Date: 10/27/2025

## REPORT TO BICYCLE AND PEDESTRIAN ADVISORY COMMITTEE

### **SUBJECT**

Bicycle Plan Status of Projects and Programs (Shariat)

## BACKGROUND

The Bicycle Master Plan Update (Plan) was adopted by City Council on September 24, 2019. Last year, the Bicycle and Pedestrian Advisory Committee (BPAC) was given a status report of projects and programs completed since the adoption of the Plan. Staff and the BPAC acknowledged the importance of monitoring the yearly progress being made towards the recommendations outlined in the Plan.

Staff will provide an update on the progress that has been made on recommended priority projects and programs within the Plan.

### DISCUSSION

The Plan recommends 40 priority bicycle projects. The Priority Projects Status Report (Attachment 1) provides the progress the City has made on these projects and includes the projects that currently have a dedicated funding source.

The Plan also includes recommended bicycle related programs. The programs are organized based on four of the five "E's," which are Education, Encouragement, Enforcement, and Evaluation. The fifth "E" is Equity, which shall be incorporated throughout all of the Plan's program recommendations. A summary of all the bicycle related programs and their status is included as Attachment 2.

Staff is currently working on various projects to implement 38 of the 47 miles (81 percent) covering in the 40 priority bicycle projects. Key efforts include projects on nine corridors: De La Cruz Boulevard, Bowers Avenue, Monroe Street, Benton Street, Scott Boulevard, Lick Mill Boulevard, Laurelwood Road, Walsh Avenue, and Mission College Boulevard.

Written by: Carol Shariat, Principal Transportation Planner, Public Works

Reviewed by: Steve Chan, Transportation Manager, Public Works

Approved by: Michael Liw, Assistant Director/City Engineer, Public Works

## **ATTACHMENTS**

1. 2018 Bicycle Plan Update - Priority Projects Status Report

2. 2018 Bicycle Plan Update - Programs Status Report

Rank	Name	Project	Start	End	Phase	Status	Mileage
1a	El Camino Real	Class IV Separated	City limit	Pomeroy	2-Design	Project began in 2025	0.75
1b	El Camino Real	Class IV Separated	Pomeroy	Lincoln Ave	2-Design	Caltrans to complete; Design to begin in 2028	1.75
1c	El Camino Real	Class IV Separated	Lincoln Ave	City Limit	0-Planning	Need design and construction funding	1.79
2	Pruneridge Ave	Class IIB Buffered	Winchester Blvd	City Limit/ Meadow Ave	2-Design	Study completed in Summer 2022. Applied for	3.03
						Federal Earmark.	
3	Scott Blvd	Class II Lane	Monroe St	Liberty St	2-Design	Design to be completed in 2025	1.55
4	Benton St	Class II Lane	Monroe St	El Camino Real	Completed	Completed Fall 2020	0.83
5	Bowers Ave	Class IIB Buffered	Chromite Dr	El Camino Real	1-Study	Begin study in 2027	1.06
6	El Camino Real at Benton St	Intersection	El Camino Real	Benton St	Completed	SW corner radius tightened and bike detection	-
						completed in 2021.	
7	El Camino Real at Monroe St	Intersection	El Camino Real	Monroe St	0-Planning	Tighten turning radii completed in 2023. Bike detection to be completed with El Camino bike lane project.	-
8	Harvard Ave, Bing Dr/ Princeton Way	Class III	Homestead Rd	Pruneridge Ave		*	0.55
	, g			3			
9	Homestead Rd	Class II Lane	Scott Blvd	Viader Ct	1-Study	Eastbound: Completed end 2020; Westbound: TBD	0.23
10a	Lincoln St	Class II Lane	Warburton Ave	El Camino Real	2-Design	Funded by OBAG grant, begin design in 2026	0.25
10b	Lincoln St	Class II	El Camino Real	Harrison	Completed	Completed in 2023	0.17
10c	Lincoln St	Class II	Harrrison	Homestead	0-Planning	To be completed as part of future paving project	0
11a	Camino Drive	Class IIIB	Washington St	Park Ave	+	*	0.29
11b	Manchester Dr	Class III	Monroe St	Washington St	+	*	0.29
12	Mission College Blvd	Class II Lane	Great America Pkwy	Marriott Entrance	Completed	Completed in 2025	0.21
13	Monroe St	Class II Lane Class IIB Buffered	Lawrence Expy	San Tomas A.C Trail	1-Study	Study completed in 2024, need design and	1.62
13		Class lib bullered	Lawrence Expy	San Tomas A.C Trail	1-Study	construction funding.	
14	San Tomas Expy at Monroe St	Intersection	San Tomas Expy	Monroe St	Completed	Completed in 2009. San Tomas Aquino Creek Trail Class 1 with some portions being on-street.	-
15	Saratoga Creek Trail	Class I Path	Forbes Ave	Cabrillo Ave	0-Planning	Complete masterplan in 2026	1.98
15 16	Benton St	Class I Path Class IIB Buffered				Study completed in 2024. Design to begin in 2026.	
16	Berilon St	Class IIB Buffered	Dunford Way	Maryann Dr	2-Design	Study completed in 2024. Design to begin in 2026.	1.68
17	Benton St	Class III	Maryann Dr	Monroe St	2-Design	Study completed in 2024. Design to begin in 2026.	0.88
18a	Calabazas Creek Trail	Class I Path	Mission College Blvd	Benton St	0-Planning	Complete meeternlen in 2020	3.72
						Complete masterplan in 2026	
18b	Calabazas Creek Trail	Class I Path	Bay Trail	Old Mtn View-Alviso Rd	0-Planning	Complete masterplan in 2026	0.12
19	Forbes Ave	Class IIIB	Harvard Ave	Los Padres Blvd	0 1.1	0	1.84
20	Laurelwood Rd	Class II Lane	Thomas Rd	Bassett St	Completed	Completed in 2025	0.51
21	Monroe St	Class II Lane	Civic Center Dr	Lewis St	Completed	Completed in Fall 2020	0.14
22 23a	Amethyst Dr Bowers Ave/ Great America Parkway	Class III Class IV Separated	Glade Dr Bay Trail	Bowers Ave Patrick Henry	0-Planning	*	0.90 1.40
	,	·		,			
23b	Bowers Ave/ Great America Parkway	Class IV Separated	Patrick Henry	US 101 interchange	3-Construction	In construction, to be completed in 2025	0.57
23c	Bowers Ave/ Great America Parkway	Class IV Separated	US 101 interchange	Walsh	0-Planning	*	0.97
23d	Bowers Ave/ Great America Parkway	Class IV Separated	Walsh	Chromite	1-Study	Study to be begin 2027	0.48
24	Homestead Rd at San Tomas Expy	Intersection	Homestead Rd	San Tomas Expy		*	-
25a	Kifer Rd	Class IV Separated	City limit	Bowers Ave		*	1.50
25b	Walsh Ave	Class IV Separated	Bowers Ave	Lafayette St	1-Study	Study completed in 2024, need design and construction funding.	1.70
26	Pruneridge Ave at Lawrence Expy	Protected Intersection	Pruneridge Ave	Lawrence Expy		*	-
	Monroe St at San Tomas A.C Trail	Intersection	Monroe St	San Tomas A.C Trail	Completed	Completed in Fall 2021	-
28	Warburton Ave	Class IIIB	Lawrence Rd	Laine Ave	3-Construction	Included with 2025 Paving Project as Class III in short-term till evaluate staff evaluates traffic calming measures; to be completed in 2025	1.48
29	De La Cruz Blvd	Class IV Separated	Montague Park	Trimble Rd	2-Design	Design to be completed in 2025	0.63
30	Lafayette St	Class IV Separated	Laurelwood Rd	Reed St	3-Construction	Construction to begin in 2025	1.42
31	Mission College Blvd	Class IV Separated	Mariott Entrance	Montague Expy	Completed	Completed in 2025	0.87
32	Saratoga Ave	Class IIB Buffered	Stevens Creek Blvd	Market St/Bellomy St		*	1.42
33	De La Cruz Blvd	Class IV Separated	Central Expy	Reed St	1-Study	Study completed in 2024, need design and construction funding.	0.89
34a	Homestead Rd at Lawrence Expy	Intersection - Bike lane marking through intersection	Homestead Rd	Lawrence Expy		*	-
34b	Homestead Rd at Lawrence Expy	Protected Intersection	Homestead Rd	Lawrence Expy		*	-
35	Lick Mill Blvd	Class IV Separated	Tasman Dr	Montague Expy	2-Design	Design to be completed in 2025	1.43
36	Agnew Rd at San Tomas A.C Trail	Intersection	San Tomas A.C Trail	Agnew Rd		*	-
	San Tomas Expy at Walsh Ave	Protected Intersection	San Tomas Expy	Walsh Ave		*	-
		Class IV Separated	SR 237	Agnew Rd	3-Construction	Interim Class IIB bike lanes completed with 2022 paving project	1.73
37	Lafayette St	·					i
37 38 39	Lafayette St Patrick Henry Dr/Old Ironsides Dr	Class IV Separated	Great America Pkwy	Tasman Dr	0-Planning	To be completed as part of Patrick Henry Specific Plan	1.30
37 38 39	,	·	Great America Pkwy  City Limit	Tasman Dr Monroe St		To be completed as part of Patrick Henry Specific	1.30 2.59
37 38 39 40	Patrick Henry Dr/Old Ironsides Dr	Class IV Separated	·		0-Planning 2-Design Completed	To be completed as part of Patrick Henry Specific Plan	
37 38	Patrick Henry Dr/Old Ironsides Dr Scott Blvd	Class IV Separated Class IIB Buffered	City Limit	Monroe St	2-Design	To be completed as part of Patrick Henry Specific Plan  Design to be completed in 2025	2.59

<sup>\*</sup> Not programmed yet due to budget and staff resources. Looking for grant opportunities

EDUCATION PROGRAMS				
Program	Description	Status		
Adult Bicycling Skills Class	City to support adult bicyclist skills classes which are taught by Silicon Valley Bicycle Coalition (SVBC) and Valley Transportation Authority (VTA).	City added a link to the Silicon Bicycle Coalition website on BPAC website promoting free bicycle skill classes.		
Student Bicycle Traffic Safety Information	Students are taught traffic safety skills that help them understand basic traffic laws and safety rules.	On-going - Third phase of the Safe Routes to School Project includes 17 schools and runs between Years 2022-2026.		
ENCOURAGEMENT PROGRAMS				
Program	Description	Status		
Back-to-school Encouragement Marketing	A back-to-school encouragement marketing campaign can promote bus, carpool, walking, and bicycling to school.	On-going - Third phase of the Safe Routes to School Project includes 17 schools and runs between Years 2022-2026.		
Employer-Based Encouragement Programs	The City collaborate with employers to implement bicycle related programs.	Not started due to limited staff resources		
Bicycle Helmet Giveaway	The City to conduct bike helmet giveways for children.	On-going - Third phase of the Safe Routes to School Project includes 17 schools and runs between Years 2022-2026.		
Open Streets Events	The City should work with local community groups to host Open Streets Events, sometimes called "Ciclovia".	Not started due to limited staff resources and City funding. This item was brought to BPAC in October 2020.		
Bike to Shop Day	Bring bike to shop day to Santa Clara. Local shop owners typically reward shoppers who arrive by bike through discounts and prizes during one month of the year.	A BPAC subcommittee was created for this item.		
Bike to Work Month and Day	The City sponsor a Bike to Work Day energizer station and begin to sponsor a different event such as Bike to Work group rides.	Ongoing - Staff supports a Bike to Work Day energizer station, including this past May 2025.		
Walk and Roll Days	Walk and bike to school days are events to encourage students to try walking or bicycling to school.  Recommendation is to expand these events to a weekly basis.	On-going - Third phase of the Safe Routes to School Project includes 17 schools and runs between Years 2022-2026.		
Walking School Buses and Bike Trains	An organized group of students who walk or ride together under the supervision of a parent/adult volunteer.	On-going - Third phase of the Safe Routes to School Project includes 17 schools and runs between Years 2022-2026.		
Suggested Routes to School Maps	Family friendly routes to schools.	On-going - Third phase of the Safe Routes to School Project includes 17 schools and runs between Years 2022-2026. These maps have been completed for most of the schools and uploaded onto schools' websites. The final maps are being updated by our consultant.		
ENFORCEMENT PROGRAMS				
Program	Description	Status		
Bicycle-Related Ticket Diversion Class	Diversion classes are classes offered to bicyclist offenders of cetain traffic violations, such as running a stoplight. No classes are currently offered to those 18 years of age or older.	Police Dept. has offered in the past the opportunity for juveniles to take safety classes instead of paying a fine for violations such as not wearing a helmet. These type of opportunities arise when Police Dept. has received grants to purchase helmets and thus, doesn't occur on a regular basis.		
Crosswalk Stings/Enforcement Campaigns	Police Department target drivers who fail to yield to pedestrians in a school crosswalk.	Police Dept. has conducted crosswalk stings in the past. Due to limited staff resources, stings are not done on a regular basis. The Police Dept. will however, enforce crosswalk laws while out on patrol.		
Vision Zero Targeted Enforcement	Police Department adopt enforcement goals targeting the vehicle code infractions most likely to result in injury collisions or fatalities. This should be done after a Vision Zero Policy is adopted.	Staff is bringing the Vision Zero Plan for BPAC to recommend to City Council to adopt the plan at the October 2025 meeting.		
Adult Bicycling Skills Class				
Program	Description	Status		
Parent Surveys	Conduct parent surveys every 3 years related to modes of travel, interest in walking or biking to school, and challenges to walking and bicycling to school.	On-going - Third phase of the Safe Routes to School Project includes 17 schools and runs between Years 2022-2026.		
	Student hand tallies conducted annually as to how many students walk, bike, take transit or carpool to school.	On-going - Third phase of the Safe Routes to School Project includes 17 schools and runs between Years 2022-2026.		
BICYCLE PLAN OBJECTIVES				
Policy	Description	Status		
	Review bicycle collisions on an annual basis to identify any annual trends and locations needing improvements.	Currently have a BPAC subcommittee group for this item.		
	Identify opportunities to reduce crossing distances	On-going - Staff identifies opportunities during review of capital and land development projects.  In progress - Council approved reducing speed limits around		
	Study the need for 15 mph School Zone speed limits and adopt in appropriate locations by 2022	schools in June 2025. The City is currently in the process of updating signage around the schools.		
	StreetSmarts uses print media, radio spots, and television spots to educate people about safe driving, bicycling, skateboarding, and walking behavior.	On-going - Staff is bringing the Vision Zero Plan for BPAC to recommend to City Council to adopt the plan at the October 2025 meeting. As part of the project, residents will be educated about safely driving, walking, and bicycling around the City.		

Program	Description	Status
	Submit dedicated bicycle projects into the Capital Improvement Program	On-going - Staff submits dedicated bicycle projects into the Capital Improvement Program
Objective 2.A: Obtain funding for all high priority projects by 2026;	Actively pursue external grant funding	On-going - Staff actively pursues external grant funding and a work plan topic related to grants will be provided by City staff at October 2025 BPAC meeting
	At every BPAC meeting, present a "grant funding sheet"	On-going - Staff provides grant activity status at every BPAC meeting
Objective 2.B: Plan, design, and construct	Coordinate implementation of cross county corridor recommendations with neigboring jurisdictions and VTA	On-going - Staff is currently coordinating with VTA on the next phase of the Central Bikeway Study. The City also recently worked with the City of San Jose, City of Cupertiono, Valley Transportation Authority, and County of Santa Clara on a long-term visioning study for the Stevens Creek Boulevard-West San Carlos Street corridor related to possibly multi-modal improvements including options for High Capacity Transit. Finally, multidisciplinary stakeholders were part of the Vision Zero Working Group such as VTA, School District, and Santa Clara County.
a complete bicycle network	Upgrade and improve existing arterial bikeway network	On-going - Staff looks to upgrade the bikeway network as part of Complete Streets Review of projects and separate bicycle capital projects.
	Implement bicycle detection at signalized intersections within the City	On-going - Bicycle detection is a City standard and is implemented when projects modify signalized intersections.
	Incorporate green stormwater infrastructure	On-going - Limited by capital project funding. However, City currently in the process of designing a green infrastructure project that will treat five (5) acres of stormwater runoff.
	Develop a trail pavement management plan by 2020 and request funding through the capital budget process to perform necessary pavement maintenance.	In-progress - City has developed a trail pavement management plan and secured funding to implement the first phase of the plan. Maintenance to begin in Year 2026. Future phases are contingent upon additional funding being allocated in the budget.
Objective 2.C: Enhance standard operating	Identify opportunities for parking removal or roadway reallocation	On-going - Staff has recently completed (8) projects to identify opportunities for parking removal or roadway reallocation. The next bike project to study the opportunity for parking removal or roadway reallocation will be Bowers Avenue from El Camino Real to Walsh Avenue.
practices for installing and maintaining bicycle facilities	Review striping plans for all roadways prior to resurfacing projects	On-going - Staff reviews striping plans as part of Complete Streets Review of resurfacing projects. In addition, brought to BPAC for complete streets review as well.
	Maintain bicycle lanes next to construction zones when feasible	On-going - Staff reviews construction zone traffic control plans to maintain bicycle lanes when feasible.
	Maintain bicycle facilities by street sweeping and pavement repair	On-going - City roadways, including bicycle lanes on these roadways, are swept on average three times a month. The City has pavement rehabilitation projects which aims at repairing roadways every year.
	Install green colored bicycle lanes at high conflict zones	On-going - Green color bicycle lanes are implemented at high conflict zones.
	Encourage large employers/retailer to pursue LAB designation. Develop an award program to highlight private sector partners	Not started due to limited staff resources.
	Develop city-wide bicycle wayfinding system	The City's BPAC formed a subcommittee on September 5, 2019 and created a draft plan on October 28, 2019 which could be the basis for any furture work on a Citywide Bicycle Wayfinding project. The recently passed Measure I includes a Bicycle Wayfinding project in the amount of \$300,000.
Objective 3.A: Increase bicycle mode share to five percent by 2026	Update the MySantaClara app an online service request website to permit requests for maintenance on bicycle facilities by 2020.	Complete- MySantaClara currently allows residents/stakeholders to notify the City of bicycle facility issues by submitting a request through the mobile app. MySantaClara app agenda topic was brought forth to BPAC in August 2023.
	Prioritize installation of bicycle parking in the public right of way and consider updating the Municipal Code to increase the amount of bicycle parking	In progress - Staff completed updating the Zoning Code and was adopted by Council in July 2024 which included new bicycle parking requirements. The updated bicycle parking requirements were brought to the BPAC in August 2022.
	Support Safe Routes to School programs	On-going - Third phase of the Safe Routes to School Project includes 17 schools and runs between Years 2022-2026.
	Work with Police to host annual bike light giveways	On-going - The current third phase of the Safe Routes to School Program will work with Police and schools to give away safety materials such as bike lights and bike reflectors.

## 2018 Bicycle Plan Update Programs Status Report 10/14/2025

Program	Description	Status
	Collect pre and post data for projects	In Progress - City has collected pre-bicycle data and post bicycle data for the Mission College Class IV bicycle lane project from Marriott driveway to Wyatt Drive. The City also collect pre-data for the completed eight (8) bike planning projects.
	Whenever vehicle Level of Service studies are required, include measurements that account fo bicyclists and pedestrians	On-going - Vehicle studies for new developments are reviewed to ensure compliance with bicycle and pedestrian goals.
Objective 3.B: Conduct ongoing planning	Encourage local community input in planning and implementation of bikeways	On-going - Staff completed eight (8) bike planning projects that encouraged local community input in planning and implementation of the bikeways. The same level of community outreach will be completed for the upcoming Bowers Avenue bike study from El Camino Real to Walsh Avenue.
and evaluation for bicycle facilities		On-going - Bike share and electric scooter program started in August 2022. City Council approved the program on December 7, 2021. There are currently no approved operators within the City as none applied in the last application period.
	Work with Police to improve reporting and analysis of bicycle collisions	Currently have a BPAC subcommittee group for this item.
		On-going - Staff annually monitors and reports to BPAC on the progress of projects and programs contained in the Bicycle Plan.
	Strive to improve City's Bicycle Friendly Community status	The City was notified that it received the "silver" Bicycle Friendly Community designation.
	An annual report card to assess the City's progress toward goals, objectives, projects, and programs outlined in this Plan.	On-going - Staff annually monitors and reports to BPAC on the progress of projects and programs contained in the Bicycle Plan.



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## Agenda Report

25-1073 Agenda Date: 10/27/2025

## REPORT TO BICYCLE AND PEDESTRIAN ADVISORY COMMITTEE

## **SUBJECT**

Pedestrian Master Plan Status of Projects, Objectives, and Policies (Shariat)

### **BACKGROUND**

The Pedestrian Master Plan (Plan) was adopted by City Council on February 25, 2020. Staff and the Bicycle and Pedestrian Advisory Committee (BPAC) acknowledged the importance of monitoring the yearly progress being made towards the recommendations outlined in the Plan.

Staff will provide an update on the progress that has been made on the recommended high priority pedestrian facilities, objectives, and policies within the Plan.

## **DISCUSSION**

The Plan recommends 79 high priority pedestrian projects that include intersection spot improvements, curb ramps, and sidewalks. There are 31 intersection spot improvements, 38 curb ramps, and 10 sidewalk projects classified as high priority. The High Priority Projects Status Report (Attachment 1) provides the progress the City has made on these projects and includes projects that currently have a dedicated funding source.

The Plan also includes objectives and policies that need to be met. A summary and status of the objectives and policies is included as Attachment 2.

Staff is currently working on various projects to implement 37 of 79 (47 percent) high priority recommendations from the Plan. Key efforts include installing sidewalk where there are current gaps and constructing Americans with Disabilities Act (ADA) curb ramps and/or corner bulb-outs at select intersections.

Written by: Carol Shariat, Principal Transportation Planner, Public Works

Reviewed by: Steve Chan, Transportation Manager, Public Works

Approved by: Michael Liw, Assistant Director/City Engineer, Public Works

### ATTACHMENTS

1. Pedestrian Master Plan - High Priority Projects Status Report

2. Pedestrian Master Plan - Objectives and Policies Status Report

## 2019 Pedestrian Master Plan Priority Projects Status Report

10/3/2025

Ped Plan				
Score	Location	Project	Phase	Status
7	El Camino Real / Flora Vista Ave	Curb ramps, sensors, signal phasing	0-Planning	Included in El Camino Real Specific Plan
7	El Camino Real / Railroad Ave	Bulbouts, sensors	Environmental	Included in VTA Central Bikeway Project.Environmental to begin FY 25/26
7	El Camino Real / Campbell Ave	Curb ramps, sensors	partial completion/envi ronmental	Partially completed by SCU project. Also included in VTA Central Bikeway Project.Environmental to begin FY 25/26
7	Tasman Drive / Lick Mill Blvd	Curb ramps, APS	0-Planning	Included in the Tasman East Specific Plan
7	Mc Kinley Drive / Gilbert Avenue	Curb ramps		*
7	West Tasman Dr from Lafayette to Calle del Sol	Sidewalk	Completed	Completed in 2025.
7	Calle del Sol from Calle de Luna to West Tasman Dr	Sidewalk	Completed	Completed in 2025.
6	El Camino Real / Benton St	Bulbouts, sensors	Environmental	Included in VTA Central Bikeway Project.Environmental to begin FY 25/26
6	El Camino Real / Halford Ave	Remove islands	0-Planning	Included in El Camino Real Specific Plan
6	Kiely Blvd / Homestead Rd	Bulbouts	Completed	Curb ramps completed in 2020
6	El Camino Real / Lawrence SB Ramps	Bulbouts		*
6	Lafayette St / Lexington St	Curb ramps	Completed	Curb ramps completed in 2020
6	Monroe St / Homestead Rd	Curb ramps, Ped signal	Partial	Curb ramps completed in 2021
6	Adams Way / Hayes Avenue	Curb ramps		*
6	Madison Street / Franklin Street	Curb ramps		*
6	El Sobrante Street / Via Dondera	Curb ramps		*
6	Aldo Ave from De La Cruz Blvd to Edward Ave	Sidewalk		*
6	Aldo Ave from Edward Ave to Victor St	Sidewalk		*
5	Lafayette St / Homestead Rd	Bulbout, Curb ramps	Partial	Curb ramps completed in 2020
5	El Camino Real / San Tomas Expressway	Sensors, crosswalks	0-Planning	Start design in 2028 (Caltrans)
5	Stevens Creek Blvd / Cronin Dr	Curb ramps, sensors	Partial	Curb ramps completed in 2023
0	Cleverio Greek Biva / Greriin Bi	Carb ramps, sensors	T ditidi	Curb ramps completed in 2020 and
5	Homestead Rd / Los Padres Blvd	Bulbout, Ped signal	Completed	bulbouts/signal modifications completed in 2024.
5	Homestead Rd / Las Palmas Dr	Curb ramps, sensors	Partial	Curb ramps completed in 2020
5	Monroe St / Franklin St	Traffic Study	1-Study	Completed by developer in 2022
5	El Camino Real / Alpine Ave	Bulbout, sensor	Environmental	Included in VTA Central Bikeway Project.Environmental to begin FY 25/26
5	Agnew Rd/ Davis St	HAWK	2-Design	Study recommended Rectangular Rapid Flashing Beacon (RRFB) with high visibility crosswalk and thus no HAWK. Design of RRFB to begin Winter 2026
5	Homestead Rd / Jackson St	HAWK	Completed	This intersection was studied as part of our Uncontrolled Crosswalk Study. However results did not warrant any improvements at this intersection. Thus, this project is being closed out.
5	Scott Blvd / Monroe St	Bulbouts, Ped signal		*
5	Forbes Avenue / Clara Vista Avenue	Curb ramps	Completed	Completed in 2018
5	Franklin Street / Jefferson Street	Curb ramps		*
5	Los Padres Boulevard / El Capitan Avenue	Curb ramps		*
5	Aldo Avenue / Edward Avenue	Curb ramps		*
5	Mac Gregor Lane / Laurie Avenue	Curb ramps	Completed	Completed in 2016
5	Kevin Way / Laurie Avenue	Curb ramps	Completed	Completed in 2016
5	Edward Ave from Neldo Ave to Aldo Ave	Sidewalk		*
4	El Camino Real / Kiely Blvd	Remove islands	0-Planning	Start design in 2028 (Caltrans)
4	El Camino Real / Pomeroy Ave	Bulbouts	0-Planning	Start design in 2028 (Caltrans)
4	Scott Blvd / Warburton Ave	Bulbouts	2-Design	To be completed as part of OBAG grant funding.
4	Pruneridge Ave / Woodhams Rd	Curb ramps, Ped signal	0-Planning	Study completed in 2022 as part of Pruneridge Complete Streets Plan
4	Monroe St / Harrison St	RRFB	1-Study	Study underway. However, additional pedestrian warning signage added in August 2024.
4	Lafayette St / Manchester Dr	HAWK	Completed	Construction completed 2024.
4	Kiely Blvd / Forbes Ave	Bulbouts		*
4	Homestead Rd / Central Park Library Entrance	Bulbouts, Ped signal		*
4	Lafayette St / Agnew Rd	Bulbouts		*
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<sup>\*</sup> Not programmed yet due to budget and staff resources. Looking for grant opportunities

## 2019 Pedestrian Master Plan Priority Projects Status Report

10/3/2025

Ped Plan		-	-	
Score	Location	Project	Phase	Status
4	El Camino Real / Scott Blvd	Remove islands	0-Planning	Start design in 2028 (Caltrans)
4	Monroe St / Bellomy St	Curb ramps, Ped signal	Partial	Curb ramps completed in 2021
4	Bennett Avenue / Claremont Avenue	Curb ramps	Completed	Completed in 2025.
4	Mauricia Avenue / Bennett Avenue	Curb ramps	,	*
4	Woodhams Road / Jenkins Place	Curb ramps		*
4	Michael Way / Mc Kinley Drive	Curb ramps		*
4	Muir Avenue / Mc Kinley Drive	Curb ramps		*
4	Woodhams Road / Mc Kinley Drive	Curb ramps		*
4	Mc Kinley Drive / Brian Lane	Curb ramps		*
4	Hayes Avenue / Mauricia Avenue	Curb ramps		*
4	Kellogg Way / Atherton Drive	Curb ramps		*
4	Mauricia Avenue / Michael Way	Curb ramps		*
4	Woodhams Road / Cameron Way	Curb ramps		*
4	Gibson Court / Gibson Avenue	Curb ramps		*
4	Gibson Avenue / Elmhurst Avenue	Curb ramps		*
4	Aspen Drive / Cottonwood Court	Curb ramps		*
4	Stevenson Street / Flannery Street	Curb ramps		*
4	Alexander Avenue / Cornell Drive	Curb ramps		*
4	Cornell Drive / Ridge Road	Curb ramps		*
4	Salberg Avenue / Barcells Avenue	Curb ramps		*
4	Roxbury Street / Manchester Drive	Curb ramps		*
4	Highland Avenue / Highland Court	Curb ramps		*
4	Sunset Drive / Blossom Drive	Curb ramps		*
4	Patricia Drive / Maryann Drive	Curb ramps		*
4	Alpine Avenue / Pacheco Street	Curb ramps	Completed	Completed in 2021
4	Washington Street / Lewis Street	Curb ramps	Completed	Completed in 2022.
4	El Camino Real /Bowers Ave	Curb ramps	Completed	Completed in 2020
4	Warburton Avenue / Briarwood Drive	Curb ramps		*
4	Laurie Avenue / Haig Street	Curb ramps	Completed	Completed in 2025.
4	Flora Vista Avenue / Devos Court	Curb ramps		*
4	Aldo Ave from Woodward Ave to De La Cruz Blvd	Sidewalk		*
4	Victor St from Neldo Ave to Aldo Ave	Sidewalk		*
4	San Tomas Expy from Homestead Rd to Forbes Ave	Sidewalk		Requires coordination and approval from the County
4	San Tomas Expy from Warburton Ave to El Camino Real	Sidewalk		Existing trail can be used by pedestrians

<sup>\*</sup> Not programmed yet due to budget and staff resources. Looking for grant opportunities

PEDESTRIAN PLAN OBJECTIVES				
Policy	Description	Status		
	Study implementing a Vision Zero policy before 2024	Staff received a Safe Streets for All (SS4A) grant in Year 2022 to prepare a Citywide Vision Zero Plan. Staff is bringing the Vision Zero Plan for BPAC to recommend to City Council to adopt the plan at the October 2025 meeting.		
	Annually review pedestrian related collisions and identify improvements at key locations	Currently have a BPAC subcommittee group for this item.		
	Identify locations to reduce pedestrian crossing distances and enhance pedestrian visibility	On-going - Staff identifies opportunities during review of capital and land development projects.		
	Study 15 mph school zone speed limits and adopt in appropriate locations by 2022	In Progress - Council approved reducing speed limits around schools in June 2025. The City is currently in the process of updating signage around the schools.		
	Inventory sidewalks, curb ramps, and pedestrian actuation buttons to detrmine where they are missing or don't meet standards	Completed - This was completed as part of the City's ADA Transition Plan which was approved by Council in August 2024.		
	Maintain the sidewalk repair program to replace and/or repair sidewalks damaged by City-owned street trees;	On-going - This sidewalk repair program is implemented subject to budget constraints.		
	Create program to require sidewalk inspections, and repairs when necessary when properties are being sold	Not started due to limited staff resources.		
Objective 1.B: Improve accessibility of the pedestrain environment for people with disabilities;	Update Santa Clara ADA Transition Plan and prioritize the improvements in the Plan	Completed - The City completed the ADA Transition Plan and was approved by Council in August 2024. Next step is to prioritize implementing improvements identified in the Plan based on funding allocated to the project.		
	Continue and streamline the program where pedestrians with mobility impairments can request accessibility improvements at specific locations.	On-going - This program is ongoing.		
	Work with accessibility groups to test and implement new technologies that are focused on improving accessibility and mobility for those with mobility impairments.	Not started due to limited staff resources.		
	Optimize crossing times for pedestrians at signalized crossings. Add pedestrian countdown timers where not present.	On-going - Crossing times at signalized crossings are monitored and changed, if needed. Projects upgrading traffic signals will add pedestrian countdown timers where not present.		
	Where feasible consolidate driveways	On-going - Staff identifies opportunities to consolidate driveway when reviewing land development projects.		
	Improve pedestrian visibility at crossings using complete streets strategies.	On-going - Staff identifies opportunities to improve pedestrian visibility when reviewing land development projects and investigating public requests.		
	Where feasible, shorten crossing distances using complete streets strategies	On-going - Staff identifies opportunities during review of capital and land development projects.		
	Reduce conflicts between pedestrians and vehicle turning movements using complete streets strategies	On-going - Staff identifies opportunities during review of capital and land development projects.		
	Where sidewalk width allows, establish a "furnishing zone".	On-going - Staff identifies opportunities when reviewing land development projects		
	In areas with sidewalks that have street furniture, transit amenities, utility cabinets, trees and bushes, clearly establish a "pedestrian zone"	On-going - Staff identifies opportunities when reviewing land development projects		
	Prioritize improvements that improve connectivity and remove physical barriers to walking at conflict points.	On-going - Staff identifies opportunities during review of capital and land development projects.		
	Update Santa Clara's specific plans to encourage pedestrian amenities appropriate for multiple street typologies	On-going - Identifying opportunities to encourage pedestrian amenities during creation of Specific Plans		
Object Can Built Live Co.	Inventory existing pedestrian amenities and street furniture	Not started due to limited staff resources.		
Objective 2.B: Provide and maintain amenities along sidewalks, subject to funding, that provide opportunities for shade, rest, and visual interest to create	Continue to partner with community organizations to plan and provide supplies for community/roadway/park cleanup days	On-going - Staff identifies opportunities to partner with community organizations to plan community/roadway/park cleanup days.		
an enjoyable and attractive walking	Review and update City sidewalk standards.	Not started due to limited staff resources.		
environment	Develop citywide pedestrian and bicycle wayfinding system.	The City's BPAC formed a subcommittee on September 5, 2019 and created a draft plan on October 28, 2019 which could be the basis for any furture work on a Citywide Bicycle Wayfinding project. The recently passed Measure I includes a Bicycle Wayfinding project in the amount of \$300,000.		
	Update City standards around form and placement of pedestrian-scale lighting to create safe pedestrian spaces.	On-going - Identifying opportunities for pedestrian-scale lighting during creation of Specific Plans and during review of capital and land development projects.		

## Pedestrian Master Plan Objectives and Policies Status Report 10/6/2025

floor land uses that benefit the pedestrian experience  Objective 4.C: Create opportunities to integrate public health outcomes into pedestrian projects  Objective 5.A: Obtain funding for all high priority project recommendations from the Pedestrian Master Plan 2019 by 2027  Actively pursue external grant funding to reaction of Specific Plans  On-going - Identifying opportunities during creation of Specific Plans  On-going - Identifying opportunities during creation of Specific Plans  On-going - Identifying opportunities during creation of Specific Plans  In Progress - Staff pursuing low cost media campaigns related to the benefits of walking. City also attends meetings conducted by Santa Clara County Public Health regarding administering Safe Routes to School Programs.  On-going - Staff submits dedicated pedestrian projects into the Capital Improvement Program  On-going - Staff submits dedicated pedestrian projects into the Capital Improvement Program  On-going - Staff submits dedicated pedestrian projects into the Capital Improvement Program  On-going - Staff actively pursues external grant funding  On-going - Staff actively pursues external grant funding  On-going - Staff provides grant activity status at every BPAC meeting.	Policy	Description	Status
Use social media to connect with residents on pedestrian projects.  Objective 2.D. Promote the benefits of increased walking Support resident-led placemaking, beautification, and safety initiatives to improve comfort and get more people walking Continue to support 36r Routes to School Programs to oromote walking.  Continue to support 36r Routes to School Programs to oromote walking.  Continue to support 36r Routes to School Programs to oromote walking.  Continue to support 36r Routes to School Programs to oromote walking.  Continue to support 36r Routes to School Programs to oromote walking.  Continue to support 36r Routes to School Programs to oromote walking.  Continue to support 36r Routes to School Programs to oromote walking.  Continue to support 36r Routes to School Programs to oromote walking.  Continue to support 36r Routes to School Programs to oromote walking.  Continue to support 36r Routes to School Programs to oromote walking.  Continue to support 36r Routes to School Programs to oromote walking.  Continue to support 36r Routes to School Programs to oromote walking.  Continue to support 36r Routes to School Programs to oromote walking.  Continue to support 36r Routes to School Programs to oromote walking.  Continue to support 36r Routes to School Programs to oromote walking.  Continue to support 36r Routes to School Programs to oromote walking.  Continue to support 36r Routes to School Programs to oromote walking.  Continue to support 46r Routes to School Programs to oromote walking.  Continue to support 46r Routes to School Programs to oromote walking.  Continue to support 46r Routes to School Programs to oromote walking.  Continue to support 46r Routes to School Programs to oromote the total continue to the program or to defens to the dark to the continue to oromote the stream walking.  Continue to support 46r Routes to School Program 16r Routes to the City's desired walkable place types with the community program 16r Routes walking.  Concepts into comprehensive program to the total program to th	lighting to promote attrctive, distinctive,	Prioritize installing new pedestrian-scale lighting along routes	during creation of Specific Plans. In addition, the City completed upgrading pedestrian and traffic signal safety lighting to LED
Objective 2.D: Promote the benefits of increased walking support resident-led placemaking, beautification, and safety initiatives to improve comfort and get more people walking community and the safe Routes to School Programs to promote walking.  Continue to support Safe Routes to School Programs to promote walking.  Continue to support Safe Routes to School Programs to promote walking.  Continue to support Safe Routes to School Programs to promote walking.  Continue to support Safe Routes to School Programs to promote walking.  Continue to support Safe Routes to School Programs to promote walking.  Continue to support Safe Routes to School Programs to promote walking.  Continue to support Safe Routes to School Programs to promote walking.  Continue to support Safe Routes to School Programs to promote walking.  Continue to support Safe Routes to School Programs to promote walking.  Continue to support Safe Routes to School Programs to grant support safe Routes to School Project Includes 17 schools and runs between Years 2022-2026.  Status  Consider Safe Routes to Safe Routes to School Project Includes 17 schools and runs between Years 2022-2026.  Status  Consider Safe Routes to Safe Routes to School Project Includes 17 schools and runs between Years 2022-2026.  Status  Consider Safe Routes to Safe Routes to School Projects Includes 18 schools and runs between Years 2022-2026.  Status  Consider Safe Routes to			On-going - Silicon Valley Power to review lighting standards
increased walking support resident-led placemaking, beautification, and safety initiatives to improve comfort and get more people walking continue to support Safe Routes to School Programs to promote walking continue to support Safe Routes to School Programs to promote walking continue to support Safe Routes to School Programs to promote walking continue to implement the neighborhood traffic calming to increase pedestrian comfort when resurfacing roadways, consider opportunities to add/enhance active transportation facilities  Discuss desired walkable place types with the community concepts into comprehensive planning processes types, land-use mix, public open space and trails, and street types. Consider developing form-based ordinances to implement the City's desired walkable environment When establishing Specific or Precise Plans, include a variety of high quality open spaces of hoor land uses that benefit the pedestrian experience.  Objective 4.A: Integrate the outcomes of Hoor land uses that benefit the pedestrian experience  Objective 4.B: Develop and foster ground-floor land uses that benefit the pedestrian experience  Objective 4.B: Develop and foster ground-floor land uses that benefit the pedestrian projects walking  Objective 5.A: Obtain funding for all high provides for a subject was all to the pedestrian experience.  Objective 5.A: Obtain funding for all high provides for provide projects in the City's Capital improvement Program during each budget cycle for future funding for all high projects recommendations from make the projects recommendations	Objective 2 D: Promote the benefits of	topics.	social media feeds and also writes City Manager blog articles to
Policy Confinue to implement the neighborhood traffic calming program Calming to increase pedestrian comfort When resurfacing roadways, consider opportunities to add/enhance active transportation facilities  Discuss desired walkable place types with the community  Objective 3.A: Integrate walkability Provide for design guidelines citywide and within Specific or Concepts into comprehensive planning processes types, land-use mix, public open space and trails, and street types Consider developing form-based ordinances to implement the City's desired walkable environment When establishing Specific or Pectice Plans, include a variety of high quality open spaces Dispective 4.A: Integrate the outcomes of the Sand Cara County Public Health and other processes with other City processes of the Sand Cara County Public Health and other integrate public health outcomes into gedestrian projects  Objective 4.C: Create opportunities to pedestrian projects  Submit pedestrian projects walkable program during each budget cycle for future funding provides grant funding spreadsheet* to the PAC that explains upcoming the Pedestrian projects into the City's Capital Improvement Program during each budget cycle for future funding project recommendations from At every PaC meeting. The Pack are projects into the City's Capital Improvement Program during each budget cycle for future funding project recommendations from At every PaPAC meeting. The PAC meeting and projects into the City's Sapital Improvement Program during spreadsheet* to the PaPAC that explains upcoming meeting projects and projects and projects and projects with the City project recommendations from At every PaPAC meeting the PaPAC meeting and projects into the City's Sapital proportion projects and projects into the City's Capital Improvement Program during		Support resident-led placemaking, beautification, and safety	Not started due to limited staff resources.
Objective 2.E: Implement vehicular traffic calming to increase pedestrian comfort and program when resurfacing roadways, consider opportunities to add/enhance active transportation facilities  Objective 3.A: Integrate walkability concepts into comprehensive planning processes types. Jandius processes of the calculation of the City's desired walkable environment the Streets Review of resurfacing proportunities during creation of Specific Plans  Objective 4.A: Integrate the outcomes of the Streets with the City of high quality open spaces  Objective 4.B: Develop and foster groundfloor and uses that benefit the pedestrian projects  Objective 4.B: Develop and foster groundfloor land uses that benefit the pedestrian projects  Objective 4.C: Create opportunities to integrate public health outcomes into pedestrian projects  Submit pedestrian projects  Objective 5.A: Obtain funding for all high priority project recommendations from the Pedestrian Master Plan 2019 by 2027  At every BPAC meeting, Ne City shall present a "grant funding spreadsheet" to the BPAC that explain supporting mental provinces funding spreadsheet" to the BPAC that explain supporting mental provinces and the province of the Program funding spreadsheet" to the BPAC that explain supporting mental provinces funding spreadsheet" to the BPAC that explain supporting mental provinces and the province of the province of the province of the province of the Plans such as the Station Area Plan.  On-going - Identifying opportunities during creation of Specific Plans such as the Station Area Plan.  On-going - Identifying opportunities during creation of Specific Plans in the Station Area Plan.  On-going - Public Works and Community Development province or projects with the City province province or projects.  On-going - Identifying opportunities during creation of Specific Plans in Program Station Area Plan.  On-going - Identifying opportunitie	Dalian	promote walking.	includes 17 schools and runs between Years 2022-2026.
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## Pedestrian Master Plan Objectives and Policies Status Report 10/6/2025

Policy	Description	Status
Objective 5.B: Conduct ongoing planning and evaluation for pedestrian facilities		On-going - Staff reviews the results of the American Community Survey to determine progress in reaching mode share targets. Most recent 5-year ACS from 2019-2023 shows 2.7% of Santa Clara residents journey to work by walking. In addition, most recent 1-year ACS from 2024 shows 3.4% of Santa Clara residents journey to work by walking.
	Work with the Santa Clara Police Department to improve the reporting and analysis of pedestrian collisions.	Currently have a BPAC subcommittee group for this item.
	Update MySantaClara app to include additional types of requests for maintenance of pedestrian facilities	Not started due to limited staff resources. However, MySantaClara currently allows residents/stakeholders to notify the City of pedestrian facility issues by submitting a request through the mobile app. MySantaClara app agenda topic was brought forth to BPAC in August 2023.



1500 Warburton Avenue Santa Clara, CA 95050 santaclaraca.gov @SantaClaraCity

## Agenda Report

25-1122 Agenda Date: 10/27/2025

## REPORT TO BICYCLE AND PEDESTRIAN ADVISORY COMMITTEE

## **SUBJECT**

Grant Activity Verbal Update (Shariat)

## **BACKGROUND**

The 2018 Bicycle Plan Update Policy 2.A.3 and 2019 Pedestrian Master Plan Policy 5.A.3 state "the City shall present a grant funding spreadsheet at every Bicycle and Pedestrian Advisory Committee (BPAC) meeting."

## DISCUSSION

Staff will provide a verbal update on existing and future grant opportunities (Attachment 1).

Written by: Carol Shariat, Principal Transportation Planner, Public Works

Reviewed by: Steve Chan, Transportation Manager, Public Works

Approved by: Michael Liw, Assistant Director/City Engineer, Public Works

## **ATTACHMENT**

1. Grant Activity Table

## **GRANT ACTIVITY**

## **Current Active Grant Projects (Sorted by Project Deadline)**

#	Grant	Purpose	Award Yr	Proj Deadline	Awarding Agency	Gra	nt Type	Project	Project Summary	Plans	Amount	City Match	Status
1	отѕ	Safety	2024	Sep-25	State	State	Competitive	Safe Routes to School Program	Assemblies, Rodeos and Bike Safety Equipment for Safe Routes to School Program	Bike Plan Update 2018	\$69,050	\$0	Program in-progress
2	OTS	Safety	2024	Sep-25	State	State	Competitive	Vision Zero	Safety Campaign and Data Analysis	Bike Plan Update 2018	\$77,800	\$0	Project in-progress
3	Safe Streets for All	Safety	2022	Jan-26	FHWA	Federal	Competitive	Santa Clara Vision Zero Plan	Safety Action Plans	Bike Plan Update 2018; Pedestrian Master Plan 2019	\$450,000	\$120,000	Project in-progress
4	TDA (23/24)	Bicycle and Pedestrian	FY 23/24	Jun-26	State/MTC/ VTA	State	Non- Competitive	High priority curb ramps	Bicycle and Pedestrian only	Pedestrian Master Plan 2019/ADA Plan	\$104,938	\$0	Construction Completed
5	CPUC Section 130	Transportation	2017	Jun-26	Caltrans	State	Competitive	Agnew/UPRR Crossing Improvements	Roadway/Heavy Rail Safety Improvements	Pedestrian Master Plan 2019	\$4,386,000	\$0	Restarting the project with expanded scope from Caltrans
6	Measure B	Bike & Ped Planning grant	FY23/24	Dec-26	VTA	County	Competitive	Bowers Corridor (Walsh to El Camino Real)	Outreach and analyses for bicycle lanes	Bike Plan Update 2018	\$154,000	\$146,000	Start pending completion of Council Policy on Future Bike Studies.
7	TIRCP	Rail and Transit	2022	Jun-27	State	State	Competitive	On-Demand Microtransit	Rail, Transit, Microtransit	None	\$4,007,230	\$4,007,230	Program In-progress
8	Measure B	Bicycle and Pedestrian	2022	Jul-27	VTA	County	Non- Competitive	Safe Routes to School Program	Education and encouragement only	Bike Plan Update 2018	\$408,183	\$0	Program In-progress
9	TDA (24/25)	Bicycle and Pedestrian	FY 24/25	Sep-27	State/MTC/V TA	State	Non- Competitive	High priority curb ramps	Bicycle and Pedestrian only	Pedestrian Master Plan 2019/ADA Plan	\$191,822	\$0	Construction Completed
10	Measure B	Bicycle	2020	Dec-27	VTA	County	Competitive	Lafayette St. Class IV Bikeway	Class IV Bikeway (Laurelwood - Reed)	Bike Plan Update 2018	\$1,170,000	\$130,000	Target construction Fall 2025
11	OBAG (STP and CMAQ)	Bicycle and Pedestrian	2023	Jun-30	FHWA/MTC/ VTA	Federal	Competitive	Central Santa Clara Bike/Ped Improvement Project	Safety, Bike/Pedestrian improvements	Bike Plan Update 2018; Pedestrian Master Plan 2019	\$9,029,000	\$2,280,000	City in process of selecting design consultant
12	Federal Earmark	Bicycle	2022	Sep-30	Federal	Federal	Competitive	De La Cruz Blvd, Lick Mill Blvd, Scott Blvd Corridors	Outreach, analyses, design, and construction for bicycle lanes	Bike Plan Update 2018	\$2,725,000	\$0	City in processof releasing RFB for construction
13	TDA (25/26)	Bicycle and Pedestrian	FY 25/26	Banked	State/MTC/V TA	State	Non- Competitive	To be determined	Bicycle and Pedestrian only	To be determined	\$159,508	\$0	Funding is banked for future project.
										Total:	\$22,932,531	\$6,683,230	

	GRANT ACTIVITY  Int Opportunities (Sort by Application Deadline)			
Future Grant O	pportunities	(Sort by	Application	Deadline)

Future Grant Opportunities (Sort by Application Deadline)													
#	Grant	Purpose	Award Yr	Application Deadline	Awarding Agency	Grant Type		Project	Eligibile Uses	Plans	Amount	City Match	Status
14	MTC Transit Oriented Communities Planning Grant	Transit Oriented Communities	2025	Nov-24	State	State	Competitive	Brokaw/Benton Multi- modal Undercrossing Feasibility Study	Station Access and Circulation	City's General Plan	\$400,000	\$100,000	Working with MTC on selecting consultant.
15	MTC Housing Incentives Pool	Bicycle and Pedestrian	2025	Dec-24	State	State	Competitive	Uncontrolled Crosswalks Phase 2	Bike/Pedestrian and Safety	City's General Plan	\$1,754,000	\$624,274	Target design in Winter 2025
16	отѕ	Safety	2025	Jan-25	State	State	Competitive	Safe Routes to School Program	Assemblies, Rodeos and Bike Safety Equipment for Safe Routes to School Program	Bike Plan Update 2018	\$120,000	\$0	Submitted. Expect results in summer 2025.
17	TFCA (25/26)	Bicycle and Pedestrian	2026	Mar-25	BAAQMD/ VTA	Regional	Competitive	Benton Street Bikeway	Bicycle and Pedestrian	Bike Plan Update 2018	\$150,000	\$1,223,521	Submitted in March. Expect results in Fall 2025.
18	VTA Transit- Oriented Communities Grant	Transit Oriented Communities	2025	Jun-25	VTA	County	Competitive	North Santa Clara Transit Station Access and Circulation Study	Station Access and Circulation	City's General Plan	\$150,000	\$26,500	Awarded. Working with VTA on funding agreement.
									Total:	\$37,270,039	\$10,911,025		

ATP - Active Transportation Program

BAAQMD - Bay Area Air Quality Management District

Caltrans - California Department of Transportation

CMAQ - Congestion Mitigation and Air Quality

CSTPG - Caltrans Sustainable Transportation Planning Grant

FHWA - Federal Highway Association

FTIP- Federal Transportation Improvement Program

HSIP - Highway Safety Improvement Program

MTC - Metropolitan Transportation Commission

OBAG - One Bay Area Grant

OTS - California Office of Traffic Safety

SCTPG - Sustainable Communities Transportation Planning Grant

STP - Surface Transportation Program

TDA - Transportation Development Act

TFCA - Transportation Fund for Clean Air

TIRCP-Transit and Intercity Rail Capital Program

VTA - Valley Transportation Authority UPRR - Union Pacific Rail Road

RAISE - Rebuilding American Infrastructure with Sustainabliity and Equity



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## Agenda Report

25-1078 Agenda Date: 10/27/2025

## REPORT TO BICYCLE AND PEDESTRIAN ADVISORY COMMITTEE

## **SUBJECT**

Valley Transportation Authority Bicycle and Pedestrian Advisory Committee Meetings Update (Megas)

## DISCUSSION

Bicycle and Pedestrian Advisory Committee (BPAC) Member Megas will provide a verbal update regarding recent Valley Transportation Authority Bicycle and Pedestrian Advisory Committee (VTA BPAC) meetings.

Written by: Ralph Garcia, Senior Civil Engineer, Public Works

Reviewed by: Carol Shariat, Principal Transportation Planner, Public Works

Reviewed by: Steve Chan, Transportation Manager, Public Works

Approved by: Michael Liw, Assistant Director/City Engineer, Public Works

## ATTACHMENT

1. Email from Member Megas dated October 10, 2025

From: Betsy Megas
To: Carol Shariat

Cc: Ralph Garcia; Steve Chan; Michael Liw

Subject: Re: October BPAC Agenda Item Documents - Past Due

**Date:** Friday, October 10, 2025 1:22:29 PM

#### Hi all,

We just had the October meeting this week. Here are the notes for both September and October. As usual, the full agenda packets are on the portal.

## September

## https://santaclaravta.iqm2.com/Citizens/Detail\_Meeting.aspx?ID=4298

- The committee reviewed the project priorities for Transportation Development Act (TDA3) and Transportation Funds for Clean Air (TFCA) program manager funds.
  - The City of Santa Clara will bank the TDA3 funds this cycle and use \$150,000 towards the design and construction of the Benton Street Bikeway
- The committee reviewed the assignments for the State Transportation Improvement Program (STIP) funding.
  - Of interest to those in the City of Santa Clara, some funding has been reprogrammed away from the Central Bikeway, reflecting the timing and order of the needed funding.
- The committee reviewed the Bascom Complete Streets Checklist.
- The committee reviewed and discussed the scoring system for the Measure B Bicycle & Pedestrian Planning Studies Competitive Grant.
  - One of the objectives of both the committee and the staff in updating this rubric is to invite narrative explanations of why a proposal meets the criteria and serves community needs.

#### October

### https://santaclaravta.iqm2.com/Citizens/Detail\_Meeting.aspx?ID=4299

- We revisited new and changed details from the STIP programming and Measure B scoring items from September.
- We got an informational update on the Better Bus Stops program to add benches, shelters, lighting, trash cans, and other amenities to bus stops.
- We got an update on three station access studies: River Oaks, Hostetter, and Great Mall.
- We learned the results of the second annual cycle for VTA's Transit-Oriented Communities grants.
  - The City of Santa Clara was awarded \$145,000 for the North Santa Clara Transit Station Access and Circulation Study.
  - The Santa Clara City Library Foundation and Friends was awarded \$25,000 for Project LIFT – Literacy for Transit
- We learned from engineer Tom Esch about County Roads' Planning and Early Design Review process.

Take care,

Betsy Megas



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## Agenda Report

25-1079 Agenda Date: 10/27/2025

## REPORT TO BICYCLE AND PEDESTRIAN ADVISORY COMMITTEE

## **SUBJECT**

Santa Clara Station Area Task Force Update (Shure)

## **DISCUSSION**

Bicycle and Pedestrian Advisory Committee (BPAC) Member Shure will provide an update regarding recent Santa Clara Station Area Task Force meetings.

Written by: Ralph Garcia, Senior Civil Engineer, Public Works Reviewed by: Steve Chan, Transportation Manager, Public Works

Approved by: Michael Liw, Assistant Director/City Engineer, Public Works

## **ATTACHMENT**

1. Santa Clara Station Area Task Force Update



# Santa Clara Station Area Task Force Update


**Bicycle & Pedestrian Advisory Committee** 

October 27, 2025


# **Preferred Development Concept – Landmark Tower**



# **Preservation of Police Station**

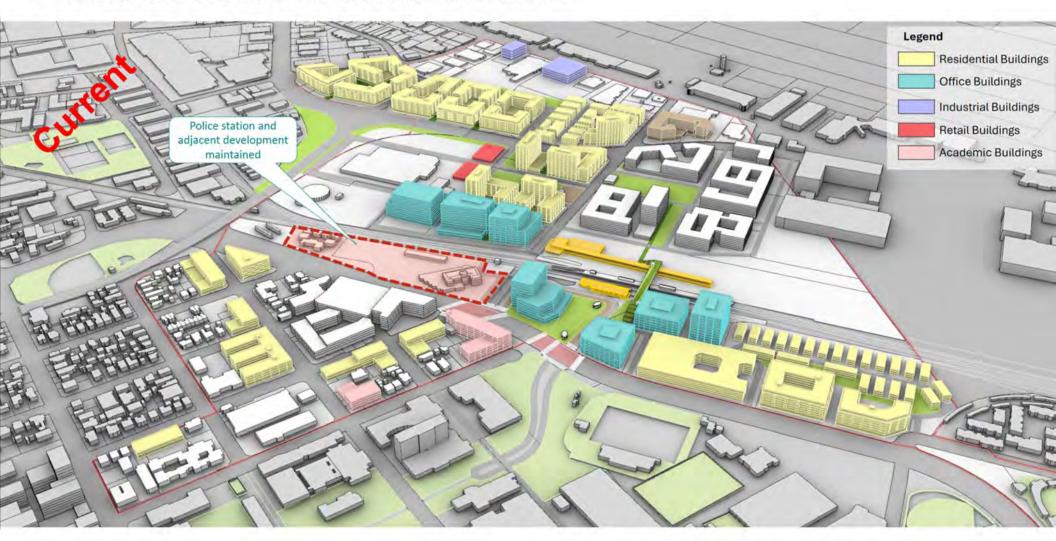

# Flexibility to Design

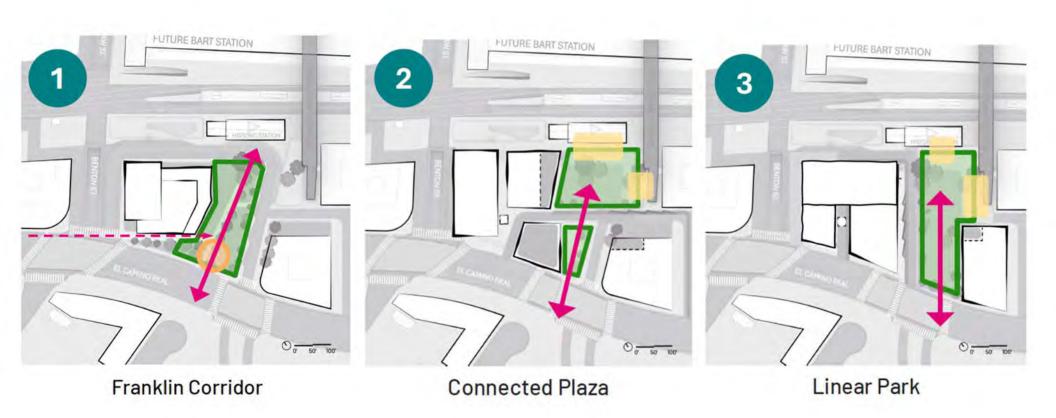

**CURRENT APPROACH** 

# Building Heights Maximum

Legends



ALTERNATE APPROACH

# Building Heights Maximum

Legends

