





320 Sycamore Valley Road West Danville, CA 94526 www.shephardarch.com (925) 803 - 1000


COVER SHEET


AT:

2290 DE LA CRUZ BLVD

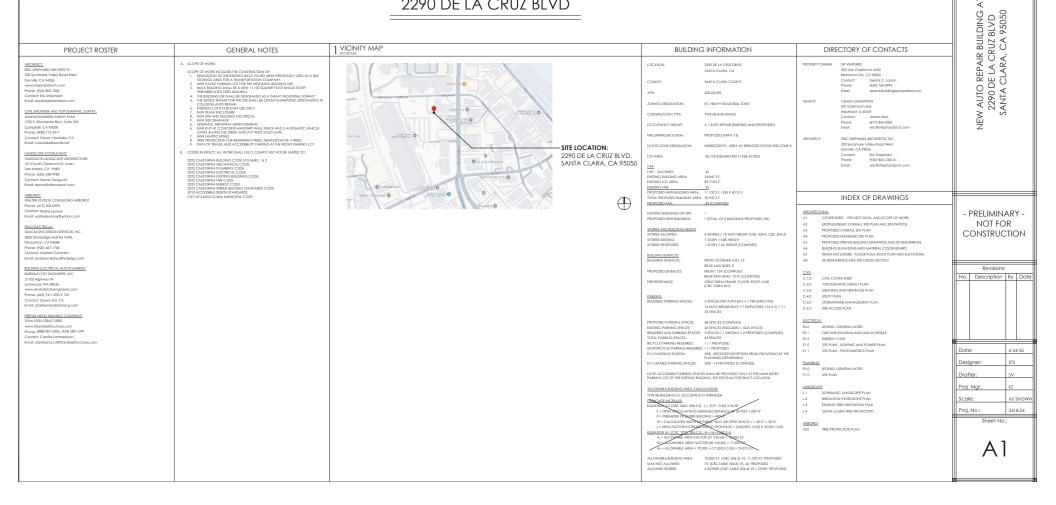

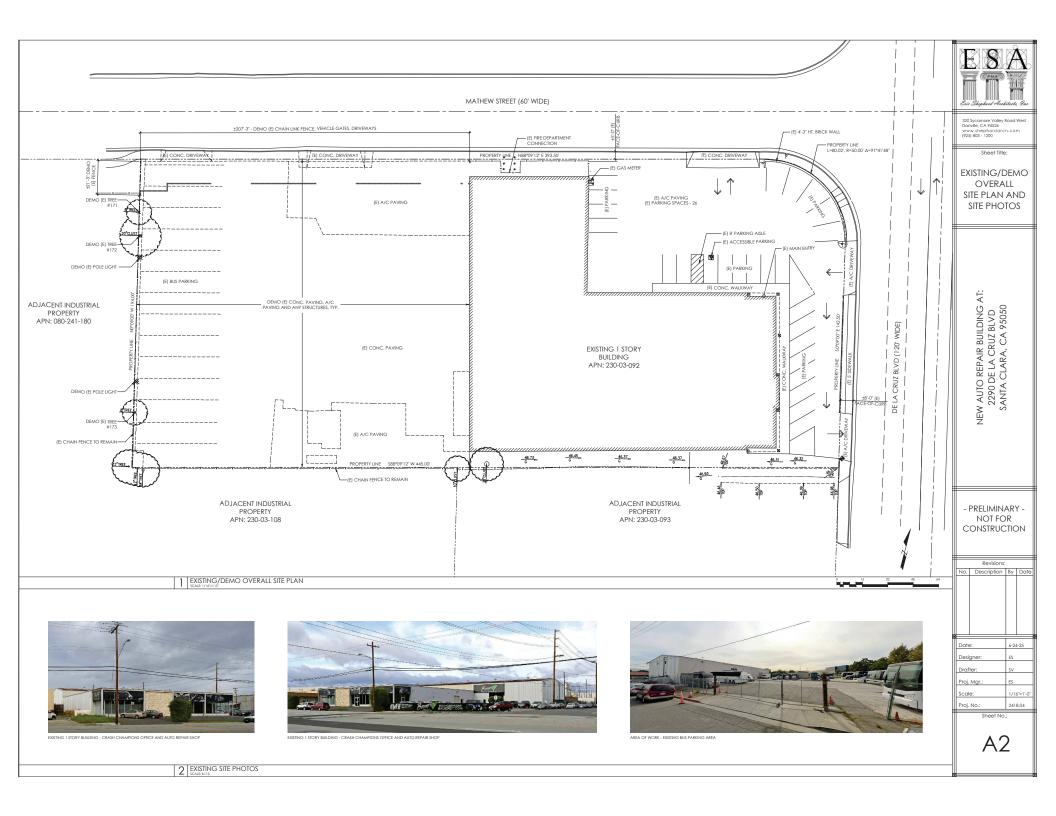


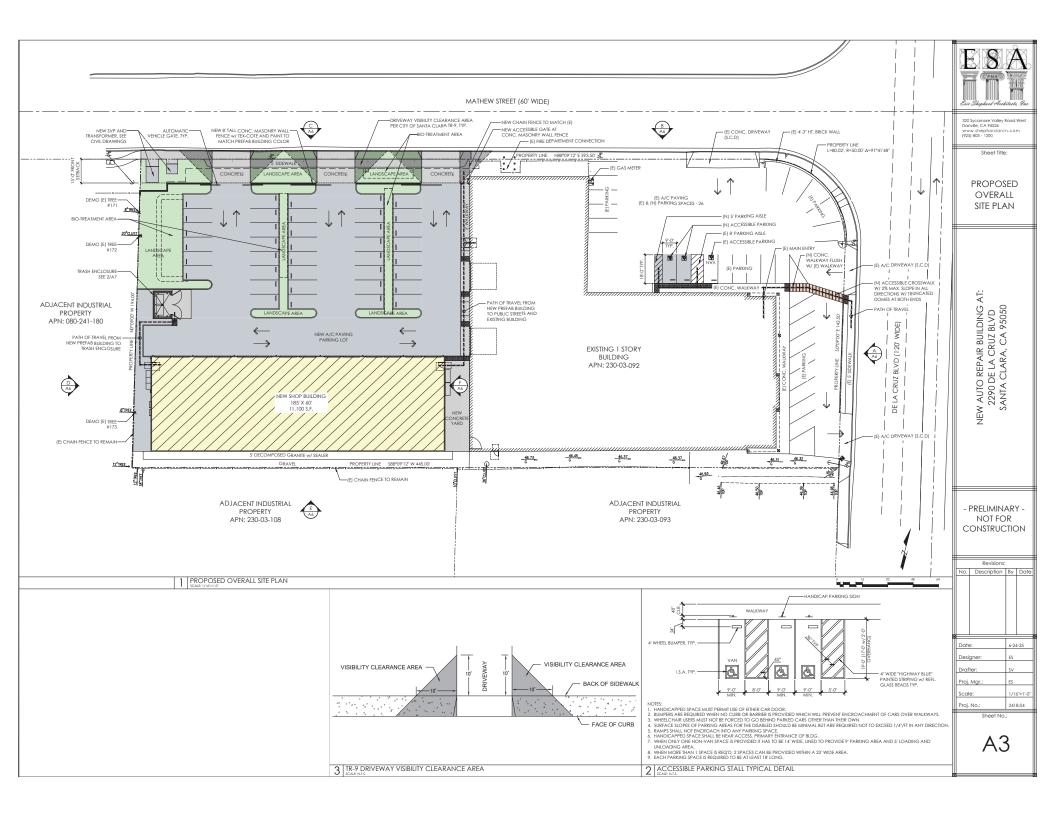


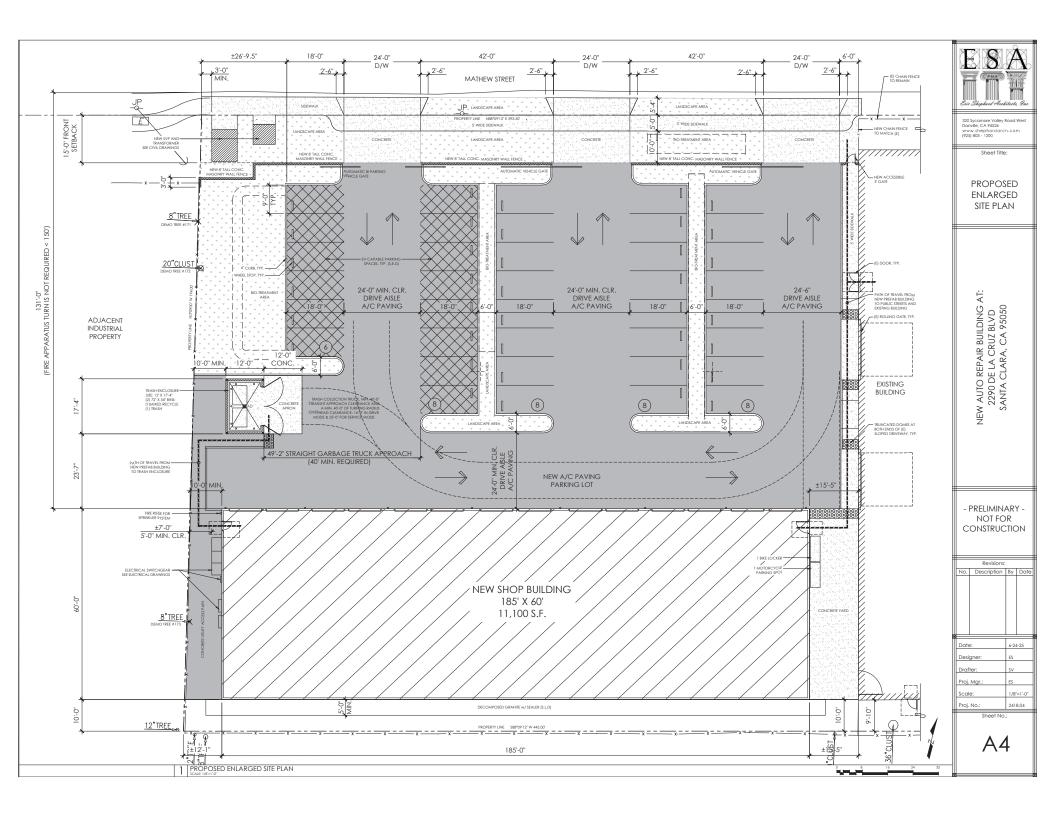








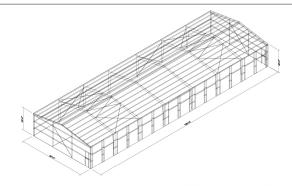


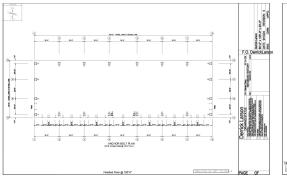


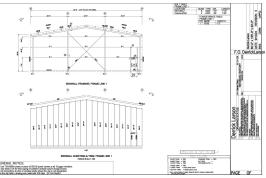


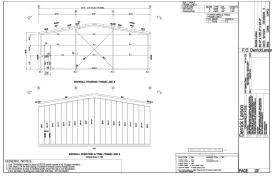


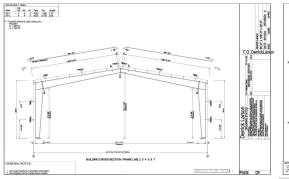

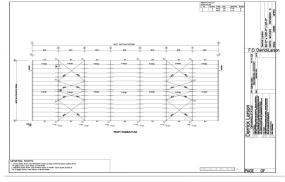

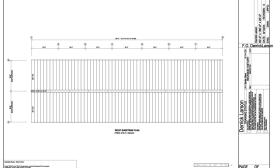

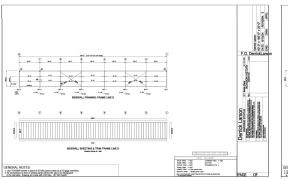

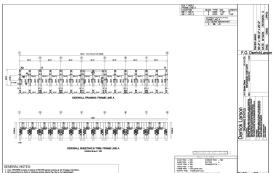

1 PROPOSED PREFAB BUILDING DRAWINGS AND 3D RENDERINGS

ESA Eii Shephad Aukitata, Inc.

320 Sycamore Valley Road We Danville, CA 94526 www.shephardarch.com (925) 803 - 1000

Sheet Title:

PROPOSED PREFAB BUILDING DRAWINGS AND 3D RENDERINGS

NEW AUTO REPAIR BUILDING AT: 2290 DE LA CRUZ BLVD SANTA CLARA, CA 95050


- PRELIMINARY -NOT FOR CONSTRUCTION


Revisions:

No. Description By Date

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ate):	6-2	1-25	
esi	gner:	ES		
raf	ter:	sv		
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cal	e:	AS:	SHOWN	

A5

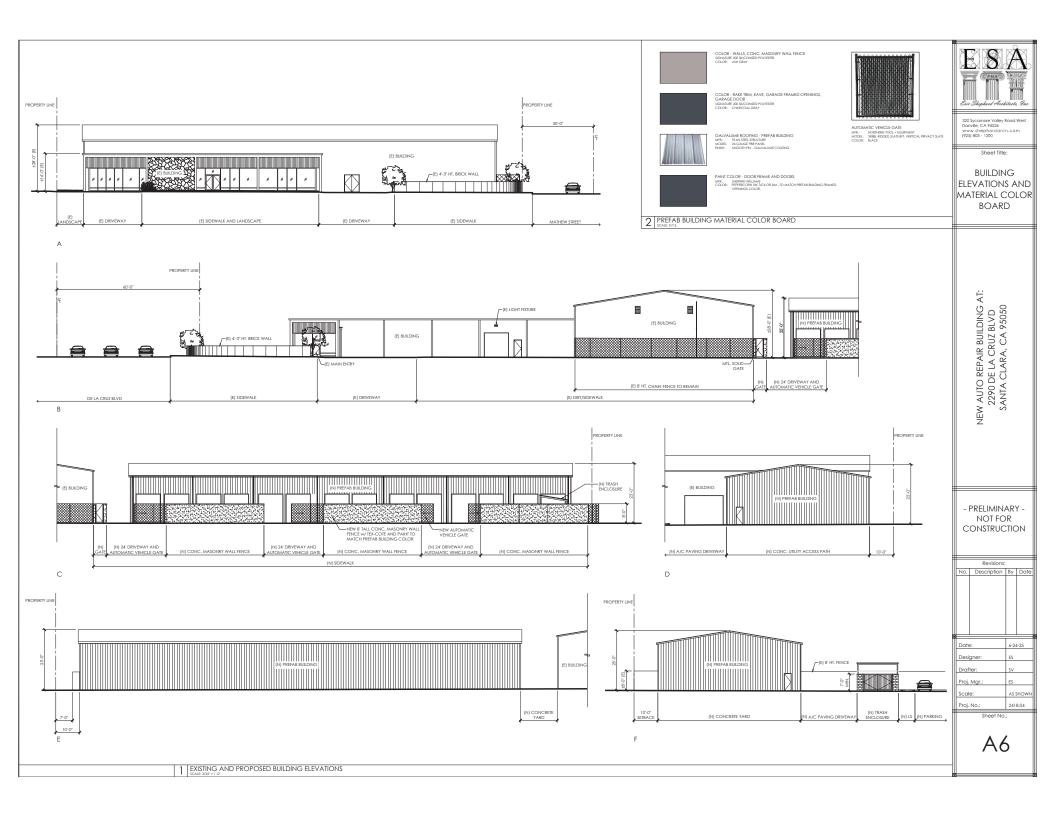

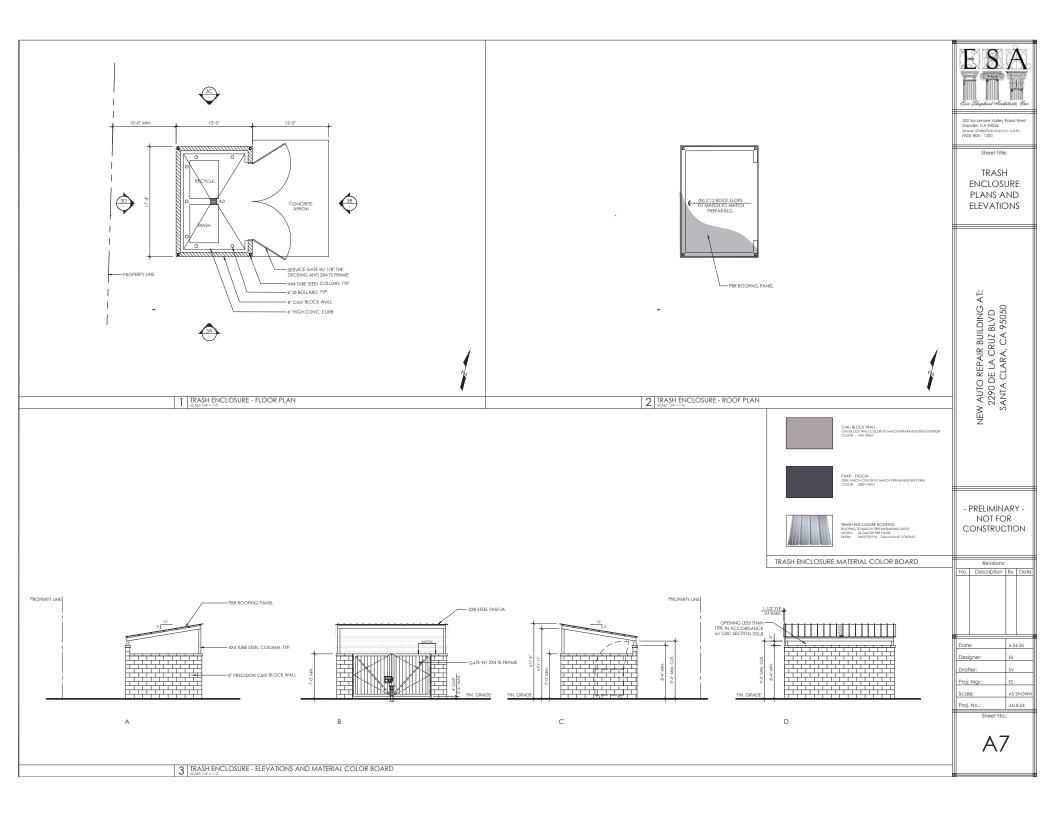



320 Sycamore Valley Road We Danville, CA 94526 www.shephardarch.com (925) 803 - 1000

Shoot Title:

3D RENDERINGS AND SITE CROSS-SECTION

> NEW AUTO REPAIR BUILDING AT: 2290 DE LA CRUZ BLVD SANTA CLARA, CA 95050




VIEW FROM SIDEWALK ACROSS THE MATHEW STREET

1 3D RENDERINGS

AERIAL VIEW

2 PRELIMINARY SITE CROSS-SECTION

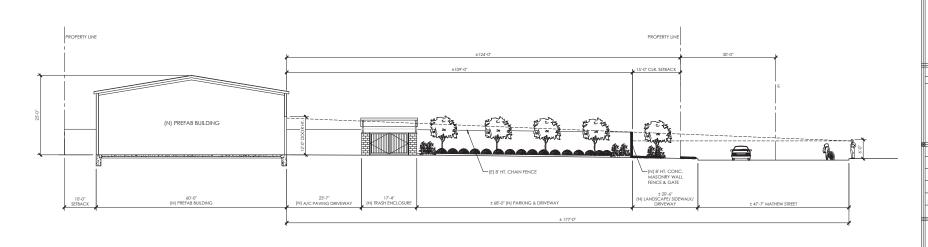

- PRELIMINARY -NOT FOR CONSTRUCTION

Revisions:

1				
No.	Description	Ву	Date	
			=	
Date	e:	6-2	1-25	
Desi	gner:	ES		
١		١		
Draf	ter:	SV	_	
Proj.	Mgr.:	ES		
Scal	e:	AS:	NWOH	
Proj.	No.:	241	8.04	
=		_	_	

8A

EXISTING PROPOSED RETAINING WALL A.C. PAVEMENT ____ CONC. VALLEY GUTTER Geografie esta CONC. SIDEWALK OR PAD 6" CURB & GUTTER EDGE OF A.C. PAVEMENT 6" VERTICAL CURB CENTER LINE __8"__ss-_ _ SANITARY SEWER MAIN _____15**__SD-___ STORM DRAIN MAIN PERFORATED PIPE WATER MAIN _6"_FW----FIRE WATER MAIN ___4"__DW___ DOMESTIC WATER MAIN ____4*___CHW-____ 6"__CHW___ CHILLED WATER MAIN IRRIGATION LINE HOT WATER SUPPLY & RETURN ----HWS-HWR-----STEAM LINE TRENCH DRAIN CONDENSATE RETURN -- CR -----FLOW LINE CHAIN LINK FENCE GAS MAIN ELECTRIC AND SIGNAL DUCT BANK ——£—— OVERHEAD ELECTRIC LINE LINDERGROUND ELECTRIC LINE STREET LIGHT CONDUIT CONTOUR FLEVATION LINE -----85 -----FG 95.94 x 95.94 🏰 SPOT ELEVATION 2:1 1% DIRECTION OF SLOPE GAS METER **∭** GM Š. GAS VALVE WATER METER ₩ ĕ ñ WATER VALVE FIRE HYDRANT 77 101 ж BACK FLOW PREVENTOR PIV POST INDICATOR VALVE FIRE DEPARTMENT CONNECTION WATER LINE TEE CAP AND PLUG END **■** ARV AIR RELEASE VALVE ACCESSIBLE RAMP CONCRETE THRUST BLOCK → REDUCER • SANITARY SEWER MANHOLE SANITARY SEWER CLEANOUT SSÇO SSCO STORM DRAIN MANHOLF \odot 00 STORM DRAIN AREA DRAIN STORM DRAIN CATCH BASIN STORM DRAIN CURB INLET SDCO STORM DRAIN CLEANOUT ELECTROLIER · * * · * JP. JOINT POLE OVERLAND RELEASE \Rightarrow DETAIL REFERENCE CONSTRUCTION DETAIL REFERENCE SHEET REFERENCE

LEGEND

ABBREVIATIONS

AB AC ADA ADA ASB BC BFDC BLDG BOD BOD BOS BOW CAC CAC CAC CONC ASPHALT CONCRETE
AREA DRAIN
AMERICANS WITH DISABILITIES ACT
AGGREGATE SUBBASE
BEGINNING OF CURVE ROUNTED AT STREAMS

ESCANMIC OF COUNTY OF

BULDING COPINER

BULDING COPINER

BUTTON OF DOCK

BOTTON OF STEP

BOTTON OF STEP

BOTTON OF STEP

BOTTON OF WALK

COMPRETE OF WALK

CURRE AND CUTTER

CAMPAN AND CUTTER

CAMPAN AND CUTTER

CAMPAN AND CUTTER

CAMPAN AND COMPRETE

COMPRETE INFO OF CLASS

CORNIGE OF CLASS

CORNIGHTED INFO O

CORRUGATED METAL PIPE
OLEANOUT
CURB OPENING INLET
CONCRETE
CONSTRUCTION OR CONSTRUCT
CUBIC YARD
DOUBLE CHECK DETECTOR ASSEMBLY

DROP INLET
DUCTILE IRON PIPE
DOMESTIC
DOMESTIC WATER DRAWNO
EAST
END OF CURVE
EDGE OF PAVEWENT
END OF RETURN
END VERTICAL CURVE
ELEVATION
EXISTING
FIRE DEPARTMENT CONNECTION
FINSHEPS DEPARTMENT CONNECTION

FIRE DEPARTMENT C FINISHED FLOOR FINISHED GRADE FIRE HYDRANT FOUNDATION FINISHED SURFACE FOOT FIRE WATER GROUND ELEVATION GRADE BREAK GATE VALVE GRADE BREAK
GATE VALVE
ACCESSIBLE RAMP
HIGH POINT
INVERT ELEVATION
JOINT POLE
JOINT TRENCH
LIP OF GUTTER
LOW POINT
LANDSCAPE ARCHITECT
MAXMUM
MECHANICAL ALLECTRICAL MECHANICAL /ELECTRICAL /PLUMBING MANHOLE MINIMUM MIDPOINT OF VERTICAL CURVE MONUMENT

MONUMENT NORT IN CONTRACT NUMBER NOT TO SCALE PAVEMENT ELEVATION PAVELENT ELEVATION
PORTAND CLEENT CONCRETE /
PORT OF CONTINUOUS CURVATURE
POST MUSICATOR VALVE
PROPERTY LINE
POWER MANHOLE
POWER ON CURVE
POWER OF REVERSE CURVATURE
POWER OF REVERSE CURVATURE
POLYMON, COLORDE PIPE
RADIUS
RELATIVE COMPACTION
RELATIVE COMPACTION
RELATIVE COMPACTION
RELATIVE COMPACTION

PCC


REDUCED PRESSURE PRINCIPLE
RIGHT OF WAY
2.0FC OF SOUTH
2.0FC OF SOUTH
3.0FC OF SO

STANDARD
SIDEWALK
TOP OF CURB
TRENCH DRAIN
TOP OF DOCK
TOE OF SLOPE
TOP OF STAIR
FG ® TOP OF WALL
TOP OF SLAB
TYPICAL INVESS OTHERWISE NOTED


UNLESS UTHERWISE N UNDERGROUND VERTICAL CURVE WATER METER WATER VALVE WEST WELDED WIRE FABRIC

2290 DE LA CRUZ

SANTA CLARA, CA

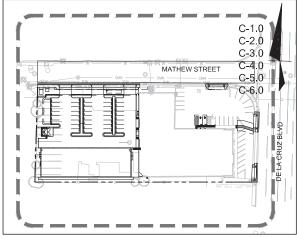

KEY MAP

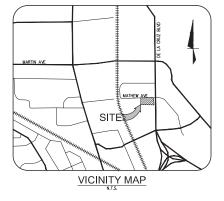

PROJECT DESCRIPTION

THIS PROJECT PROPOSES TO CONSTRUCT A NEW 12,000 SF METAL BUILDING AND ASSOCIATED SITE IMPROVEMENTS. THE BUILDING WILL INCLUDE NEW UTILITY SERVICES, GRADING AND DRAINAGE, AND STORMINATER MANAGEMENT IMPROVEMENTS.

OWNER INFO

DOLLINGER PROPERTIES
CONTACT PERSON: DERRICK LARSON
555 TWN PROPERTIES DR. #600
REDWOOD CITY, CA. 94065 PH: (650)766-0099 EMAIL: DERRICK@DOLLINGERPROPERTIES.COM

CIVIL SHEET INDEX

C-10 CIVIL COVER SHEET C-2.0 C-3.0 TOPOGRAPHIC SURVEY GRADING AND DRAINAGE PLAN

C-4.0 UTILITY PLAN

FIRE ACCESS PLAN

CONSTRUCTION CONTRACTOR AGREES THAT IN ACCORDANCE WITH GENERALLY ACCEPTED CONSTRUCTION PRACTICES, CONSTRUCTION MICHIGANIZED WILL BE REQUIRED TO ASSUME SIGE AND COMPLETE PRACTICES, CONSTRUCTION MICHIGANIZED WILL BE AGREED TO A REPORTED THAT THIS REQUIREMENT SHALL BE AGREED APPLY CONTRICUOUS SHAPEY OF ALL PERSONS AND PROPERTY. THAT THIS REQUIREMENT SHALL BE AGREED APPLY CONTRICUOUS PROPERTY AND THE PROPERTY TO ARRIVE AND CONTRICUOUS AND CONSTRUCTION APPLY CONTRICUOUS PROPERTY AGREES TO THE AGREED THAT AND ALL LIBBUTY, REAL OF ALLESSO IN CONNECTION WITH THE PERFORMANCE OF AGREED ATTENDED AND AGREED THAT AND ALLESSO IN CONNECTION WITH THE PERFORMANCE OF AGREED ATTENDED AND AGREED ATTENDED AND AGREED THAT AND ALLESSO IN CONNECTION WITH THE PERFORMANCE OF AGREED ATTENDED.



UNAUTHORIZED CHANGES AND USES CAUTION: THE ENGINEER PREPARING THESE PLANS WILL NOT BE RESPONSIBLE FOR, OR LIMBLE FOR, UMUTHORIZED CHANGES TO OR USES OF THESE PLANS, ALL CHANGES TO THE PLANS MUST BE IN WRITING AND MUST BE APPROVED BY THE PREPARES OF THE PLANS.



BUILD ON.

DATE: 06/24/2025 SCALE: AS NOTED PROJECT No : 224179

DATE JUNE 24

, 2025


2290 DE LA CRUZ


SANTA CLARA


CALIFORNIA


CIVIL COVER SHEET


SHEET C-1.0

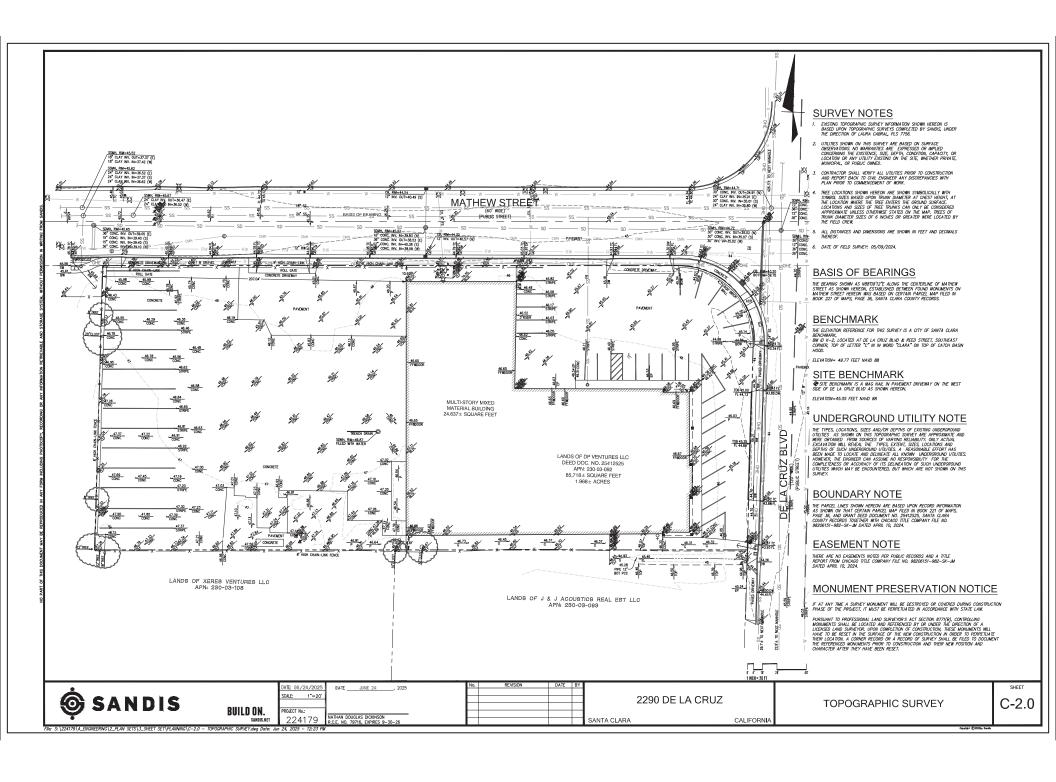


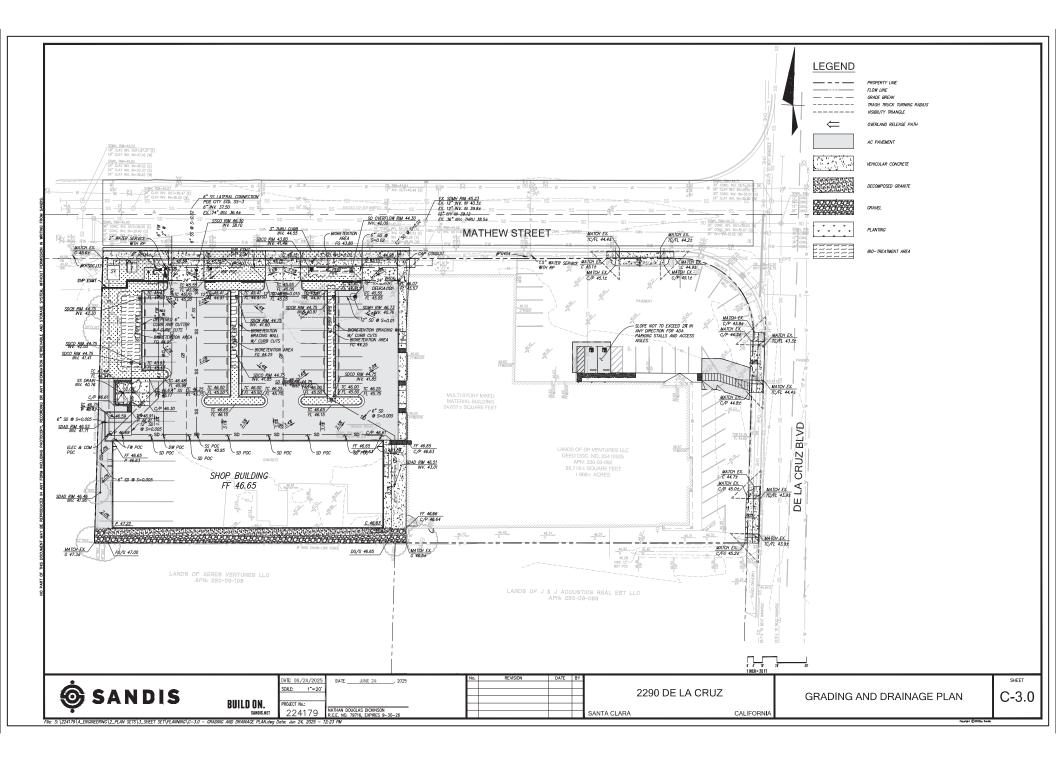

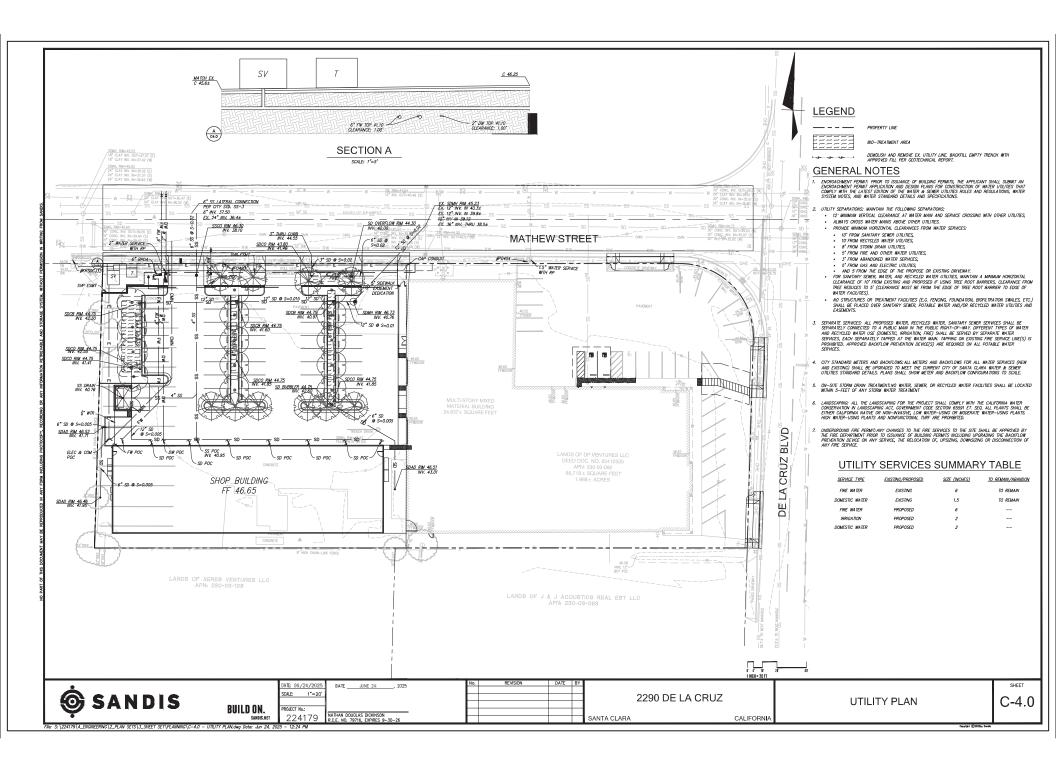

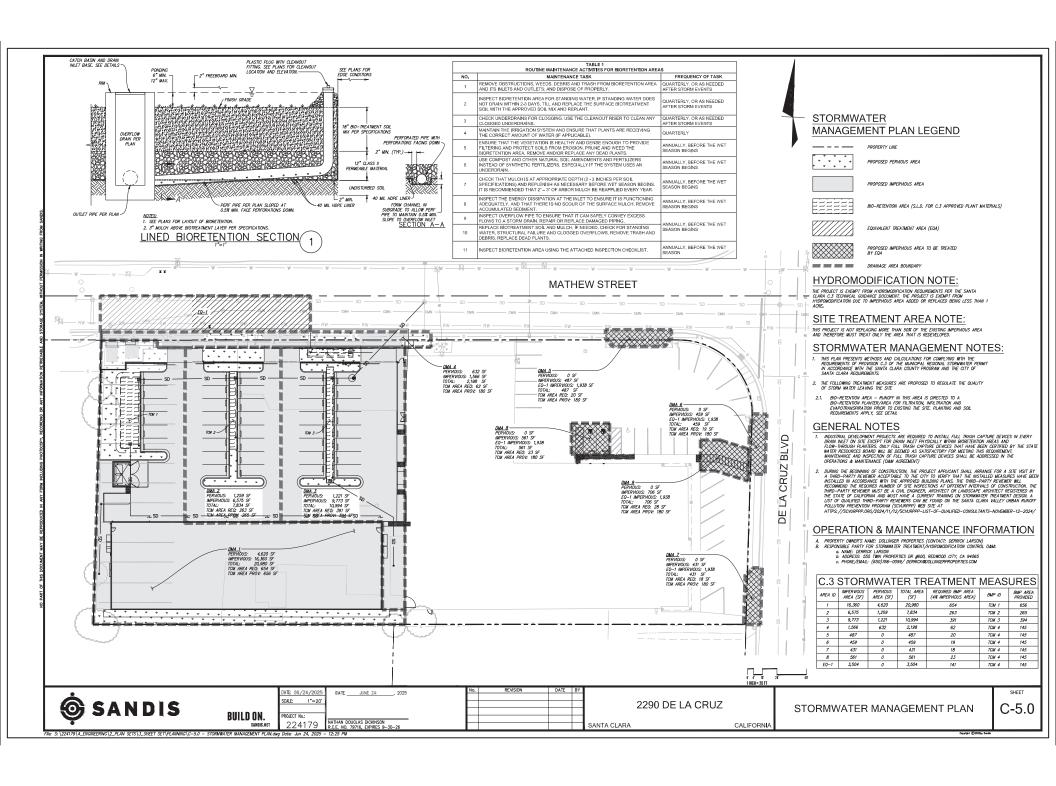

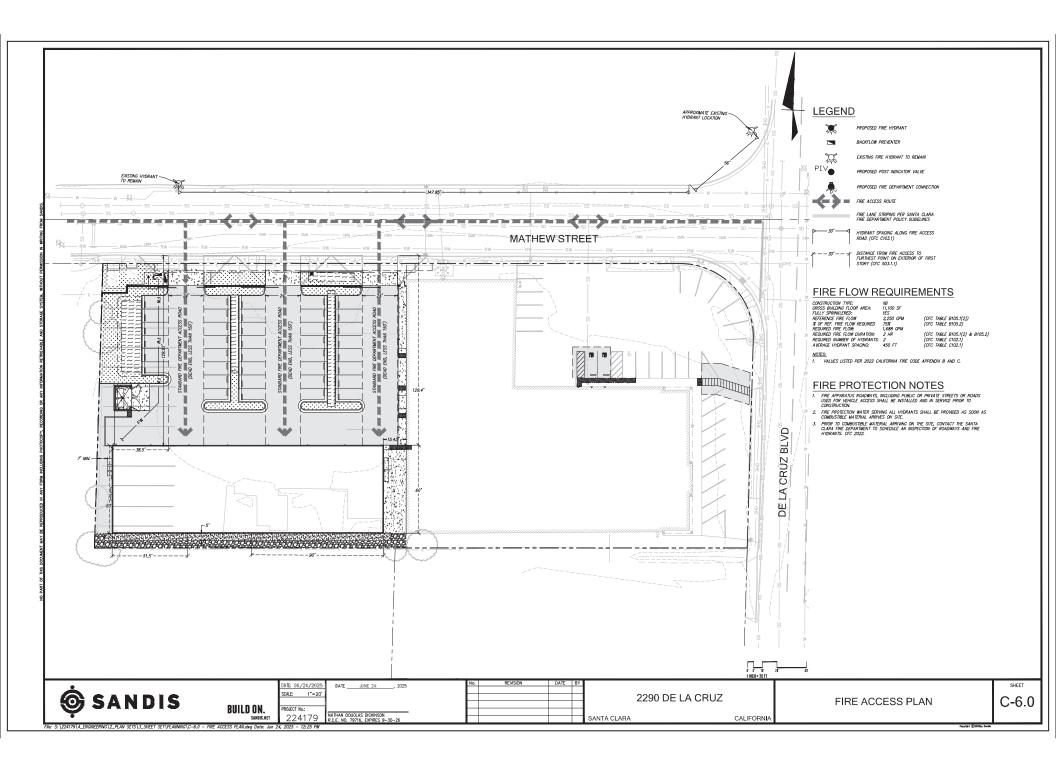

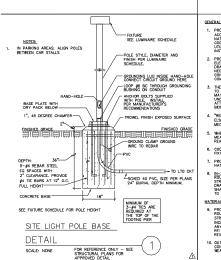

LUMINAIRE SCHEDULE

DESCRIPTION

16' POLE LIGHT, FULL CUTOFF, TYPE IV, BRONZE, HOUSE SIDE SHIELD, INTEGRAL MOTION DETECTOR

EXTERIOR WEDGE LIGHT, 11.5 W X 9 H X 7 D, FULL CUTOFF, FORWARD THROW

4' LINEAR LED, VAPOR TIGHT

SYMBOL

6

Ф

CALLDUT

GENERAL NOTES

1. PROVIDE ELECTRICAL INSTALLATION IN

- 2. PROVIDE ITEMS NECESSARY TO COMPLETE ELECTRICAL SYSTEMS. THE ELECTRICAL DRAWNOS ARE DIAGRAMMATIC AND DO NOT NECESSARIL'S HOW EVERY COMDUIT, BOX, COMDUCTOR, OR SIMILAR ITEMS FOR A COMPLETE INSTALLATION.
- . THE CONTRACTOR SHALL VISIT THE SITE PRIOR TO BID AND DETERMINE CONDITIONS WHICH MAY AFFECT BID. ANY TIEMS NOT FULLY UNDERSTOOD SHALL BE BROUGHT TO THE ATTENTION OF THE ARCHITECT PRIOR TO
- *REF* NDICATIONS DENOTE WORK COVERED ELSEWHERE (ARCHITECTURAL, STRUCTURAL, OR 15. WRING: POWER WIRNG SHALL BE COPPER MECHANICAL). THINN/THINN, INSULATED FOR 600V. ALUMI
- WHEREVER THE WORD "PROVIDE" IS USED, IT MEANS FURNISH AND INSTALL COMPLETE AND READY FOR USE.
- COORDINATE LOCATION OF ELECTRICAL FIXTURES WITH OTHER TRADES.
- PROVIDE CONDUCTORS AND RACEWAYS PER NATIONAL ELECTRICAL CODE.
- NATIONAL ELECTRICAL

 I. IN-SLAB CONDUITS: CONTRACTORS MAY
 ROUTE BRANCH CIRCUITS IN SLAB WITH
 ENGINEERS APPROVAL. A SHOP MATERIALS AND METHODS
- 9. PROWDE RACEWAY AND WIRING AS NOTED, ROUTED CONSCALED WITHIN BUILDING STRUCTURE WHEREVER POSSIBLE (EXCEPTIONS INCLUDE GARAGE & BOW/JUTILITY ROOMS), ANY EXPOSED MRING IS TO BE SENT AS AN RIF FOR OWNER, ARCHITECT, & ENGINEER
- CONDUITS ROUTED ON ROOF OR EXPOSED TO 18, SUPPORT; SUPPORT LIGHT FIXTURES FROM WEATHER SHALL BE EMT OR LIQUID—TIGHT

BALLAST

WDGE2 LED

(1)

MOUNTING

 2,00

 2,00
 3,000
 4,900
 6,000

 8,50
 18,000
 12,000

 16,00
 16,000
 29,000
 22,000

CEILING

WALL

LAMP

(1) 42W 4000K LED

(1) 52W LED 4000K

Depth (D1: Depth (D2: Height: Width: Weight:

- 12. CONNECTIONS: PROVIDE GRS, METALLIC FLEX, OR LIQUIDITIE FLEX CONDUITS FOR CONNECTIONS TO MOTORS OR MOTORIZED EQUIPMENT.
- 13. WRING: MINIMUM TO BE #12 AWG WIRE IN COMMON AREAS; #14 ALLOWED WITHIN DWELLING UNITS ONLY, NON-METALLIC CABLE (ROMEX) IS ALLOWED IN TYPE II OR V CONSTRUCTION ONLY, INSTALLED PER NEC,
- 23. UNDERGROUND CONDUITS: PROVIDE PVC. SCHEDULE 40, 3/4" MINIMUM. PROVIDE PVC CONDUIT TRANSITION ELBOW WHEN TURNING UP TO ABOVE-GRADE.
 - 24. BELOW SLAB: CONDUIT ROUTED BELOW ON-GRADE FLOOR SLABS SHALL BE INSTALLED PRIOR TO FLOOR SLAB POUR, ROUTE CONDUITS BELOW SLAB AS STRAIGHT AS POSSIBLE TO MINIMIZE BENDS, 25. ALL CONDUITS PENETRATING THE BUILDING ENVELOPE BELOW GRADE SHALL FOLLOW WATERPROOFING REQUIREMENTS IN THE ARCHITECTURAL DRAWINGS.

MODEL.

LITHONIA: VAR. 4000 M. EST. WD. MVOLT C710 40V 80CPL

EATON - STREETWORKS (FORMER COOPER LIGHTING) USSL-COI-D-U-T4-SA-BZ-HSS, MS-DIM-L20 WITH 16' STEEL POLE

- LINESTED ASSOCIATED AND INVESTED AND INVESTED AS INVESTED AND INVESTED AS INVESTED AS INVESTED AS INVESTED AND INVE 26. AT CONTRACTORS DISCRETION, NEUTRALS MAY BE SHARED ON COMBINED HOMERUNS UNLESS THE CIRCUIT HAS A GOT OR AFG BREAKER, AN ISOLATED GROUND, OR 15 FROM A PAVEL
- 17. FUSES: PROVIDE FUSES PER EQUIPMENT NAMEPLATE UNLESS OTHERWISE INDICATED. FUSES SHALL BE PROVIDED WITH REJECTION TYPE FUSE HALL DEPEN.

BUILDING STRUCTURE. DO NOT SUPPORT FIXTURES FROM SUSPENDED CEILING.

NEUTRAL MINES SHOWN FOR TWO— AND THREE—POLE MECHANICAL/KITCHEN ECUIPMENT HAY BE CONTITED UPON VERRICATION THAT THEY ARE NOT REQUIRED FOR EITHER OPERATION OR CONTROL CROUTS PER MANUFACTURER'S SPECIFICATIONS.

INPUT WATTS

VOLTS

277V 1D 2W

- 19. LABELS: ENCLOSURES FOR ELECTRICAL PANELS, TIME SWITCHES, DISCONNECTS, STAPTERS, CONTACTORS, PIUL BOXES, ETC, SHALL BE, PERMANENTLY LABELED TO IDENTEY THEIR DESIGNATION OR UNIT SERVED. PANEL SCHEDULES MUST BE TYPED. PROMDE LIGHT FIXTURES W/ PROPER FITTING FLANCES, MOUNTING SUPPORTS, AND ACCESSORY ITEMS UL LISTED FOR CONDITIONS OF USE.
- 29. LOW YOLTAGE LIGHTING
 29.1. PROVIDE LOW YOLTAGE TRANSFORMERS IN
 MEARIN' ACCESSIBLE CEILING SPACE,
 29.2. PROVIDE LOW YOLTAGE CONDUCTORS
 SIZED PER MANUFACTURER'S GUIDELINES
 TO MINIMIZE VOLTAGE BROP. 20. PAINTING: ELECTRICAL ENCLOSURES SHALL BE PAINTED TO MATCH ADJACENT WALL.
- 21. COVERPLATES: PROVIDE AS FOLLOWS, SUBMIT SAMPLE OF EACH FOR APPROVAL:
- 21. COURREATES PROVIDE AS FOLIONS, SUBMIT TO MINIMALE VIALIDATIONS AND ASSESSMENT OF THE PROVIDE AS THE COLOR PLANTS.

 21. ALL OTHER AREAS, WHITE COLOR PLASTIC, 30, THE CONTROLLED FROM A SPICE SHOT OF THAT MAY BE CONTROLLED FROM A SPICE SHOT

 - 32. NO LIGHTING SHALL BE ON THE SAME CIRCUIT BREAKER AS EQUIPMENT LOADS.

MISCELLANEOUS

- PROVIDE ALL NECESSARY FIRE CAULKING & FIRE STOPPING FOR ALL ELECTRICAL EQUIPMENT.
- 34. TAMPER RESISTANT RECEPTACLES ARE REQUIRED FOR ALL 15A AND 20A 120' RECEPTACLES LOCATED THROUGHOUT FNIBE PROLIFE.
- 6. SUB-GRADE ELECTRICAL ROOMS: PROVIDE HOUSEKEEPING PAD FOR ALL SMITCHGEAR LOCATED IN SUB-GRADE ELECTRICAL ROOM HOUSEKEEPING PAD TO BE LESS THAN 2" I HEIGHT.

TRASH ENGLOSHED

MOTES

SITE LIGHTING PARKING LOT, B2-UD-G2, INTEGRAL MOTION SENSOR TO DIM TO 50% WHEN NO ACTIVITY FOR 15 MIN, PROVIDE WITH TUNING DIMMERS

Streetworks

LEGEND

LIGHT FIXTURE CALLOUT

HO B ILLUMINATED EXIT SIGN.

- SINGLE POLE, SINGLE THROW JGHT SWITCH, 20A (WP = WEATHERPROOF COVER)
- THREE-WAY LIGHT SWITCH, 20A \$4 FOUR-WAY LIGHT SWITCH, 20A

- SWITCH, SINGLE POLE; WITH SWITCHING SUBSCRIPT 'a'
- \$\$ DUAL SWITCHES, BOTH WITH OCCUPANCY SENSOR CONTROL
- DCCUPANCY SENSOR, WALL MOUNTED 63 OCCUPANCY SENSOR, CEILING MOUNTED
- 0 SINGLE RECEPTACLE, GROUNDED
- 0
- . DUPLEX RECEPTACLE, 1/2 HOT
- ra IG DUPLEX RECEPTACLE, ISOLATED GROUND
- D are DUPLEX RECEPTACLE WITH GROUND FAULT INTERRUPTION (GFCI)
- DUPLEX RECEPTACLE WITH GROUND FAULT INTERRUPTION (GFCI) LOCATED ABOVE COUNTER

A AC

QUAD RECEPTACLE, GROUNDED

- PANEL BOARD
- ELECTRICAL DISTRIBUTION EQUIPMENT
- A CIRCUIT BREAKER DISCONNECT SWITCH
- L) NON-FUSED DISCONNECT SWITCH FUSED DISCONNECT SWITCH
- MAGNETIC MOTOR STARTER
 - COMBINATION MAGNETIC MOTOR STARTER AND
- MOTOR CONNECTION

- DUPLEX RECEPTACLE, GFCI WITH WEATHERPROOF COVER EXTRA DUTY AND WEATHER RESISTANT RECEPTACLE
- SPECIAL PURPOSE RECEPTACLE AS NOTED
- (8)
 - JUNCTION BOX

COMBINATION SMOKE & CARBON MONOXIDE ALARM (POWERED BY FIRE ALARM)

ABBREVIATIONS



SW AUTO REPAIR BUILDINGS FOR: 2290 DE LA CRUZ BLVD SANTA CLARA, CA 95050

O

EMERALD C

ר א

21705 HIGHWAY 99 YNNWOOD, WA 98086

∆ 06/04/25 BUILDING RESUBMITTAL



SMD ISSUANCE PLANNING SET

DATE: 06/24/25

SHEET TITLE: LEGEND

GENERAL NOTES

APPLICABLE CODES DRAWING INDEX

HEAT TRACE INSULATED CEILING RATED INTERMEDIATE DISTRIBUTION FRAME ISOLATED GROUND

JOINT TRENCH
THOUSAND CIRCULAR MILLS
KITCHEN EQUIPMENT CONTRACTOR
KILOVOLT AMPERES

Account 25 2000 2-06/25

- CALIFORNIA ELECTRIC CODE 2022
 CALIFORNIA BUILDING CODE 2022
 CALIFORNIA FIRE CODE 2022
 NATIONAL ELECTRIC CODE 2020
 CALIFORNIA TITLE—24 ENERGY CODE 2022
 CALIFORNIA GREEN BUILDING STANDARD 2022

DWG	DESCRIPTION
E0.0	LEGEND, GENERAL NOTES
E0.1	ONE LINE DIAGRAM & LUM SCHEDULE
F0.2	ENERGY CODE
E0.3	ENERGY CODE
E1.0	SITE PLAN LTG & PWR
E1.1	SITE PLAN PHOTOMETRICS

WITH WITHOUT TRANSFORMER

TRANSFER IMPEDANCE OR ZONE

SHEET NO. E0.0

Z2 FIXTURE


PRHICTY

Z7 FIXTURE SCALE: NONE


USSL USSL-XL douglicke the common transport funder many other work transport AREA / SITE / ROASMAY LUMINARE 🐽 🐽


> SHIPPING DATA Approximate Net Weigh: JSSL 30 fox. (0.00 kgs.) JSSL-Ni; 45 fox. (0.41 gs.) ٠

COMPRENT 2005, EMERALD CITY ENGREENE, INC., 2007 210, 2007 21, 2007 210, 2007 21, 2007 21, 2007 21, 2007 21, 2007 21, 2007 21, 2007 21, 20

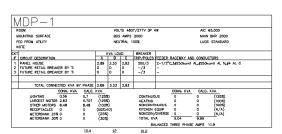

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3	20/1	0.5	LIGHTING			- 1	4	20/1	0		SPARE			
5	20/3	2.83	POWERED	GATE		- 1		20/1			SPARE			
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15	1		1			- 1	16				SPARE			
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25	20/1	0	SPARE					20/1			SPARE			
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31	20/1	0	SPARE			ŀ		20/1			SPARE			
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DP VENTURES
2280 DE LA CRUZ BLVD
SANTA CLARA, CA 95050

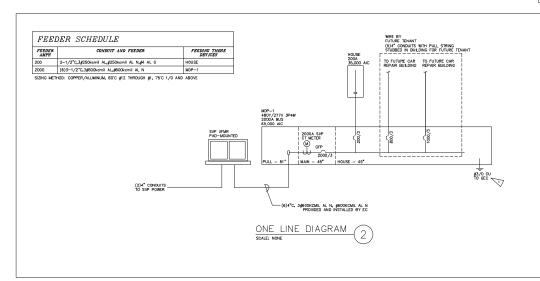DESIGNED:

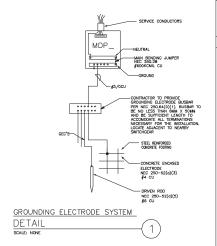PLANNING SET DATE:

06/24/25

SHEET TITLE:

ONE LINE

DIAGRAM &

LUM SCHEDULE

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CIRCUIT BREAKERS 400A AND LARGER TO HAVE FIELD-ADJUSTABLE, SHORT-TIME AND CONTINUOUS-CURRENT SETTINGS.

TO GROUNDING ELECTRODE SYSTEM, SEE DETAIL 6/E6.04

EQUIPMENT MARKING SHALL BE PROVIDED FOR ALL ELECTRICAL EQUIPMENT PER CEC 110.21.

ELECTRONAL COMPANY FOR CE: TILCZ:

2022 CALIFERINE REPREY CODE:

VOCACE BROP FROM SERVICE PRINT TO LOAD TO NOT

5. FIRE PRIMP AND HOUSE MEERS TO HAVE TIST—
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AUTHORISM AND INSTALL ARC—PLASH HAZARD MARKINGS

WET THE REQUIREMENTS OF 10.24(8) AND SHALL BE
CLEARLY WISHEST TO CHALLED FRESCH SEPTIME

ELEMANTON, AUJUSTINENY, ZENYONG, OF

MANTEDWAKE OF THE COMPANY.

2 LOCKABLE SOLAR DISCONNECT SWITCH, PROVIDED BY ELECTRICAL CONTRACTOR WITH CONDUIT ROUTED TO ROOF.

FLAG NOTES:

SHEET NOTES:

CONTINUOS—CUMENT SETIMOS.

7, CEZ 2022 - 1016(®): SERVICE EGUIPMENT TO HAVE A PERMANENT LABEL (FIELD OR FACTORY) WITH THE FOLLOMEN THROUGH OF ACTORY) WITH THE CALLOMENT AT THE SERVICE COPD THE CLEANING THROUGH OF SERVICE COPD METER AVAILABLE CUMENT.

THE ONLY THE LABEL MAY APPLIED.

CEC 2022: 240.67: ARC ENERGY REDUCTION: WHERE CIRCUIT BREAKERS OR FUSES RATED 1200A OR HIGHER, PROVIDE DOCUMENTATION AND GLEARING TIME METHOD PER 240.67(B).

SHEET NO. E0.1

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ENERGY CODE COMPLIANCE SHEETS
SCALE: NONE

EMERALD CITY

YNNWOOD, WA 98096 25-741-1200

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A MA/A/2 BRUDA RESIDUTA

DP VENTURES
2290 DE IA CRIZ BLVD
SANTA CLARA, CA 95050



DESIGNED:
SMD
ISSUANCE:
PLANNING SET
DATE:
06/24/25
SHEET TITLE:
ENERGY CODE

SHEET NO.

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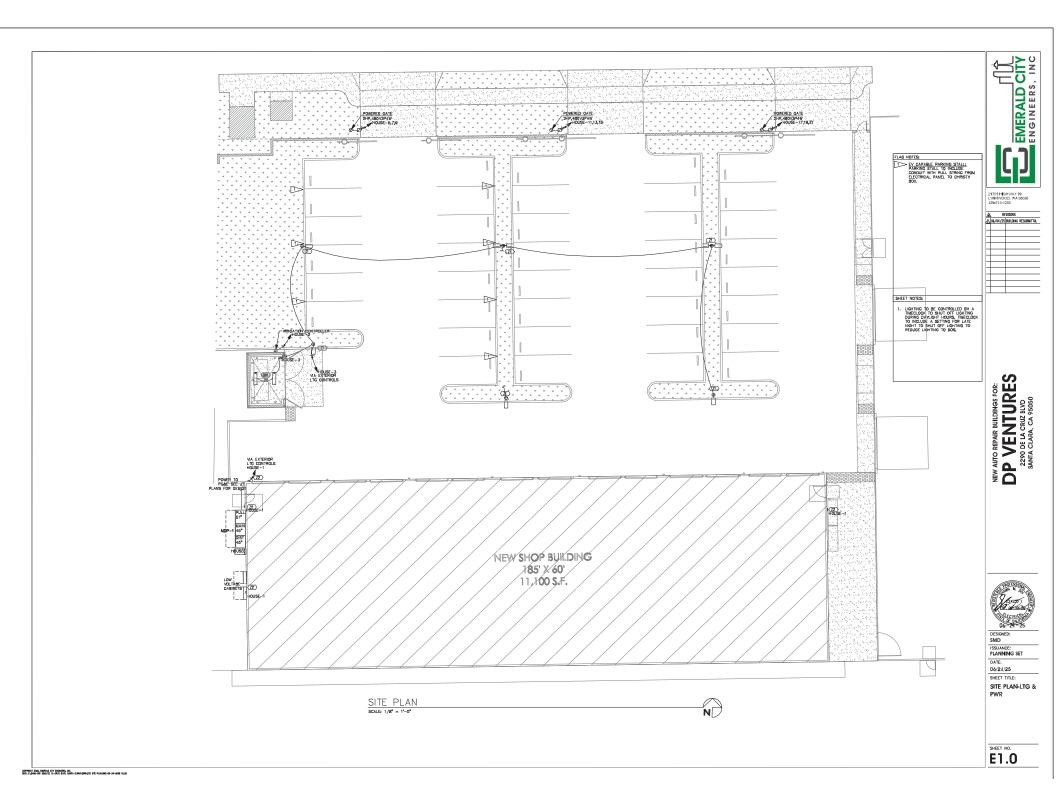
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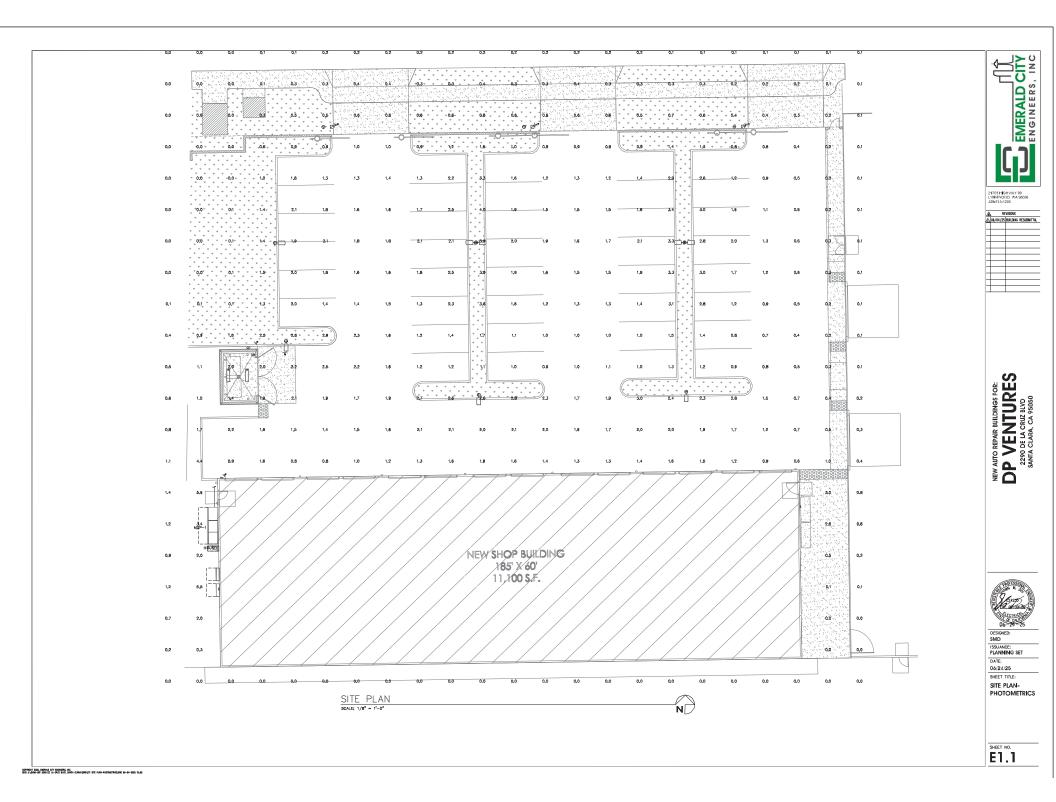
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ENGINEERS, INC

DESIGNED: SMD ISSUANCE: PLANNING SET DATE: 06/24/25 SHEET TITLE: ENERGY CODE

SHEET NO. E0.3





GENERAL NOTES

GENERAL NOTES - MECHANICAL

- CODES: COMPLETE INSTALLATION OF THE MECHANICAL SYSTEM SHALL BE PER THE APPLICABLE BUILDING, MECHANICAL, ENERGY, PLUMBING, FIRE, AND HEALTH CODES AND REGULATIONS AS ADOPTED BY THE LOCAL ARJ.
- PLUMBING CONTRACTOR SHALL LOCATE AND COORDINATE EXACT LOCATION OF ALL PLUMBING EQUIPMENT WITHIN THE STRUCTURE.
- LIGHT FIXTURE CLEARANCE: COORDINATE LOCATIONS OF MECHANICAL WORK TO PROVIDE CLEARANCES OVER LIGHTING FIXTURES FOR REMOVAL AND REPLACEMENT.
- CABLE TRAYS: DUCTWORK AND PIPING INSTALLED ADJACENT TO ELECTRICAL DABLE TRAYS SHALL ALLOW MINIMUM ACCESS OF 6" ABOVE AND TO THE SIDE OF CABLE TRAYS.

COORDINATION REQUIREMENTS

- PIPING: COORDINATE WITH STRUCTURAL FOR EXACT LOCATION OF ALL STRUCTURAL FRAMING AND FOOTINGS AND FINALIZE THE EXACT ROUTING OF ALL PIPES WITH STRUCTURAL AND AT THE SITE PRIOR AND DURING THE CONSTRUCTION.
- ADJUSTMENTS: ALL EQUIPMENT, MOTORS, FANS GAS BURNERS, IGNITION DEVICES, DRIVES, ETC. SHALL BE ADJUSTED AND BALANCED TO OPERATE AT SPECIFIED RATINGS AS REQUIRED FOR THIS PROJECT SITE AND ACCOUNTING FOR ELEVATION ABOVE SEA LEVEL.
- APPROVALS: MECHANICAL AND PLAMBING EQUIPMENT SHALL BE APPROVED FOR INSTALLATION IN THE PROJECT LOCATION AND SHALL HARA ALL CERTIFICATIONS AND ATMINGS TO MEET LLL ENERCY, POLLUTION, ENVIRONMENTAL, SEISMIC, ETC. CODES AND REQUILATIONS. THE CONTRACTOR SHALL COORDINATE WITH HIS MAINFACTURE SUPPLIERS AND SHALL INCLUDE ALL COSTS REQUIRED TO MEET THESE RECOMPREMENTS IN HIS BID.

PLUMBING NOTES

- 1. CONSTRUCT PURPOR PLAYER CONSTRUCTORS TO BILLDANG
 WHITE LAST COLD WATER, AND HOT WATER SYSTEM IN ADDRESSE
 WHITE DRAWNES, MANUFACTURER'S RECOMMENDATIONS, AND LOCAL
 CODES, CONNECT TO EACH TRUTHE, EQUIPMENT, ETC. WITH ALL
 CODES, CONNECT TO EACH TRUTH, EQUIPMENT, ETC. WITH ALL
 AS REQUIRED AND AS RECOMMENDED BY THE MANUFACTURERS. REFER
 TO PULLMEN POTURE CONNECTION SCIENCE ON PLAYS.
- HOT AND COLD: WATER PIPING CONNECTION TO EACH FIXTURE SHALL BE COLD WATER ON THE RIGHT HAND SIDE AND HOT WATER ON THE LEFT HAND SIDE.
- SHUT-OFFS: PROVIDE SHUT-OFF VALVES/STOPS AT HOT AND COLD WATER SUPPLY TO EACH FIXTURE.
- TRAP ARMS; PROVIDE TRAP ARMS SUCH THAT THE MAXIMUM LENGTH WILL NOT EXCEED CODE REQUIREMENTS.
- ADA INSULATION: AT PLIMBING PIPING EXPOSED UNDER LAVATORIES, INSULATE THE EXPOSED PIPING AND TRAPS WITH PRODUCT SPECIFICALLY DESIGNED FOR THIS APPLICATION MEETING ADA REQUIREMENTS. PROVIDE HANDIL-LAV GUARD OR EQUIVALENT. OFFSET P-TRAPS TO CLEAR WHEELCHAIR ACCESS.
- 6. WATER HAMMER ARRESTERS: PROVIDE AT THE END OF HOT AND COLD WATER LINES SERVING TWO OR WOKE FIXTURES, SIZE IN ACCORDANCE WITH PLUMBING AND DRAINAGE WISTUTIC (PD) REQUIREMENTS. WATER HAMMER ARRESTORS ARE REQUIRED FOR QUICK CLOSING VALVES, SUCH AS LAUMORY WASHERS, LUSH VALVES (POPULC TOLLET), ETC.
- TRAP PRIMERS: PROVIDE TRAP PRIMERS AND PIPNG FOR FLOOR DRAINS AND FLOOR SINKS, ARRANGE PIPING TO ACHIEVE EQUAL FLOW TO EACH DRAIN AND FLOOR SINK FOR TRAP PRIMERS SERVING MULTIPLE DRAINS AND FLOOR SINKS.
- B. CLANDUTS: PROVIDE CLEANDUTS PER CURRENT OPC AND AS REQUIRED BY LOCAL JARSOSCHOKE, SIGN HORIZONTAL DERBASEC PRES SHALL BY LOCAL JARSOSCHOKE, SIGN HORIZONTAL DERBASEC PRES SHALL BER HORIZONTAL DERBASEC DEBENDAN AN ADMITTANT IS MORE THAN 100 FEET OF TOTAL DERECAPED LIBERTON AN ADMITTANT OLD ADMITTANT OF THE STATE OF THE CAPA PROVIDE IN DERBANGE LINES FOR EACH ADRIEGATION CHANGE OF DIRECTION EXCEDING CONFERENT COSC. CLEANDUT, UP TO SHALL BE THE SMAKE SIZE AS THE PRIME STREND BY THE CLEANDUT, UP TO 4 MOILES. NOTE ON THE ADMITTANT OF STREND THE CLEANDUT, UP TO 4 MOILES. NOTE ON THE ADMITTANT OF STREND THE CLEANDUT, UP TO THE PROVINCE ORDINARY.

PIPING NOTES

- DISASSEMBLY PROVISIONS: PROVIDE UNIONS OR FLANCES AT PIPING CONNECTIONS TO EQUIPMENT, COILS, TRAPS, CONTROL VALVES, AND OTHER COMPONENTS TO ALLOW DISASSEMBLY FOR MAINTENANCE.
- 3. DIELECTRIC UNIONS: PROVIDE AT CONNECTIONS OF DISSIMILAR PIPE,
- CONDENSATE DRAIN; PROVIDE A P-TRAP FOR EACH HVAC UNIT CONDENSATE PAN WITH PLUG TEES FOR CLEANING.

DRAWNGS ARE DIAGRAMMATIC, SHOWING THE CENERAL LOCATION, TYPE, LAYOUT, AND EQUIPMENT REQUIRED, THE DRAWNGS SHALL MACRITICINES, DRAWNGS FOR COMMISSION REPORT OF MANUFACTURER'S STANDARD INSTALLATION ROAMNOS FOR EQUIPMENT COMPETIONS AND INSTALLATION ROAMNOS FOR EQUIPMENT COMPETIONS AND INSTALLATION ROUMERENTS, PROVIDE DUCTWORK, COMMETTIONS, ACCESSIVES, OFFSETS, AND MATERIALS DECESSARY FOR A COMMETTE STSTEM.

TEST	ING AND ACCEPTANCE CRITERIA
DOMESTIC HOT AND COLD WATER	THE SYSTEM SHALL BE TESTED WITH WATER OR AIR. THE TEST PRESSURE SHALL BE GREATER THAN OR EQUAL TO THE WORKING PRESSURE UNDER WHICH THE SYSTEM IS TO BE USED, AIR (F USED) SHALL HAVE A MINIMUM PRESSURE OF 50 PSG. THE PIPMS SYSTEM SHALL WITHSTAND THE TEST PRESSURE WITHOUT SHOWING EVIDENCE OF ELEKAGE FOR NOT LESS THAN 15 MINUTES, BASED ON CO. 6094.
SANITARY WASTE AND VENT	THE WATER TEST SHALL BE APPLIED TO THE DRAMAGE AND WATT SYSTEMS STITMEN ITHEN THE ENTERTY OR IN SECTIONS, EACH OPENING SHALL BE TRUTH, PLUDGED, EXCEPT FOR THE HIGHEST OPENING OF MITH HE SECTION LINDER THE TEST AND EACH SECTION SHALL BE FILLED, WITH THE SCHOOL WATER THE WATER SHALL BE KEPT IN THE SYSTEM, OR IN THE POPRION WADER TEST FOR NOT LESS THAM 15 MANUTES, BASED ON DPC 71.2.2.

APPLICABLE CODES

-2022 CALIFORNIA BUILDING CODE -2022 CALIFORNIA MECHANICAL CODE -2022 CALIFORNIA PLUMBING CODE -2022 CALIFORNIA NON-RESIDENTIAL ENERGY CODE

PIPE MATERIALS

- 1 WATER SLIPPLY PIPING: COPPER PEY OR CPVC
- 2. BELOWGROUND WASTE AND VENT PIPING: CAST IRON, PVC, DR ABS
- 3. ABOVEGROUND WASTE AND VENT PIPING: CAST IRON, PVC, OR ABS

CALGREEN REQUIREMENTS

INDOOR WATER US	E FLOWRATES
FIXTURE TYPE	NAXIMUM FLOW RATE
WATER CLOSETS - FLUSHOMETER VALVE	
WATER CLOSETS - TANK	1.28 GAL/FLUSH
URINALS	0,125 GAL/FLUSH
PUBLIC LAVATORY	0.5 GPM 60 60 PSI
PRIVATE LAVATORY	1.2 GPM 60 60 PSI
KITCHEN FAUCETS	1.8 GPM @ 60 PSI
SHOWERHEADS	1.8 GPM @ 80 PSI

LEGEND



CD	CONDENSATE DRAIN
D	DIAMETER
DN	DOWN
FLEC	ELECTRIC
ELEC	EXTERIOR, EXTERNAL
	FLOOR DRAIN
FU	FAN COIL UNIT
FCU	FAN COIL UNII
FLR	HORSEPOWER
HP	
HVAC	HEATING, VENTILATING, AND AIR
	CONDITIONING
ID	INDIRECT DRAIN, INSIDE DIAMETER
IN	
KW	KILOWATT
NECH	MECHANICAL
NCA	MINIMUM CIRCUIT AMPACITY
NOCP	MAXIMUM OVER CURRENT
	PROTECTION
	MOUNTED
QD.	OUTSIDE DIMENSION OR DIAMETER
POC	POINT OF CONNECTION
PRV	PRESSURE REDUCING VALVE
PSIG	POUNDS PER SOUARE INCH GAUGE
RFF	REFERENCE
	SANITARY SEWER
SO.	SOUARE
TP	TRAP PRIMER
ΤΥΡ	TYPICAL.
LION	UNIESS OTHERWISE NOTED
v	VENT
VTR	VENT THRU ROOF
w	WASTE WATT WIDE
	MASIE, WATT, MIDE

DRAWING INDEX

DWG	DESCRIPTION
P0.0 P1.0	LEGEND, GENERAL NOTES SITE PLAN
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A REVISIONS
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P VENTURES


480 MATTHEW ST.

SANTA CLARA, CA 95050



DESIGNED: MB PLANNING SET DATE: 06/24/25 SHEET TITLE: LEGEND GENERAL NOTES

SHEET NO. PO.0

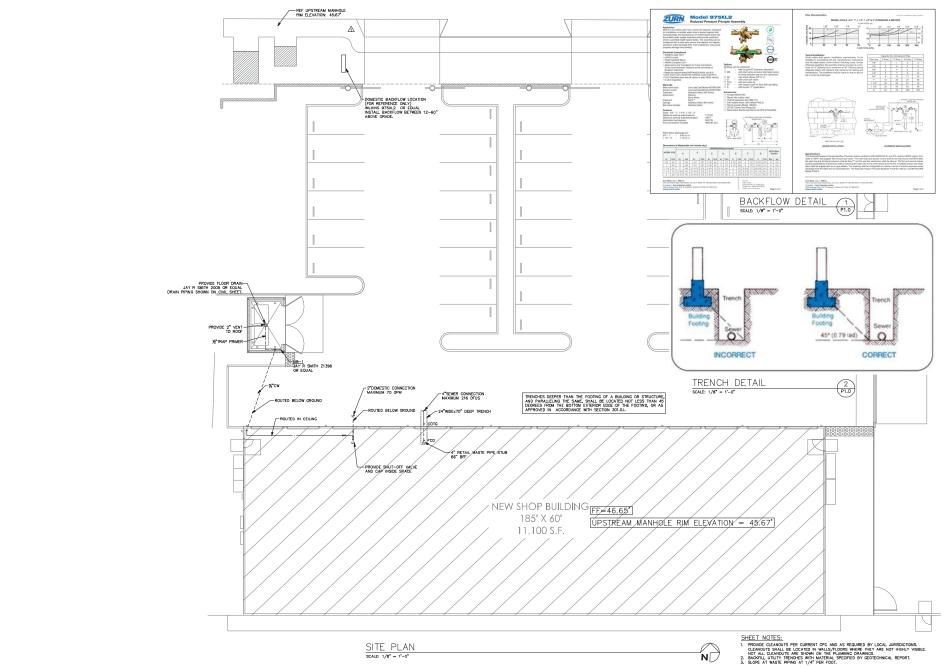

EMERALD CITY ENGINEERS, INC

21705 HIGHWAY 99 LYNNWOOD, WA 98086

A REVISIONS

| OK/ON/25 | BUILDING RESUBMITTAL

DP VENTURES

480 MATHEW ST.

SANTA CLARA, CA 95050




DESIGNED: ISSUANCE: PLANNING SET

DATE: 06/24/25 SHEET TITLE:

SITE PLAN


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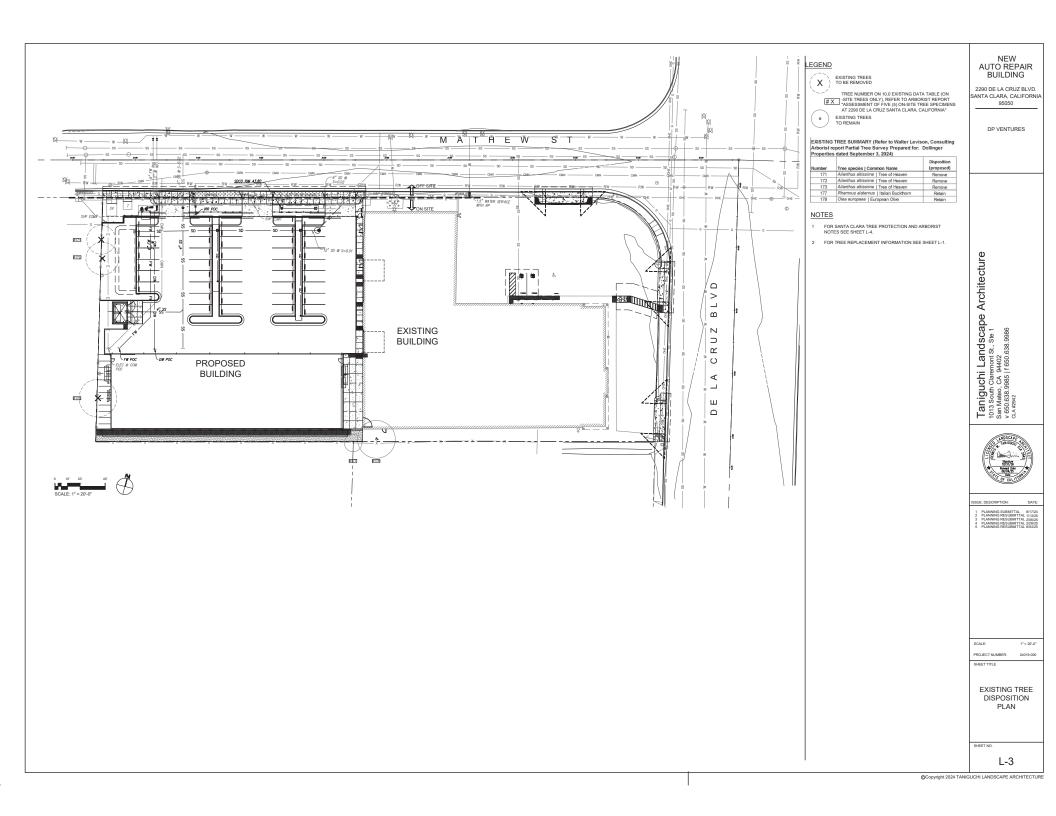


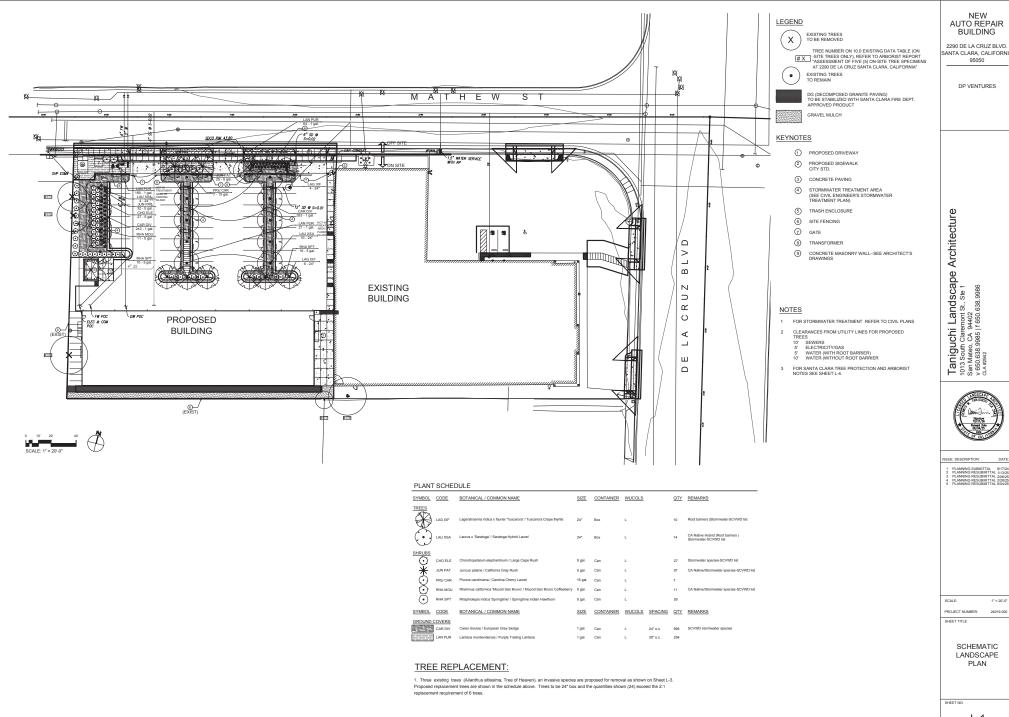
SANTA CLARA, CALIFORNIA

PROJECT NUMBER: 24019.000

L-1



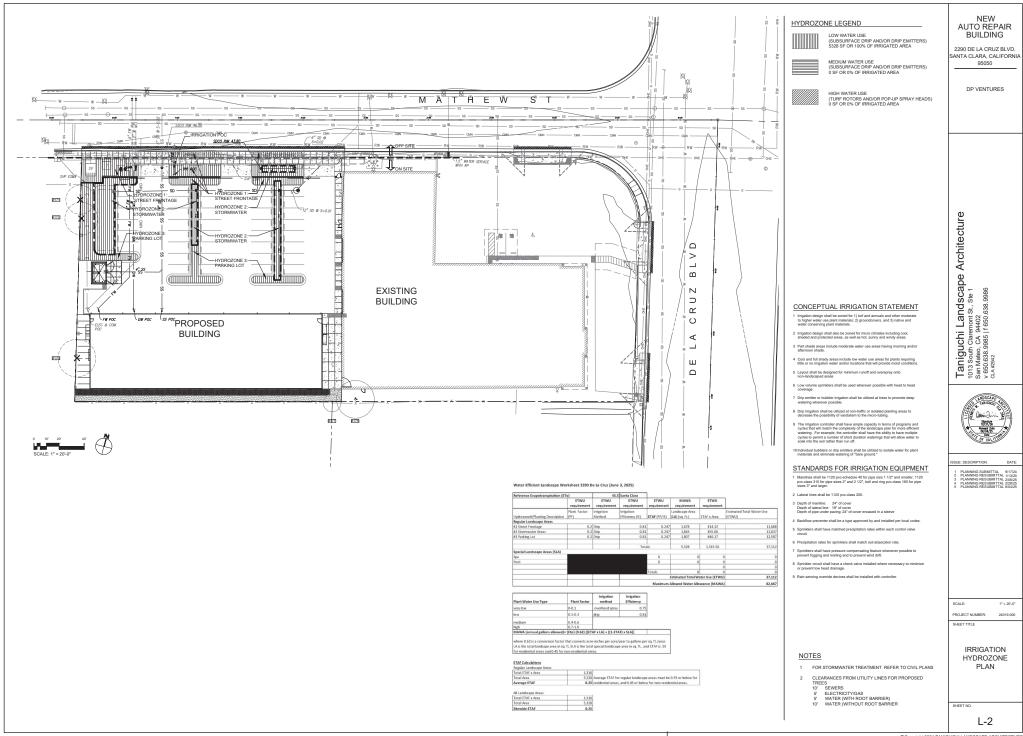

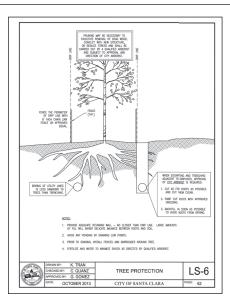



CITY OF SANTA CLARA ARBORIST NOTES

I. GENERAL

- No cutting of any part of city trees, including roots, shall be done without securing approval and direct supervision from the city arborist or arborist employed by city (408-615-3080).
- No cutting of any part of private trees, including roots, shall be done without direct supervision of an international society of arboriculture (ISA) certified arborist.
- 3. When construction occurs within the drip line of existing trees, contractor shall pile the soil on the side away from the tree. When this is not possible, place soil on plywood, tarp, or 4"s 5" thick bed of mulach. This is to belp prevent cutting into the soil surface when the backhoe or tractor blade refills the trench.
- 4. Refill open trenches quickly within hours of excavation when they occur within the drip lin of existing trees. If this is not possible and the weather is hot, dry, writely, contractor man key every or in an insole by covering them with we though. The contraction of the property or in the most by covering them with we though. The man recommendation of the property of the pro
- 5. When roots 2" or larger are required to be cut, showel by hand near the roots and prune the roots with an incustry-approved pruning tool. Roots that are accidentally broken should be pruned two incluser from the damaged end. Creabled or tora roots are more likely to allow desay to begin. Sharply cut roots produce a flush of new roots helping the tree to recover from its injury.
- Contractor shall notify thecity arborist or arborist employed by city 72 hours in advance of any work requiring digging around or within the drip line of existing trees.
- A clear system of flagging rust be provided around trees within 20' of the proposed grading. Contractor shall secure approval of such system from the city arborist or arborist employed by city.
- Materials, equipment, temporary buildings, fuels, paints and other construction items shall not be placed within the drip line of existing trees.

Page 1 of 4



CITY OF SANTA CLARA ARBORIST NOTES

9. Fence all trees to be retained to completely enclose the <u>tree protection none</u> prior to demolition, grabbing or grading. Frencing shall be placed at the drip line of cristing trees or if possible. 5 times the related of the drip line out from the truth of the tree. A warning sign shall be prominently displayed on each frence. The sign shall be a minimum of 30° 31" and clearly start warning—tree protection none that force shall not be removed without supervant from the city arborraty/project arborrist. Pences shall be 6-foot tall clear line it.

equivalent, as approved by the city arborist or arborist employed by city. Finces shall remain until all grading and construction work is completed. In addition, wap all trees with straw avadide up to the first main branch, and then waps panow freeding around the waddle on all trees in the construction zone to protect them fron bark damage caused by the work.

- 10. No trenching shall be donewithin the drip line of existing trees without the approval of the city arbeits or arboist employed by City. Open trenching in the noxione of a public tree is problisted except in cases where the trenching falls outside the drip line of the tree involved. Rougitions may be allowed if, in the opinion of the city and the content of the city of the content of the city of the content of the city and content of the city of the negligible.
- 11. Any cutting of existing roots of city trees shall be done with approved light equipme under the direct supervision of the city arborist or arborist employed by city. Any cutting of existing roots of private trees shall be done with approved equipment under the direct supervision of an ISA certified arborist.
- Grading should not create drainage problems for trees by channeling waterinto them, or creating sunken areas.
- 38. All prairies within the rêst jus of city trees shall be done with approved light squament unmet hed direc supervision of the direct periods or absorbed to employed by city. All grading within the drip lime of private trees shall be done with approved equipment under the direct supervision of an ISA excelled advoired. The original grade at the base of existing trees shall not be modified. If a grade increase is necessary, dry walls should be used.
- 14. When trenching is allowed the contractor must first cut roots with a vermeer root cutter prior to any trenching to avoid tugging or pulling of roots.
- 15. Trees that are determined to be removed by the city arborist or arborist employed by city due to an unforeseen circumstance during construction shall be replaced by the

Page 2 of 4



CITY OF SANTA CLARA ARBORIST NOTES

contractor. The city arborist or arborist employed by city shall determine to

- 16. Place 4"-5" thick mulch around all existing trees (out to their drip line) that are to be retained prior to any construction. This will help maintain moisture under the tree within the fencing area.
- 17. Bore pits are not allowed within the drip line of any tree.

II. BORING

Where there is insufficient space to bypass the drip line by trenching adjacent to all existing trees in excess of 6° D3H, the installation must be made by boring. The beginning and ending distance of the bore from the face of the tree in any direction is determined by the diameter or other tree as specified by the accompanying table:

Then the tree dia	meter at 4% feet is:	Trenching will be replaced by boring a this minimum distance from the face of the tree in any direction:		
0-2	inches	1	foot	
3-4	inches	2	feet	
6-9	inches	5	feet	
10-14	inches	10	feet	
15-19	inches	12	feet	
over 19	inches	15	feet	

Tree diameter	(minimum) depth of bore	
9 inches or less	2.5 feet	
10-14 inches	3.0 feet	
15-19 inches	3.5 feet	
20 inches or more	4.0 feet	

III.TREE PROTECTION

Contractor shall tag and identify existing trees which are to remain within the
project limits and on the public right-of-way prior to start of work. Protect all tagged
trees at all times from damage by the work. Treatment of all minor damage to tagged
trees shall be performed by an ISA certified arborist or other personnel approved by
the city arborist or arboris employed by city. It a sugged tree is personnel.

Page 3 of 4



CITY OF SANTA CLARA

disfigured or killed as a result of the work, contractor shall remove the tree, including its roots, from the site and replace each removed tree with an equal-stard reb. It such replacement to not possible, the contract of shall reimbure to the tree-owner the samount listed in the table below. The city arborist or arborist employed by give shall be the sole below for the condition of any tree. Courtestor shall provide regular watering of existing landscaping within the construction area through the construction area through the construction area through the

2. Contractor shall pay the tree owner the value of existing trees to remain that died or were damaged because of the contractor's faithure to novoide adeasate notice. You and schedule of value, using "tree adlarge" method established in the most revent issue of the "guide for establishing values of trees and other plants", prepared by the council of tree and indeedage architecture.

7 inches	\$ 2,400
8 inches	\$ 3,400
9 inches	\$ 4,400
10 inches	\$ 5,200
11 inches	\$ 6,200
12 inches	\$ 7,200
13 inches	\$ 8,200
14 inches	\$ 9,200
15 inches	\$ 10,000
16 inches	\$ 11,000
17 inches	\$ 12,000
18 inches and over	
Add for each caliper inch	\$ 1.200

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NEW AUTO REPAIR BUILDING

2290 DE LA CRUZ BLVD. SANTA CLARA, CALIFORNIA 95050

DP VENTURES

Taniguchi Landscape Architectur 1013 South Claremont St., Ste 1 San Marker, CA 94402. V 660.538, 99865 | 1 650, 638, 9986

OF CALIFOR

SUE: DESCRIPTION: D

1 PLANNING SUBMITTAL 9/17/24 2 PLANNING RESUBMITTAL 1/13/23 3 PLANNING RESUBMITTAL 2/06/25 4 PLANNING RESUBMITTAL 2/28/25 5 PLANNING RESUBMITTAL 6/04/25

SCALE: 1" = 20'-0"

PROJECT NUMBER: 24019.000

SHEET TITLE

SANTA CLARA TREE PROTECTION

SHEET NO.

L-4

