NOTES TO CONTRACTOR ON NEW GARAGE WALL, PROVIDE SUB-PANEL LOCATED ON NEW MASTER BEDRM. ADDITION. OVERHEAD SERVICE FEEDS FROM POWER POLE LOCATED IN REAR YARD. REMOVE EXISTING GRAVITY FURNACE, PROVIDE AND INSTALL NEW GAS FURNACE AND LOCATE IN ATTIC (80% EFFICEINCY MIN.) REMOVE EXISTING WOOD WINDOWS, PROVIDE AND INSTALL NEW WHITE VINYL LOW-E DUAL GLAZED WINDOWS AT ALL EXISTING WINDOW LOCATIONS. CONTRACTOR TO VERIFY WASTE LINE INVERT AND DETERMINE IF EITHER THE STRUCTURE SHOULD MOVE CLOSER TO THE EXISTING HOME OR REQUIRE AN WASTE LINE EJECTION PUMP. GRADING WORK WILL BE REQUIRED AT THE REAR YARD TO CREATE A LEVEL PAD, POSITIVE DRAINAGE RUN OFF, AND LEVELING OF THE SOIL WHERE PREVIOUS TREES HAD BEEN REMOVED. 7) CONTRACTOR TO PROVIDE CONCRETE BAND DRIVEWAY CONTRACTOR TO FACILITATE REMOVAL OF TERMITE DAMAGED WOOD PER TERMITE REPORTS RECOMMENDATIONS. **GENERAL NOTES** THE WORK PROVIDED BY THE GENERAL CONTRACTOR SHALL CONSIST OF ALL LABOR, MATERIAL, TRANSPORTATION, TOOLS AND EQUIPMENT NECESSARY FOR THE CONSTRUCTION OF THE PROJECT, LEAVING ALL WORK

①

- ORDINANCES. THE GENERAL EXTENT OF CONSTRUCTION NECESSAR FOR THE PLANS INDICATE THE GENERAL EXTENT OF CONSTRUCTION HECESSAR FOR THE WORK, BUT NOT INTERCED TO BE ALL INCLUSIVES ALL WORK. FOR THE PLANS INTERCED THE PLANS INTE
- THE GENERAL CONTRACTOR SHALL VERIEY AND ASSUME RESPONSIBILITY FOR ALL DIMENSION AND SITE CONDITIONS. EACH SUB-CONTRACTOR SHALL INSPECT AND TAKE NOTE OF EXISTING CONDITIONS PRIOR TO SUBMITTING FINAL PRICES NO CLAIM SHALL BE ALLOWED FOR DIFFICULTIES SUBMITTING FINAL PRICES. NO CLAIM SHALL BE ALLOWED FOR DIFFICULTIES SUBMITTING FINAL PRICES. NO CLAIM SHALL BE ALLOWED FOR DIFFICULTIES SUBMITTING FINAL PRICES.
- PROTECT ALL FINISHES WHERE THEY CONTACT THE WORK OF OTHER TRADES AND WHEN WET WHEATHER IS ANTICIPATED.
- THE GENERAL CONTRACTOR SHALL REMOVE ALL RUBBISH AND WASTE MATERIALS ON A REQULAR BASIS AND SHALL EXERCISE STRICT CONTROL OVER JOB CLEANING TO PREVENT DIRT OR DEBRIS FROM AFFECTING FINISHED AREAS IN OR OUTSIDE THE JOB.

SHEET INDEX

A0.00 SITE PLAN, PROJECT DATA, GENERAL NOTES, VICINITY MAP, CONTRACTOR NOTES

- A0.01 NEIGHBORHOOD PLAN
- A1.00 PROPOSED SITE PLAN. EXISTING FLOOR PLAN. NOTES A2.00 CONSTRUCTION PLANS, SYMBOL LEGEND
- AS 00 AREA LINE DIAGRAMS
- A4.01 PROPOSED ELEVATIONS

CODES

All work shall be in accordance with the following codes:

2022 CBC, 2022 CRC, 2022 CMC, 2022 CPC, 2022 CEC AND 2022 CGBC ARE APPLICABLE TO THIS PROJECT. SCOPE OF WORK

560 SF ADDITION TO 1ST FLOOR AND 2ND FLOOR ABOVE ADDITION AREA FOR JR. ADU (403 SF). NEW EGRESS WINDOW IN PRIMARY SUITE. NEW LAUNDRY ROOM UNDER STAIR.



KEY NOTES

- NEW GUTTER AND DOWNSPOUTS, DIRECT ALL WATER AWAY
 FROM BUILDING
- FROM BULDIMS.

 SY, LOT DRAINAGE AWAY FROM BUILDING FOR A MIN. OF 10'.
 IF PHYSICAL OBSTRUCTIONS OR LOT LINES PROHIBIT 10'
 DISTANCE, A 5% SLOPE SHALL BE PROVIDED TO AN
 APPROVED ALTERNATE METHOD. SWALES USED FOR THIS
 PURPOSE SHALL BE SLOPED A MIN. OF 2%.
- (E) 200 AMP ELECTRICAL MAIN PANEL ON DETACHED GARAGE.
- ROOF VENTS PER VENTILATION CALCULATION, REFER TO SHEET A-1, DISTRIBUTE EQUALLY.


- (9) (E) GAS METER NO CHANGE
- (E) UTILITY POLE AND OVERHEAD ELECT. SERVICE (E) 24" WIDE CONCRETE TURF PAVER BANDS TO REAR YARD.
- (E) ELECTRICAL SUB-PANEL
- (3) CONTRACTOR TO ENSURE THAT NO EAVES OR RAKE PROJECTIONS ARE IN THE 5 FOOT SETBACK AREA. (4) ALL EXISTING WINDOWS TO BE REMOVED AND REPLACED WITH NEW VINYL WINDOWS.
- (15) (E) CONCRETE TURF PAVERS AT PARKING SPACE (B) EXISTING ROOF AREA TO BE REMOVED, REFER TO FLOOR PLAN FOR WALL LOCATION.
- (17) EXISTING WATER METER
- (B) (E) CURB CUT W CITY STND. CURB. GUTTER. & SIDEWALK

PROJECT DATA

555 SF

403 SF

963 SF

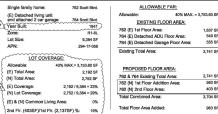


EXISTING: 3 BEDROOMS / 2 BATHROOMS PROPOSED: 4 BEDROOMS / 2 BATHROOMS / 1 BEDROOM JR. ADU

AUTOMATIC IRRIGATION SYSTEM CONTROLLERS FOR LANDSCAPING PROVIDED BY THE BUILDER AND INSTALLED AT THE TIME OF FINAL INSPECTION SHALL COMPLY WITH THE FOLLOWING:

CONTROLLERS SHALL BE WEATHER: OR SOIL MOISTURE-BASED CONTROLLERS THAT AUTOMATICALLY
ADJUST IRRIGATION IN RESPONSE TO CHANGES IN PLANTS' NEEDS AS WEATHER CONDITIONS CHANGE.

2. WEATHER-BASED CONTROLLERS WITHOUT INTEGRAL RAIN SENSORS OR COMMUNICATION SYSTEMS 2. WEATHER BASED CONTROLLER WINDLINESTING FOR STREAMS OF MINISTERS RAIN SENSOR WHICH THAT ACCOUNT FOR LOCAL RAINFALL SHALL HAVE A SEPARATE WIRED OR MIRELESS RAIN SENSOR WHICH CONNECTS OR COMMUNICATES WITH THE CONTROLLER(S), SOIL MOISTURE-BASED CONTROLLERS ARE NOT REQUIRED TO HAVE RAIN SENSOR INPUT.

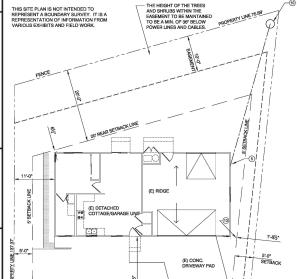

PLANTING AREA

7-

PLANTING

AREA

(E) 5:12 ROOF PITCH

 \Box

1'-0"

4'-0"

PLANTING AREA

20' FRONT SETBACK LINE

DRIVEWAY

Leopold Vandeneynde,

S

GILROY,

LINDA VISTA LANE,

Design

Leopold

MCLAIN BROWN SANTA CLARA,

2'-0" EASEMENT

NEIGHBORING PLANTING AREA

PLANTING NOT TO EXCEED

3'-0" IN HEIGHT WITHIN THE

APROACH

SCALE: 1/8" = 1'-0"

STREET

LIGHT

MODIFICATIONS TO THE HOME OF: SEAN

BLVD., SCOTT 762

SITE / ROOF PLAN
NOTES TO CONTRA
EXISTING DEMO. FLI
PROJECT DATA
VICINITY MAP JOB NO. DRAWN BY 762 - 24 LEOPOLD DATE:

SEPT. 10, 2024 REVISIONS PLANNING DEPT. 10/14/24 Λ

SHEET NO.

A0.00



CONTACT LIST

ARCHITECT: LEOPOLD VANDENEYNDE. LEOPOLD DESIGN 9260 LINDA VISTA LN., GILROY, CA. 95020

STRUCTURAL ENGINEER: MOSES HAENG
MHA CONSULTING ENGINEERS
1823 WRIGHT AVE.,SUNNYVALE, CA 94087
projects@mhaeng.com, 341-758-2666

OWNER: SEAN MCLAIN BROWN, 782 SCOTT BLVD., SANTA CLARA, CA, 95050 seanmclainbrown@gmail.com, 415-577-1510

ENERGY CONSULTANT: MICHAEL KLINZ NSULTANT: MICH VILLE TITLE-24 EXPRESS P.O. Box 587, Blue Lake, CA 955525

WORKING HOURS (8-5 M-F, 9-4 SAT, NO WORK ON SUNDAYS OR HOLIDAYS).

CITY NOTES

- APPLICATIONS FOR WHICH NO PERMIT IS ISSUED WITH 180 DAYS FOLLOWING THE DATE OF APPLICATION SHALL AUTOMATICALLY EXPIRE. PER CRC R105.3.2.
- EVERY PERMIT ISSUED SHALL BECOME INVALID UNLESS WORK AUTHORIZED IS COMMENCED WITHIN 160 DAYS OR F THE WORK AUTHORIZED IS SUSPENDED OR ADMANDON FOR FERDON OF 160 DAYS, A SUCCESSFUL INSPECTION ON FOR EXTENSION AND ON EXTENSION FERDON FOR PERMIT IS DEPENDED FOR THE PERMIT AND GRANTED BY THE FOR EXTENSION AND ON EXTENSION FERDON FOR PERMIT IS DEPENDED FOR THE PERMIT AND GRANTED BY THE BULDING OFFICIAL. NO MORE THAN ONE EXTENSION MAY BE GRANTED, PERMITS WHICH HAVE BECOME INVALID SHALL PAY A REACH THAT OFFI EXTENSION FOR THE ORIGINAL PERMIT EXEMINATION FEED FOR FOR POSSION FOR THE ORIGINAL PERMIT EXEMINATION FEED FOR THE ORIGINAL PERMIT EXEMINATION FEED FOR THE ORIGINAL PERMIT FEED MOUNT HAVE BEEN THE PERMIT IN ADMINISTRATION FEED FOR THE ORIGINAL PERMIT FEED MOUNT HAVE BEEN THE PERMIT HAS BEEN EXPRESSED FOR A PERMIT OF THE ORIGINAL PERMIT FEED FOR THE ORIGINAL PERMIT FEED FEED FOR THE ORIGINAL PERMIT FEED
- ALL CONSTRUCTION SHALL COMPLY WITH THE 2022 EDITIONS OF THE CALIFORNIA RESIDENTIAL CODE, CALIFORNIA BUILDING CODE, CALIFORNIA ELECTRICAL CODE, CALIFORNIA MECHANICAL CODE, CALIFORNIA PLUMBING CODE, CALIFORNIA PIEC CODE AND 2022 CALIFORNIA BENERGY CODE.

STORMWATER DRAINAGE PLAN

EROSION CONTROL (KEEPING THE DIRT IN PLACE) MINIMIZING THE IMPACT OF

- 9. INSPECT AND MAINTAIN CONTROLS

6X6 CLEAR SPACE FOR JURISDICTIONAL APPROVAL STAMPS

. MINIMIZE DISTURBED AREA AND PROTECT NATURAL FEATURES AND SCIL.

PHASE CONSTRUCTION ACTIVITY CONTROL STORMWATER FLOWING ONTO AND THROUGH THE PROJECT.
 STABILIZE SOILS PROMPTLY.

S. PROTECT STORM DRAIN NUETS.

6. ESTABLISH PERMITER CONTROLS

7. RETAN SEQUENT TO SETE AND CONTROL DEWATERING PRACTICES.

8. ESTABLISH STABLIZED CONSTRUCTION EXTS.

8. ESTABLISH STABLIZED CONSTRUCTION EXTS.

EXISTING SITE/ROOF PLAN

PLANTING AREA

(E) SIDEWALK



Leopold Vandeneynde, A.I.A.

9260 LINDA VISTA LANE, GILROY, CA 95020 Leopold Design

SEAN MCLAIN BROWN 762 SCOTT BLVD., SANTA CLARA, CA MODIFICATIONS TO THE HOME OF:

JOB NO. DRAWN BY 762 - 24 LEOPOLD JOB NO.


DATE: SEPT. 10, 2024


REVISIONS

SHEET NO.

SCALE: 1/8" = 1'-0"

A0.01

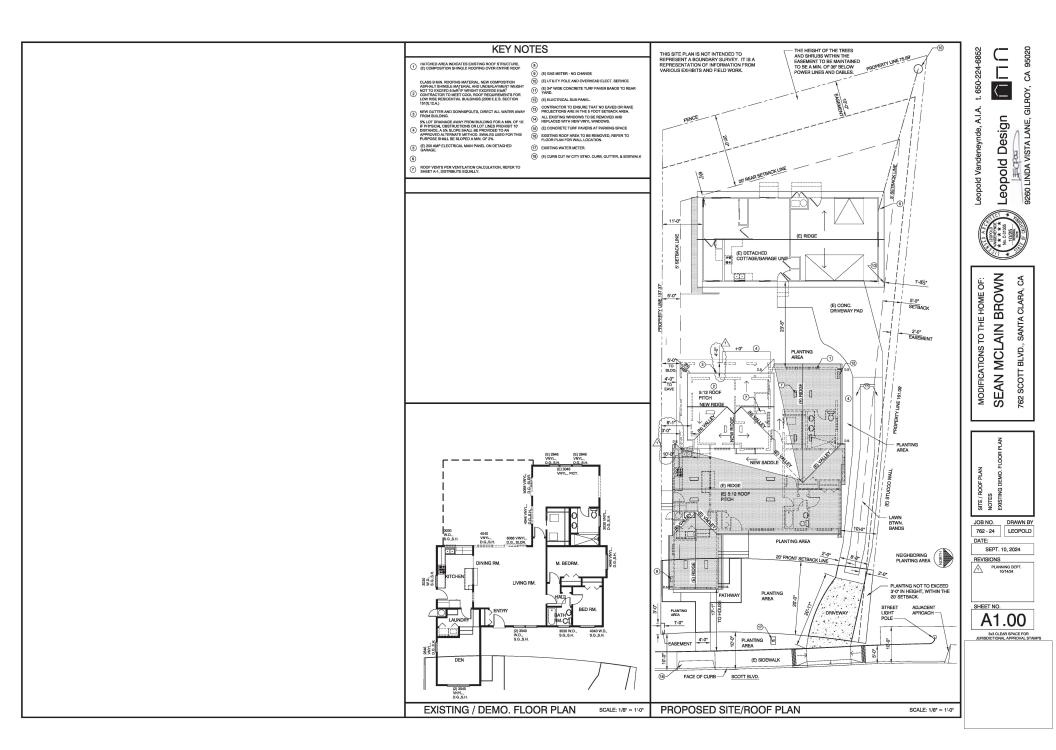

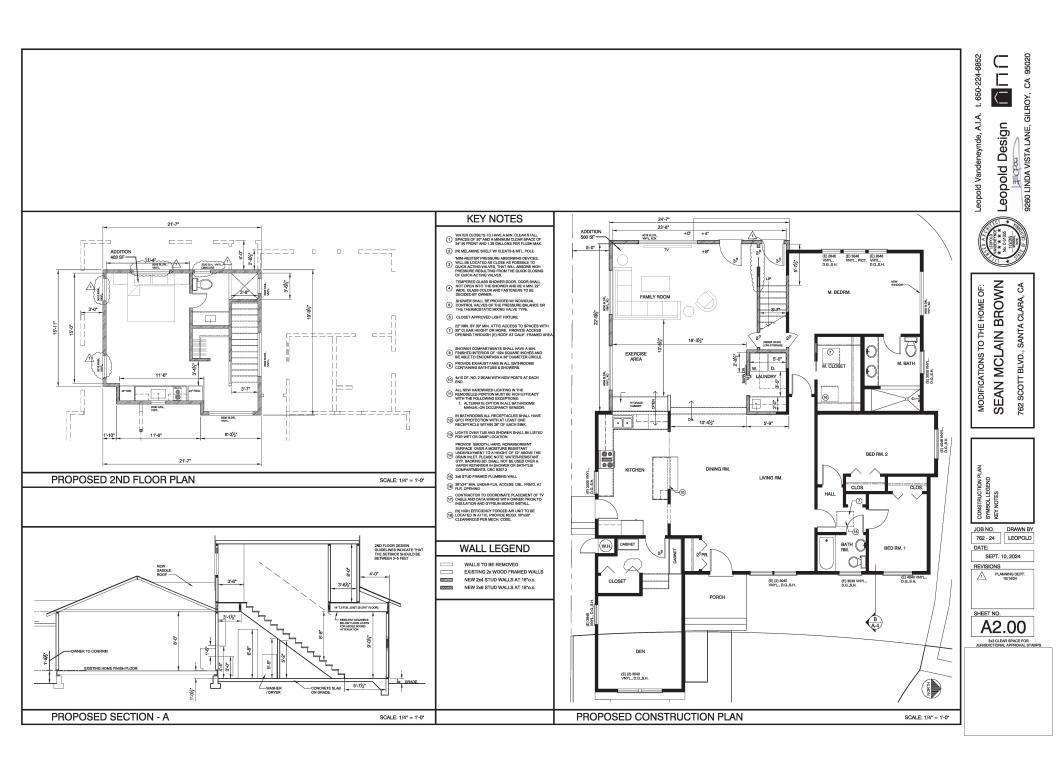




SEAN MCLAIN BROWN 762 SCOTT BLVD., SANTA CLARA, CA MODIFICATIONS TO THE HOME OF:



JOB NO. DRAWN BY 762 - 24 LEOPOLD SEPT. 10, 2024

SHEET NO. A3.00

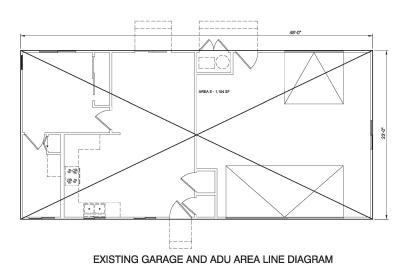


Existing Areas (Garage & House)	
A	196
В	1,019
С	9
D	413
E	1,104
TOTAL	2,741


Addition Areas

F	32
G	528
Н	344
ı	47
J	12
TOTAL	963

Combined Areas	
Existing	2,741
Addition	963
TOTAL	3,704

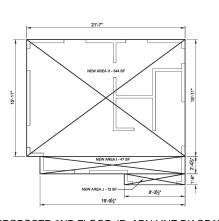


PROPOSED 2ND FLOOR JR. ADU LINE DIAGRAM

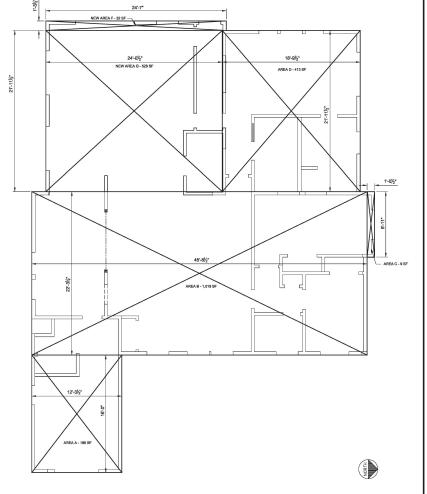

PROPOSED 1ST FLOOR AREA LINE DIAGRAM

SCALE: 1/4" = 1'-0"



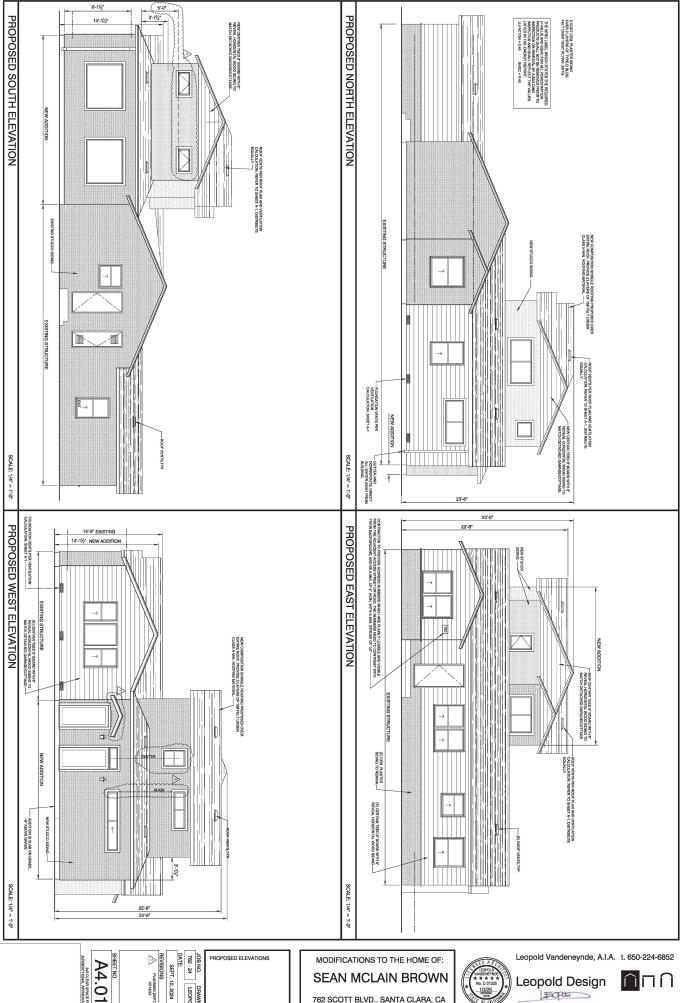

DATE: SEPT. 10, 2024 JOB NO. DRAWN BY
762 - 24 LEOPOLD REVISIONS
PLANNING DEPT.
10/14/24 A4.01

762 SCOTT BLVD., SANTA CLARA, CA

