SHEET NO. SHEET REF. DESCRIPTION T-1 TITLE SHEET 1 2 GN-1 **GENERAL NOTES** 

KEY MAP / PROJECT CONTROL 3-7 KM-1 TO KM-5

L-1 TO L-19 LAYOUT PLAN 8-26

27 WPC-1 CONSTRUCTION BEST MANAGEMENT PRACTICES (BMPS)

28-47 PD-1 TO PD-20 SIGNING AND STRIPING PLAN



CENTRAL ANGLE DIAMETER AB AC AP BC BEG AGGREGATE BASE ASPHALT CONCRETE ANGLE POINT CENTERLINE € C&G CURB & GUTTER CONC CONT CSC DIA DWG CONCRETE

CITY OF SANTA CLARA DIAMETER

FASTING (E) FC FG EXISTING FINISH GRADE FIRE HYDRANT

FH FO HMA IRR HOT MIX ASPHALT IRRIGATION JOINT TRENCH LENGTH

L LG Lt LIP OF GUTTER MILL AND OVERLAY MIN MINIMUM MODIFIED NORTHING

NOT TO SCALE NUMBER NO. O.C. OG OHE PCC ON CENTER ORIGINAL GROUND OVERHEAD ELECTRIC

PORTLAND CEMENT CONCRETE POINT OF COMPOUND CURVE PROTECT IN PLACE PLASTIC

PL POB POC POINT OF BEGINNING POINT ON CURVE POE PVMT POINT OF ENDING PAVEMENT QUALIFIED STORMWATER OSP

POLLUTION PREVENTION PLAN PRACTITIONER

REM

RHMA RUBBERIZED HOT MIX ASPHALT RECTANGULAR RAPID-FLASHING BEACON

Rt RCP REINFORCED CONCRETE PIPE RIGHT-OF-WAY STORM DRAIN

R/W SD SDMH STORM DRAIN MANHOLE SANITARY SEWER
SANITARY SEWER MANHOLE SS SSMH

STD STANDARD TANGENT

T TP TYP TOP OF PAVEMENT TYPICAL VAR VARIES VCP VTA


VITRIFIED CLAY PIPE VALLEY TRANSPORTATION AUTHORITY


WELDED STEEL WATER VALVE

1730 N. FIRST STREET SUITE 600 SAN JOSE, CA 95112 408-467-9194 408-467-9100 (FAX)





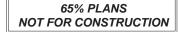


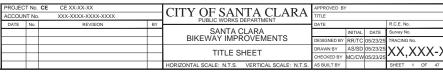



# PUBLIC WORKS DEPARTMENT

# SANTA CLARA BIKEWAY IMPROVEMENTS

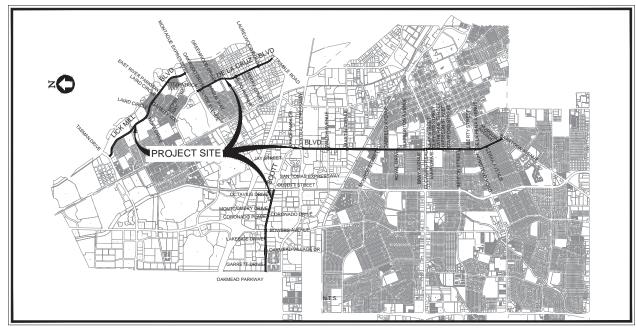

LOCATION MAP



VICINITY MAP

#### ACCEPTANCE OF PLANS:

THE CITY OF SANTA CLARA HERBY ACCEPTS THESE PLANS FOR CONSTRUCTION, AS BEING IN GENERAL COMPLIANCE WITH PLANS PREPARATION REQUIREMENTS OF THIS GOVERNMENT. RESPONSIBILITY FOR THE COMPLETENESS AND ACCURACY OF THE PLANS AND RELATED DESIGN RESIDES WITH THE ENGINEER AND ENGINEERING FIRM OF RECORD.

#### APPROVED FOR BIDDING:

MICHAEL JACK LIW
ASSISTANT DIRECTOR OF PUBLIC WORKS/CITY ENGINEER

#### REVIEWED BY:

WATER AND SEWER UTILITIES DEPARTMEN

STREET & AUTOMOTIVE SERV MAINTENANCE DIV

ELECTRIC DEPARTMENT

#### CERTIFICATION OF PEER REVIEW:

THE UNDERSIGNED HEREBY CERTIFIES THAT A PROFESSIONAL PEER REVIEW OF THESE PLANS AND THE REQUIRED DESIGNS WAS CONDUCTED BY ME. A PROFESSIONAL ENGINEER WITH DEVERTIES AND DEPRETRIENCE IN THE PLANS OF THE PROFESSIONAL DEPRETRIES OF THE PROFESSIONAL PROFESSIONAL PROFESSIONAL PROFESSIONAL PROFESSIONAL PROFESSIONAL PEER PROFESSIONAL PROFESSIONAL PEER PROFESS

T-1



#### GENERAL NOTES:

- STANDARD PROVISIONS AND STANDARD SPECIFICATIONS:
  ALL MATERIALS AND WORKMANSHIP SHALL BE IN ACCORDANCE WITH THE LATEST STANDARD
  PROVISIONS OF THE CITY OF SANTA CLARA AND THE 2024 CALTRANS STANDARD PLANS,
  SPECIFICATIONS, AND REVISED STANDARD PLANS (RSP), AND THE 2014 REVISION 9 CALIFORNIA
  MANUAL ON UNIFORM TRAFFIC CONTROL DEVICES (CA MUTCD).
- EXISTING UTILITIES SHOWN ARE BASED UPON RECORD INFORMATION AND ARE APPROXIMATE IN LOCATION. IT IS THE CONTRACTOR'S RESPONSIBILITY TO VERIFY THE LOCATION AND DEPTH OF ALL EXISTING UTILITIES WITH THE APPROPRIATE UTILITY AGENCIES PRIOR TO THE COMMENCEMENT OF CONSTRUCTION. CONTRACTOR SHALL REPORT POTENTIAL CONFLICTS TO THE REPRESENTATIVE PRIOR TO EXCAVATING FOR NEW FACILITIES.
- 3. CONTRACTOR SHALL NOTIFY ALL PUBLIC OR PRIVATE UTILITY OWNERS FORTY—EIGHT HOURS PRIOR TO COMMENCEMENT OF WORK ADJACENT TO THE UTILITY. CONTRACTOR SHALL CONTACT USA (UNDERGROUND SERVICE ALERT) AT 811 AT LEAST 48 HOURS PRIOR TO COMMENCING EXCAVATION WORK TO VERIFY EXISTING UNDERGROUND UTILITIES.
- 4. CONSTRUCT ALL TRENCHES AND EXCAVATIONS IN STRICT COMPLIANCE WITH THE APPLICABLE SECTIONS OF CALIFORNIA AND FEDERAL O.S.H.A. RECQUIREMENTS AND OTHER APPLICABLE SAFETY ORDINANCES. YOU BEAR FULL RESPONSIBILITY FOR TRENCH SHORING DESIGN AND INSTALLATION.
- 5. CONTRACTOR IS RESPONSIBLE FOR THE PRESERVATION AND/OR PERPETUATION OF ANY EXISTING SURVEY MONUMENTS (CURE TASS, IRON PIPES, STREET MONUMENTS, ETC.) NOTED ON THE PLANS OR FOUND DURING CONSTRUCTION PER SECTION 8771 OF THE CALIFORNIA BUSINESS AND PROFESSIONS CODE. F. A SURVEY MONUMENT HAS THE POTENTIAL OF BEING DISTURRED OR WITHIN 3 FEET OF THE WORK, THE MONUMENT HAS THE POTENTIAL OF BEING DISTURRED OR WITHIN 3 FEET OF THE WORK, THE MONUMENT BE LOCATED, REFERENCED, AND A CORNER RECORD MUST BE FILED WITH THE SANTA CLARA COUNTY SURVEYOR. AND A DUPLICATE OF THE CORNER RECORD MUST BE SUBMITTED TO THE CITY REPRESENTATIVE PRIOR TO THE START OF CONSTRUCTION, SHOULD ANY SURVEY MONUMENT BE DAMAGED OR DESTROYCED DURING CONSTRUCTION, SAND MONUMENT MUST BE RE-ESTABLISHED PER CITY STANDARD, A CORNER RECORD SHALL BE FILED WITH THE SANTA CLARA COUNTY SURVEYOR, ALONG WITH A DUPLICATE OF THE CORNER RECORD TO THE CITY REPRESENTATIVE PRIOR TO FINAL PROJECT NOTICE OF COMPLETION ISSUED BY THE DEPARTMENT OF PUBLIC WORKS, CONTRACTOR SHALL HIRE, AT CONTRACTOR'S EXPENSE, A LICENSED PROFESSIONAL WITH LENGINEER AUTHORIZED TO PRACTICE LAND SURVEYING OR LAND SURVEYOR TO PERFORM THE WORLD.
- 6. UNLESS OTHERWISE DIRECTED BY THE CITY REPRESENTATIVE IN THE FIELD: AT EACH LOCATION WHERE NEW CURB/GUTTER IS TO BE INSTALLED ON AN EXISTING STREET (DRIVEWAY INSTALLATION, DRIVEWAY ABANDONMENT, CURB RAMP INSTALLATION, CURB FACE DRAINAGE INSTALLATION, ETC.) PAVEMENT RECONSTRUCTION IS REQUIRED. AN 24-INCH WIDE BAND OF PAVEMENT MUST BE REMOVED AND REPLACED ALONG THE ENTIRE LENGTH OF CURB/GUTTER INSTALLATION. REMOVAL DEPTH (SAW CUTS REQUIRED) MUST BE TO THE BASE MATERIAL ON STREETS WITH A.C. OR P.C.C. PAVEMENT FOUR (4) INCHES OR LESS IN THICKNESS. REMOVAL DEPTH MUST BE TWO (2) INCHES MINIMUM ON STREETS WITH A.C. (GRIND) AND FOUR (4) INCHES MINIMUM ON STREETS WITH A.C. (GRIND) AND FOUR (4) INCHES MEDICAL WITH A.C. OR P.C.C. (SAW CUT) PAVEMENT THICKNESS GREATER THAN FOUR (4) INCHES REPLACE WITH A.C. OR P.C.C. (DOWELS REQUIRED) TO MATCH EXISTING PAVEMENT.
- 7. REMOVE AND REPLACE ALL SIDEWALK, CURB, AND GUITER DAWAGED AS A RESULT OF THE PROJECT TO THE NEAREST SCAFE MARK OR AS DIRECTED. INSTALLATION OF NEW SIDEWALK, CURB AND GUITER AGAINST EXISTING IMPROVEMENTS MUST HAVE A SIDEWALK CONTACT JOINT (DOWELS REQUIRED).
- GRADE BREAKS ON CURBS AND SIDEWALKS MUST BE ROUNDED OFF ON FORM WORK AND FINISHED SURFACING.
- OVERNIGHT PARKING OF CONSTRUCTION EQUIPMENT IN THE PUBLIC RIGHT-OF-WAY IS NOT PERMITTED, EXCEPT AT LOCATION(S) APPROVED IN ADVANCE BY THE CITY TRAFFIC ENGINEER.
- 10. UNLESS OTHERWISE NOTED, CLASS 2 A.B. UNDER CURB, GUTTER, AND STREET SECTIONS PAVED WITH ASPHALT CONCRETE MUST BE COMPACTED TO 95% RELATIVE COMPACTION.
- 11. NEAR COMPLETION OF THE PROJECT, CONTRACTOR SHALL REPLACE DAMAGED CURB AND GUTTER WITHIN PROJECT LIMITS AS DIRECTED BY THE CITY REPRESENTATIVE
- 12. AT ALL TIMES DURING CONSTRUCTION AND UNTIL FINAL COMPLETION AND ACCEPTANCE OF THE WORK, THE CONTRACTOR SHALL PREVENT THE FORMATION OF AN AIRBORNE DUST NUISANCE IN SUCH A MANNER THAT IT WILL CONTAIN DUST PARTICLES TO THE IMMEDIATE SUFFACE OF THE WORK. THE CONTRACTOR SHALL PERFORM SUCH TREATMENT WITHIN 2 HOURS AFTER NOTIFICATION BY THE CITY THAT AN AIRBORNE NUISANCE EXIST.
- 13. THE CONTRACTOR SHALL KEEP THE STREET AND WORK SITE CLEAN AND FREE FROM RUBBISH AND DEBRIS. THIS INCLUDES PREVENTING SPILLAGE ON HAUL ROUTES, CLEANING UP SPILLAGE, SWEEPING ALL STREETS OF MUD, DIRT AND DEBRIS THAT ARE A RESULT OF THE CONTRACTOR'S WORK, AND KEEPING THE WORK SITE IN A CLEAN AND NEAT APPEARANCE. ANY SPILLAGE ON HAUL ROUTES SHALL BE IMMEDIATELY REMOVED AND CLEANED UP.

#### LEGAL RELATIONS AND RESPONSIBILITY

- 14. STATE AND CITY LICENSES: ALL CONTRACTORS AND SUBCONTRACTORS SHALL BE LICENSED IN ACCORDANCE WITH THE LAWS OF THE STATE OF CALIFORNIA.
- 15. COMPLIANCE WITH ENVIRONMENTAL DOCUMENTS: THE CONTRACTOR SHALL COMPLY WITH THE PROVISIONS OF ALL PERMITS, LICENSES OR OTHER AUTHORIZATIONS APPLICABLE TO THE WORK WITH RESPECT TO THE ENVIRONMENTAL QUALITY ACT.

- 16. PUBLIC CONVENIENCE AND ACCESS: ALL WORK SHALL BE PLANNED AND CARRIED OUT SO THAT THERE WILL BE THE LEAST POSSIBLE INCONVENIENCE TO THE TRAVELING PUBLIC, AND TRAFIC SHALL NOT BE UNREASONABLY DELAYED, DRIVEWAY ACCESS SHALL BE MAINTAINED TO EACH PROPERTY AT ALL TIMES.
- 17. MAINTAIN TRAFFIC CONTROL DEVICES: THE CONTRACTOR SHALL INSTALL AND MAINTAIN FENCES, BARRIERS, LIGHTS AND SIGNS NEEDED TO GIVE ADEQUATE WARNING TO THE PUBLIC AT ALL TIMES, IN ACCORDANCE WITH THE CALIFORNIA MANUAL ON UNIFORM TRAFFIC CONTROL DEVICES (CA MUTCD)
- 18. REMOVE MATERIAL AND EQUIPMENT AT END OF DAY: NO MATERIAL OR EQUIPMENT SHALL BE STORED IN THE PUBLIC RICHT-OF-WAY AFTER "NORMAL WORKING HOURS". AT THE END OF EACH DAY'S WORK AND AT OTHER TIMES WHEN CONSTRUCTION OPERATIONS ARE SUSPENDED FOR ANY REASON, THE CONTRACTOR SHALL REMOVE ALL EQUIPMENT AND OTHER OBSTRUCTIONS FROM THE PUBLIC RICHT-OF-WAY.
- 19. HAZARDOUS MATERIALS AND WASTE: ALL WORK SHALL BE CONDUCTED IN A MANNER WHICH PREVENTS THE RELEASE OF HAZARDOUS WATERIALS OR HAZARDOUS WASTE TO THE SOIL OR GROUNDWATER, AND MIMIMIZES THE DISCHARGE OF HAZARDOUS MATERIALS, HAZARDOUS WASTES, POLLUTED WATER AND SEDIMENTS TO THE STORM DRAIN SYSTEM.
- 20. NOTIFY ADJACENT PROPERTIES: CONTRACTOR SHALL NOTIFY THE ADJACENT RESIDENCES AND BUSINESS IN WRITING DESCRIBING THE NATURE OF THE WORK, SCHEDULE OF THE WORK, WHEN PARKING WILL BE PROHIBITED (IF ANY). THE CITY PRIOR TO ITS DISTRIBUTION MUST APPROVE THE NOTICE. THE CONTRACTOR MUST DISTRIBUTE THE NOTICE TO THE ADJACENT RESIDENCES AND BUSINESS AT LEAST 48 HOURS PRIOR TO THE START OF THE CONSTRUCTION WORK.
- 21. STREET CLOSURE NOTHFICATION: IN THE EVENT OF A STREET CLOSURE AND DETOUR THAT IS THREE OR MORE CONSECUTIVE DAYS IN DURATION AND IS CAUSED BY THE CONTRACTOR'S OPERATIONS, THE CONTRACTOR SHALL NOTIFY THE U.S. POSTAL SERVICES CUSTOMER SERVICES MANAGER 24 HOURS PRIOR TO THE STREET CLOSURE.
- 22. PEDESTRIAN ACCESS: WHERE PRACTICABLE AS DETERMINED BY THE CITY, THE CONTRACTOR SHALL MAINTAIN PEDESTRIAN ACCESS ALONG WALKWAYS, INCLUDING PUBLIC SIDEWALKS, AT ALL TIMES. THE CITY'S PUBLIC WORKS INSPECTOR MUST APPROVE SIDEWALK CLOSURES IN ADVANCE. WALKWAYS SHALL BE REOPENED AT THE END OF EACH WORKING DAY. WELL—COMPACTED BASE ROCK MAY BE USED AS A TEMPORARY WALKING SURFACE.
- 23. SIGEWALK REPLACEMENT: SIDEWALKS SHALL BE REPLACED BY SAWCUTTING ALONG SCORE MARKS, THEN REMOVING AND REPLACING THE ENTIRE WIDTH OF THE SIDEWALK OVER 3" AGGREGATE BASE AND INSTALLING NO. 4 DOWELS (9" MINIMUM LENGTH) AT 3" ON CENTERS, PER CITY OF SANTA CLARA (CSC) STANDARD DETAIL ST-12 AND ST-17 OF THE STANDARD PROVISIONS. THE DOWELS ARE TO BE DRILLED 3" INTO THE EXISTING CURB AND REMAINING SIDEWALK AND EPOXIED IN PLACE
- 24. CONSTRUCTION WATER PERMIT: A PORTABLE HYDRANT METER (PHM) IS REQUIRED FOR THE USE OF CITY WATER. COMPLETED PHM APPLICATION AND DEPOSIT MUST BE SUBMITTED TO SCHEDULE AN APPOINTMENT FOR METER SHOP TO INSTALL THE PHM. FOR FURTHER INFORMATION, CONTACT THE CITY OF SANTA CLARA WATER & SEWER UTILLITES DEPARTMENT, LOCATED AT 1500 WARBURTON AVENUE, SANTA CLARA. THE DEPARTMENT CAN BE REACHED BY TELEPHONE AT (408) 615–2000 (SELECT OPTION #2), BY EMAIL AT WATER®SANTACLARACA.GOV, OR BY FAX AT (408) 247–0784.

#### TRAFFIC SIGNALS

- 25. WORK NEAR TRAFFIC SIGNAL, NOTIFICATION: THE CONTRACTOR SHALL NOTIFY THE CITY TRAFFIC ENGINEER 48 HOURS PRIOR TO PERFORMING ANY WORK NEAR SIGNALIZED INTERSECTION THAT IS MAINTAINED BY THE CITY TO DETERMINE IF THE SIGNAL NEEDS TO BE SWITCHED FROM AUTOMATIC TO MANUAL MODE. THIS ALSO APPLIES TO NON-EXCAVATION WORK WHERE THE CONTRACTOR'S EQUIPMENT AFFECTS THE OPERATION OF THE DETECTOR LOOPS.
- 26. TRAFFIC SIGNAL LOOP REPLACEMENT: TRAFFIC SIGNAL DETECTOR LOOPS THAT ARE DAMAGED AS A RESULT OF THE CONTRACTOR'S OPERATIONS SHALL BE REPLACED WITH NEW DETECTOR LOOPS IN ACCORDANCE WITH DOCUMENT 20286 OF THE TECHNICAL PROVISIONS. THE DETECTOR LOOP REPLACEMENT WORK SHALL BE PERFORMED BY A LOCAL QUALIFIED CONTRACTOR WITH EXPERIENCE IN THE INSTALLATION OF DETECTOR LOOPS.
- 27. TRAFFIC SIGNAL LOOP REPLACEMENT WITHIN 72 HOURS: ALL DAMAGED TRAFFIC SIGNAL DETECTION LOOPS SHALL BE REPLACED WITHIN 72 HOURS OF THEIR DAMAGE, UNLESS THE CITY GRANTS AN EXCEPTION. THIS REQUIRES PERMANENT PAVING OF TRENCHES TO BE INSTALLED PRIOR TO REPLACEMENT OF THE DETECTOR LOOPS.

#### GARBAGE COLLECTION ROUTES

28. GARBAGE ROUTE OPERATIONS: FOR ANY WORK ON OR ADJACENT TO CARBAGE AND RECYCLING COLLECTION ROUTES, THE CONTRACTOR SHALL ALLOW GARBAGE TRUCKS TO SAFELY PASS THROUGH THE CONTRACTOR'S SITE AT ALL TIMES, UNLESS AN EXCEPTION IS GRANTED BY THE CITY.

#### UNDERGROUND CONDUITS-TELECOMMUNICATIONS, ETC.

- 29. UTILITY COMPANY NAME ON LIDS OR COVERS: ALL UTILITY COMPANY VAULTS AND MANHOLES MUST HAVE THE UTILITY COMPANY'S NAME ON THE LID OR COVER.
- 30. VAULT SURFACE FINISHING AND TRAFFIC RATING: ALL BOXES AND VAULTS PLACED IN THE SIDEWALK AREA SHALL HAVE A CONCRETE TYPE OF FINISH (POLYMER LIDS AND FRAMES ARE ACCEPTABLE). BOXES AND VAULTS LOCATED WITHIN DRIVEWAYS SHALL BE TRAFFIC RATED BOXES AND LIDS FOR AT LEAST H20 TRAFFIC LOADS.

#### SITE RESTORATION

- 31. MINIMIZE DAMAGE TO LANDSCAPE: EXISTING LANDSCAPE WITHIN THE AREA OF WORK SHALL BE CAREFULLY REMOVED AND REPLACED WITH MINIMAL DAMAGE.
- 32. SITE RESTORATION: THE CONTRACTOR SHALL RETURN THE PRIVATE YARDS, SIDEWALKS, PLANTERS, IRRIGATION SYSTEMS, AND ANY OTHER FACILITIES, PUBLIC OR PRIVATE, DISTURBED BY THE WORK TO THE SAME OR BETTER CONDITION THAT EXISTED PRIOR TO COMMENCEMENT OF THE WORK. THE CONTRACTOR SHALL MAKE A REASONABLE EFFORT TO RESTORE EACH PRIVATE YARD DISTURBED BY THE WORK WITHIN ONE WEEK AFTER THE WORK IS COMPLETED ON THE SAME YARD EXCEPT WHERE THE CITY'S INSPECTOR AGREES THAT FOR CONSTRUCTION REASONS, THE ONE WEEK REQUIREMENT MAY BE FXTENDED.

#### SILICON VALLEY POWER (SVP) NOTES:

- 33. MAINTAIN 5' CLEARANCE FROM SVP OVERHEAD LINES AND IF USING EQUIPMENT NEAR THE OVERHEAD LINES OR EXCAVATING CLOSER THAN 42" TO SVP UNDERGROUND FACILITIES, CONTACT SVP A MINIMUM OF TWO WEEKS IN ADVANCE OF CONSTRUCTION. CONTRACTOR SHALL CONTACT DAVE PADILLA, ELECTRIC T&D MANAGER, AT (408) 615-5630.
- 34. PROTECT IN PLACE SVP TRANSFORMERS, VAULTS & MANHOLES, AND SVP UTILITY WOOD AND STRETLIGHT PLOES. MAINTAIN VERTICAL SEPARATION MINIMUM OF 24" OF FINISHED GRADE WHEN IMPROVING PAVEMENT. REFER TO 001000 PG 34.


GN-1


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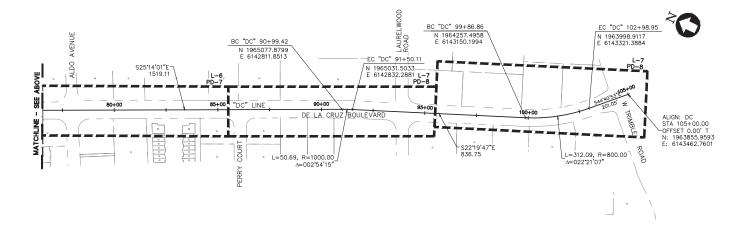
1730 N. FIRST STREET SUITE 600 SAN JOSE, CA 95112 408-467-9194 408-467-9100 (FAX)



	PROJEC	CT No.	CE CE XX-XX-XX		CITY OF SANTA CLARA		APPROVED BY							
	ACCOU	NT No	. XXX-XXXX-XXXX		PUBLIC WORKS DEPARTMENT	TITLE								
	DATE	No.	REVISION	BY		DATE			R.C.E. No.					
					SANTA CLARA		INITIAL	DATE	Survey No.					
					BIKEWAY IMPROVEMENTS	DESIGNED BY	RR/TC	05/23/25	TRACING No.					
.					GENERAL NOTES	DRAWN BY	AS/SD	05/23/25	XX XXX					
v					GENERAL NOTES	CHECKED BY	MC/CW	05/23/25	///,////-					
					HORIZONTAL SCALE: N.T.S. VERTICAL SCALE: N.T.S.	AS BUILT BY			SHEET 2 OF 47					



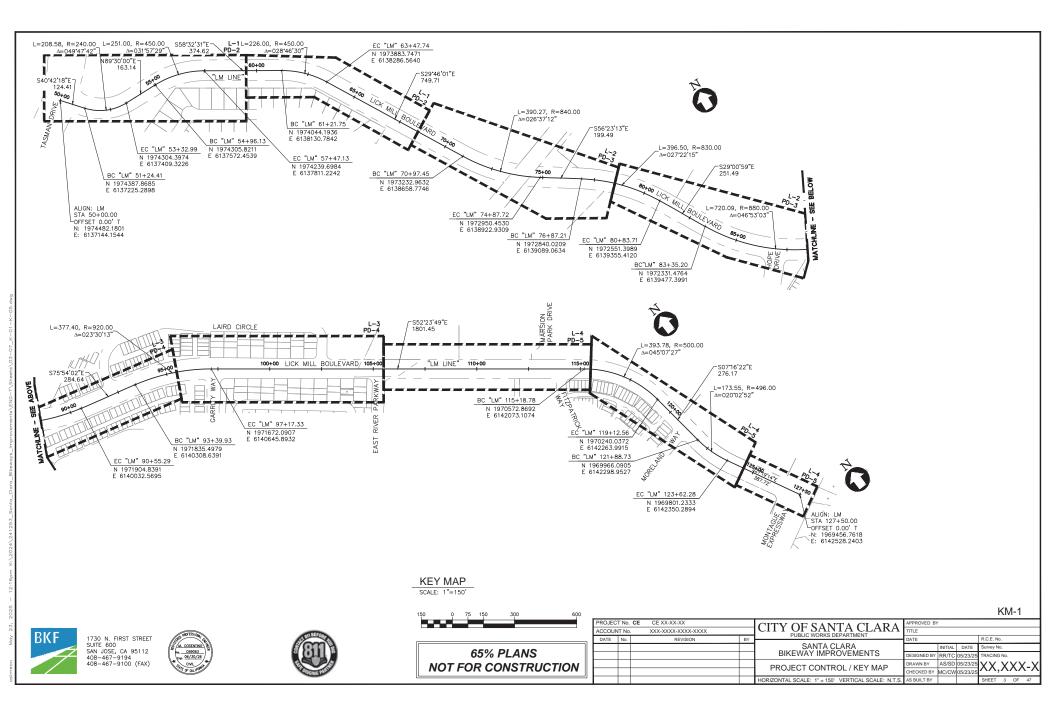

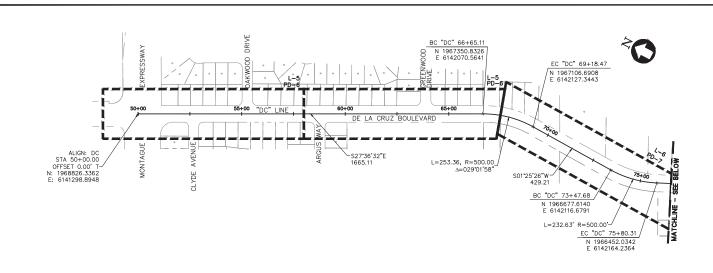


KEY MAP SCALE: 1"=150'








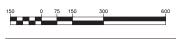



65% PLANS	
NOT FOR CONSTRUCTION	

									KI	M-2	
ı	PROJEC <sup>1</sup>	ΓNo.	CE CE XX-XX-XX		CITY OF SANTA CLARA	APPROVED BY	1				
- [	ACCOUN	T No.	XXX-XXXX-XXXX		PUBLIC WORKS DEPARTMENT	TITLE					
, [	DATE	No.	REVISION	BY		DATE			R.C.E. No.		
					SANTA CLARA		INITIAL	DATE	Survey No.		
[					BIKEWAY IMPROVEMENTS	DESIGNED BY					
ll [					PROJECT CONTROL / KEY MAP	DRAWN BY	AS/SD	05/23/25	$XX, \lambda$	(X)	Y - Y
					PROJECT CONTROL/ RET WAP	CHECKED BY	MC/CW	05/23/25	///,/	\/\/	\-\\
١.					HORIZONTAL SCALE: 1" = 150' VERTICAL SCALE: N.T.S.	AS BUILT BY			SHEET 4	OF	47

asimeon May 23, 2025 - 12:16pm K:\202

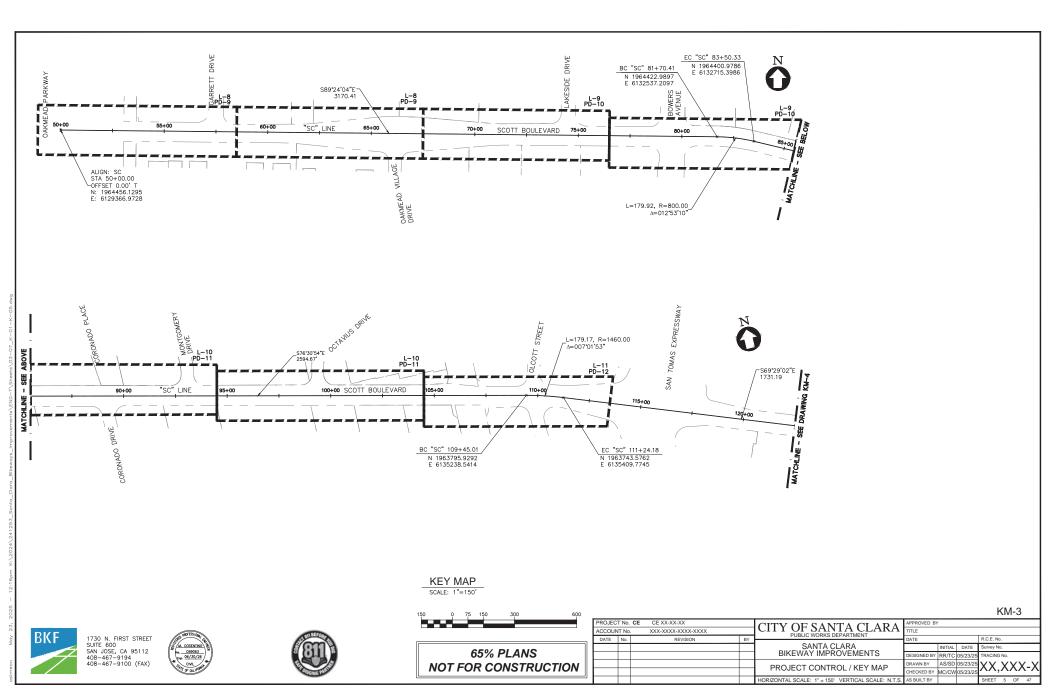

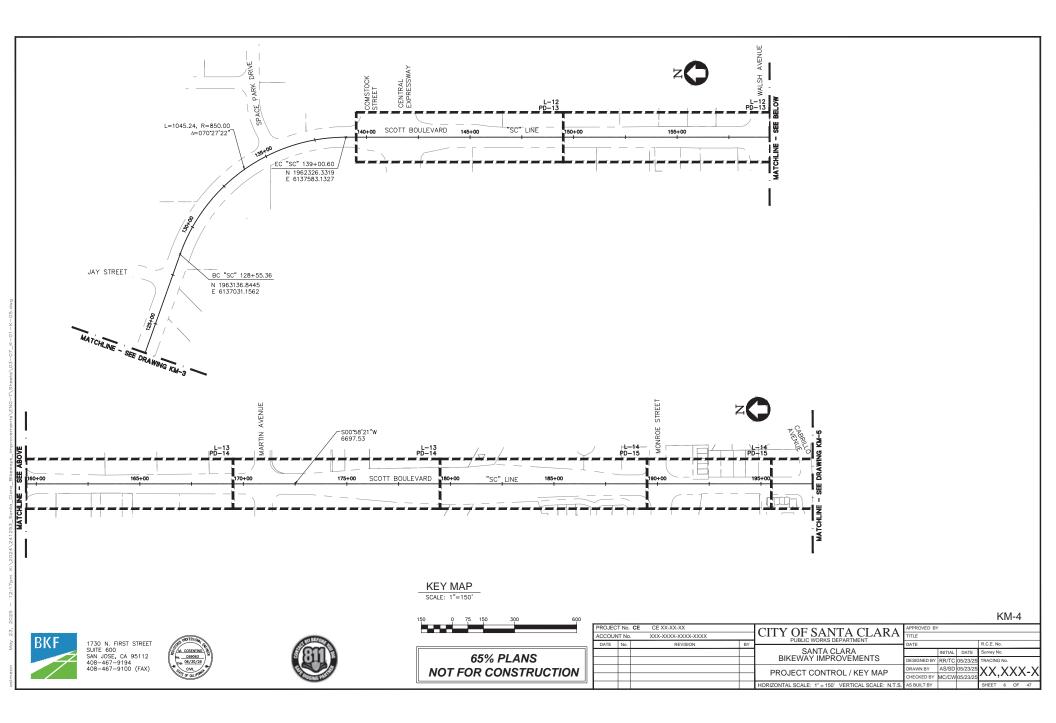

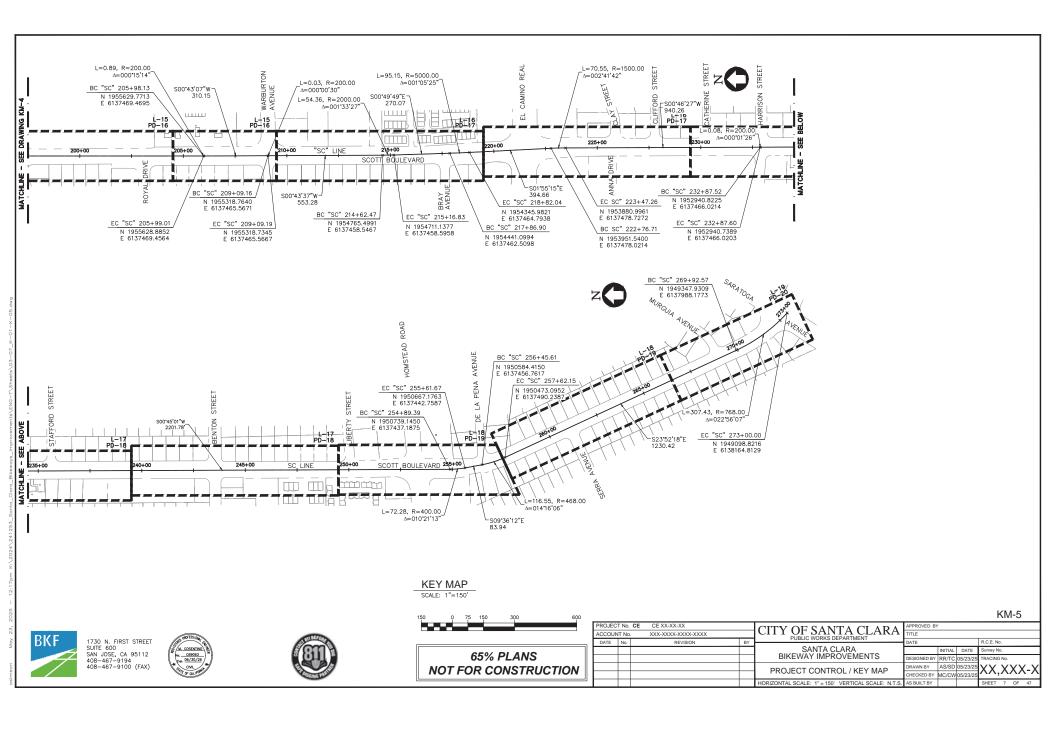



LICK MILL BOULEVARD - PLAN



#### CONSTRUCTION NOTES:

- $\bigodot$  (E) SIDEWALK, CURB, GUTTER, DRIVEWAY, CURB RAMP TO REMAIN.
- 2 PROTECT IN PLACE.
- 3 MICROGRIND PAVEMENT MARKING/LANE LINE BEFORE INSTALL OF NEW STRIPING.
- (4) REMOVE ALL EXISTING DETAIL 9 REFLECTORS BEFORE INSTALL OF NEW STRIPING. TYPICAL WHERE THERE IS NO SLURRY SEAL.

SLURRY SEAL (SEE NOTES 6, 7 & 8)

--- RIGHT OF WAY/PROPERTY LINE

- @ (E) STORM DRAIN MANHOLE
- ∃ (E) INLET
- @ (E) SANITARY SEWER MANHOLE
- O (E) TELEPHONE MANHOLE
- ⋈ (E) VALVE
- (E) FIRE HYDRANT
- □ (E) UTILITY BOX/VAULT
- 👢 (E) JOINT POLE AND GUY WIRE
- (E) STREET LIGHTING
- \_\_\_(E) SIGN

#### PROJECT PLAN IMPROVEMENT NOTES:

- THIS PLAN IS ACCURATE FOR PAVEMENT RESURFACING AND SLURRY SEAL ONLY.
   CONTRACTOR SHALL PRUNE TREE ROOTS AT DIRECTION OF

- CONTRACTOR SHALL PROVE TREE ROOTS AT DIRECTION CITY ENGINEER AND CITY ARBORIST. CONTRACTOR SHALL COMPLY WITH THE CITY STANDARD DETAILS FOR ALL PROJECT IMPROVEMENTS, UNLESS
- DETAILS FOR ALL PROJECT IMPROVEMENTS, UNLESS OTHERWISE NOTED.
  THE LINES AND THICKNESS SHOWN FOR CIVIL CONSTRUCTION WORK ARE FOR INFORMATION ONLY. IT SHALL BE THE CONTRACTOR'S RESPONSIBILITY TO DETERMINE THE EXTENT OF WORK BASED ON THE SPACE REQUIRED TO PERFORM THE CONSTRUCTION.
  CONTRACTOR SHALL BE RESPONSIBLE FOR THE PROTECTION AND PERPETUATION OF ANY BENCHMARK OR MONUMENTATION, UNLESS SHOWN FOR REMOVAL BY THESE PLANS. IF A BENCHMARK OR MONUMENTATION, UNLESS SHOWN FOR REMOVAL IS DISTURBED, THE CONTRACTOR SHALL HAVE A LICENSED LAND SURVEYOR RESTORE THE BENCHMARK OR MONUMENTATION ATTAINS OF REMOVAL IS DISTURBED, THE CONTRACTOR SHALL HAVE A LICENSED LAND SURVEYOR RESTORE THE BENCHMARK OR MONUMENTATION AT THE CONTRACTOR'S EXPENSE.
- MONUMENTATION AT THE CONTRACTOR'S EXPENSE.

  CONTRACTOR SHALL MASK MANHOLE LIDS, VALVE COVERS,
  AND UTILITY BOXES PRIOR TO SLURRY SEAL APPLICATION
  PER CONSTRUCTION NOTE(2).
- CONTRACTOR SHALL CRACK SEAL PER CITY STANDARDS PRIOR TO SLURRY SEAL.
- PRIOR TO SLURRY SEAL.

  CONTRACTOR SHALL REMOVE EXISTING PAVEMENT DELINEATION
  AND MARKINGS WITHIN LIMITS OF SLURRY SEAL WHICH
  CONFLICTS WITH THIS PLAN. CONTRACTOR SHALL GRIND EXISTING PAVEMENT DELINEATION AND MARKING PRIOR TO THE APPLICATION OF SLURRY SEAL. SLURRY SEAL SHALL BE APPLIED PRIOR TO INSTALLATION OF NEW STRIPING AND
- APPLIED PRIOR TO INSTALLATION OF NEW STRIPING AND MARKINGS.

  REFER TO SHEETS PD-1 TO PD-20 FOR SIGNING, STRIPING PLAN & TYPICAL SECTIONS.

  10. LOCATION OF R/W LINES ARE APPROXIMATE. ACTUAL

L-1


LOCATION OF R/W LINE WILL BE DETERMINED BY CITY IF NEEDED.



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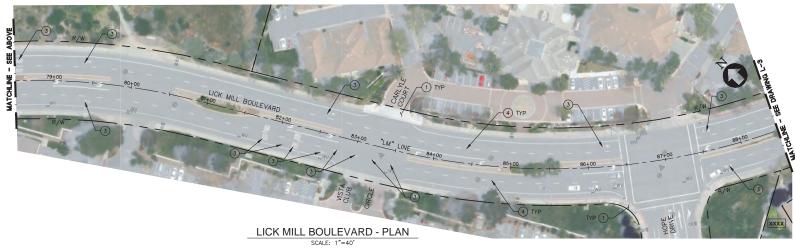




PROJE	ROJECT No. CE CE XX-XX-XX			CITY OF SANTA CLARA	APPROVED BY						
ACCO	COUNT No. XXX-XXXX-XXXX		PUBLIC WORKS DEPARTMENT								
DATE	No.	REVISION	BY		DATE		R.C.E. No.				
				SANTA CLARA		INITIAL	DATE	Survey No.			
				BIKEWAY IMPROVEMENTS	DESIGNED BY	RR/TC	05/23/25	TRACING No.			
				LAYOUT PLAN	DRAWN BY	AS/SD	05/23/25	XX XXX_X			
				LATOOT FLAN	CHECKED BY	MC/CW	05/23/25	///,///////////////////////////////////			
				HORIZONTAL SCALE: 1 = 40'	AS BUILT BY			SHEET 8 OF 47			
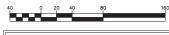
#### LICK MILL BOULEVARD - PLAN

SCALE: 1"=40'



#### CONSTRUCTION NOTES:

- $\begin{picture}(1)\time 1.5\textwidth (E) & SIDEWALK, CURB, GUTTER, DRIVEWAY, CURB RAMP TO REMAIN. \end{picture}$
- 2 PROTECT IN PLACE.
- 3 MICROGRIND PAVEMENT MARKING/LANE LINE BEFORE INSTALL OF NEW STRIPING.
- (4) REMOVE ALL EXISTING DETAIL 9 REFLECTORS BEFORE INSTALL OF NEW STRIPING. TYPICAL WHERE THERE IS NO SLURRY SEAL.

#### LEGEND:

SLURRY SEAL (SEE NOTES 6, 7 & 8)

--- RIGHT OF WAY/PROPERTY LINE

- @ (E) STORM DRAIN MANHOLE
- (E) INLET
- @ (E) SANITARY SEWER MANHOLE
- O (E) TELEPHONE MANHOLE
- ⋈ (E) VALVE
- (E) FIRE HYDRANT
- □ (E) UTILITY BOX/VAULT
- 🕽 (E) JOINT POLE AND GUY WIRE
- (E) STREET LIGHTING
- ——(E) SIGN

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   CONTRACTOR SHALL PRUNE TREE ROOTS AT DIRECTION OF
- CITY ENGINEER AND CITY ARBORIST.
  CONTRACTOR SHALL COMPLY WITH THE CITY STANDARD
  DETAILS FOR ALL PROJECT IMPROVEMENTS, UNLESS

- DETAILS FOR ALL PROJECT IMPROVEMENTS, UNLESS
  OTHERWISE NOTED.

  4. THE LINES AND THICKNESS SHOWN FOR CIVIL CONSTRUCTION
  WORK ARE FOR INFORMATION ONLY, IT SHALL BE THE
  CONTRACTOR'S RESPONSIBILITY TO DETERMINE THE EXTENT
  OF WORK BASED ON THE SPAGE REQUIRED TO PERFORM
  THE CONSTRUCTION.
  CONTRACTOR SHALL BE RESPONSIBLE FOR THE PROTECTION
  AND PERPETUATION OF ANY BENCHMARK OR
  MONUMENTATION OF ANY BENCHMARK OR
  MONUMENTATION, UNLESS SHOWN FOR REMOVAL BY THESE
  PLANS, IF A BENCHMARK OR MONUMENTATION NOT SHOWN
  FOR REMOVAL IS DISTURBED, THE CONTRACTOR SHALL HAVE
  A LICENSED LAND SURVEYOR RESTORE THE BENCHMARK OR
  MONUMENTATION OF THE CONTRACTOR SHALL HAVE
  A LICENSED LAND SURVEYOR RESTORE THE BENCHMARK OR
  MONUMENTATION AT THE CONTRACTOR STEPPENSE
  - A CLEURSED DAND SORVETOR RESIDER IN BENCHMARK C MONUMENTATION AT THE CONTRACTOR'S EXPENSE. CONTRACTOR SHALL MASK MANHOLE LIDS, VALVE COVERS, AND UTILITY BOXES PRIOR TO SLURRY SEAL APPLICATION PER CONSTRUCTION NOTE(2).

- CONTRACTOR SHALL CRACK SEAL PER CITY STANDARDS PRIOR TO SLURRY SEAL.

  CONTRACTOR SHALL REMOVE EXISTING PAVEMENT DELINEATION AND MARKINGS WITHIN LIMITS OF SLURRY SEAL WHICH CONFLICTS WITH THIS PLAN. CONTRACTOR SHALL GRIND EXISTING PAVEMENT DELINEATION AND MARKING PRIOR TO THE APPLICATION OF SLURRY SEAL SHALL BE APPLIED PRIOR TO INSTALLATION OF NEW STRIPING AND MARKINGS.
- APPLIED PRIOR TO INSTALLATION OF NEW STRIPING AND MARKINGS.

  REFER TO SHEETS PD-1 TO PD-20 FOR SIGNING, STRIPING PLAN & TYPICAL SECTIONS.

  10. LOCATION OF R/W LINES ARE APPROXIMATE. ACTUAL
- LOCATION OF R/W LINE WILL BE DETERMINED BY CITY IF



1730 N. FIRST STREET SUITE 600 SAN JOSE, CA 95112 408-467-9194 408-467-9100 (FAX)







65% PLANS **NOT FOR CONSTRUCTION** 

PRO	PROJECT No. CE CE XX-XX-XX				CITY OF SANTA CLARA	APPROVED BY						
ACC	CCOUNT No. XXX-XXXX-XXXX				PUBLIC WORKS DEPARTMENT	TITLE						
DA*	TE	No.	REVISION	BY		DATE		R.C.E. No.				
					SANTA CLARA		INITIAL	DATE	Survey No.			
					BIKEWAY IMPROVEMENTS	DESIGNED BY	RR/TC	05/23/25	TRACING No.			
					LAYOUT PLAN	DRAWN BY	AS/SD	05/23/25	$YY YYY_Y$			
					LATOUTPLAN	CHECKED BY	MC/CW	05/23/25	///,////·/			
					HORIZONTAL SCALE: 1 = 40'	AS BUILT BY			SHEET 9 OF 47			

L-2



#### LICK MILL BOULEVARD - PLAN SCALE: 1"=40



### LICK MILL BOULEVARD - PLAN

SCALE: 1"=40'

#### CONSTRUCTION NOTES:

- $\bigodot$  (E) SIDEWALK, CURB, GUTTER, DRIVEWAY, CURB RAMP TO REMAIN.
- 2 PROTECT IN PLACE.
- 3 MICROGRIND PAVEMENT MARKING/LANE LINE BEFORE INSTALL OF NEW STRIPING.
- (4) REMOVE ALL EXISTING DETAIL 9 REFLECTORS BEFORE INSTALL OF NEW STRIPING. TYPICAL WHERE THERE IS NO SLURRY SEAL.

#### LEGEND:

SLURRY SEAL (SEE NOTES 6, 7 & 8)

--- RIGHT OF WAY/PROPERTY LINE

- @ (E) STORM DRAIN MANHOLE
- (E) INLET
- @ (E) SANITARY SEWER MANHOLE
- O (E) TELEPHONE MANHOLE
- (E) FIRE HYDRANT
- □ (E) UTILITY BOX/VAULT
- 🕽 (E) JOINT POLE AND GUY WIRE
- (E) STREET LIGHTING
- ---(E) SIGN

#### PROJECT PLAN IMPROVEMENT NOTES:

- THIS PLAN IS ACCURATE FOR PAVEMENT RESURFACING AND SLURRY SEAL ONLY.
  CONTRACTOR SHALL PRUNE TREE ROOTS AT DIRECTION OF
- CONTRACTOR SHALL PROVE IREE ROOTS AT DIRECTION CITY ENGINEER AND CITY ARBORIST. CONTRACTOR SHALL COMPLY WITH THE CITY STANDARD DETAILS FOR ALL PROJECT IMPROVEMENTS, UNLESS
- DETAILS FOR ALL PROJECT IMPROVEMENTS, UNLESS OTHERWISE NOTED.
  THE LINES NOTED.
  THE LINES AND THICKNESS SHOWN FOR CAUL CONSTRUCTION WORK ARE FOR INFORMATION ONLY, IT SHALL BE THE CONTRACTOR'S RESPONSIBILITY TO DETERMINE THE EXTENT OF WORK BASED ON THE SPACE REQUIRED TO PERFORM THE CONSTRUCTION OF ANY BENCHMARK OR MONUMENTATION, UNLESS SHOWN FOR REMOVAL BY THESE PLANS. IF A BENCHMARK OR MONUMENTATION, UNLESS SHOWN FOR REMOVAL BY THESE PLANS. IF A BENCHMARK OR MONUMENTATION NOT SHOWN FOR REMOVAL IS DISTURBED, THE CONTRACTOR SHALL HAVE A LICENSED LAND SURVEYOR RESTORE THE BENCHMARK OR MONUMENTATION AT THE CONTRACTOR SHALL HAVE A LICENSED LAND SURVEYOR RESTORE THE BENCHMARK OR MONUMENTATION AT THE CONTRACTOR'S EXPENSE
- A CLEURSED DAND SORVETOR RESIDER IN BENCHMARK C MONUMENTATION AT THE CONTRACTOR'S EXPENSE. CONTRACTOR SHALL MASK MANHOLE LIDS, VALVE COVERS, AND UTILITY BOXES PRIOR TO SLURRY SEAL APPLICATION PER CONSTRUCTION NOTE(2).
- CONTRACTOR SHALL CRACK SEAL PER CITY STANDARDS PRIOR TO SLURRY SEAL.
  CONTRACTOR SHALL REMOVE EXISTING PAVEMENT DELINEATION AND MARKINGS WITHIN LIMITS OF SLURRY SEAL WHICH CONFLICTS WITH THIS PLAN. CONTRACTOR SHALL GRIND EXISTING PAVEMENT DELINEATION AND MARKING PRIOR TO THE APPLICATION OF SLURRY SEAL. SLURRY SEAL SHALL BE APPLIED PRIOR TO INSTALLATION OF NEW STRIPING AND
- APPLIED PRIOR TO INSTALLATION OF NEW STRIPING AND MARKINGS.

  9. REFER TO SHEETS PD-1 TO PD-20 FOR SIGNING, STRIPING PLAN & TYPICAL SECTIONS.

  10. LOCATION OF R/W LINES ARE APPROXIMATE. ACTUAL

L-3


LOCATION OF R/W LINE WILL BE DETERMINED BY CITY IF NEEDED.



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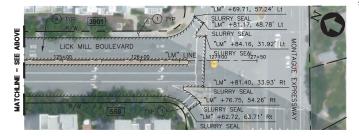
PRO	PROJECT No. CE CE XX-XX-XX				CITY OF SANTA CLARA	APPROVED BY	′				
ACC	CCOUNT No. XXX-XXXX-XXXX				PUBLIC WORKS DEPARTMENT	TITLE					
DA*	TE	No.	REVISION	BY		DATE		R.C.E. No.			
					SANTA CLARA		INITIAL	DATE	Survey No.		
					BIKEWAY IMPROVEMENTS	DESIGNED BY	RR/TC	05/23/25	TRACING No.		
					LAYOUT PLAN	DRAWN BY	AS/SD	05/23/25	$YY YYY_Y$		
					LATOUT PLAN	CHECKED BY	MC/CW	05/23/25	///,////·/		
					HORIZONTAL SCALE: 1 = 40'	AS BUILT BY			SHEET 10 OF 47		

LICK MILL BOULEVARD - PLAN SCALE: 1"=40'

LICK MILL BOULEVARD TYP (4)-H "LM" LINE121+00 "LM" +79.00, 11.02' Rt SLURRY SEAL
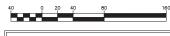
#### LICK MILL BOULEVARD - PLAN

SCALE: 1"=40'



LICK MILL BOULEVARD - PLAN SCALE: 1"=40"

- $\begin{picture}(1)\end{picture}$  (E) SIDEWALK, CURB, GUTTER, DRIVEWAY, CURB RAMP TO REMAIN.
- 2 PROTECT IN PLACE.

CONSTRUCTION NOTES:

- 3) MICROGRIND PAVEMENT MARKING/LANE LINE BEFORE INSTALL OF NEW STRIPING.
- REMOVE ALL EXISTING DETAIL 9 REFLECTORS BEFORE INSTALL

SLURRY SEAL (SEE NOTES 6, 7 & 8)

RIGHT OF WAY/PROPERTY LINE

- @ (E) STORM DRAIN MANHOLE
- (E) INLET
- @ (E) SANITARY SEWER MANHOLE
- O (E) TELEPHONE MANHOLE
- ⋈ (E) VALVE
- (E) FIRE HYDRANT
- □ (E) UTILITY BOX/VAULT
- 🕽 (E) JOINT POLE AND GUY WIRE
- (E) STREET LIGHTING
- \_\_\_(E) SIGN

#### PROJECT PLAN IMPROVEMENT NOTES:

- THIS PLAN IS ACCURATE FOR PAVEMENT RESURFACING AND SLURRY SEAL ONLY.
   CONTRACTOR SHALL PRUNE TREE ROOTS AT DIRECTION OF
- CONTRACTOR SHALL PROVE TREE ROOTS AT DIRECTION CITY ENGINEER AND CITY ARBORIST. CONTRACTOR SHALL COMPLY WITH THE CITY STANDARD DETAILS FOR ALL PROJECT IMPROVEMENTS, UNLESS

- DETAILS FOR ALL PROJECT IMPROVEMENTS, UNLESS OTHERWISE NOTED.
  THE LINES NOTED.
  THE LINES AND THICKNESS SHOWN FOR CAUL CONSTRUCTION WORK ARE FOR INFORMATION ONLY, IT SHALL BE THE CONTRACTOR'S RESPONSIBILITY TO DETERMINE THE EXTENT OF WORK BASED ON THE SPACE REQUIRED TO PERFORM THE CONSTRUCTION OF ANY BENCHMARK OR MONUMENTATION, UNLESS SHOWN FOR REMOVAL BY THESE PLANS. IF A BENCHMARK OR MONUMENTATION, UNLESS SHOWN FOR REMOVAL BY THESE PLANS. IF A BENCHMARK OR MONUMENTATION NOT SHOWN FOR REMOVAL IS DISTURBED, THE CONTRACTOR SHALL HAVE A LICENSED LAND SURVEYOR RESTORE THE BENCHMARK OR MONUMENTATION AT THE CONTRACTOR SHALL HAVE A LICENSED LAND SURVEYOR RESTORE THE BENCHMARK OR MONUMENTATION AT THE CONTRACTOR'S EXPENSE
- MONUMENTATION AT THE CONTRACTOR'S EXPENSE.

  CONTRACTOR SHALL MASK MANHOLE LIDS, VALVE COVERS,
  AND UTILITY BOXES PRIOR TO SLURRY SEAL APPLICATION
  PER CONSTRUCTION NOTE(2).

- CONTRACTOR SHALL CRACK SEAL PER CITY STANDARDS PRIOR TO SLURRY SEAL.
  CONTRACTOR SHALL REMOVE EXISTING PAVEMENT DELINEATION AND MARKINGS WITHIN LIMITS OF SLURRY SEAL WHICH CONFLICTS WITH THIS PLAN. CONTRACTOR SHALL GRIND EXISTING PAVEMENT DELINEATION AND MARKING PRIOR TO THE APPLICATION OF SLURRY SEAL. SLURRY SEAL SHALL BE APPLIED PRIOR TO INSTALLATION OF NEW STRIPING AND
- APPLIED PRIOR TO INSTALLATION OF NEW STRIPING AND MARKINGS.

  REFER TO SHEETS PD-1 TO PD-20 FOR SIGNING, STRIPING PLAN & TYPICAL SECTIONS.

  10. LOCATION OF R/W LINES ARE APPROXIMATE. ACTUAL
- LOCATION OF R/W LINE WILL BE DETERMINED BY CITY IF NEEDED.




1730 N. FIRST STREET SUITE 600 SAN JOSE, CA 95112 408-467-9194 408-467-9100 (FAX)








PROJE	CT No.	CE CE XX-XX-XX		CITY OF SANTA CLARA	APPROVED BY	′			
ACCOL	CCOUNT No. XXX-XXXX-XXXX		PUBLIC WORKS DEPARTMENT		TITLE				
DATE	No.	REVISION	BY	DATE		R.C.E. No.			
				SANTA CLARA BIKEWAY IMPROVEMENTS		INITIAL	DATE	Survey No.	
					DESIGNED BY	RR/TC	05/23/25	TRACING No.	
				LAYOUT PLAN	DRAWN BY	AS/SD	05/23/25	$XX XXX_X$	
				LATOOT FLAN	CHECKED BY	MC/CW	05/23/25	///,///// //	
				HORIZONTAL SCALE: 1 = 40'	AS BUILT BY			SHEET 11 OF 47	

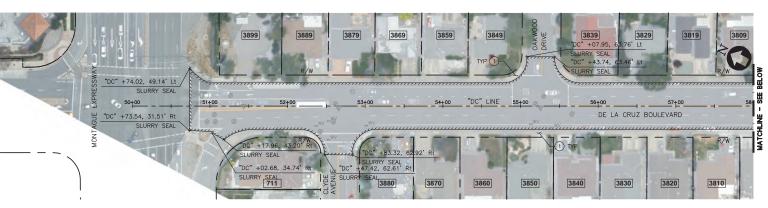

DE LA CRUZ BOULEVARD - PLAN

SCALE: 1"=40

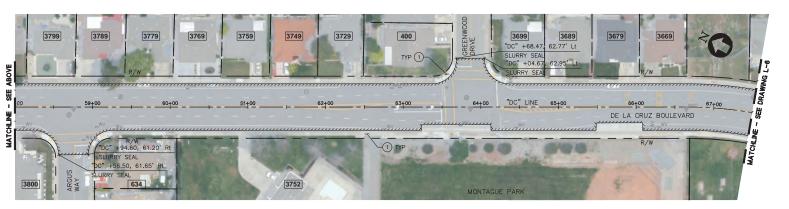

DE LA CRUZ BOULEVARD - PLAN

SCALE: 1"=40'

#### CONSTRUCTION NOTES:

- (E) SIDEWALK, CURB, GUTTER, DRIVEWAY, CURB RAMP TO REMAIN.
- 2 PROTECT IN PLACE.
- 3 MICROGRIND PAVEMENT MARKING/LANE LINE BEFORE INSTALL OF NEW STRIPING.
- 4 REMOVE ALL EXISTING DETAIL 9 REFLECTORS BEFORE INSTALL OF NEW STRIPING. TYPICAL WHERE THERE IS NO SLURRY SEAL.

#### LEGEND:

SLURRY SEAL (SEE NOTES 6, 7 & 8)

--- RIGHT OF WAY/PROPERTY LINE

- @ (E) STORM DRAIN MANHOLE
- ∃ (E) INLET
- @ (E) SANITARY SEWER MANHOLE
- O (E) TELEPHONE MANHOLE
- (E) FIRE HYDRANT
- □ (E) UTILITY BOX/VAULT
- 🕽 (E) JOINT POLE AND GUY WIRE
- (E) STREET LIGHTING
- ---(E) SIGN

#### PROJECT PLAN IMPROVEMENT NOTES:

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- CONTRACTOR SHALL PROVE IREE ROOTS AT DIRECTION CITY ENGINEER AND CITY ARBORIST. CONTRACTOR SHALL COMPLY WITH THE CITY STANDARD DETAILS FOR ALL PROJECT IMPROVEMENTS, UNLESS
- - DETAILS FOR ALL PROJECT IMPROVEMENTS, UNLESS
    THE LINES AND THICKNESS SHOWN FOR CIVIL CONSTRUCTION
    WORK ARE FOR INFORMATION ONLY, IT SHALL BE THE
    CONTRACTOR'S RESPONSIBILITY TO DETERMINE THE EXTENT OF WORK BASED ON THE SPACE REQUIRED TO PERFORM THE CONSTRUCTION.
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  CONTRACTOR SHALL BE RESPONSIBLE FOR THE PROTECTION

  AND PERPETUATION OF ANY BENCHMARK OR

  MONUMENTATION, UNLESS SHOWN FOR REMOVAL BY THESE

  PLANS. IF A BENCHMARK OR MONUMENTATION NOT SHOWN

  FOR REMOVAL IS DISTURBED, THE CONTRACTOR SHALL HAVE

  A LICENSED LAND SURVEYOR RESTORE THE BENCHMARK OR
- MONUMENTATION AT THE CONTRACTOR'S EXPENSE.

  CONTRACTOR SHALL MASK MANHOLE LIDS, VALVE COVERS,
  AND UTILITY BOXES PRIOR TO SLURRY SEAL APPLICATION
  PER CONSTRUCTION NOTE(2).
- CONTRACTOR SHALL CRACK SEAL PER CITY STANDARDS PRIOR TO SLURRY SEAL.
- PRIOR TO SLURRY SEAL.

  CONTRACTOR SHALL REMOVE EXISTING PAVEMENT DELINEATION
  AND MARKINGS WITHIN LIMITS OF SLURRY SEAL WHICH
  CONFLICTS WITH THIS PLAN. CONTRACTOR SHALL GRIND EXISTING PAVEMENT DELINEATION AND MARKING PRIOR TO THE APPLICATION OF SLURRY SEAL. SLURRY SEAL SHALL BE APPLIED PRIOR TO INSTALLATION OF NEW STRIPING AND
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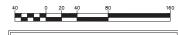
L-5



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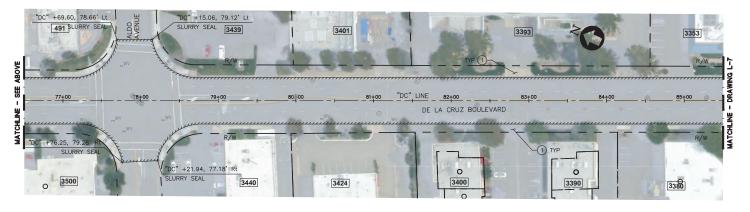




	PROJEC*	T No.	CE CE XX-XX-XX		CITY OF SANTA CLARA	APPROVED BY							
	ACCOUN	IT No.	XXX-XXXX-XXXX		PUBLIC WORKS DEPARTMENT	TITLE							
a	DATE	No.	REVISION	BY		DATE			R.C.E. No.				
11					SANTA CLARA		INITIAL	DATE	Survey No.				
					BIKEWAY IMPROVEMENTS	DESIGNED BY	RR/TC	05/23/25	TRACING No.	$\neg$			
					LAYOUT PLAN	DRAWN BY	AS/SD	05/23/25	XX XXX	. X			
					LATOOT FLAN	CHECKED BY	MC/CW	05/23/25	///,/////	$^{\prime}$			
_					HORIZONTAL SCALE: 1 = 40'	AS BUILT BY			SHEET 12 OF 47	7			

#### DE LA CRUZ BOULEVARD - PLAN

SCALE: 1"=40'



#### DE LA CRUZ BOULEVARD - PLAN

SCALE: 1"=40'

#### CONSTRUCTION NOTES:

- $\bigodot$  (E) SIDEWALK, CURB, GUTTER, DRIVEWAY, CURB RAMP TO REMAIN.
- 2 PROTECT IN PLACE.
- 3 MICROGRIND PAVEMENT MARKING/LANE LINE BEFORE INSTALL OF NEW STRIPING.
- (4) REMOVE ALL EXISTING DETAIL 9 REFLECTORS BEFORE INSTALL OF NEW STRIPING. TYPICAL WHERE THERE IS NO SLURRY SEAL.

#### LEGEND:



SLURRY SEAL (SEE NOTES 6, 7 & 8)

RIGHT OF WAY/PROPERTY LINE

- @ (E) STORM DRAIN MANHOLE
- ∃ (E) INLET
- @ (E) SANITARY SEWER MANHOLE
- O (E) TELEPHONE MANHOLE
- (E) FIRE HYDRANT
- □ (E) UTILITY BOX/VAULT
- (E) JOINT POLE AND GUY WIRE
- (E) STREET LIGHTING
- (E) SIGN

#### PROJECT PLAN IMPROVEMENT NOTES:

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- CONTRACTOR SHALL PROVE TREE ROOTS AT DIRECTION CITY ENGINEER AND CITY ARBORIST. CONTRACTOR SHALL COMPLY WITH THE CITY STANDARD DETAILS FOR ALL PROJECT IMPROVEMENTS, UNLESS
- DETAILS FOR ALL PROJECT IMPROVEMENTS, UNLESS
  OTHERWISE NOTED.

  4. THE LINES AND THICKNESS SHOWN FOR CIVIL CONSTRUCTION
  WORK ARE FOR INFORMATION ONLY. IT SHALL BE THE
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- CONTRACTOR'S RESPONSIBILITY TO DETERMINE THE EXTENT OF WORK BASED ON THE SPACE REQUIRED TO PERFORM THE CONSTRUCTION.

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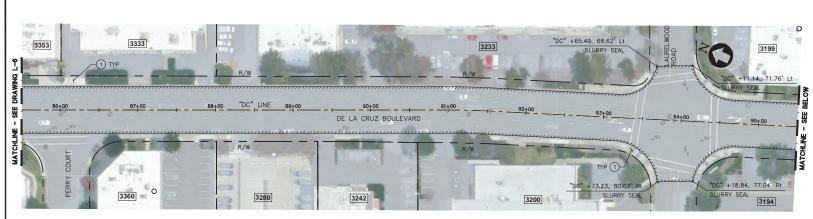
1730 N. FIRST STREET SUITE 600 SAN JOSE, CA 95112 408-467-9194 408-467-9100 (FAX)








									L	-6	
	PROJEC*	T No.	CE CE XX-XX-XX		CITY OF SANTA CLARA	APPROVED BY	1				
	ACCOUN	T No.	XXX-XXXX-XXXX		PUBLIC WORKS DEPARTMENT	TITLE					
_	DATE	No.	REVISION	BY		DATE			R.C.E. No.		
					SANTA CLARA		INITIAL	DATE	Survey No.		
					BIKEWAY IMPROVEMENTS	DESIGNED BY	RR/TC	05/23/25	TRACING No.		
					LAYOUT PLAN	DRAWN BY	AS/SD	05/23/25	yyy	VV	/_X
					LATOUT PLAIN	CHECKED BY	MC/CW	05/23/25	/\//\	/\/	`^
					HORIZONTAL SCALE: 1 = 40'	AS BUILT BY			SHEET 13	OF	47



#### DE LA CRUZ BOULEVARD - PLAN

SCALE: 1"=40

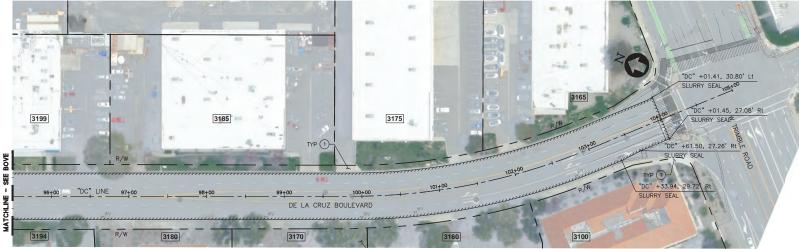

#### DE LA CRUZ BOULEVARD - PLAN

SCALE: 1"=40"

#### CONSTRUCTION NOTES:

- $\begin{picture}(1)\end{picture}$  (E) SIDEWALK, CURB, GUTTER, DRIVEWAY, CURB RAMP TO REMAIN.
- 2 PROTECT IN PLACE.
- 3 MICROGRIND PAVEMENT MARKING/LANE LINE BEFORE INSTALL OF NEW STRIPING.
- 4 REMOVE ALL EXISTING DETAIL 9 REFLECTORS BEFORE INSTALL OF NEW STRIPING. TYPICAL WHERE THERE IS NO SLURRY SEAL.

#### LEGEND:

SLURRY SEAL (SEE NOTES 6, 7 & 8)

RIGHT OF WAY/PROPERTY LINE

- @ (E) STORM DRAIN MANHOLE
- (E) INLET
- @ (E) SANITARY SEWER MANHOLE
- O (E) TELEPHONE MANHOLE
- ⋈ (E) VALVE
- (E) FIRE HYDRANT
- □ (E) UTILITY BOX/VAULT
- 👢 (E) JOINT POLE AND GUY WIRE
- (E) STREET LIGHTING
- ---(E) SIGN

#### PROJECT PLAN IMPROVEMENT NOTES:

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- PRIOR TO SLURRY SEAL.

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  10. LOCATION OF R/W LINES ARE APPROXIMATE, ACTUAL

L-7


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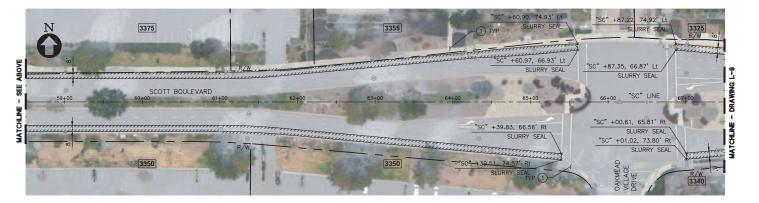






PROJEC	T No.	CE CE XX-XX-XX		CITY OF SANTA CLARA	APPROVED BY	1			
ACCOUN	ACCOUNT No. XXX-XXXX-XXXX			PUBLIC WORKS DEPARTMENT	TITLE				
DATE	No.	REVISION	BY		DATE			R.C.E. No.	
				SANTA CLARA		INITIAL	DATE	Survey No.	
				BIKEWAY IMPROVEMENTS	DESIGNED BY	RR/TC	05/23/25	TRACING No.	
				LAYOUT PLAN	DRAWN BY	AS/SD	05/23/25	$YY YYY_Y$	
				LATOUTPLAN	CHECKED BY	MC/CW	05/23/25	///,/////·/	
				HORIZONTAL SCALE: 1 = 40'	AS BUILT BY			SHEET 14 OF 47	

SCALE: 1"=40

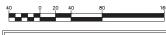

#### SCOTT BOULEVARD - PLAN

SCALE: 1"=40'

#### CONSTRUCTION NOTES:

- $\bigodot$  (E) SIDEWALK, CURB, GUTTER, DRIVEWAY, CURB RAMP TO REMAIN.
- 2 PROTECT IN PLACE.
- 3 MICROGRIND PAVEMENT MARKING/LANE LINE BEFORE INSTALL OF NEW STRIPING.
- 4 REMOVE ALL EXISTING DETAIL 9 REFLECTORS BEFORE INSTALL OF NEW STRIPING. TYPICAL WHERE THERE IS NO SLURRY SEAL.

#### LEGEND:

SLURRY SEAL (SEE NOTES 6, 7 & 8)

--- RIGHT OF WAY/PROPERTY LINE

- @ (E) STORM DRAIN MANHOLE
- ∃ (E) INLET
- @ (E) SANITARY SEWER MANHOLE
- O (E) TELEPHONE MANHOLE
- ⋈ (E) VALVE
- (E) FIRE HYDRANT
- □ (E) UTILITY BOX/VAULT
- 🙏 (E) JOINT POLE AND GUY WIRE
- (E) STREET LIGHTING
- (E) SIGN

#### PROJECT PLAN IMPROVEMENT NOTES:

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- DETAILS FOR ALL PROJECT IMPROVEMENTS, UNLESS
  OTHERWISE NOTED.

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- MARKINGS.

  9. REFER TO SHEETS PD-1 TO PD-20 FOR SIGNING, STRIPING PLAN & TYPICAL SECTIONS.

  10. LOCATION OF R/W LINES ARE APPROXIMATE. ACTUAL

L-8

LOCATION OF R/W LINE WILL BE DETERMINED BY CITY IF NEEDED.










PROJEC	T No.	CE CE XX-XX-XX		CITY OF SANTA CLARA	APPROVED BY	′			
ACCOUN	ACCOUNT No. XXX-XXXX-XXXX			PUBLIC WORKS DEPARTMENT	TITLE				
DATE	No.	REVISION	BY	DATE		R.C.E. No.			
				SANTA CLARA		INITIAL	DATE	Survey No.	
				BIKEWAY IMPROVEMENTS	DESIGNED BY	RR/TC	05/23/25	TRACING No.	
				LAYOUT PLAN	DRAWN BY	AS/SD	05/23/25	$YY YYY_Y$	
				LATOOT FLAN	CHECKED BY	MC/CW	05/23/25	///,///// //	
				HORIZONTAL SCALE: 1 = 40'	AS BUILT BY			SHEET 15 OF 47	

SCALE: 1"=40

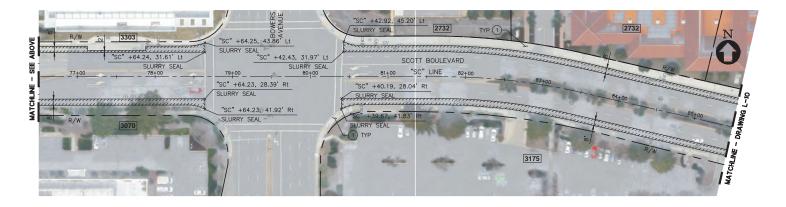

#### SCOTT BOULEVARD - PLAN

SCALE: 1"=40'

#### CONSTRUCTION NOTES:

- (E) SIDEWALK, CURB, GUTTER, DRIVEWAY, CURB RAMP TO REMAIN.
- 2 PROTECT IN PLACE.
- 3 MICROGRIND PAVEMENT MARKING/LANE LINE BEFORE INSTALL OF NEW STRIPING.
- 4 REMOVE ALL EXISTING DETAIL 9 REFLECTORS BEFORE INSTALL OF NEW STRIPING. TYPICAL WHERE THERE IS NO SLURRY SEAL.

SLURRY SEAL (SEE NOTES 6, 7 & 8)

--- RIGHT OF WAY/PROPERTY LINE

- @ (E) STORM DRAIN MANHOLE
- ∃ (E) INLET
- @ (E) SANITARY SEWER MANHOLE
- O (E) TELEPHONE MANHOLE
- (E) FIRE HYDRANT
- □ (E) UTILITY BOX/VAULT
- 👢 (E) JOINT POLE AND GUY WIRE
- (E) STREET LIGHTING
- (E) SIGN

#### PROJECT PLAN IMPROVEMENT NOTES:

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  10. LOCATION OF R/W LINES ARE APPROXIMATE. ACTUAL

L-9


LOCATION OF R/W LINE WILL BE DETERMINED BY CITY IF NEEDED.




1730 N. FIRST STREET SUITE 600 SAN JOSE, CA 95112 408-467-9194 408-467-9100 (FAX)






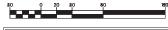

	PROJEC <sup>1</sup>	T No.	CE CE XX-XX-XX		CITY OF CANTA CLADA	APPROVED BY	,				$\neg$
	ACCOUN	IT No.	XXX-XXXX-XXXX		CITY OF SANTA CLARA	TITLE					
, I	DATE	No.	REVISION	BY		DATE			R.C.E. No.		
Ш					SANTA CLARA		INITIAL	DATE	Survey No.		
Ш					BIKEWAY IMPROVEMENTS	DESIGNED BY	RR/TC	05/23/25	TRACING No.		
Ш					LAYOUT PLAN			05/23/25		Y)	/_Y
Ш					LATOUT PLAN	CHECKED BY	MC/CW	05/23/25	$\wedge \wedge, \wedge$	./\/	(-\
_					HORIZONTAL SCALE: 1 = 40'	AS BUILT BY			SHEET 16	OF	47

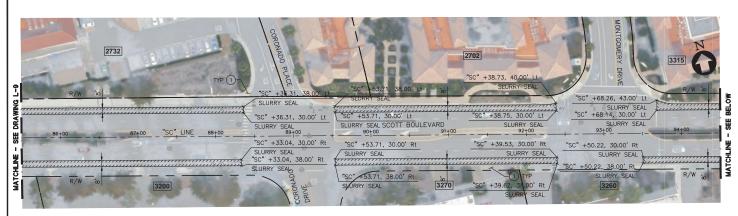

SCALE: 1"=40

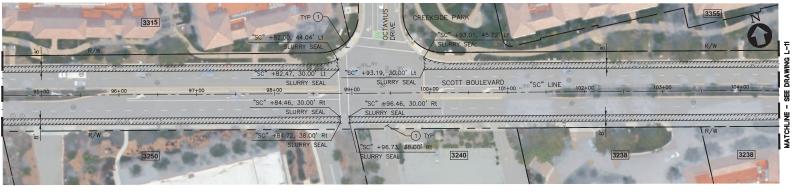

SCOTT BOULEVARD - PLAN

SCALE: 1"=40'

#### CONSTRUCTION NOTES:

- (E) SIDEWALK, CURB, GUTTER, DRIVEWAY, CURB RAMP TO REMAIN.
- 2 PROTECT IN PLACE.
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#### LEGEND:

SLURRY SEAL (SEE NOTES 6, 7 & 8)

--- RIGHT OF WAY/PROPERTY LINE

- @ (E) STORM DRAIN MANHOLE
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- (E) STREET LIGHTING
- (E) SIGN

#### PROJECT PLAN IMPROVEMENT NOTES:

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  10. LOCATION OF R/W LINES ARE APPROXIMATE. ACTUAL

L-10

LOCATION OF R/W LINE WILL BE DETERMINED BY CITY IF NEEDED.



1730 N. FIRST STREET SUITE 600 SAN JOSE, CA 95112 408-467-9194 408-467-9100 (FAX)







	PROJEC*	T No.	CE CE XX-XX-XX		CITY OF SANTA CLARA	APPROVED BY	′				
	ACCOUN	IT No.	XXX-XXXX-XXXX		PUBLIC WORKS DEPARTMENT	TITLE					
, I	DATE	No.	REVISION	BY		DATE			R.C.E. No.		
11					SANTA CLARA		INITIAL	DATE	Survey No.		
Ш					BIKEWAY IMPROVEMENTS	DESIGNED BY	RR/TC	05/23/25	TRACING N	10.	
					LAYOUT PLAN	DRAWN BY	AS/SD	05/23/25	YY Y	٧Y	$\mathbf{Y}_{-}\mathbf{Y}_{-}$
					LATOUTPLAN	CHECKED BY	MC/CW	05/23/25	///,/	\/\/	\-\
2					HORIZONTAL SCALE: 1 = 40'	AS BUILT BY			SHEET	17 OF	47

SCALE: 1"=40

#### CONSTRUCTION NOTES:

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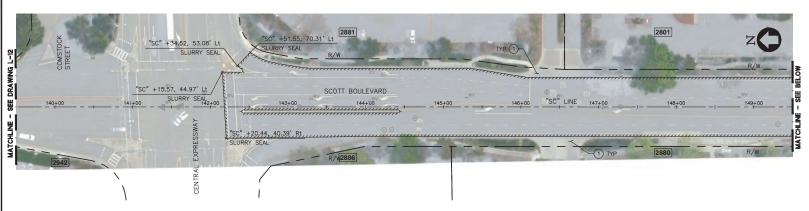









	PROJEC*	T No.	CE CE XX-XX-XX		CITY OF SANTA CLARA	APPROVED BY	′				
	ACCOUN	IT No.	XXX-XXXX-XXXX		PUBLIC WORKS DEPARTMENT	TITLE					
, I	DATE	No.	REVISION	BY		DATE			R.C.E. No.		
11					SANTA CLARA		INITIAL	DATE	Survey No.		
Ш					BIKEWAY IMPROVEMENTS	DESIGNED BY	RR/TC	05/23/25	TRACING	No.	
					LAYOUT PLAN	DRAWN BY	AS/SD	05/23/25	lyy '	XX'	$\mathbf{Y}_{-}\mathbf{Y}_{-}$
Ш					LATOUT PLAN	CHECKED BY	MC/CW	05/23/25	///,	^///	/\-/\
٥.					HORIZONTAL SCALE: 1 = 40'	AS BUILT BY			SHEET	18 OF	47



SCOTT BOULEVARD - PLAN SCALE: 1"=40"

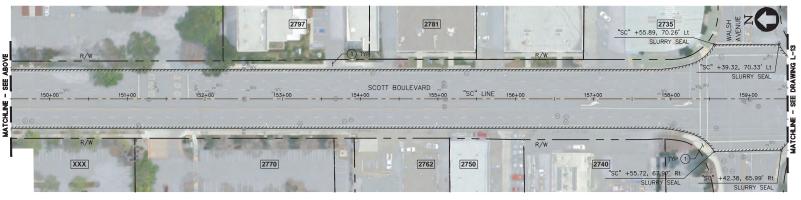

#### SCOTT BOULEVARD - PLAN

SCALE: 1"=40

#### CONSTRUCTION NOTES:

- $\bigodot$  (E) SIDEWALK, CURB, GUTTER, DRIVEWAY, CURB RAMP TO REMAIN.
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SLURRY SEAL (SEE NOTES 6, 7 & 8)

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- (E) STREET LIGHTING
- \_\_\_(E) SIGN

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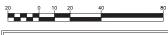
L-12

LOCATION OF R/W LINE WILL BE DETERMINED BY CITY IF NEEDED.











PROJEC	T No.	CE CE XX-XX-XX		CITY OF SANTA CLARA	APPROVED BY	1		
ACCOUN	CCOUNT No. XXX-XXXX-XXXX		PUBLIC WORKS DEPARTMENT	TITLE				
DATE	No.	REVISION	BY		DATE			R.C.E. No.
				SANTA CLARA		INITIAL	DATE	Survey No.
				BIKEWAY IMPROVEMENTS	DESIGNED BY	RR/TC	05/23/25	TRACING No.
				LAYOUT PLAN	DRAWN BY	AS/SD	05/23/25	$YY YYY_Y$
				LATOUTPLAN	CHECKED BY	MC/CW	05/23/25	///,/////·/
				HORIZONTAL SCALE: 1 = 40'	AS BUILT BY			SHEET 19 OF 47

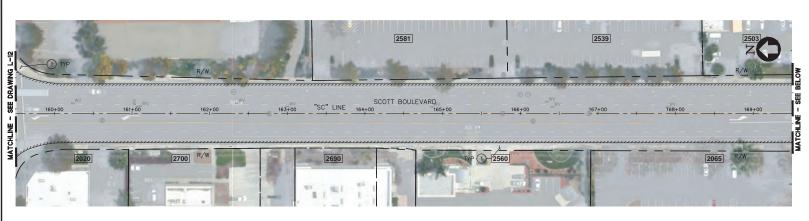

SCALE: 1"=40

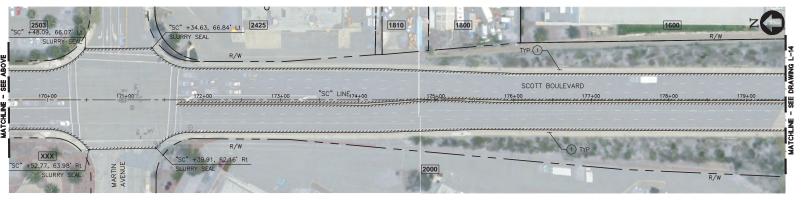

#### SCOTT BOULEVARD - PLAN

SCALE: 1"=40"

#### CONSTRUCTION NOTES:

- $\bigodot$  (E) SIDEWALK, CURB, GUTTER, DRIVEWAY, CURB RAMP TO REMAIN.
- 2 PROTECT IN PLACE.
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#### LEGEND:

SLURRY SEAL (SEE NOTES 6, 7 & 8)

--- RIGHT OF WAY/PROPERTY LINE

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L-13

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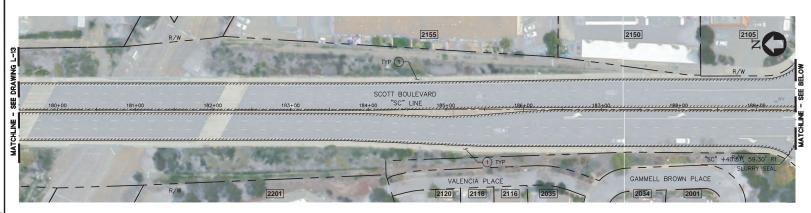
1730 N. FIRST STREET SUITE 600 SAN JOSE, CA 95112 408-467-9194 408-467-9100 (FAX)








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					LATOUT PLAN	CHECKED BY	MC/CW	05/23/25	$\mathcal{N}\mathcal{N},\mathcal{N}\mathcal{N}$	\/\-/
2					HORIZONTAL SCALE: 1 = 40'	AS BUILT BY			SHEET 20	OF 47



SCALE: 1"=40

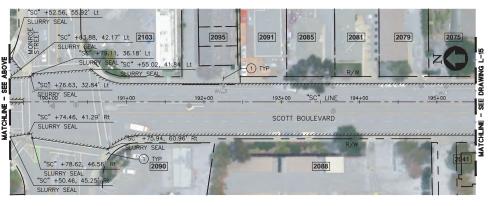

#### SCOTT BOULEVARD - PLAN

SCALE: 1"=40

#### CONSTRUCTION NOTES:

- $\bigodot$  (E) SIDEWALK, CURB, GUTTER, DRIVEWAY, CURB RAMP TO REMAIN.
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SLURRY SEAL (SEE NOTES 6, 7 & 8)

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  10. LOCATION OF R/W LINES ARE APPROXIMATE. ACTUAL

L-14

LOCATION OF R/W LINE WILL BE DETERMINED BY CITY IF NEEDED.










	PROJEC*	T No.	CE CE XX-XX-XX		CITY OF SANTA CLARA	APPROVED BY	′				
	ACCOUN	IT No.	XXX-XXXX-XXXX		PUBLIC WORKS DEPARTMENT	TITLE					
57	DATE	No.	REVISION	BY		DATE			R.C.E. No.		
1		П			SANTA CLARA		INITIAL	DATE	Survey No.		
					BIKEWAY IMPROVEMENTS	DESIGNED BY	RR/TC	05/23/25	TRACING No.		
					LAYOUT PLAN	DRAWN BY	AS/SD	05/23/25	yyy	VV	(_Y
JI I					LATOUTPLAN	CHECKED BY	MC/CW	05/23/25	////,//		<b>/-//</b>
2)					HORIZONTAL SCALE: 1 = 40'	AS BUILT BY			SHEET 21	OF	47

SCALE: 1"=40

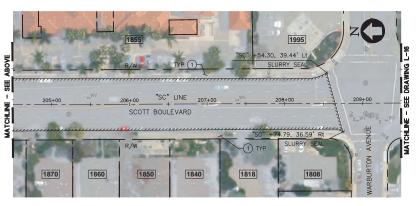

SCOTT BOULEVARD - PLAN

SCALE: 1"=40'

#### CONSTRUCTION NOTES:

- $\bigodot$  (E) SIDEWALK, CURB, GUTTER, DRIVEWAY, CURB RAMP TO REMAIN.
- 2 PROTECT IN PLACE.
- 3 MICROGRIND PAVEMENT MARKING/LANE LINE BEFORE INSTALL OF NEW STRIPING.
- (4) REMOVE ALL EXISTING DETAIL 9 REFLECTORS BEFORE INSTALL OF NEW STRIPING. TYPICAL WHERE THERE IS NO SLURRY SEAL.

#### LEGEND:



SLURRY SEAL (SEE NOTES 6, 7 & 8)

--- RIGHT OF WAY/PROPERTY LINE

- @ (E) STORM DRAIN MANHOLE
- ∃ (E) INLET
- @ (E) SANITARY SEWER MANHOLE
- O (E) TELEPHONE MANHOLE
- ⋈ (E) VALVE
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- 🕽 (E) JOINT POLE AND GUY WIRE
- (E) STREET LIGHTING
- (E) SIGN

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L-15

LOCATION OF R/W LINE WILL BE DETERMINED BY CITY IF NEEDED.




1730 N. FIRST STREET SUITE 600 SAN JOSE, CA 95112 408-467-9194 408-467-9100 (FAX)








	PROJEC*	T No.	CE CE XX-XX-XX		CITY OF SANTA CLARA	APPROVED BY	′			$\overline{}$
	ACCOUN	T No.	XXX-XXXX-XXXX		PUBLIC WORKS DEPARTMENT	TITLE				
57	DATE	No.	REVISION	BY		DATE			R.C.E. No.	
11					SANTA CLARA		INITIAL	DATE	Survey No.	
					BIKEWAY IMPROVEMENTS	DESIGNED BY	RR/TC	05/23/25	TRACING No.	
					LAYOUT PLAN	DRAWN BY	AS/SD	05/23/25	XX XXX	(_X
╝					LATOOT FLAN	CHECKED BY	MC/CW	05/23/25	///,/////	
_					HORIZONTAL SCALE: 1 = 40'	AS BUILT BY			SHEET 22 OF	47

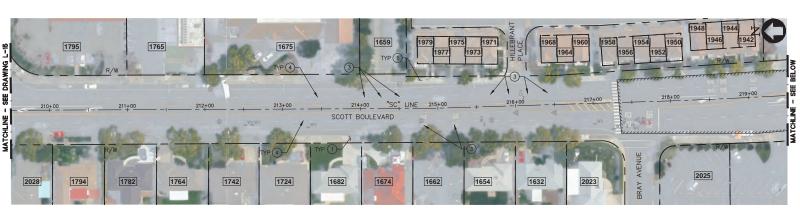

SCALE: 1"=40

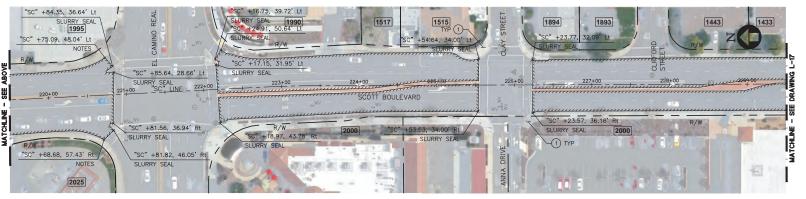

#### SCOTT BOULEVARD - PLAN

SCALE: 1"=40'

#### CONSTRUCTION NOTES:

- (E) SIDEWALK, CURB, GUTTER, DRIVEWAY, CURB RAMP TO REMAIN.
- 2 PROTECT IN PLACE.
- 3 MICROGRIND PAVEMENT MARKING/LANE LINE BEFORE INSTALL OF NEW STRIPING.
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#### LEGEND:

SLURRY SEAL (SEE NOTES 6, 7 & 8)

--- RIGHT OF WAY/PROPERTY LINE

- @ (E) STORM DRAIN MANHOLE
- ∃ (E) INLET
- @ (E) SANITARY SEWER MANHOLE
- O (E) TELEPHONE MANHOLE
- (E) FIRE HYDRANT
- □ (E) UTILITY BOX/VAULT
- A (E) MONUMENT
- (E) JOINT POLE AND GUY WIRE
- (E) STREET LIGHTING
- (E) SIGN

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  10. LOCATION OF R/W LINES ARE APPROXIMATE. ACTUAL

L-16


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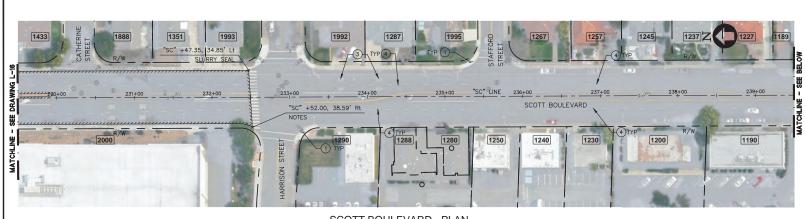
1730 N. FIRST STREET SUITE 600 SAN JOSE, CA 95112 408-467-9194 408-467-9100 (FAX)







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	PROJEC'	T No.	CE CE XX-XX-XX		CITY OF SANTA CLARA	APPROVED BY	r				
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, I	DATE	No.	REVISION	BY		DATE			R.C.E. No.		
11		П			SANTA CLARA		INITIAL	DATE	Survey No.		$\neg$
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_					HORIZONTAL SCALE: 1 = 40'	AS BUILT BY			SHEET 23	OF	47

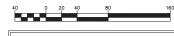

SCALE: 1"=40



#### SCOTT BOULEVARD - PLAN

SCALE: 1"=40'

#### CONSTRUCTION NOTES:

- (E) SIDEWALK, CURB, GUTTER, DRIVEWAY, CURB RAMP TO REMAIN.
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SLURRY SEAL (SEE NOTES 6, 7 & 8)

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L-17

LOCATION OF R/W LINE WILL BE DETERMINED BY CITY IF NEEDED.



1730 N. FIRST STREET SUITE 600 SAN JOSE, CA 95112 408-467-9194 408-467-9100 (FAX)







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	PROJEC*	T No.	CE CE XX-XX-XX		CITY OF SANTA CLARA	APPROVED BY	r				
	ACCOUN	IT No.	XXX-XXXX-XXXX-XXXX		PUBLIC WORKS DEPARTMENT	TITLE					
, I	DATE	No.	REVISION	BY		DATE			R.C.E. No.		
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Ш					LAYOUT PLAN	DRAWN BY	AS/SD	05/23/25	XX X	VΥ	′_Y
Ш					LATOUT PLAN	CHECKED BY	MC/CW	05/23/25	$\wedge \wedge, \wedge$	^/^	'-V
_					HORIZONTAL SCALE: 1 = 40'	AS BUILT BY			SHEET 24	OF	47

SCOTT BOULEVARD - PLAN SCALE: 1"=40

675 655 645 1992 743 733 727 723 713 703 685 683 673 665 663 653 "SC" LINE 262+00 260+00 263+00 SCOTT BOULEVARD MATCHLINE AVEN 744 742 734 732 724 2010 684 676 674 670 664 656 654 646 2015

> SCOTT BOULEVARD - PLAN SCALE: 1"=40

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SLURRY SEAL (SEE NOTES 6, 7 & 8)

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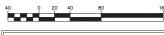
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L-18









	PROJEC*	T No.	CE CE XX-XX-XX		CITY OF SANTA CLARA	APPROVED BY	′			
	ACCOUN	IT No.	XXX-XXXX-XXXX		PUBLIC WORKS DEPARTMENT	TITLE				
.	DATE	No.	REVISION	BY		DATE			R.C.E. No.	
					SANTA CLARA		INITIAL	DATE	Survey No.	
Ш					BIKEWAY IMPROVEMENTS	DESIGNED BY	RR/TC	05/23/25	TRACING No.	
					LAYOUT PLAN	DRAWN BY	AS/SD	05/23/25	XX XX	/Y_Y
					LATOUT PLAN	CHECKED BY	MC/CW	05/23/25	$\wedge \wedge, \wedge \rangle$	\\-\\
2			·		HORIZONTAL SCALE: 1 = 40'	AS BUILT BY			SHEET 25	OF 47

SCALE: 1"=40"

#### CONSTRUCTION NOTES:

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L-19

LOCATION OF R/W LINE WILL BE DETERMINED BY CITY IF NEEDED.









PROJEC	T No.	CE CE XX-XX-XX		CITY OF SANTA CLARA	APPROVED BY	1		
ACCOUN	CCOUNT No. XXX-XXXX-XXXX		PUBLIC WORKS DEPARTMENT	TITLE				
DATE	No.	REVISION	BY		DATE			R.C.E. No.
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				LATOUT PLAN	CHECKED BY	MC/CW	05/23/25	///,////·//
				HORIZONTAL SCALE: 1 = 40'	AS BUILT BY			SHEET 26 OF 47

# BK 12025 - 9156am K\2024\2412



# **Construction Best Management Practices (BMPs)**

Construction projects are required to implement the stormwater best management practices (BMP) on this page, as they apply to your project, all year long.

Prevention Program
Clean Water. Healthy Community.

#### Materials & Waste Management



#### Non-Hazardous Material

- Berm and cover stockpiles of sand, dirt or other construction material with tarps when rain is forecast or if not actively being used within 14 days.
- ☐ Use (but don't overuse) reclaimed water for dust control.

#### Hazardous Materials

- Label all hazardous materials and hazardous wastes (such as pesticides, paints, thinners, solvents, fuel, oil, and antifreeze) in accordance with city, county, state and federal regulations.
- Store hazardous materials and wastes in water tight containers, store in appropriate secondary containment, and cover them at the end of every work day or during wet weather or when rain is forecast.
- □ Follow manufacturer's application instructions for hazardous materials and be careful not to use more than necessary. Do not apply chemicals outdoors when rain is forecast within 24 hours.
- ☐ Arrange for appropriate disposal of all hazardous wastes.

#### Waste Management

- Cover waste disposal containers securely with tarps at the end of every work day and during wet weather.
- Check waste disposal containers frequently for leaks and to make sure they are not overfilled. Never hose down a dumpster on the construction site.
- Clean or replace portable toilets, and inspect them frequently for leaks and spills.
- Dispose of all wastes and debris properly. Recycle materials and wastes that can be recycled (such as asphalt, concrete, aggregate base materials, wood, gyp board, pipe, etc.)
- Dispose of liquid residues from paints, thinners, solvents, glues, and cleaning fluids as hazardous waste.

#### Construction Entrances and Perimete

- Establish and maintain effective perimeter controls and stabilize all construction entrances and exits to sufficiently control erosion and sediment discharges from site and tracking off site.
- Sweep or vacuum any street tracking immediately and secure sediment source to prevent further tracking. Never hose down streets to clean up tracking.

#### Equipment Management & Spill Control



#### Maintenance and Parking

- Designate an area, fitted with appropriate BMPs, for vehicle and equipment parking and storage.
- Perform major maintenance, repair jobs, and vehicle and equipment washing off site.
- ☐ If refueling or vehicle maintenance must be done onsite, work in a bermed area away from storm drains and over a drip pan big enough to collect fluids. Recycle or dispose of fluids as hazardous waste.
- If yehiele or equipment cleaning must be done onsite, clean with water only in a bermed area that will not allow rinse water to run into gutters, streets, storm drains, or surface waters.
- Do not clean vehicle or equipment onsite using soaps, solvents, degreasers, steam cleaning equipment, etc.

#### Spill Prevention and Control

- ☐ Keep spill cleanup materials (rags, absorbents, etc.)
- ☐ Inspect vehicles and equipment frequently for and repair leaks promptly. Use drip pans to catch leaks until repairs are made.
- Clean up spills or leaks immediately and dispose of cleanup materials properly.
- Do not hose down surfaces where fluids have spilled. Use dry cleanup methods (absorbent materials, cat litter, and/or rags).
- Sweep up spilled dry materials immediately. Do not try to wash them away with water, or bury them.
- Clean up spills on dirt areas by digging up and properly disposing of contaminated soil.
- □ Report significant spills immediately. You are required by law to report all significant releases of hazardous materials, including oil. To report a spill: 1) Dial 911 or your local emergency response number, 2) Call the Governor's Office of Emergency Services Warning Center, (800) 852-7550 (24 hours).

#### Earthwork & Contaminated Soils



#### **Erosion Control**

- Schedule grading and excavation work for dry weather only.
- ☐ Stabilize all denuded areas, install and maintain temporary crossion controls (such as crossion control fabric or bonded fiber matrix) until vegetation is established.
- Seed or plant vegetation for crosion control on slopes or where construction is not immediately planned.

#### Sediment Control

- Protect storm drain inlets; gutters, ditches, and drainage courses with appropriate BMPs; such as gravel hags, fiber rolls, berms, etc.
- Prevent sediment from migrating offsite by installing and maintaining sediment controls, such as fiber rolls, silt fences, or sediment basins.
- Keep excavated soil on the site where it will not collect into the street.
- Transfer excavated materials to dump trucks on the site, not in the street.
- ☐ Contaminated Soils
- If any of the following conditions are observed, test for contamination and contact the Regional Water Quality Control Board:
  - Unusual soil conditions, discoloration, or odor.
  - Abandoned underground tanks
     Abandoned wells
  - Buried barrels, debris, or trash.

#### Paving/Asphalt Work



- Avoid paving and seal coating in wet weather, or when rain is forecast before fresh pavement will have time to cure.
- Cover storm drain inlets and manholes when applying seal coat, tack coat, slurry seal, fog seal, etc.
- ☐ Collect and recycle or appropriately dispose of excess abrasive gravel or sand. Do NOT sweep or wash it into gutters.
- Do not use water to wash down fresh asphalt concrete pavement.

#### hitches Sawcutting & Asphalt/Concrete Removal

- ☐ Completely cover or barricade storm drain inlets when saw cutting. Use filter fabric, eatch basin inler filters, or gravel bags to keep slurry out of the storm drain sestem.
- □ Shovel, abosorb, or vacuum saw-cut slurry and dispose of all waste as soon as you are finished in one location or at the end of each work day (whichever is sooner!).
- ☐ If sawcut slurry enters a catch basin, clean it up immediately.

#### Concrete, Grout & Mortar Application



- Store concrete, grout and mortar under cover, on pallets and away from drainage areas. These materials must never reach a storm drain.
- □ Wash out concrete equipment/trucks offsite or in a contained area, so there is no discharge into the underlying soil or onto surrounding areas. Let concrete harden and dispose of as garbage.
- Collect the wash water from washing exposed aggregate concrete and remove it for appropriate disposal offsite.

#### Dewatering



- ☐ Effectively manage all run-on, all runoff within the site, and all runoff that discharges from the site. Divert run-on water from offsite away from all disturbed areas or otherwise ensure compliance.
- □ When dewatering, notify and obtain approval from the local municipality before discharging water to a street gutter or storm drain. Filtration or diversion through a basin, tank, or sediment trap may be required.
- ☐ In areas of known contamination, testing is required prior to reuse or discharge of groundwater. Consult with the Engineer to determine whether testing is required and how to interpret results, Contaminated groundwater must be treated or hadled off-site for proper disposal.

#### Painting & Paint Removal



#### Painting cleanup

- Never clean brushes or rinse paint containers into a street, gutter, storm drain, or surface waters,
- ☐ For water-based paints, paint out brushes to the extent possible. Rinse to the sanitary sewer once you have gained permission from the local wastewater treatment authority. Never pour paint down a frain.
- ☐ For oil-based paints, paint out brushes to the extent possible and clean with thinner or solvent in a proper container. Filter and reuse thinners and solvents. Dispose of residue and unusable thinner/solvents as hazardous waste.

#### Paint removal

- Chemical paint stripping residue and chips and dust from marine paints or paints containing lead or tributyltin must be disposed of as hazardous waste.
- ☐ Paint chips and dust from non-hazardous dry stripping and sand blasting may be swept up or collected in plastic drop cloths and disposed of as trash.

#### Landscape Materials



- Contain stockpiled landscaping materials by storing them under tarps when they are not actively being used.
- ☐ Stack erodible landscape material on pallets. Cover or store these materials when they are not actively being used or applied.
- □ Discontinue application of any erodible landscape material within 2 days before a forecast rain event or during wet weather.

# Storm drain polluters may be liable for fines of up to \$10,000 per day!

WPC-1



1730 N. FIRST STREET SUITE 600 SAN JOSE, CA 95112 408-467-9194 408-467-9100 (FAX)



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	F	PROJEC	T No.	CE CE XX-XX-XX		CITY OF SANTA CLARA	APPROVED BY	′				
	1	ACCOUN	IT No	. XXX-XXXX-XXXX		PUBLIC WORKS DEPARTMENT	TITLE					
_	Г	DATE	No.	REVISION	BY		DATE			R.C.E. No.		
7	Г					SANTA CLARA		INITIAL	DATE	Survey No.		
I						BIKEWAY IMPROVEMENTS	DESIGNED BY	RR/TC	05/23/25	TRACING No.		
I	Г					CONSTRUCTION BMPS	DRAWN BY	AS/SD	05/23/25	yy y	٧V	(_)
I	Г					CONSTRUCTION BINES	CHECKED BY	MC/CW	05/23/25	////,//	/\/	<b>\</b> -/
_,	П					HORIZONTAL SCALE: N.T.S. VERTICAL SCALE: N.T.S.	AS BUILT BY			SHEET 27	OF	47

#### ALL STRIPING, MARKINGS AND SIGNAGE INSTALLATION TO BE PERFORMED BY CONTRACTOR UNLESS NOTED OTHERWISE. IGIN LOCATION SHOWN IS APPROXIMATE. EXACT LOCATION TO BE DETERMINED BY CITY ENGINEER.

- ALL ARROWS CLOSEST TO LIMIT OR CROSSWALK LINE SHALL BE INSTALLED 10' FROM LIMIT OR CROSSWALK LINE.
- ALL PAVEMENT STRIPING AND MARKING SHALL BE THERMOPLASTIC. ALL RAISED PAVEMENT MARKERS SHALL BE RETROREFLECTIVE AND SHALL BE 3M TYPE 290 SERIES OR APPROVED.

SIGNING AND STRIPING NOTES (SHEETS PD-1 THROUGH PD-5 ONLY):


- INSTALL BLUE RAISED PAVEMENT MARKER AT 6" OFFSET FROM LANE STRIPING AT ALL FIRE HYDRANTS.
- 6. ALL STRIPING AND MARKING REMOVAL TO BE PERFORMED BY THE CONTRACTOR PER THE CITY OF SANTA CLARA STANDARD SPECIFICATIONS. ALL STRIPING AND MARKING THAT ARE IN CONFLICT WITH THE NEW INSTALLATION MUSTS BE REMOVED BY THE CONTRACTOR. ALL OTHER EXISTING STRIPING AND PAVEMENT MARKINGS MUST BE REINSTALLED BACK TO THEIR ORIGINAL CONFIGURATION PRIOR TO COMPLETION OF WORK.
- ALL PAVEMENT MARKING, STRIPING LAYOUT (CAT-TRACKING) AND TEMPORARY STRIPING SHALL BE DONE BY THE CONTRACTOR PRIOR PLACEMENT
- UNLESS INDICATED OTHERWISE, ALL STRIPING, MARKING AND SIGN TYPES SHOWN ON THIS PLAN ARE PER THE 2014 CA MUTCO REVISION 9 AND THE 2024 CALTRANS STANDARD PLANS, SPECIFICATIONS, AND REVISED STANDARD PLANS (RSP).
- 9. THE WIDTH OF THE CROSSWALK SHALL BE MEASURED FROM CENTER OF STRIPING ON ONE SIDE TO CENTER OF STRIPING ON THE OTHER SIDE.
- NUMBER ONE LANE DIMENSIONS SHALL BE MEASURED FROM MEDIAN FACE OF CURB TO CENTER OF STRIPING WHERE MEDIAN IS PRESENT; OTHERWISE LANE DIMENSIONS SHALL BE MEASURED FROM CENTER OF STRIPING TO CENTER OF STRIPING.
- CENTER LANE DIMENSIONS SHALL BE MEASURED FROM CENTER OF STRIPING TO CENTER OF STRIPING.
- 12. WHERE BIKE LANE IS NEXT TO FACE OF CURB, BIKE LANE DIMENSIONS SHALL BE MEASURED FROM CENTER OF STRIPING TO FACE OF CURB.
- 13. WHERE BIKE LANE IS NOT PRESENT NEXT TO FACE OF CURB, CURB LANE DIMENSIONS SHALL BE MEASURED FROM CENTER OF STRIPING TO FACE OF CURB.

# DETAIL D PIANO KEY CROSSWALK STRIPING (SCHOOL) NTS

#### LEGEND (SHEETS PD-1 THROUGH PD-5 ONLY):

INSTALLATION OF PROPOSED SIGN ON EXISTING LIGHTING, SIGNAL OR SIGN POLE BY STRAP AND SADDLE BRACKET METHOD i-1--a INSTALLATION OF PROPOSED SIGN WITH NEW 2" STEEL SIGN POLE PROPOSED / EXISTING SIGN ON EXISTING POLE PROPOSED ROADSIDE SIGN ON EXISTING POST/POLE REMOVE EXISTING SIGN ON EXISTING POLE EXISTING ROADSIDE SIGN TO REMAIN INSTALL 3'X3' TYPE D BIKE LOOP INSTALL 6'X6' TYPE D LOOP DETECTOR P7/7/7/7/7/ RECONFIGURE VIDEO DETECTION AREA (27B) STRIPE DETAIL NUMBER DIRECTION OF TRAVEL FLEXIBLE DELINEATOR INSTALL PAVEMENT MARKING WORDS PER CALTANS STD PLAN A24E INSTALL PAVEMENT MARKING WORDS PER CALTANS STD PLAN A24E INSTALL PAVEMENT MARKING WORDS PER CALTANS STD PLAN A24D INSTALL PAVEMENT MARKING WORDS PER CALTANS STD PLAN A24D INSTALL PAVEMENT MARKING WORDS PER CALTANS STD PLAN A24D | >< | INSTALL PAVEMENT MARKING SYMBOL PER CALTANS STD PLAN A24B INSTALL BICYCLE LOOP DETECTOR SYMBOL PER CALTANS STD PLAN A24C INSTALL BIKE LANE SYMBOL WITH PERSON AND BIKE LANE ARROW PER CALTANS STD PLAN A24A AND A24C INSTALL PAVEMENT MARKING SYMBOL PER CALTANS STD PLAN A24D INSTALL PAVEMENT MARKING SYMBOL PER CALTANS STD PLAN A24D

INSTALL SHARED ROADWAY BICYCLE MARKING PER CALTANS STD PLAN A24C

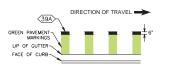


DETAIL A


GREEN BIKE LANE PAVEMENT MARKING (TYP.)

NTS



DETAIL E YIELD LINE NTS

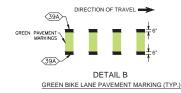


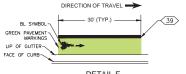


DETAIL F
BIKE SYMBOL WITH GREEN PAVEMENT ENHANCEMENT
NTS

#### ABBREVIATIONS (SHEETS PD-1 THROUGH PD-5 ONLY):

BL	BIKE LANE ARROW AND BIKE WITH PERSON SYMBOL
SR	SHARED LANE MARKING (SHARROW)
LTA	TYPE IV ARROW (LEFT)
RTA	TYPE IV ARROW (RIGHT)
L/RA	TYPE VIII ARROW (LEFT AND RIGHT)
L/TA	TYPE VII ARROW (LEFT AND THROUGH)
R/TA	TYPE VII ARROW (RIGHT AND THROUGH)
LMA	TYPE VI ARROW (LEFT MERGE LANE)
RR	RAILROAD CROSSING SYMBOL
SNS	STREET NAME SIGN
NTS	NOT TO SCALE
O.C.	ON CENTER

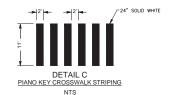

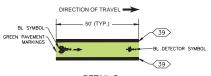


DETAIL G GREEN BIKE LANE WITH BIKE SYMBOL AND BIKE DETECTOR SYMBOL NTS


PD-1






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	DATE	No.	REVISION	BY		DATE			R.C.E. No.	
					LICK MILL BLVD		INITIAL	DATE	Survey No.	
					BIKEWAY IMPROVEMENTS	DESIGNED BY	TM/AD	05/22	TRACING No.	
						DRAWN BY	TM	05/22	$  yy yyy_y$	
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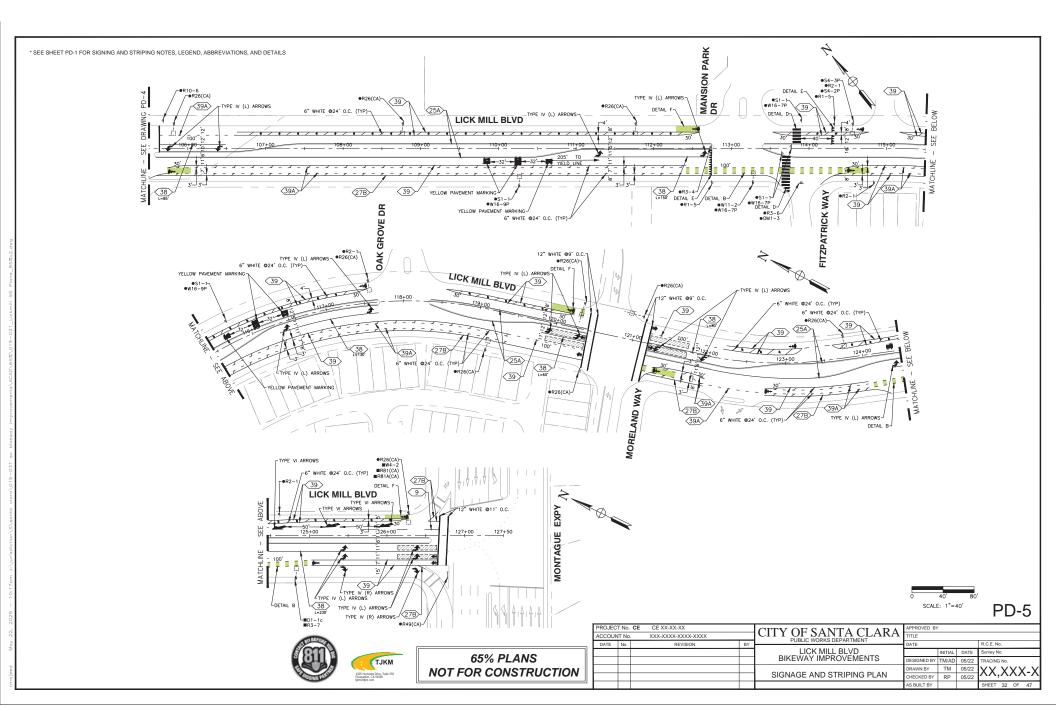


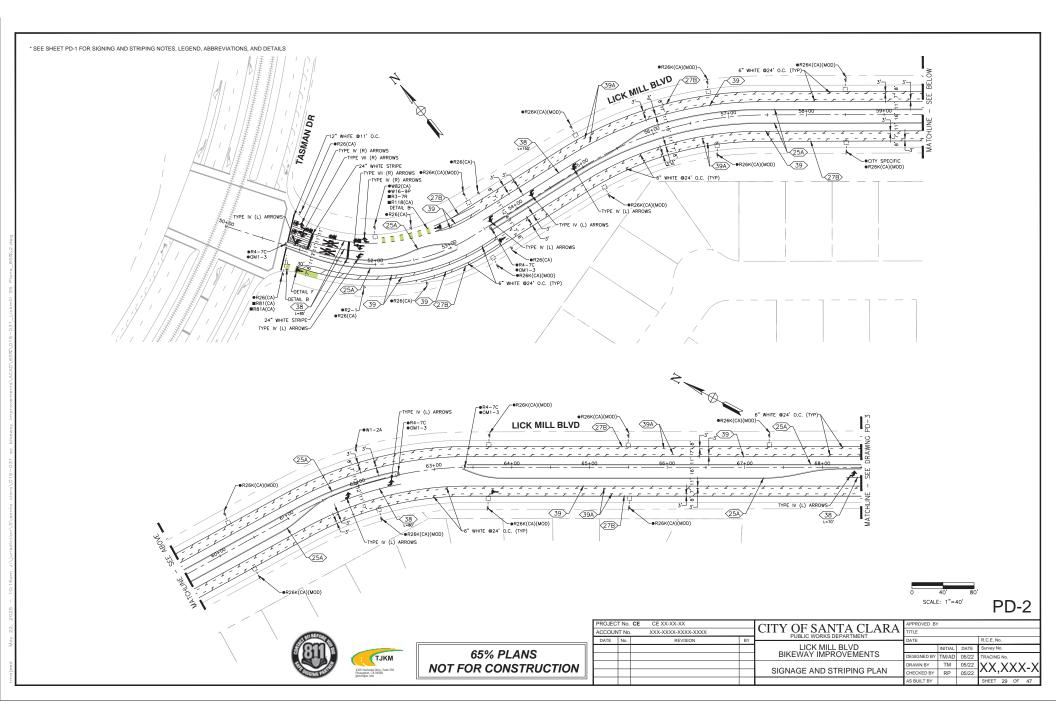

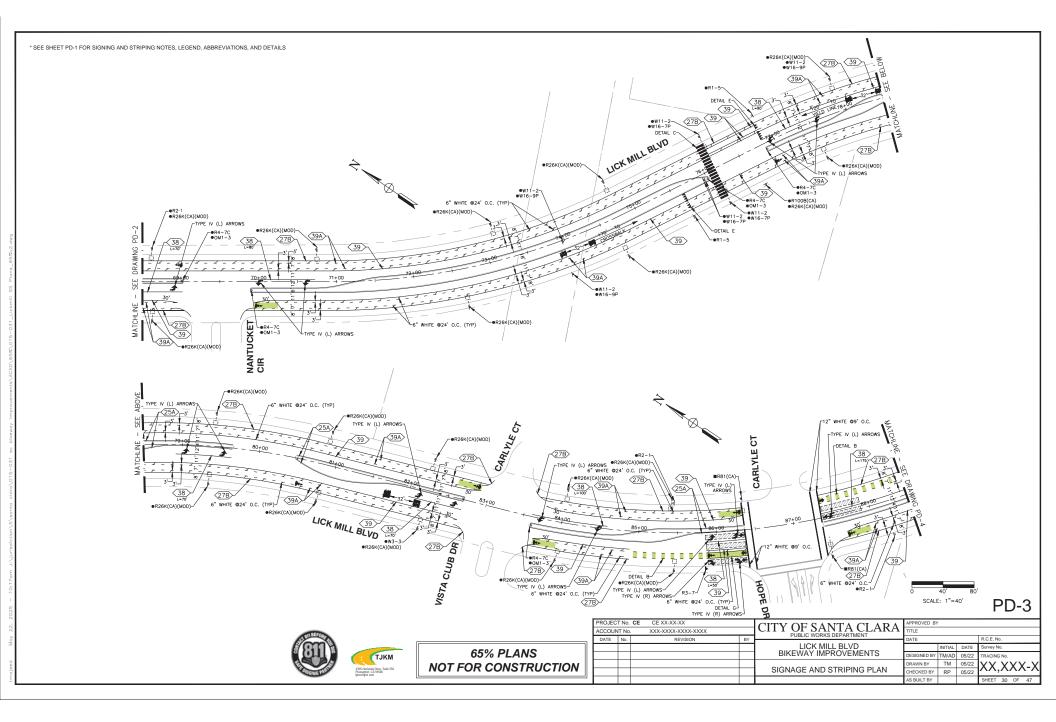

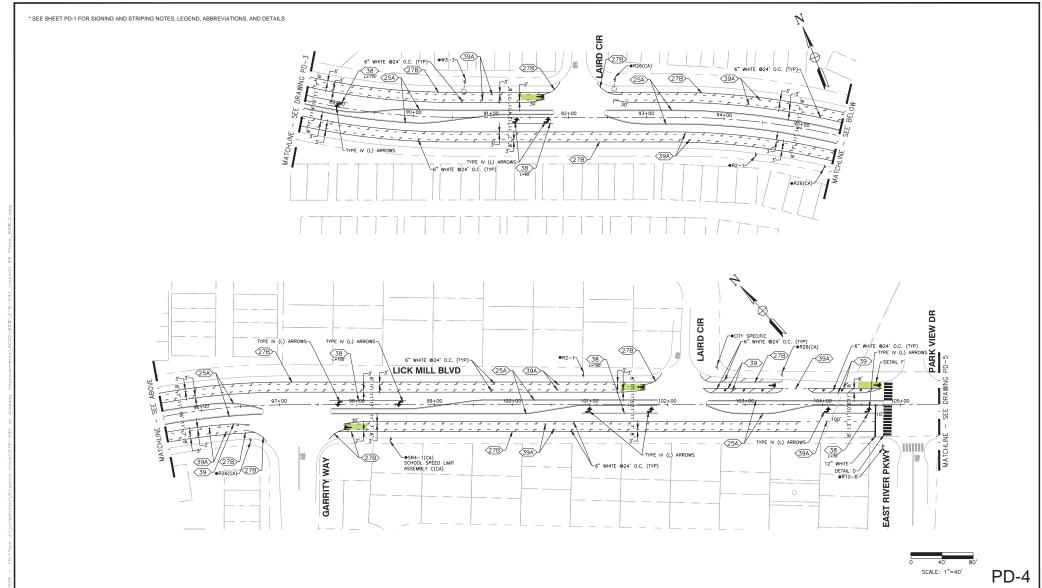


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1



◆ASSEMBLY C (CA)

-YELLOW PAVEMENT MARKING

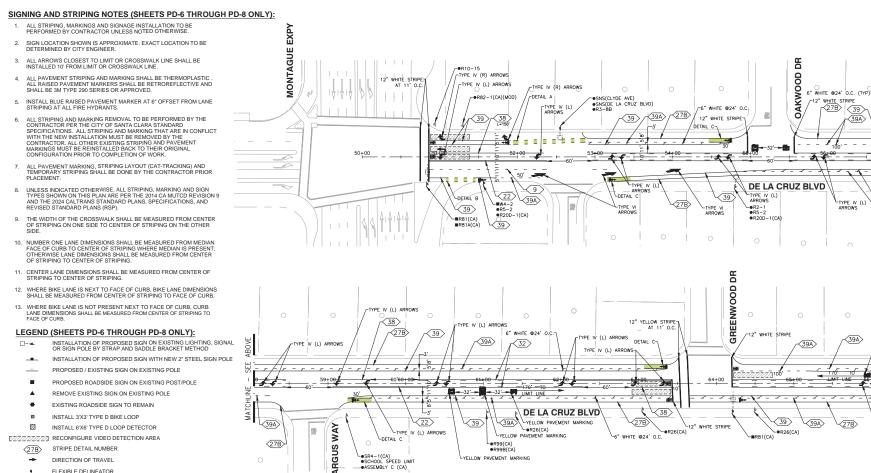BL SYMBOL

65% PLANS

GREEN PAVEMENT

DIRECTION OF TRAVEL

DETAIL C
BIKE SYMBOL WITH GREEN PAVEMENT ENHANCEMENT


DIRECTION OF TRAVEL FLEXIBLE DELINEATOR 112

INSTALL PAVEMENT MARKING WORDS PER CALTANS STD PLAN A24E INSTALL PAVEMENT MARKING WORDS PER CALTANS STD PLAN A24E

INSTALL PAVEMENT MARKING WORDS PER CALTANS STD PLAN A24D INSTALL PAVEMENT MARKING WORDS PER CALTANS STD PLAN A24D

INSTALL PAVEMENT MARKING WORDS PER CALTANS STD PLAN A24D INSTALL PAVEMENT MARKING SYMBOL PER CALTANS STD PLAN A24C

INSTALL BIKE LANE SYMBOL WITH PERSON AND BIKE LANE ARROW PER CALTANS STD PLAN A24A AND A24C

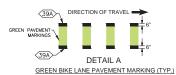



DIRECTION OF TRAVEL

DETAIL B
BIKE SYMBOL WITH GREEN PAVEMENT ENHANCEMENT

NTS

BL SYMBOL

MARKINGS

GREEN PAVEMENT

LIP OF GUTTER-

FACE OF CURB

PROJEC	T No.	CE CE XX-XX-XX			APPROVED BY						
				CITY OF SANTA CLARA							
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				SIGNAGE AND STRIPING PLAN	CHECKED BY	RP	05/22	///,///// //			
					AS BUILT BY			SHEET 33 OF 47			

39>

-BL DETECTOR SYMBOL

DIRECTION OF TRAVEL

DETAIL D
GREEN BIKE LANE WITH BIKE SYMBOL AND BIKE DETECTOR SYMBOL

BL SYMBOL

GREEN PAVEMENT MARKINGS

√39A>

(39A)

-YELLOW PAVEMENT MARKING

-R99(CA)

●R99B(CA)

(27B)

-6" WHITE @24"

YELLOW PAVEMENT MARKING

YPE IV (L) ARROWS

SCALE: 1"=40

PD-6


<39A>

**32** 

27B 39

<39A)

(39A)

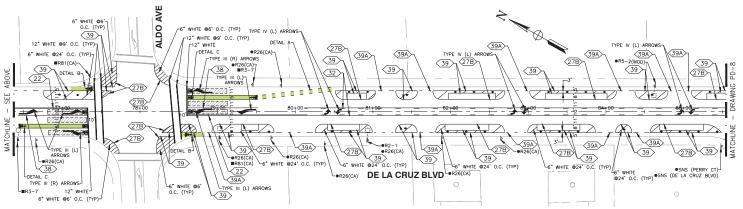




PD-7





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					DE LA CRUZ BLVD		INITIAL	DATE	Survey No.	
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					SIGNAGE AND STRIPING PLAN	CHECKED BY	RP	05/22	///,/////·//	
_						AS BUILT BY			SHEET 34 OF 47	

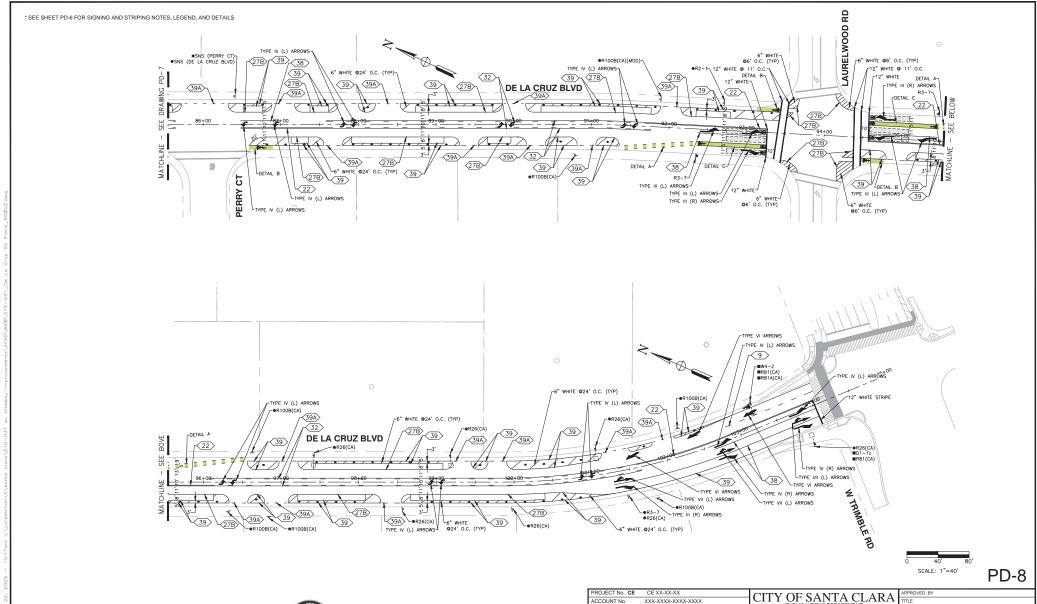

65% PLANS

**NOT FOR CONSTRUCTION** 

TJKM

ACCOUNT No

XXX-XXXX-XXXX-XXXX

DE LA CRUZ BLVD BIKEWAY IMPROVEMENTS

SIGNAGE AND STRIPING PLAN

INITIAL DATE Survey No.

DRAWN BY TM 05/22 XX, XXX-X

TRACING NO

DESIGNED BY TM/AD 05/22

CHECKED BY RP 05/22

#### PROJECT NOTES (SHEETS PD-09 TO PD-20 ONLY):

- 1. ALL ROADSIDE SIGNS, PAVEMENT MARKINGS, AND STRIPING ARE BASED ON THE 2014 CALIFORNIA MUTCD REVISION 9 AND THE 2024 CALTRANS STANDARD PLANS, SPECIFICATIONS, AND REVISED STANDARD PLANS (RSP).
- 2. PAVEMENT MARKINGS AND STRIPING ARE APPROXIMATE. EXACT LOCATION TO BE DETERMINED IN THE FIELD BY CONTRACTOR AND VERIFIED/ADJUSTED BY THE
- 3. CONTRACTOR SHALL REMOVE EXISTING PAVEMENT DELINEATION WHICH CONFLICT WITH THIS PLAN BY GRINDING PRIOR TO NEW STRIPING INSTALLATION.
- 4. SIGN LOCATION SHOWN IS APPROXIMATE. EXACT LOCATION TO BE DETERMINED IN THE FIELD BY CONTRACTOR AND VERIFIED/ADJUSTED BY THE CITY ENGINEER.
- 5. ALL ARROWS CLOSEST TO LIMIT OR CROSSWALK LINE SHALL BE INSTALLED 10' FROM LIMIT OR CROSSWALK LINE.
- 6. REPLACE RED CURB PAINT IMPACTED BY CONSTRUCTION.
- 7. ALL NEW AND RELOCATED SIGNS SHALL BE MOUNTED ON SQUARE METAL POSTS PER CITY DETAIL TR-10.
- 8. ALL PAVEMENT STRIPING AND MARKINGS SHALL BE THERMOPLASTIC. ALL RAISED PAVEMENT MARKINGS SHALL BE RETROREFLECTIVE AND SHALL BE 3M TYPE 290 SERIES OR APPROVED EQUAL. GREEN BIKE LANE PAVEMENT MARKING SHALL BE THERMOPLASTIC.
- 9. ALL STRIPING MEASUREMENTS ARE MEASURED CENTER TO CENTER, OR AT ROAD EDGES, FROM CENTER TO FACE OF CURB.

10. INSTALL BLUE RAISED PAVEMENT MARKER AS PER CA MUTCD FIGURE 3B-102 (CA).

#### LEGEND (SHEETS PD-09 TO PD-20 ONLY):

PAVEMENT DELINEATION DETAIL PER CALTRANS STANDARD PLANS No.

- NEW ROADSIDE SIGN AND POST TO BE INSTALLED
- EXISTING ROADSIDE SIGN
- ()--e EXISTING SIGN ON EXISTING STREET LIGHT POLE
- INSTALL NEW SIGN ON EXISTING STREET LIGHT POLE
- CHANGE OF PAVEMENT DELINEATION
- INSTALL GREEN PAVEMENT MARKING
- REMOVE EXISTING ROADSIDE SIGN

- REMOVE EXISTING ROADSIDE SIGN AND POLE
- EXISTING ROADSIDE SIGN TO REMAIN
- EXISTING ROADSIDE SIGN TO BE RELOCATED
- INSTALL NEW ROAD SIDE SIGN
- INSTALL BLUE FIRE HYDRANT REFLECTIVE MARKER
- BIKE LANE SYMBOL WITH PERSON
- BIKE LOOP DETECTOR SYMBOL
- FLEXIBLE DELINEATOR

AS SHOWN ON PLANS

(39A)

AS SHOWN TO PLANS

(39A)

\*\*\*\*\* YIELD LINE PER CALTRANS STANDARD DETAIL A24G

PAVEMENT MARKING. SEE CALTRANS STANDARD PLANS FOR DETAILS

BACK OF WALK

FACE OF CURB LIP OF GUTTER

GREEN PAVEMENT BIKE LANE MARKING

GREEN PAVEMENT BIKE LANE MARKING

SOLID 24" WHITE

39

ON PLANS

PD-9

DIRECTION OF TRAVEL

DIRECTION OF TRAVEL

DETAIL A

DETAIL B


- 45° DIAGONAL 6" WHITE

DETAIL D

- INSTALL 3'X3' TYPE D LOOP DETECTOR
- INSTALL 6'X6' TYPE D LOOP DETECTOR
- INSTALL 6' TYPE E LOOP DETECTOR
- IIIIIII RECONFIGURE VIDEO DETECTION AREA




SCOTT BOULEVARD - PLAN SCALE: 1"=40

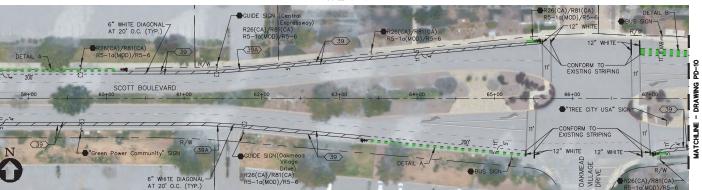

SCOTT BOULEVARD - PLAN

SCALE: 1"=40'



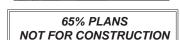

ROJEC	ΓNo.	CE CE XX-XX-XX		CITY OF SANTA CLARA	APPROVED BY						
CCOUN	CCOUNT No. XXX-XXXX-XXXX			PUBLIC WORKS DEPARTMENT	TITLE						
DATE	No.	REVISION	BY		DATE	R.C.E. No.					
				SANTA CLARA		INITIAL	DATE	Survey No	).		
				BIKEWAY IMPROVEMENTS	DESIGNED BY	RR/TC	05/23/25	TRACING	No.		
				PAVEMENT DELINEATION PLAN	DRAWN BY	AS/SD	05/23/25	ΥY	ΥY	Y - Y	
				PAVEINENT DELINEATION PLAN	CHECKED BY	MC/CW	05/23/25	$\wedge \wedge$ ,	$^{\prime\prime}$	\-\	
				HORIZONTAL SCALE: 1 = 40'	AS BUILT BY			SHEET	36 OI	F 47	


20'-

1730 N. FIRST STREET SUITE 600 SAN JOSE, CA 95112 408-467-9194

408-467-9100 (FAX)

#### SCOTT BOULEVARD - PLAN

SCALE: 1"=40'

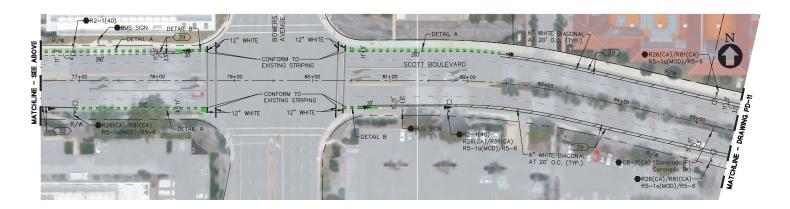


#### SCOTT BOULEVARD - PLAN

SCALE: 1"=40'







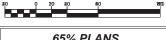


65% PLANS
NOT FOR CONSTRUCTION

PRO	OJECT	ΓNo.	CE CE XX-XX-XX		CITY OF SANTA CLARA	APPROVED BY	APPROVED BY				
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					SANTA CLARA		INITIAL	DATE	Survey No.		
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					PAVEMENT DELINEATION PLAN	DRAWN BY	AS/SD	05/23/25	XX XXX_X		
					PAVEINENT DELINEATION FLAN	CHECKED BY	MC/CW	05/23/25	///,///// //		
					HORIZONTAL SCALE: 1 = 40'	AS BUILT BY			SHEET 37 OF 47		


PD-10

shiwakoti May 23, 2025 — 12:42pm \\bkf-sj\vol4\2024\241253\_santa\_clara\_bikeways\_improvements\ENG-T\Sheets\08\_PD-09

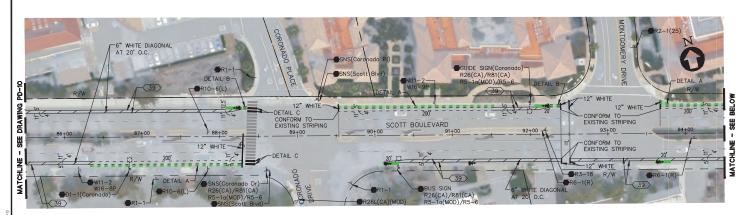

SCOTT BOULEVARD - PLAN

SCALE: 1"=40'

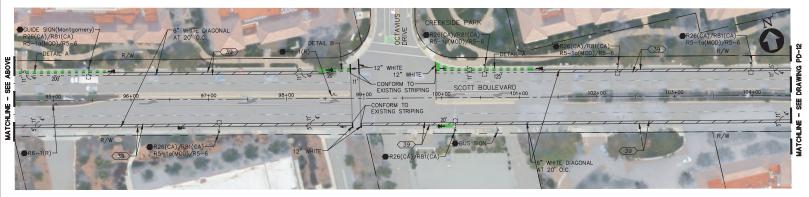

SCOTT BOULEVARD - PLAN

SCALE: 1"=40'



1730 N. FIRST STREET SUITE 600 SAN JOSE, CA 95112 408-467-9194 408-467-9100 (FAX)








65% PLANS NOT FOR CONSTRUCTION

	PROJECT No. CE CE XX-XX-XX				CITY OF SANTA CLARA	APPROVED BY	APPROVED BY					
	ACCOUN	IT No.	XXX-XXXX-XXXX		PUBLIC WORKS DEPARTMENT	TITLE	TITLE					
_	DATE	No.	REVISION	BY		DATE			R.C.E. No.			
1					SANTA CLARA		INITIAL	DATE	Survey No.			
					BIKEWAY IMPROVEMENTS	DESIGNED BY	RR/TC	05/23/25	TRACING No.			
					PAVEMENT DELINEATION PLAN	DRAWN BY	AS/SD	05/23/25	$  yy yyy_y $			
					PAVEINENT DELINEATION FEAN	CHECKED BY	MC/CW	05/23/25	///,///////////////////////////////////			
					HORIZONTAL SCALE: 1 = 40'	AS BUILT BY			SHEET 38 OF 47			

PD-11

rshiwakoti May 23, 2025 — 12:43pm \\bkf-sj\vol4\2024\241253\_santa\_clara\_bikeways\_improvem

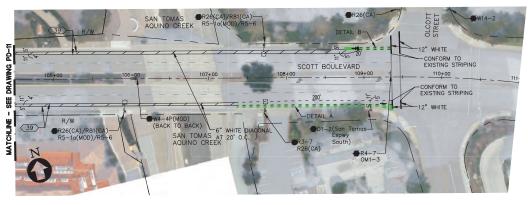

SCOTT BOULEVARD - PLAN

SCALE: 1"=40'










65% PLANS NOT FOR CONSTRUCTION

PROJEC	T No.	CE CE XX-XX-XX		CITY OF SANTA CLARA	APPROVED BY	APPROVED BY					
ACCOUN	CCOUNT No. XXX-XXXX-XXXX		PUBLIC WORKS DEPARTMENT	TITLE							
DATE	No.	REVISION	BY		DATE			R.C.E. No.			
				SANTA CLARA		INITIAL	DATE	Survey No.			
				BIKEWAY IMPROVEMENTS	DESIGNED BY	RR/TC	05/23/25	TRACING No.			
				PAVEMENT DELINEATION PLAN	DRAWN BY	AS/SD	05/23/25	$YY YYY_Y$			
				PAVEINENT DELINEATION FLAN	CHECKED BY	MC/CW	05/23/25	///,///// //			
				HORIZONTAL SCALE: 1 = 40'	AS BUILT BY			SHEET 39 OF 47			


PD-12

rshiwakoti May 23, 20

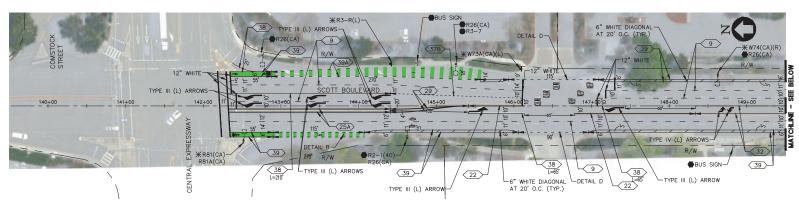

SCOTT BOULEVARD - PLAN

SCALE: 1"=40'

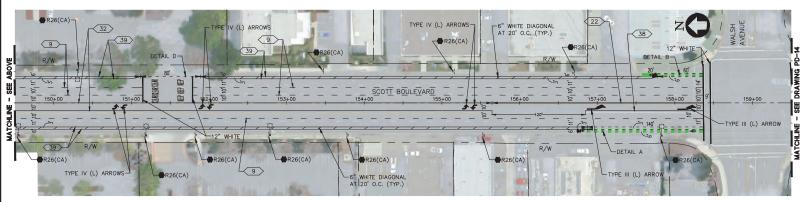

SCALE: 1"=40'





1730 N. FIRST STREET SUITE 600 SAN JOSE, CA 95112 408-467-9194 408-467-9100 (FAX)








65% PLANS NOT FOR CONSTRUCTION


PROJE	CT No.	CE CE XX-XX-XX		CITY OF SANTA CLARA	APPROVED BY					
ACCOL	OUNT No. XXX-XXXX-XXXX		PUBLIC WORKS DEPARTMENT	TITLE						
DATE	No.	REVISION	BY		DATE			R.C.E. No.		
				SANTA CLARA BIKEWAY IMPROVEMENTS		INITIAL	DATE	Survey No.		
					DESIGNED BY	RR/TC	05/23/25	TRACING No.		
				LAYOUT PLAN	DRAWN BY	AS/SD	05/23/25	$XX XXX_X$		
				LATOOT FLAN	CHECKED BY	MC/CW	05/23/25	///,///// //		
				HORIZONTAL SCALE: 1 = 40'	AS BUILT BY			SHEET 40 OF 47		

PD-13

rshiwakoti May 23, 2025 - 12:44pm \\bkf-sj\vol4\2024\241253\_santa\_clara\_bikeways\_improvements\ENG-

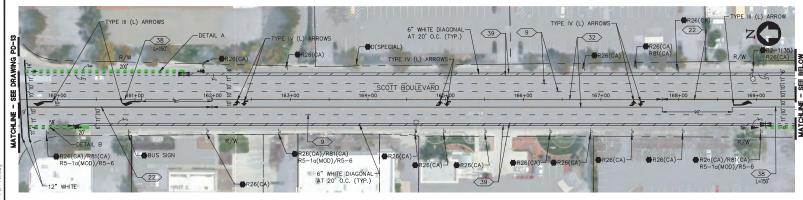

# SCOTT BOULEVARD - PLAN SCALE: 1"=40'

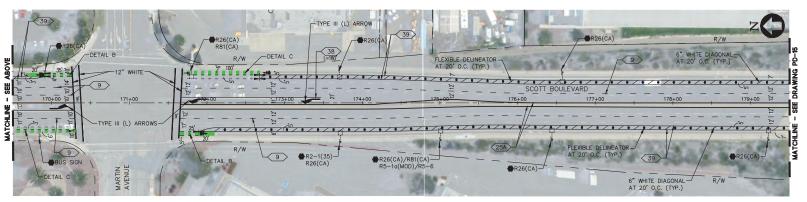

# SCOTT BOULEVARD - PLAN SCALE: 1"=40'











65% PLANS NOT FOR CONSTRUCTION

Γ	PROJEC'	T No.	CE CE XX-XX-XX		CITY OF SANTA CLARA	APPROVED BY					
I	ACCOUN	COUNT No. XXX-XXXX-XXXX		PUBLIC WORKS DEPARTMENT	TITLE						
I	DATE	No.	REVISION	BY		DATE			R.C.E. No.		
I					SANTA CLARA BIKEWAY IMPROVEMENTS		INITIAL	DATE	Survey No.		
I						DESIGNED BY	RR/TC	05/23/25	TRACING No.		
Γ					LAVOUT DLAN	DRAWN BY	AS/SD	05/23/25	$YY YYY_Y$		
L					LAYOUT PLAN	CHECKED BY	MC/CW	05/23/25	$\mathcal{N}_{\mathcal{N}}}}}}}}}}$		
Ι					HORIZONTAL SCALE: 1 = 40'	AS BUILT BY			SHEET 41 OF 47		

PD-14

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SCOTT BOULEVARD - PLAN

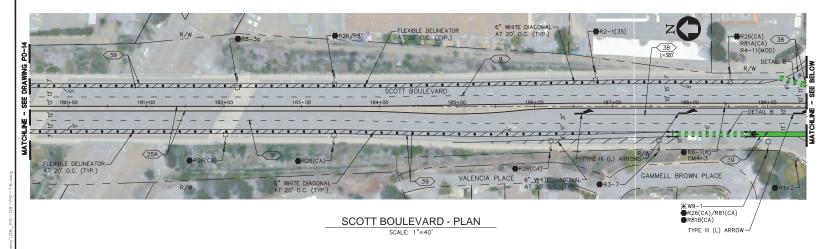SCALE: 1"=40'

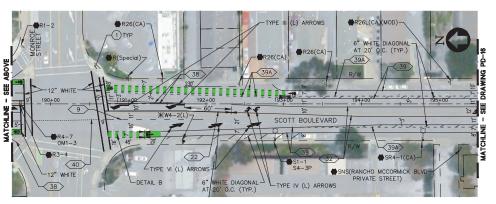








65% PLANS NOT FOR CONSTRUCTION


U	PRO	ROJECT No. CE CE XX-XX-XX			ECT NO. CE CE XX-XX-XX  UNIT NO. YYX-YYYY-YYYY  CITY OF SANTA CLARA			APPROVED BY					
	ACC	COUN	T No.	XXX-XXXX-XXXX		PUBLIC WORKS DEPARTMENT	TITLE						
_	DA	ATE	No.	REVISION	BY		DATE			R.C.E. No.			
						SANTA CLARA		INITIAL	DATE	Survey No.			
Ш						BIKEWAY IMPROVEMENTS	DESIGNED BY	RR/TC	05/23/25	TRACING No.			
Ш						LAYOUT PLAN	DRAWN BY	AS/SD	05/23/25	XX XXX_X			
						LATOUT FLAN	CHECKED BY	MC/CW	05/23/25	$\mathcal{N}_{\mathcal{N},\mathcal{N},\mathcal{N}}$			
_						HORIZONTAL SCALE: 1 = 40'	AS BUILT BY			SHEET 42 OF 47			

PD-15

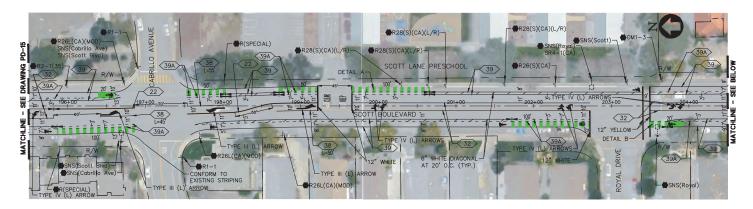

#### SCOTT BOULEVARD - PLAN

SCALE: 1"=40'

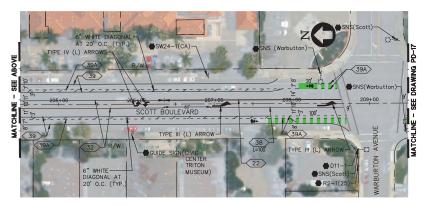

SCOTT BOULEVARD - PLAN

SCALE: 1"=40'



1730 N. FIRST STREET SUITE 600 SAN JOSE, CA 95112 408-467-9194 408-467-9100 (FAX)








65% PLANS NOT FOR CONSTRUCTION

I	PROJECT No. CE CE XX-XX-XX				CITY OF CANTA CLADA	APPROVED BY				
ı	ACCOUNT No. XXX-XXXX-XXXX				CITY OF SANTA CLARA	TITLE				
-[	DATE	No.	REVISION	BY		DATE			R.C.E. No.	
. [					SANTA CLARA		INITIAL	DATE	Survey No.	
- [					BIKEWAY IMPROVEMENTS	DESIGNED BY	RR/TC	05/23/25	TRACING No.	
-[					LAYOUT PLAN	DRAWN BY	AS/SD	05/23/25		
- 1					LATOUT FLAN	CHECKED BY	MC/CW	05/23/25	$\mathcal{N}_{\mathcal{N},\mathcal{N},\mathcal{N}}$	
					HORIZONTAL SCALE: 1 = 40'	AS BUILT BY			SHEET 43 OF 47	

PD-16

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# SCALE: 1"=40'

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SCOTT BOULEVARD - PLAN

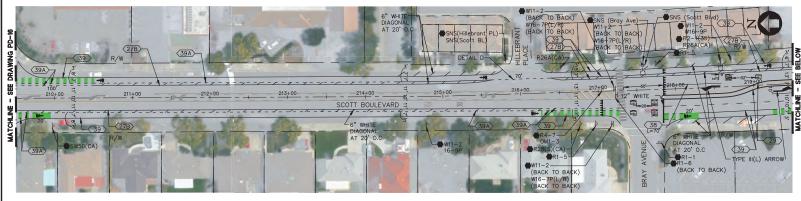SCALE: 1"=40'



1730 N. FIRST STREET SUITE 600 SAN JOSE, CA 95112 408-467-9194 408-467-9100 (FAX)








65% PLANS NOT FOR CONSTRUCTION

	PROJECT No. CE CE XX-XX-XX				CITY OF SANTA CLARA	APPROVED BY				
	ACCOUNT No.		XXX-XXXX-XXXX		PUBLIC WORKS DEPARTMENT	TITLE				
_	DATE	No.	REVISION	BY		DATE			R.C.E. No.	
7					SANTA CLARA		INITIAL	DATE	Survey No.	
					BIKEWAY IMPROVEMENTS	DESIGNED BY	RR/TC	05/23/25	TRACING No.	
					LAYOUT PLAN	DRAWN BY	AS/SD	05/23/25	lyy yyy₋yl	
					LATOUT PLAN	CHECKED BY	MC/CW	05/23/25	///,/////	
=1					HORIZONTAL SCALE: 1 = 40'	AS BUILT BY			SHEET 44 OF 47	


PD-17

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SCOTT BOULEVARD - PLAN

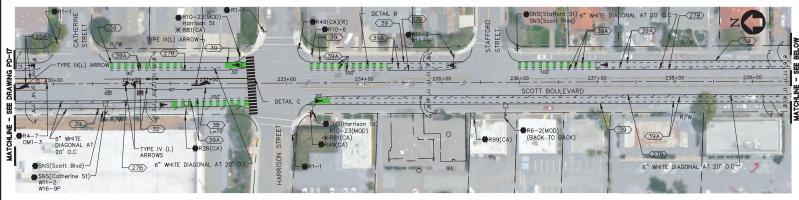SCALE: 1"=40'



SCOTT BOULEVARD - PLAN

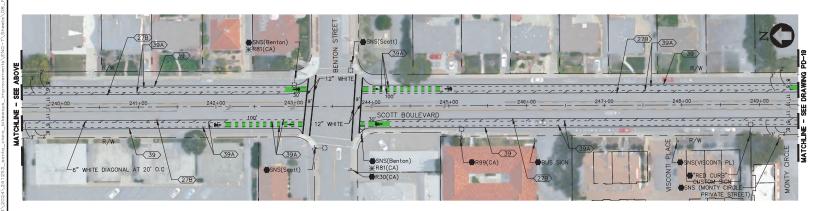
SCALE: 1"=40'



1730 N. FIRST STREET SUITE 600 SAN JOSE, CA 95112 408-467-9194 408-467-9100 (FAX)





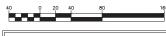


65% PLANS NOT FOR CONSTRUCTION


PROJECT No. CE CE XX-XX-XX					CITY OF SANTA CLARA	APPROVED BY				
I	ACCOUNT No. XXX-XXXX-XXXX				PUBLIC WORKS DEPARTMENT	TITLE				
I	DATE	No.	REVISION	BY		DATE			R.C.E. No.	
I					SANTA CLARA		INITIAL	DATE	Survey No.	
I					BIKEWAY IMPROVEMENTS	DESIGNED BY	RR/TC	05/23/25	TRACING No.	
Γ					LAYOUT PLAN	DRAWN BY	AS/SD	05/23/25	$yy yyy_y$	
I					LATOUT PLAN	CHECKED BY	MC/CW	05/23/25	///,////·/	
Ι					HORIZONTAL SCALE: 1 = 40'	AS BUILT BY			SHEET 45 OF 47	

PD-18

rshiwakoti May 23, 2025 - 12:51pn

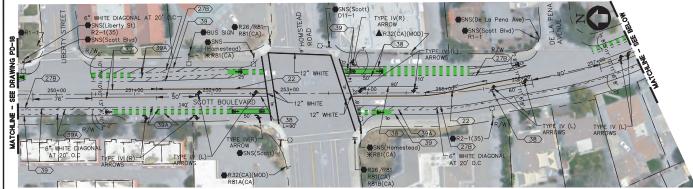

## SCOTT BOULEVARD - PLAN

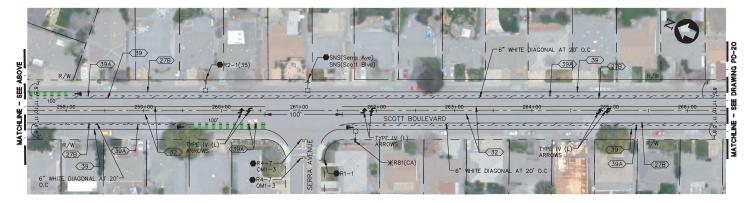

SCOTT BOULEVARD - PLAN

SCALE: 1"=40'





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	PROJECT No. CE CE XX-XX-XX				CITY OF SANTA CLARA	APPROVED BY				
	ACCOUNT No. XXX-XXXX-XXXX				PUBLIC WORKS DEPARTMENT	TITLE				
٦ ا	DATE	No.	REVISION	BY		DATE			R.C.E. No.	
11					SANTA CLARA		INITIAL	DATE	Survey No.	
$\  \ $					BIKEWAY IMPROVEMENTS	DESIGNED BY	RR/TC	05/23/25	TRACING No.	
$\  \ $					LAYOUT PLAN	DRAWN BY	AS/SD	05/23/25	$YY YYY_Y$	
$\  \ $					LATOUT PLAN	CHECKED BY	MC/CW	05/23/25	///,////·/	
2)					HORIZONTAL SCALE: 1 = 40'	AS BUILT BY			SHEET 46 OF 47	

PD-19

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1730 N. FIRST STREET SUITE 600 SAN JOSE, CA 95112 408-467-9194 408-467-9100 (FAX)


SCOTT BOULEVARD - PLAN

SCALE: 1"=40'







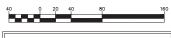

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F	PROJECT NO. CE CE XX-XX-XX  CITY OF SANTA CLARA APPROVED BY									
ACCOUNT No. XXX-XXXX-XXXX					PUBLIC WORKS DEPARTMENT	TITLE				
Г	DATE	No. REVISION BY			DATE			R.C.E. No.		
					SANTA CLARA		INITIAL	DATE	Survey No.	
					BIKEWAY IMPROVEMENTS	DESIGNED BY	RR/TC	05/23/25	TRACING No.	
Е					LAYOUT PLAN	DRAWN BY	AS/SD	05/23/25	XX XXX-X	
					LATOUT FLAN	CHECKED BY	MC/CW	05/23/25	$\mathcal{N}_{\mathcal{N}}}}}}}}}}$	
L					HORIZONTAL SCALE: 1 = 40'	AS BUILT BY			SHEET 47 OF 47	