EXISTING BUILDING ADDRESSES

1205 Coleman Ave

328 Brokaw Road

340 Brokaw Road

400 Brokaw Road

PLANNING/ZONING

EXISTING ZONING: Light Industrial

EXISTING GENERAL PLAN DESIGNATION: Station Area Plan

PROPOSED ZONING DESIGNATION: Very High Density Residential

PROPOSED GENERAL PLAN DESIGNATION: Community Commercial / Very High Density Residential

BUILDING HEIGHT

The maximum building height 85 feet and subject to the Federal Aviation Administration (FAA) regulation Part 77 height restrictions

SETBACK

Minimum building setback from Coleman Avenue is 25 feet. Minimum building setback from Brokaw Street is 25 feet. Minimum building setback from Champion Pkwy is 25 feet.

OWNER

TOD Brokaw, LLC 10121 Miller Ave, Suite 200 Cupertino, CA 95014

ARCHITECT

MVE + Partners, Inc. 1900 Main Street, 8th Floor Irvine, CA 92614

CIVIL ENGINEER

Nterra

1155 n First street | suite 214 San Jose, CA 95112

LANDSCAPE ARCHITECT

The Guzzardo Partnership Inc. 181 Greenwich Street San Francisco, CA 94111

VICINITY MAP





GENERAL

GEN.1 PROJECT INFORMATION, DIRECTORY AND INDEX

GEN.2 PROJECT ILLUSTRATIVE PLAN

GEN.3 PROJECT DATA

CIVIL

C1.00 OVERALL CONTEXT PLAN

C2.21 DETAILED SITE PLAN

C2.22 DETAILED SITE PLAN

C2.30 TYPICAL STREET SECTIONS

C2.40 FIRE ACCESS & APPARATUS

C3.10 PRELIMINARY GRADING PLAN

C3.20 PRELIMINARY STORMWATER CONTROL PLAN C3.21 PRELIMINARY STORMWATER CONTROL PLAN

C4.10 COMPOSITE SITE UTILITY & TREE OVERLAY PLAN

C4.11 PRELIMINARY UTILITY PLAN

C4.12 PRELIMINARY UTILITY PLAN

ARCHITECTURE

A1.01 PLAN- B1

A1.02 PLAN-STREET LEVEL

A1.03 PLAN-LEVEL 2

A1.04 PLAN-LEVEL 3

A1.05 PLAN-LEVEL 4-5

A1.06 PLAN-LEVEL 6

A1.07 PLAN-LEVEL 7

A1.08 PLAN-LEVEL ROOF

A1.11 TYPICAL UNIT PLANS

A1.12 TYPICAL UNIT PLANS

A2.01 ARCHITECTURAL STYLE 1

A2.02 ARCHITECTURAL STYLE 2

A2.03 ARCHITECTURAL STYLE 3 A2.04 ARCHITECTURAL STYLE 4

A2.05 ARCHITECTURAL STYLE 5-HOTEL

A2.06 ARCHITECTURAL STYLE 6-TOWER

A2.07 SHADOW STUDIES

SP1.00 CONCEPTUAL SITE SECTIONS

SP3.01 VENTILATION PLAN MAP

LANDSCAPE

L-1.0 Schematic Landscape Plan - Overall

L-1.1 Park Master Plan

L-1.2 Park Credit Legend

L-1.3 Planting Notes and Legends

L-2.1 Schematic Landscape Plan - Site

L-2.2 Schematic Landscape Plan - Site

L-2.3 Schematic Landscape Plan - Site

L-2.4 Schematic Landscape Plan - Site

L-2.5 Schematic Landscape Plan - Site

L-2.6 Schematic Landscape Plan - Site

L-2.7 Schematic Landscape Plan - Podium Building 1

L-2.8 Schematic Landscape Plan - Podium Hotel

L-2.9 Schematic Landscape Plan - Podium Building 2

L-2.10Schematic Landscape Plan - Podium Building 3

L-2.11Schematic Landscape Plan - Podium Building 4 L-3.1 Irrigation Zoning Diagram - Site and Podium

L-3.2 Irrigation Legend, Notes and Water-use Calculations

L-3.3 Irrigation Details

L-3.4 Irrigation Details

L-4.1 Site Sections

L-4.2 Site Sections

L-4.3 Landscape Details

L-4.4 Landscape Details

L-4.5 Landscape Details

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ROJECT#

SHEET TITLE **PROJECT** INFORMATION. DIRECTORY AND INDEX

SHEET NUMBER GEN.1





MULTI-FAMILY RESIDENTIAL (R-2)
1600 UNITS
23.84 ACRES
21.40 ACRES
21.37 ACRES
45.84 ACRES
4.52 ACRES
74.8 DU/AC

PROJECT DATA

RESIDENTIAL UNIT DATA

UNIT COUNT						
BUILDING 1	317 DU					
BUILDING 2	399 DU					
BUILDING 3	371 DU					
BUILDING 4	513 DU					
TOTAL	1600 DU					

*ALL DENS WILL REMAIN A DEN AND WILL NOT BE CONVERTED TO A BEDROOM.

UNIT MIX							
UNIT TYPE	UNIT COUNT	PERCENTAGE					
STUDIO	230 DU	14%					
1-BEDROOM	633 DU	40%					
1BD + DEN	127 DU	8%					
2-BEDROOM	562 DU	35%					
2BD + DEN	48 DU	3%					
TOTAL	1600 DU	100%					

HOTEL DATA

ROOM COUNT	FOOD AND BEVERAGE	AMENITY(spa, fitness,hotel bar and etc.)	CONFERENCE		
225	5,500 +/- SF	4,400 +/- SF	6,300 +/- SF		

*VALUES SHOWN IN THIS CHART IS NOT IN ADDITION TO THE TOTAL VALUE SHOWN IN THE COMMERCIAL AREA INFORMATION.

COMMERCIAL/ RETAIL AREA INFORMATION					
HOTEL	182,000 +/- S.F.				
RETAIL	15,000 +/- S.F.				
TOTAL COMMERCIAL/RETAIL AREA	197,000 +/- S.F.				

*GARAGE AREAS ARE EXCLUDED FROM COMMERCIAL/ RETAIL AREA CALCULATIONS. GARAGE AREAS ARE INCLUDED IN THE

CLASS II BICYCLE PARKING

BICYCLE SPACES

107 SPACES

5 SPACES

4 SPACES

RATIO

1 space /15 DU 1 space /6,000 SF

RESIDENTIAL BUILDING AREA CALCULATIONS. ALL AREA INFORMATION IS SHOWN FOR FIRE CODE CALCULATION PURPOSES.

RESIDENTIAL BUILDING AREA INFORMATION						
BUILDING 1 BUILDING 2 BUILDING 3 BUILDING 4						
TYPE IA CONSTRUCTION	281,148 +/- S.F.	327,151 +/- S.F.	309,268 +/- S.F.	575,160 +/- S.F.		
WOOD TYPE IIIA CONSTRUCTION	344,521 +/- S.F.	439,448 +/- S.F.	387,835 +/- S.F.	316,826 +/- S.F.		
TOTAL BUILDING AREA	625,669 +/- S.F.	766,599 +/- S.F.	697,103 +/- S.F.	891,986 +/- S.F.		

BICYCLE PARKING

CL	CLASS I BICYCLE PARKING					
LOCATION	BICYCLE SPACES	RATIO	LOCATION			
BUILDING 1	108 SPACES	1 space /3 DU	RESIDENTIAL			
BUILDING 2	132 SPACES	1 space /3 DU	RETAIL			
BUILDING 3	129 SPACES	1 space /3 DU	PARK			
BUILDING 4	171 SPACES	1 space /3 DU				
HOTEL	8 SPACES	1 space /30 rooms				
RETAIL	1 SPACES	1 space /30 employees				
TOTAL	549 SPACES					

NOTE: CLASS I BICYLE PARKING PROVIDED IN SECURED ROOM OF EACH BUILDING

VEHICLE PARKING

HOTEL VEHICLE PARKING							
ADA UNIVERSAL							
7	285						
292							

* 67 PARKING SPACES PROVIDED FOR CAFE, RESTAURANT AND MEETING ROOM AND SHARED WITH EMPLOYEES, (RETAIL PARKING 1/200 SF, MEETING ROOM 1/4

* 225 PARKING SPACES PROVIDED FOR GUESTS. (1/ KEY)

PARKING STALL SIZE:

UNIVERSAL 9-'0" X 18'-0" 8'-0" X 16'-0" COMPACT MOTORCYCLE 3'-0" X 6'-0"

DRIVE AISLE WIDTH :25'

ADDITIONAL 14 PARALLEL PARKING STALLS PROVIDED FOR RETAIL AND PARK USE AT INTERNAL STREET.

	BUILDING 1 VEHICLE PARKING							
,	E/DU)	MOTORCYCLE						
ADA	UNIVERSAL	ADA	EV STATION	UNIVERSAL	COMPACT	(1 SPACE/40 DU)		
3	48	10	32					
	51 444							

* VISITOR PARKING SPACES ARE SHARED WITH RESIDENTIAL GUEST, RETAIL AND PARK VISITOR. (RETAIL PARKING 1/200 SF, RESIDENTIAL GUEST PARKING 0.1/DU)

	BUILDING 3 VEHICLE PARKING								
	VISITOR	E/DU)	MOTORCYCLE						
ADA	UNIVERSAL	ADA	EV STATION	UNIVERSAL	COMPACT	(1 SPACE/40 DU)			
3	55	12	36	453	3				
58 504						10			

* VISITOR PARKING SPACES ARE SHARED WITH RESIDENTIAL GUEST, RETAIL AND PARK VISITOR. (RETAIL PARKING 1/200 SF, RESIDENTIAL GUEST PARKING 0.1/DU)

	BUILDING 2 VEHICLE PARKING								
١	MOTORCYCLE								
ADA	UNIVERSAL	ADA	EV STATION	UNIVERSAL	COMPACT	(1 SPACE/40 DU)			
4	58	12	34	542	2				
62 590						10			

* VISITOR PARKING SPACES ARE SHARED WITH RESIDENTIAL GUEST, RETAIL AND PARK VISITOR. (RETAIL PARKING 1/200 SF, RESIDENTIAL GUEST PARKING 0.1/DU)

	BUILDING 4 VEHICLE PARKING							
١	VISITOR	SPACE/DU)	MOTORCYCLE					
ADA	UNIVERSAL	ADA	EV STATION	(1 SPACE/40 DU)				
4	63	14	41	621	21			
67 697					13			

* VISITOR PARKING SPACES ARE SHARED WITH RESIDENTIAL GUEST, RETAIL AND PARK VISITOR. (RETAIL PARKING 1/200 SF, RESIDENTIAL GUEST PARKING 0.1/DU)

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SCALE:

SHEET TITLE **PROJECT** DATA

SHEET NUMBER GEN.3





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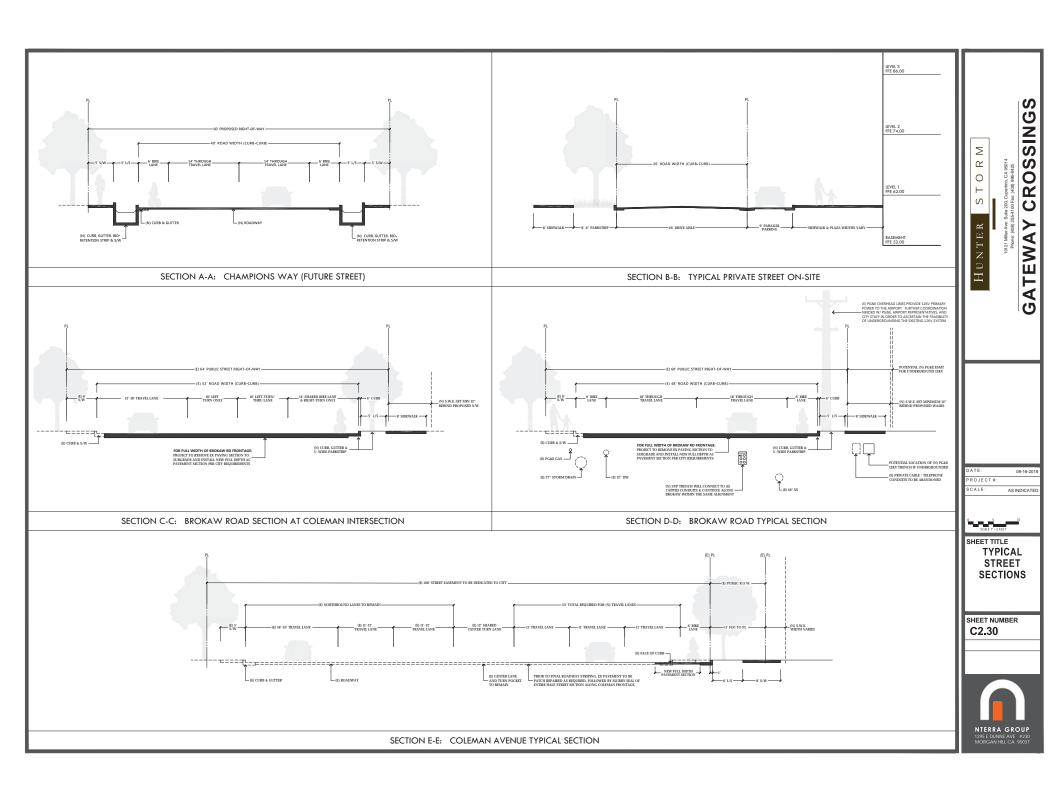
SHEET TITLE
CONTEXT PLAN


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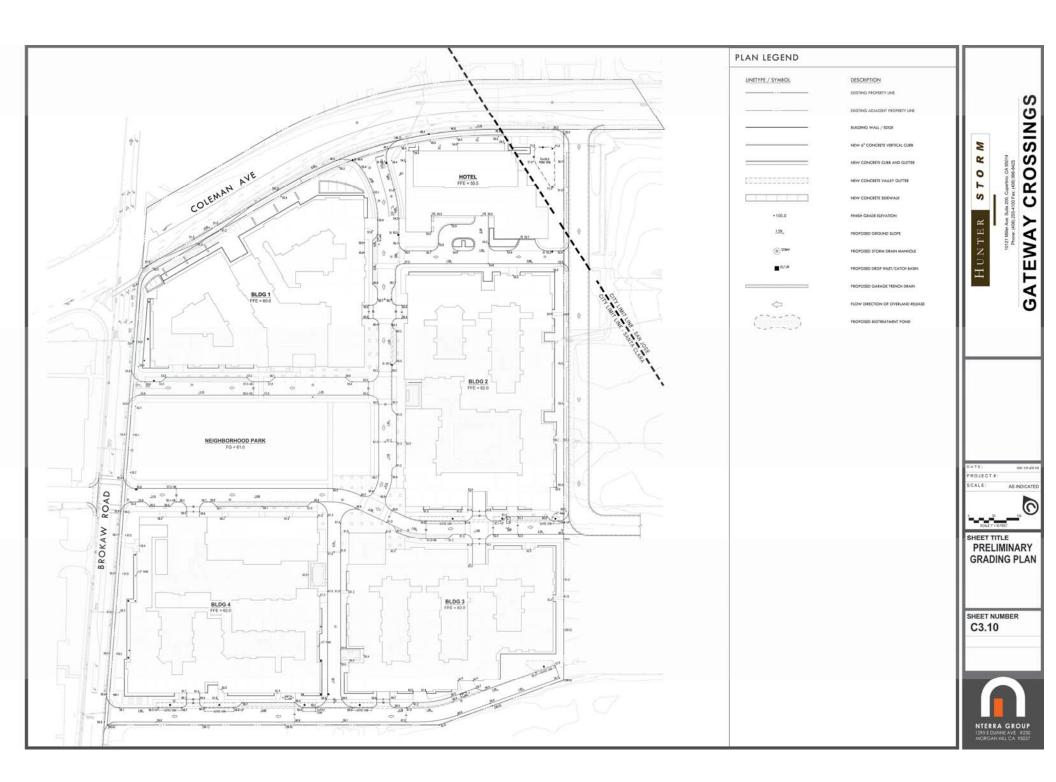







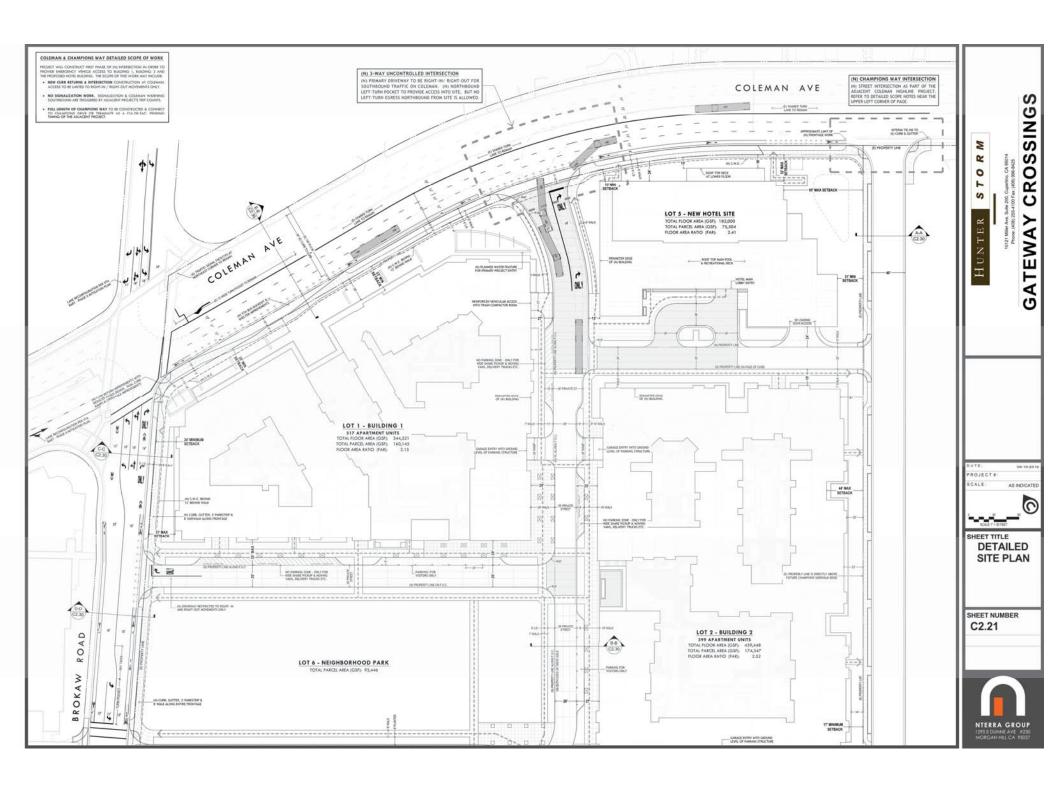

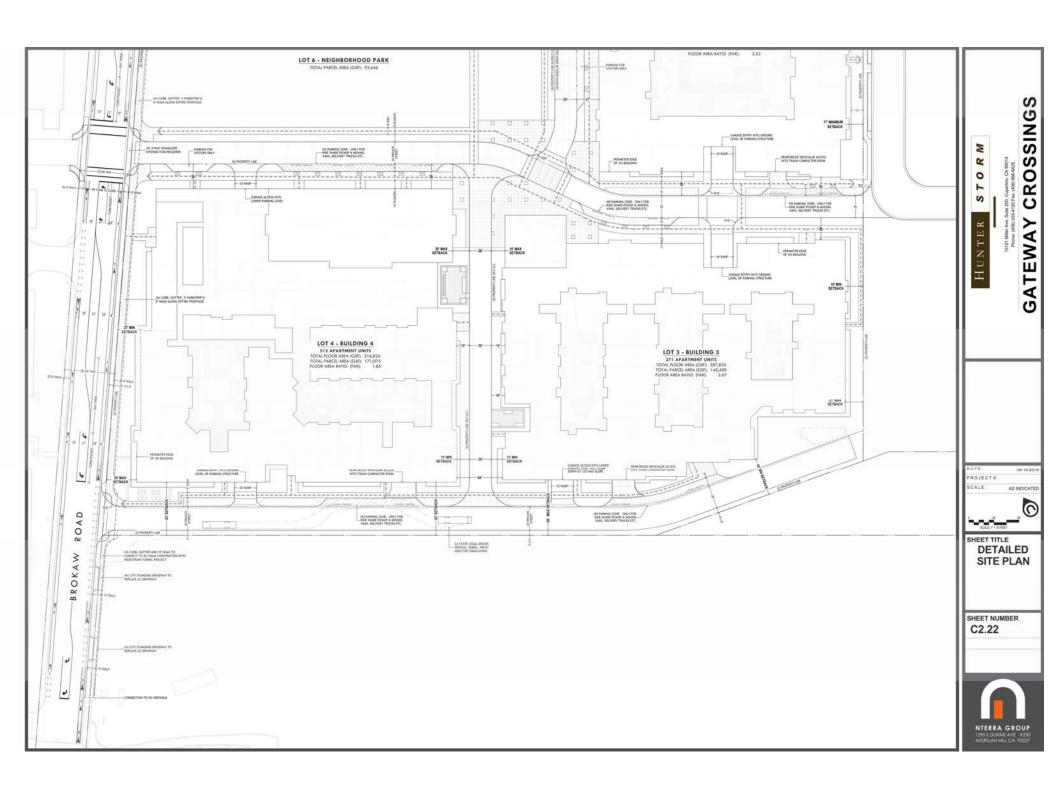

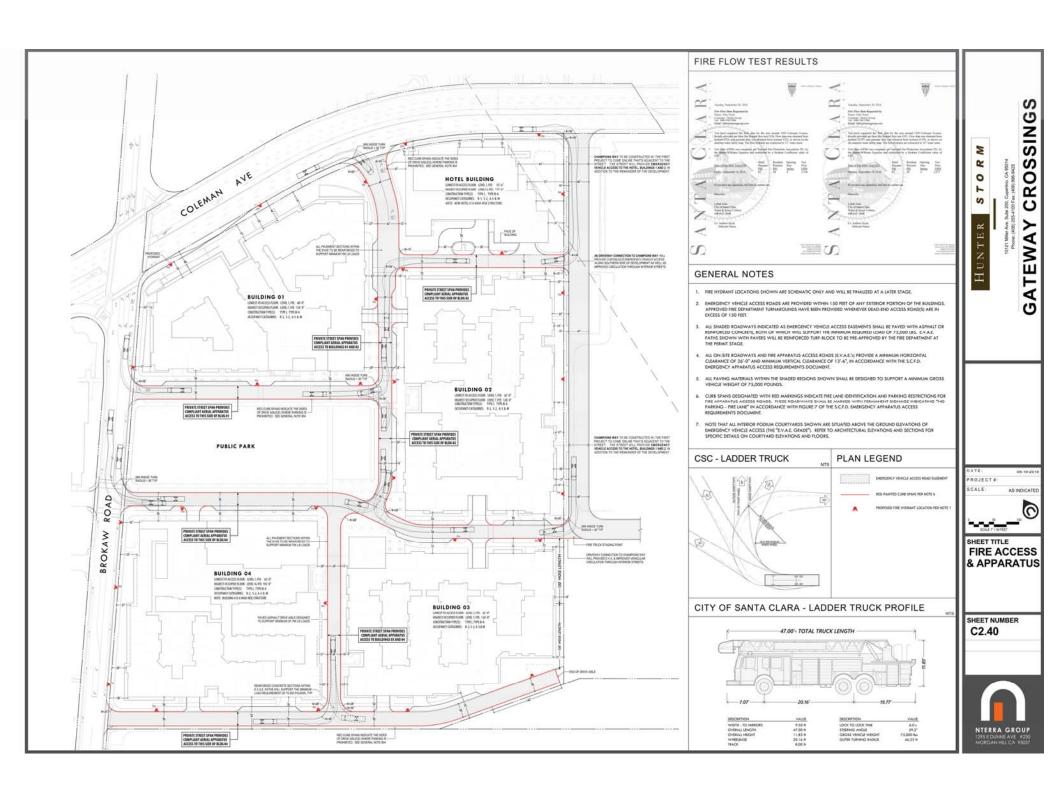

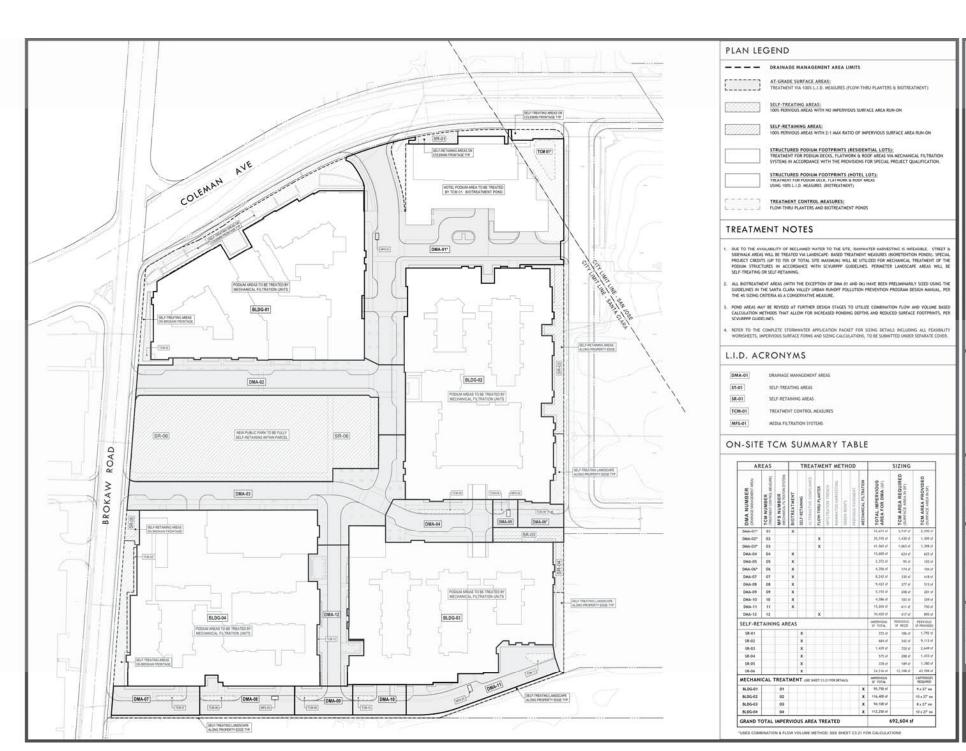

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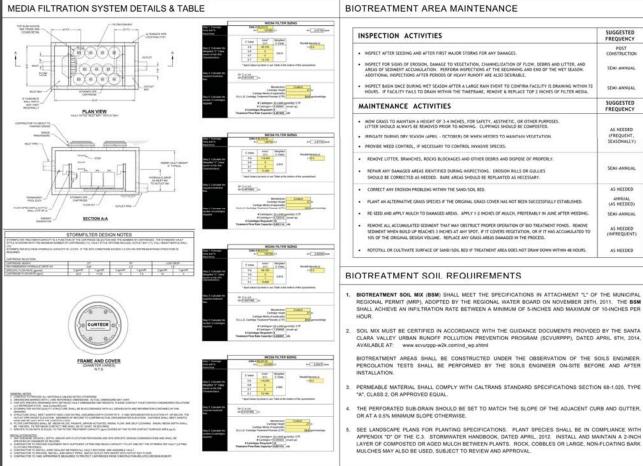
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PROJECT# SCALE: AS INDICATED 0

SHEET TITLE **PRELIMINARY STORMWATER CONTROL PLAN**

SHEET NUMBER C3.20





BIOTREATMENT AREA MAINTENANCE

INSPECTION ACTIVITIES	SUGGESTED FREQUENCY
INSPECT AFTER SEEDING AND AFTER FIRST MAJOR STORMS FOR ANY DAMAGES.	POST CONSTRUCTION
 INSPECT FOR SIGNS OF EROSION, DAMAGE TO VEGETATION, CHANNELIZATION OF FLOW, DEBRIS AND LITTER, AND AREAS OF SCOMMENT ACCUMULATION. PERFORM INSPECTIONS AT THE BEGINNING AND END OF THE WET SEASON. ADDITIONAL INSPECTIONS ATTER PERSONS OF HEAVY RIMOFF ARE ALSO DESIRABLE. 	SEMI-ANNUAL
 INSPECT BASIN ONCE DURING WET SEASON AFTER A LARGE RAIN EVENT TO CONFIRM FACILITY IS DRAINING WITHIN 72 HOURS. IF FACILITY FAILS TO DRAIN WITHIN THE TIMEFRAME, REMOVE & REPLACE TOP 2 INCHES OF FILTER MEDIA. 	SEMI-ANNUAL
MAINTENANCE ACTIVITIES	SUGGESTED FREQUENCY
 MOW GRASS TO MAINTAIN A HOGHT OF 3-4 INCHES, FOR SAFETY, AESTHETIC, OR OTHER PURPOSES. LITTER SHOULD ALWAYS BE REMOVED PROOR TO NOWNED. CLUPPINGS SHOULD BE COMPOSTED. BRIBGATE GUIRRO MY PEACHA (APEN. C-CYTORER) OR WHAN REEDED TO MAINTAIN VEGETATION. PROVIDE WEED CONTROL, IF INCESSARY TO CONTROL INVASIVE SPECIES. 	AS NEEDED (FREQUENT, SEASONALLY
REMOVE LITTER, BRANCHIS, ROCKS BLOCKAGES AND OTHER DEBRIS AND DISPOSE OF PROPERLY. REPARE ANY DAMAGED AREAS IDENTIFIED DEBRIG RESPECTIONS. EROSION BILLS OR CULLIES SHOULD BE CORRECTED AS NEEDED. BARE AREAS SHOULD BE REPLANTED AS NECESSARY.	SEMI-ANNUAI
CORRECT ANY EROSION PROBLEMS WITHIN THE SAND/SOIL BED.	AS NEEDED
 PLANT AN ALTERNATIVE GRASS SPECIES IF THE ORIGINAL GRASS COVER HAS NOT BEEN SUCCESSFULLY ESTABLISHED. 	ANNUAL (AS NEEDED)
 RE-SEED AND APPLY MULCH TO DAMAGED AREAS. APPLY 1-2 INCHES OF MULCH, PREFERABLY IN JUNE AFTER WEEDING. 	SEMI-ANNUAL
 REMOVE ALL ACCUMULATED SEDMENT THAT MAY OBSTRUCT PROPER OPERATION OF BIO TREATMENT PONDS. REMOVE SEDMENT WHEN BUILD UP REACHES 3 INCHES AT ANY SPOT. IF IT COVERS VEGETATION, OR IF IT HAS ACCUMULATED TO TOO OF THE ORIGINAL DESIGN VEHICLE. REPLACE ANY EAGS AREAS DAMAGED IN THE PROCESS. 	AS NEEDED (INFREQUENT
 ROTOTILL OR CULTIVATE SURFACE OF SAND/SOIL BED IF TREATMENT AREA DOES NOT DRAW DOWN WITHIN 46 HOURS. 	AS NEEDED

CLARA VALLEY URBAN RUNOFF POLLUTION PREVENTION PROGRAM (SCVURPPP), DATED APRIL 8TH, 2014,

BIOTREATMENT AREAS SHALL BE CONSTRUCTED UNDER THE OBSERVATION OF THE SOILS ENGINEER.

PERCOLATION TESTS SHALL BE PERFORMED BY THE SOILS ENGINEER ON-SITE BEFORE AND AFTER

SEE LANDSCAPE PLANS FOR PLANTING SPECIFICATIONS. PLANT SPECIES SHALL BE IN COMPLIANCE WITH

APPENDIX "D" OF THE C.3. STORMWATER HANDBOOK, DATED APRIL, 2012, INSTALL AND MAINTAIN A 2-INCH

LAYER OF COMPOSTED OR AGED MULCH BETWEEN PLANTS. ROCK, COBBLES OR LARGE, NON-FLOATING BARK

OVERALL SITE PERMEABILITY TABLE

A. TOTAL SITE AREA	21.40 ACRES	B. TOTAL SITE AR	EA DISTURBED	21.40 ACRES
GATEWAY CROSSINGS	EXISTING	PROPOSED	AREA	TOTAL POST-
GATEWAY CROSSINGS	AREA	REPLACED	NEW	PROJECT AREA
IMPERVIOUS AREA				
ROOF	266,588 sf	766,588 sf	84,082 sf	350,670 sf
PARKING	490,383 sf	118,850 sf	0. sf	118,850 sf
SIDEWALKS & STREETS	29,459 sf	29,459 sf	195,936 sf	225,395 sf
C. TOTAL IMPERVIOUS AREA	786,430 sf	414,897 sf	280,018 sf	694,915
D. TOTAL NEW & REPLACED IMP	TOTAL NEW & REPLACED IMPERVIOUS AREA			
PERVIOUS AREA				
LANDSCAPING	145,749 st	345,749 sf	77,415 sf	223,164 sf
PERVICUS PAVING	0 sf	0 sf	0 sf	0.1
OTHER (GREEN ROOF ETC)	0 sf	0 4	14,100 sf	14,100 si
E. TOTAL PERVIOUS AREA	145,749 sf	145,749 sf	91,515 sf	237,264 sf

SOURCE CONTROL MEASURES IMPLEMENTED

(REPLACED TOTAL IMPERVIOUS AREA + EXISTING TOTAL IMPERVIOUS AREA) x 100% =

1. BIOTREATMENT SOIL MIX (BSM) SHALL MEET THE SPECIFICATIONS IN ATTACHMENT "L" OF THE MUNICIPAL SD-10: REGIONAL PERMIT (MRP), ADOPTED BY THE REGIONAL WATER BOARD ON NOVEMBER 28TH, 2011. THE BSM SHALL ACHIEVE AN INFILTRATION RATE BETWEEN A MINIMUM OF 5-INCHES AND MAXIMUM OF 10-INCHES PER

SITE DESIGN & LANDSCAPE PLANNING

- . MAXIMIZED TREES AND PLANTING WITHIN NEW HARDSCAPE AREAS AND LANDSCAPED AREAS.
- VEGETATION/PLANTING FOR ALL LANDSCAPE AREAS. WHICH SLOPE DOWN AT A RATIO OF LESS THAN 5:1.

EFFICIENT IRRIGATION SD-11:

- RAIN-TRIGGERED SHUTOFF DEVICES FOR IRRIGATION SYSTEMS TO PREVENT OPERATION AFTER RAINFALL
- IRRIGATION SYSTEMS DESIGNED SPECIFICALLY TO ACCOMMODATE THE PROJECT'S IRRIGATION WATER DEMANDS AND PLANTING REQUIREMENTS.

STORM DRAIN SIGNAGE SD-13:

 ALL CATCH BASINS AND INLETS TO BE STENCILED W/ PROHIBITIVE LANGUAGE REGARDING DUMPING, IN ACCORDANCE WITH CITY & SCYURPPP STANDARDS.

COMBINATION VOLUME & FLOW SIZING CALCULATIONS FOR TREATMENT CONTROL MEASURES: TCM-01, TCM-02, TCM-03, AND TCM-06





All Property Indoorsellants					
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AVAILABLE AT: www.scvurppp-w2k.com/nd wp.shtml

"A". CLASS 2. OR APPROVED EQUAL.


OR AT A 0.5% MINIMUM SLOPE OTHERWISE.

MULCHES MAY ALSO BE USED, SUBJECT TO REVIEW AND APPROVAL.

INSTALLATION



TYPICAL BIORETENTION AREA HALF-SECTION

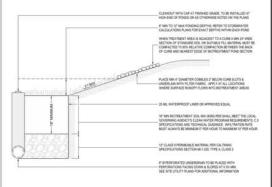

SHEET TITLE PRELIMINARY **STORMWATER** CONTROL PLAN

AS INDICATED

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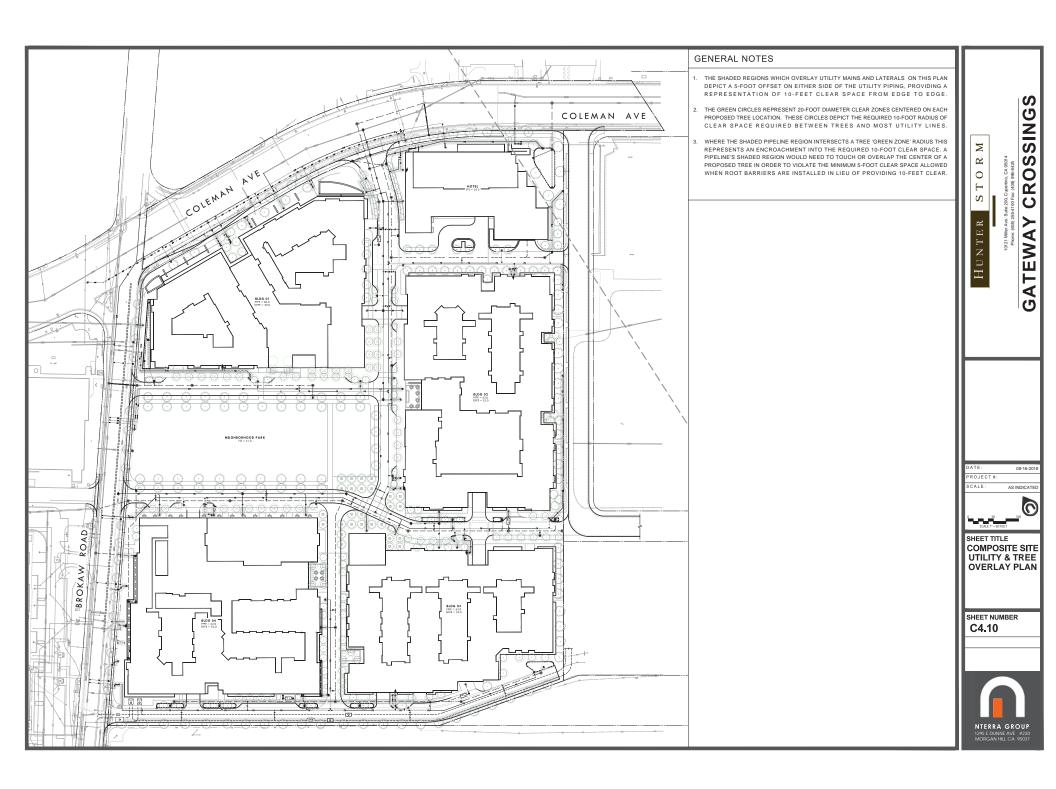
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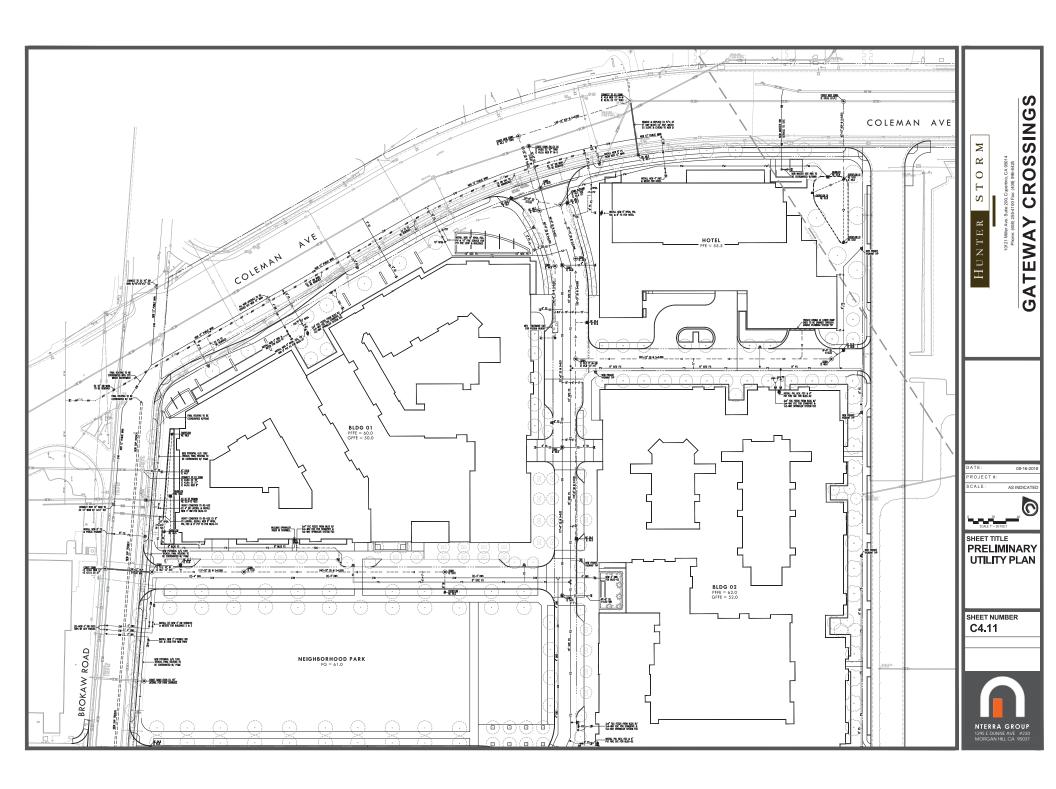
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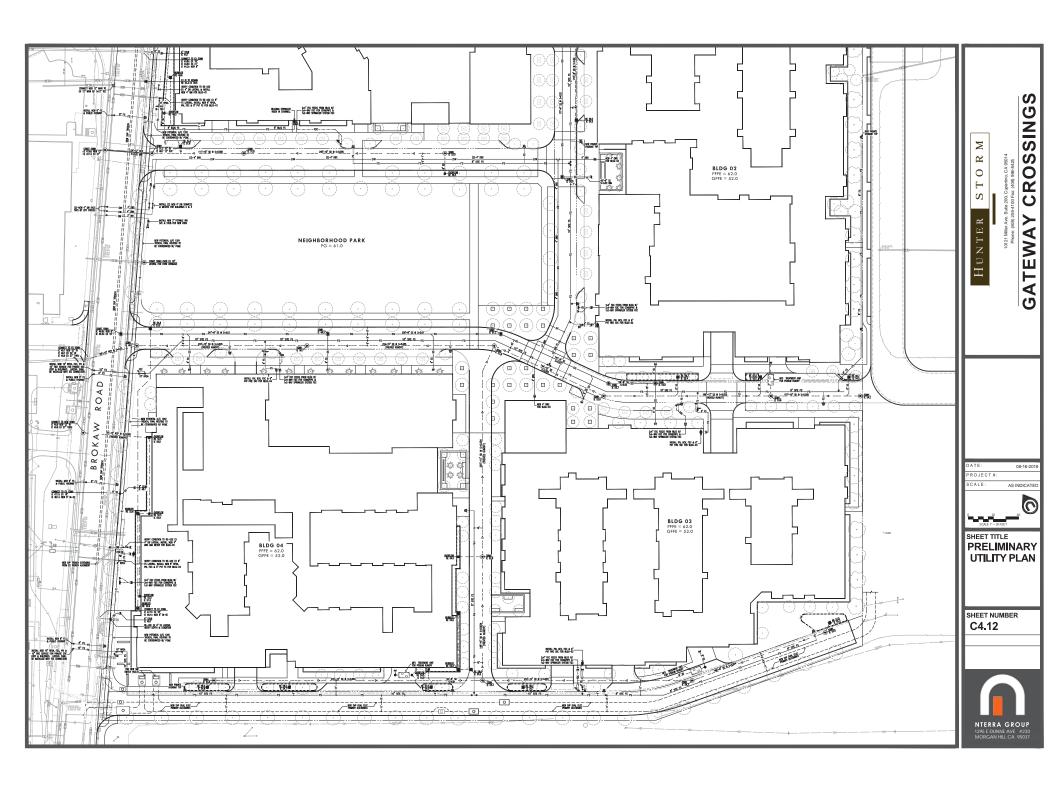
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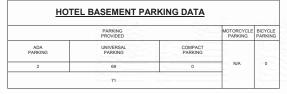












BICYCLE				RESI			VISITOR			
PARKIN	MOTORCYCLE PARKING	PARKING				PARKING				
		COMPACT PARKING	UNIVERSAL PARKING	EV PARKING	ADA PARKING	COMPACT PARKING	UNIVERSAL PARKING	ADA PARKING		
0	8	7	208	32	0	N/A	N/A	N/A		


	RETAIL/VISITOR PARKING	₹		RESI PAR	DENT		MOTORCYCLE PARKING	BICYCLE
ADA PARKING	UNIVERSAL PARKING	COMPACT PARKING	ADA PARKING	EV PARKING	UNIVERSAL PARKING	COMPACT PARKING		
N/A	N/A	N/A	0	34	302	0	10	0

		. 1		BEOL				BICYCI F
	PARKING	R			DENT KING		MOTORCYCLE PARKING	PARKING
ADA PARKING	UNIVERSAL PARKING	COMPACT PARKING	ADA PARKING	EV PARKING	UNIVERSAL PARKING	COMPACT PARKING		
N/A	N/A	N/A	6	36	216	3	10	0

	PARKING	R		RESIDENT PARKING				BICYCLE PARKING
ADA PARKING	UNIVERSAL PARKING	COMPACT PARKING	ADA PARKING	EV PARKING	UNIVERSAL PARKING	COMPACT PARKING		
N/A	N/A	N/A	5	27	274	21	13	0

NOTE:
1 ADA VAN PARKING SPACE HAS BEEN PROVIDED EVERY 6 ADA PARKING SPACES.
1 ADA VAN PARKING SPACE HAS BEEN PROVIDED IN THE PROJECT FOR RETAIL ON SITE.
1 THERE ARE IN TOTAL 60 RETAIL PARKING SPACES PROVIDED IN THE PROJECT FOR RETAIL ON SITE.
1 EV CHARGING STATIONS FOR RESIDENTS ARE PROVIDED IN BASEMENT GARGAE AND ON STREET LEVEL.

FOR LANDSCAPE DESIGN REFERENCE TO LANDSCAPE DRAWINGS. FOR SITE GRADING REFERENCE TO CIVIL DRAWINGS.

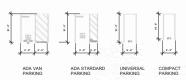

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SCALE: As indicate 100

SHEET TITLE SITE PLAN BASEMENT LEVEL

SHEET NUMBER A1.01





HOTEL GROUND LEVEL PARKING DATA

	PARKING PROVIDED	1,515	MOTORCYCLE PARKING	BICYCLE PARKING
ADA PARKING	UNIVERSAL PARKING	COMPACT PARKING		
3	67	0	N/A	8
	70			

BUILDING 1 GROUND LEVEL PARKING DATA

	PARKING	2			BICYCLE PARKING			
ADA PARKING	UNIVERSAL PARKING	COMPACT PARKING	ADA PARKING	EV PARKING	UNIVERSAL PARKING	COMPACT PARKING		
3	48	N/A	6	0	76	4	N/A	108
	51*			86				

BUILDING 2 GROUND LEVEL PARKING DATA

	PARKING	₹		RESII PARI	MOTORCYCLE PARKING	PARKING		
ADA PARKING	UNIVERSAL PARKING	COMPACT PARKING	ADA PARKING	EV PARKING	UNIVERSAL PARKING	COMPACT PARKING		
4	58	N/A	10	0	127	2	N/A	132
1.60	62*			139		100		

BUILDING 3 GROUND LEVEL PARKING DATA

	PARKING	3	RESIDENT PARKING				MOTORCYCLE PARKING	PARKING
ADA PARKING	UNIVERSAL PARKING	COMPACT PARKING	ADA PARKING	EV PARKING	UNIVERSAL PARKING	COMPACT PARKING		
3	55	N/A	0	0	81	0	N/A	129

BUILDING 4 GROUND LEVEL PARKING DATA

PARKIN	MOTORCYCLE PARKING		RESIDENT PARKING				RETAIL/VISITOR PARKING			
		COMPACT PARKING	UNIVERSAL PARKING	EV PARKING	ADA PARKING	COMPACT PARKING	UNIVERSAL PARKING	ADA PARKING		
171	N/A	0	128	14	5	N/A	63	4		

* VISITOR PARKING SPACES ARE SHARED WITH RESIDENTIAL GUEST. RETAIL AND PARK VISITOR, (RETAIL PARKING 1/200 SF, RESIDENTIAL GUEST PARKING 0.1/0U)

NOTE:

1 ADA VAN PARKING SPACE HAS BEEN PROVIDED EVERY 6 ADA PARKING SPACES.

1 HERE ARE IN TOTAL 34 RETAIL PARKING SPACES PROVIDED IN THE PROJECT FOR RETAIL ON SITE.

EV CHARGING STATIONS FOR RESIDENTS ARE PROVIDED IN BASEMENT GARGAE AND ON STREET LEVEL.

FOR LANDSCAPE DESIGN REFERENCE TO LANDSCAPE DRAWINGS. FOR SITE GRADING REFERENCE TO CIVIL DRAWINGS.



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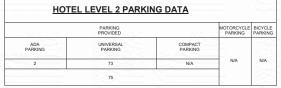
SCALE: As indicate 100

SHEET TITLE SITE PLAN STREET LEVEL

SHEET NUMBER A1.02







*HOTEL PARKING SPACES ARE SHARED WITH GUESTS, RETAIL AND EMPLOYEES.

BICYCL PARKIN	MOTORCYCLE PARKING			RESID PARK		₹	RETAIL/VISITOR PARKING	
		COMPACT PARKING	UNIVERSAL PARKING	EV PARKING	ADA PARKING	COMPACT PARKING	UNIVERSAL PARKING	ADA PARKING
N/A	N/A	0	107	0	4	N/A	N/A	N/A


	BUI	LDING	2 LEVE	L 2 PAF	KING D	ATA		
-	RETAIL/VISITOI PARKING	3		RESI PAR	DENT KING		MOTORCYCLE PARKING	BICYCLE
ADA PARKING	UNIVERSAL PARKING	COMPACT PARKING	ADA PARKING	EV PARKING	UNIVERSAL PARKING	COMPACT PARKING		
N/A	N/A	N/A	2	- 0	113	0	N/A	N/A
	N/A			115				

	RETAIL/VISITOR PARKING	₹		RESI PAR	DENT KING		MOTORCYCLE PARKING	BICYCLE PARKING
ADA PARKING	UNIVERSAL PARKING	COMPACT PARKING	ADA PARKING	EV PARKING	UNIVERSAL PARKING	COMPACT PARKING		
N/A	N/A	N/A	6	0	156	0	N/A	N/A

	BUI	LDING	4 LEVE	L 2 PAF	KING D	ATA		
[11]	RETAIL/VISITO	2	0.03500		DENT KING	una	MOTORCYCLE PARKING	BICYCLE
ADA PARKING	UNIVERSAL PARKING	COMPACT PARKING	ADA PARKING	EV PARKING	UNIVERSAL PARKING	COMPACT PARKING	5	
N/A	N/A	N/A	3	0	220	0	N/A	N/A
	N/A			223			-	

NOTE: 1 ADA VAN PARKING SPACE HAS BEEN PROVIDED EVERY 6 ADA PARKING SPACES. THERE ARE IN TOTAL 80 RETAIL PARKING SPACES PROVIDED IN THE PROJECT FOR RETAIL ON SITE. EV CHARGING STATIONS FOR RESIDENTS ARE PROVIDED IN ASSEMBLY GARGAE AND ON STREET LEVEL.

FOR LANDSCAPE DESIGN REFERENCE TO LANDSCAPE DRAWINGS. FOR SITE GRADING REFERENCE TO CIVIL DRAWINGS.

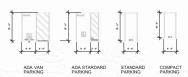

GATEWAY CROSSINGS

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DATE: 6-28-201
PROJECT #:
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SHEET TITLE
SITE PLAN
LEVEL 2

SHEET NUMBER A1.03

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1900 Main Street, Suite 800 Irvine, California 92614 949.809.3388



	PARKING PROVIDED		MOTORCYCLE PARKING	BICYCLE PARKING
ADA PARKING	UNIVERSAL PARKING	COMPACT PARKING		
0	76	N/A	N/A	N/A

*HOTEL PARKING SPACES ARE SHARED WITH GUESTS, RETAIL AND EMPLOYEES.

19121 Mater Aux Sala 200, Caperino, Co. 60014
Prove (403) 255-1105 Fac (403) 966-8455

GATEWAY CROSSINGS

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DATE: 6-28-2018
PROJECT#:

SCALE: 1"=50"-0"
0 50 100

SHEET TITLE
SITE PLAN
LEVEL 3

SHEET NUMBER
A1.04

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CROSSINGS

GATEWAY

1" = 50'-0"

SHEET TITLE SITE PLAN LEVEL 4-5

SHEET NUMBER







1" = 50'-0"





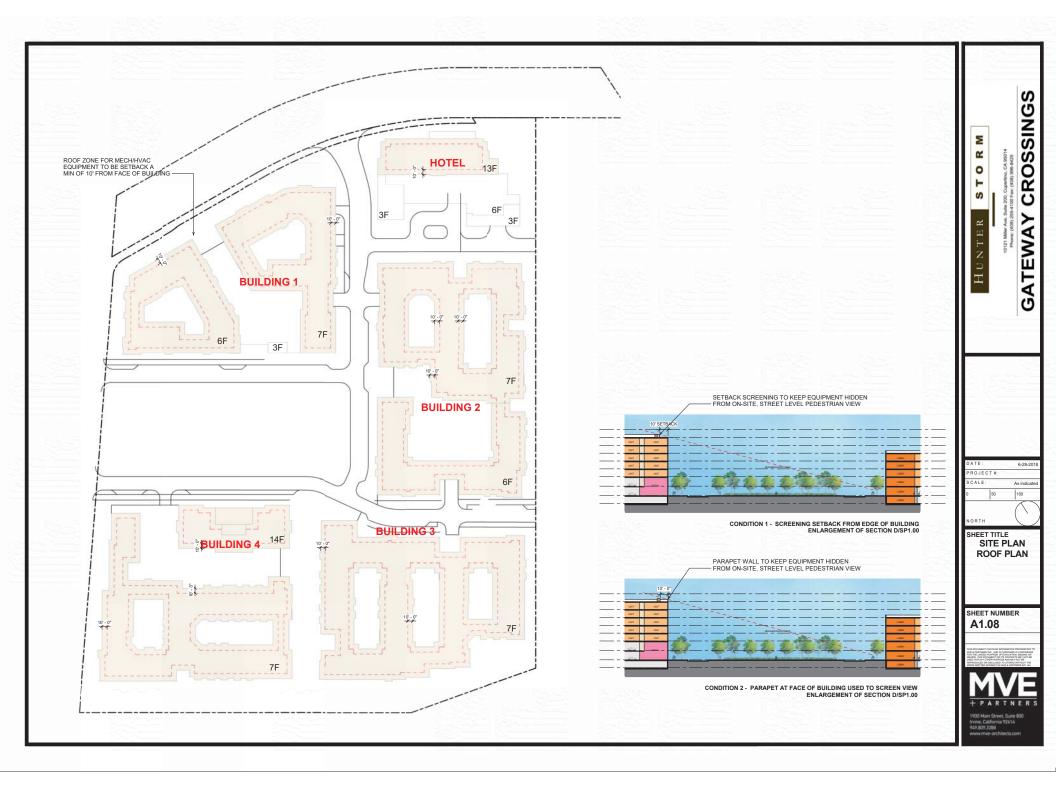

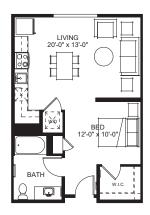

DECK BED 12'-0" x 11'-6" LIVING 13'-0" x 12'-0" KITCHEN BATH




1/4" = 1'-0"

3 UNIT - 1BR (C)

6 UNIT - 1BR (A)

2 UNIT - 1BR (B)

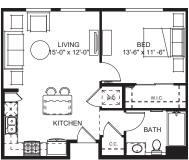



① UNIT - 1BR (D) 1/4" = 1'-0"

UNIT TYPE	TOTAL	UNIT	UNIT COUNT	UNIT SIZE (sf)	DECK SIZE (sf)
STUDIO	230	-	230	625	N/A
		А	34	795	66
		В	479	722	78
1-BEDROOM	633	С	60	693	N/A
		D	41	773	47
		CUSTOM*	19	VARIES	VARIES
1-BED + DEN	127	А	83	875	57
1-BED + DEN	121	В	44	1000	114
		А	83	1080	45
0.05000014	562	В	376	1036	62
2-BEDROOM	562	С	71	1185	51
		CUSTOM*	32	VARIES	VARIES
2-BED + DEN	48	-	48	1355	115

*CUSTOM UNIT PLANS NOT INCLUDED IN DRAWING SET. SIZE, DECK, AND FOOTPRINT VARY PER LOCATION.



NOTE: THE OCCURRENCE OF DECKS IS SUBJECT TO BUILDING ARTICULATIONS AND MAY CHANGE AS DESIGN PROGRESSES.

CROSSINGS **GATEWAY**

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SCALE: 1/4" = 1'-0" 16

SHEET TITLE
TYPICAL UNIT PLANS

SHEET NUMBER A1.11




4 UNIT - 1BR + DEN (A)

(5) UNIT - 1BR + DEN (B)

DECK

LIVING 18'-0" x 12'-6"

DINING

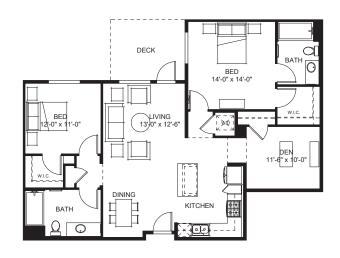

6 UNIT - 2BR + DEN


BATH

DEN 11'-6" x 10'-0"


14'-0" x 14'-0"

KITCHEN

....

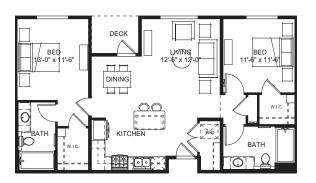

① UNIT - 2BR (A)
1/4" = 1'-0"

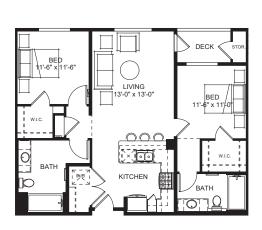

② UNIT - 2BR (B) 1/4" = 1"-0"



3 UNIT - 2BR (C) 1/4" = 1'-0"

NOTE: THE OCCURRENCE OF DECKS IS SUBJECT TO BUILDING ARTICULATIONS AND MAY CHANGE AS DESIGN PROGRESSES.



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DATE: 6:28:2018
PROJECT #:
SCALE: 1/4" = 1'-0"
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SHEET TITLE
TYPICAL UNIT
PLANS


SHEET NUMBER
A1.12

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STYLE DESCRIPTION

- · Facades articulated with expressed columns and beams.
- · Defined base, middle, and top proportions.
- Recessed and grouped windows and fenestration patterns.
- · Simple canopy and cornice used to terminate



ARCHITECTURAL IMAGERY

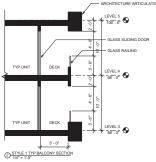







NOTE: TYPICAL APPLICATION OF STYLE. LOCATION ON SITE SUBJECT TO POSSIBLE CHANGE.

- 1 METAL TRIM
- 2 CLADDING PANEL
- 3 CLADDING/ METAL CORNICE
- 4 STUCCO
- 6 METAL CANOPY
- 6 JULIET BALCONY WITH PANELIZED RAILING
- BALCONY WITH PANELIZED RAILING



NOTE: REFERENCE LANDSCAPE DRAWINGS FOR LANDSCAPE DESIGN STYLE ELEVATIONS ARE INTENDED TO INDICATE ARCHITECTURE CHARACTERS AND SUBJECT TO CHANGE AS DESIGN PROGRESSES.

KEY MAP

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CROSSINGS

GATEWAY

STYLE 1


ARCHITECTURAL

SHEET NUMBER A2.01

STYLE 2

STYLE DESCRIPTION

- · Abstract fenestration patterns.
- Facades defined by floating planes that project beyond the building mass.
- · Windows grouped vertically within floating planes.
- · Horizontal slatted members define shading and railing devises.

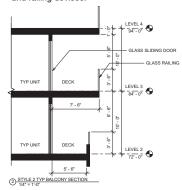

ARCHITECTURAL IMAGERY











NOT TO SCALE

- 1 ENGINEERED COMPOSITE SLATTED SCREEN
- 2 ENHANCED GLAZING SYSTEM
- METAL CANOPY
- 4 BALCONY WITH PANELIZED RAILING
- 5 STUCCO
- 6 CLADDING/ METAL CORNICE
- 7 GFRC/ CLADDING/ METAL PANEL
- 8 PLASTER



BUILDING 1 NORTH ELEVATION

(FRONTING COLEMAN AVE)

1/8" = 1'-0"

NOTE: REFERENCE LANDSCAPE DRAWINGS FOR LANDSCAPE DESIGN STYLE ELEVATIONS ARE INTENDED TO INDICATE ARCHITECTURE CHARACTERS AND SUBJECT TO CHANGE AS DESIGN PROGRESSES.

SINGS Σ œ CROS 0 **GATEWAY**

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As indicat 16 SHEET TITLE ARCHITECTURAL

STYLE 2


SHEET NUMBER A2.02



STYLE 3

STYLE DESCRIPTION

- Projecting frames used to group fenestrations and create a vertical rhythm.
- · Juliet balconies add texture and shadow between frames.
- · Solid, defined horizontal base organizes the facade composition.
- · Enhanced glazing and vertical articulation accent and mark important corners.

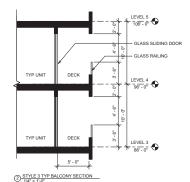

BUILDING 1 SOUTH ELEVATION

(FRONTING THE PARK)

1/8" = 1'-0"

ARCHITECTURAL IMAGERY









NOT TO SCALE

- **1** ENHANCED GLAZING SYSTEM
- 2 SMOOTH STUCCO
- **3** METAL CANOPY
- 4 STUCCO
- 6 RAINSCREEN BASE
- 6 BALCONY WITH PANELIZED RAILING
- BALCONY WITH METAL RAILING



NOTE: REFERENCE LANDSCAPE DRAWINGS FOR LANDSCAPE DESIGN STYLE ELEVATIONS ARE INTENDED TO INDICATE ARCHITECTURE CHARACTERS AND SUBJECT TO CHANGE AS DESIGN PROGRESSES.

KEY MAP

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SCALE: As indicate 16

SHEET TITLE ARCHITECTURAL STYLE 3

SHEET NUMBER A2.03




Irvine, California 92614 949.809.3388

STYLE 4

STYLE DESCRIPTION

- Traditional window patterning and proportioning devices.
- Projected mass extended from building face with recessed fenestrations
- Fenestration patterns organized by a strong grid.
- Shaped architectural cornice accents the top of the building.
- · Enhanced horizontal panels provide textural variety.

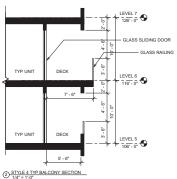

ARCHITECTURAL IMAGERY









NOT TO SCALE

NOTE: TYPICAL APPLICATION OF STYLE. LOCATION ON SITE SUBJECT TO POSSIBLE CHANGE.

- RAINSCREEN METAL PANEL
- 2 STOREFRONT GLAZING
- **3** METAL CANOPY
- 4 JUILET BALCONY WITH PANELIZED RAILING
- 5 RAINSCREEN
- **6** METAL CORNICE
- **⑦** GFRC/ CLADDING/ METAL
- **8** HORIZONTAL COMPOSITE SIDING



NOTE: REFERENCE LANDSCAPE DRAWINGS FOR LANDSCAPE DESIGN STYLE ELEVATIONS ARE INTENDED TO INDICATE ARCHITECTURE CHARACTERS AND SUBJECT TO CHANGE AS DESIGN PROGRESSES.



DATE: 6-28-2018
PROJECT#: SCALE: As indicated
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SHEET TITLE ARCHITECTURAL STYLE 4

SHEET NUMBER A2.04


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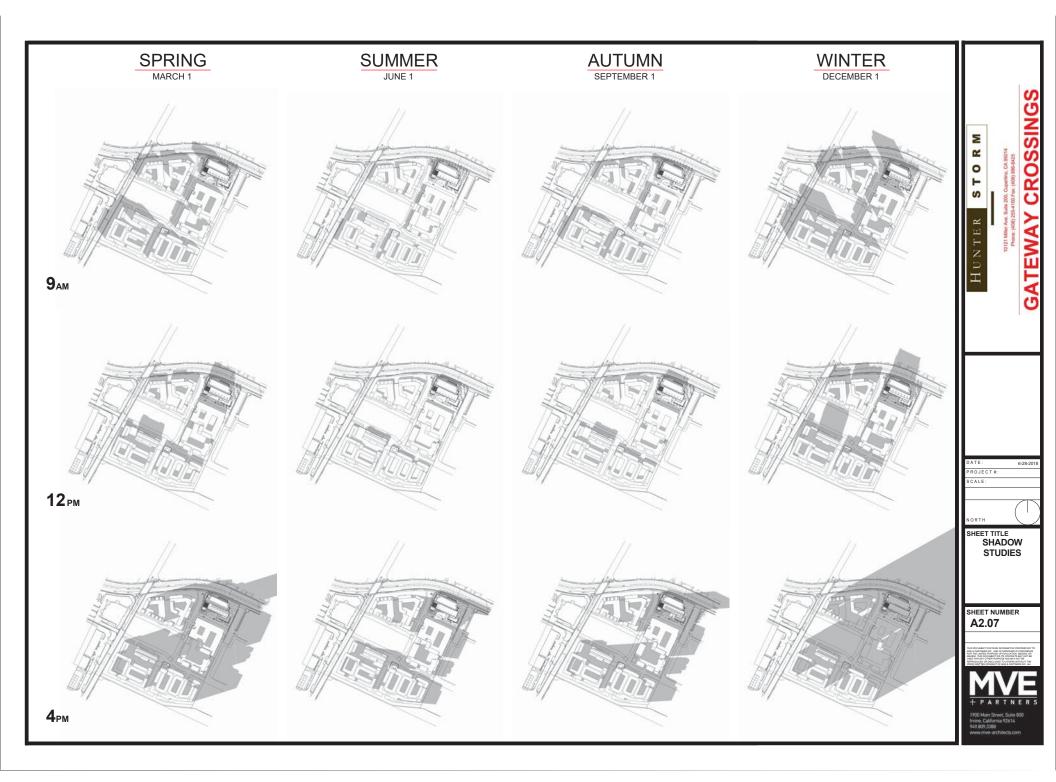
BUILDING 3 NORTH
ELEVATION(FRONTING INTERNAL


STREET)

1/8" = 1'-0"





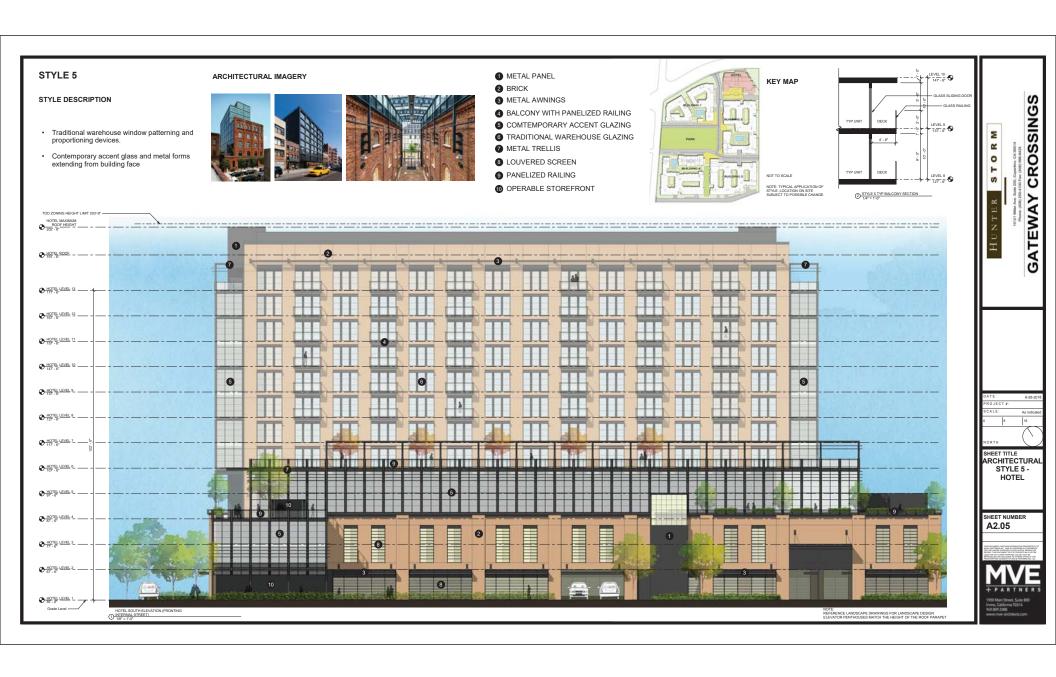

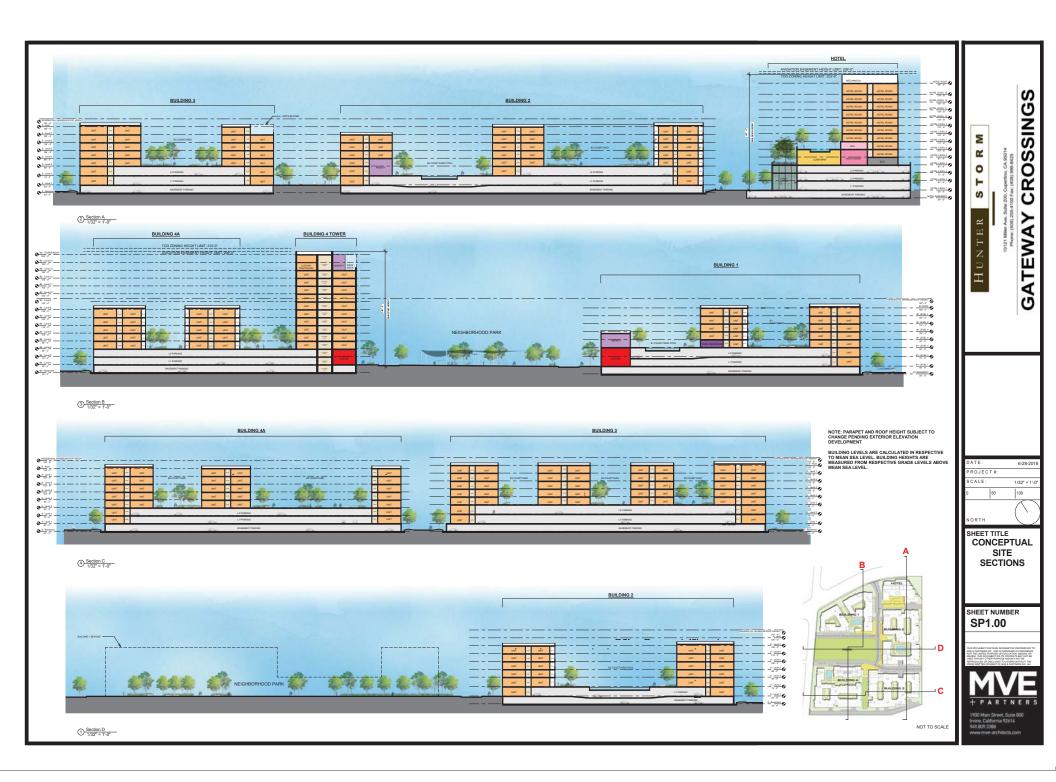



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DATE:	6-28-2018
PROJECT#:	
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SHEET TITLE VENTILATION PLAN MAP

SHEET NUMBER SP3.01





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DATE: 08:08:18 PROJECT#:

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SHEET TITLE

Schematic Landscape Plan -Overall

SHEET NUMBER

L-1.0

THE GUZZARDO PARTNERSHIP INC Landscape Architects - Land Planner

pe Architects - Land Plan 181 Greenwich Street San Francisco, CA 54111 T 415 433 4672 F 415 433 5003

LEGEND DUTDOOR GRILL DINING AREA Building 2 ***** Neighborhood Park Building 4 SEE SHEET L-1.2 FOR PARK CREDIT LEGEND.

SEE ARCHITECTURAL DRAWINGS FOR BUILDING INTERIOR AREA CALCULATIONS.

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DATE: 08.06.18 PROJECT#: SCALE: AsNote

SHEET TITLE Park Master Plan

SHEET NUMBER

L-1.1

THE GUZZARDO PARTNERSHIP INC scape Architects - Land Planner

PARTINERSHIP IN pe Architects - Land Plann 1811 Greenwich Street Sen Francisco, CA 9/111 7 415 433 4672 F 415 433 5003

PARK CREDIT LEGEND

SITE - ON GRADE

COLOR	CATEGORY	PROGRAM USES	ELEMENTS	AREA PROVIDED
	NEIGHBORHOOD PARK	OPEN LAWN AREA (26,800 sf) EXERCISE AREA (8,040 sf) PLAY AREA (9,916 sf) GRILL AND PICNIC AREA (3,876 sf)	OPEN LAWN x FINESS STATIONS, x BIKE PARKING, SHADE STRUCTURE, SEAT WALL AND BENCH x PLAY FOUIPMENT, x SEATING SPACES, SHADE SAILS, x BIKE PARKING SPACES x BBQ GRILLS, x PICNIC TABLES WITH x SEATING SPACES	93,446 SF
	LANDSCAPED AND FURNISHED QUIET AREAS	RED GARDEN (1,426 st) WHITE GARDEN (880 st) BLUE GARDEN (1,215 st) SEATING PLAZA (2,208 st) HAMMOCK GARDEN (1,053 st)	14 SEATING SPACES, A PLANTER POTS, LIVING WALL, TREE STRING LIGHTS 12 SEATING SPACES, 2 BINE PARRING SPACES, FOUNTAIN, 16 SEATING SPACES, 4 BINE PARRING SPACES, 12 PLANTER POTS 68 SEATING SPACES, TREE GROVE, 16 BINE PARRING SPACES, 48 PLANTER POTS 4 HAMMOCKS IN PALM TREE GROVE	6,882 SF
				100,328 SF TOTAL

BUILDING 1 PODIUM

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	OUTDOOR SEATING, FIREPLACE	FIREPLACE WITH LOUNGE SEATING (3,760 sf) OUTDOOR SEATING AREA (665 sf)	4 FIREPLACES, 42 SEATING SPACES, 7 PLANTER POTS 12 SEATING SPACES	4,425 SF						
	OUTDOOR GRILL, DINING AREA	BBQ COUNTER WITH OUTDOOR DINING AND COMMUNAL TABLES (1,090 sf)	2 BBQ GRILLS, 2 COMMUNAL TABLES WITH 16 SEATING SPACES	1,090 SF						
	POOL AND SPA	POOL WITH LAP SWIMMING (2,980 sf) SPA (198 sf) POOL DECK AND LOUNGE AREA (4,469 sf)	4. SWMMING LANES 9'x16' SPA 50 CHAISE LOUNGE SEATING	7,647 SF						
	INDOOR AMENITY AREA	CENTRAL GYM, CLUBHOUSE, POOL FACILITIES, VIEW LOUNGE		6,200 SF						
				19,362 SF TOTAL						

BUILDING 2 PODIUM

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		OUTDOOR SEATING, FIREPLACE	FIREPLACE AND LOUNGE SEATING	2 FIREPLACES, 26 SEATING SPACES, 3 PLANTER POTS	2,960 SF
		OUTDOOR GRILL, DINING AREA	BBQ COUNTER WITH OUTDOOR DINING AND COMMUNAL TABLES	4 BBQ GRILLS, 4 COVERED TABLES, 2 COMMUNAL TABLES, 42 SEATING SPACES, 3 SHADE STRUCTURES, 11 PLANTER POTS	2,965 SF
		POOL AND SPA	POOL WITH LAP SWMMING (2,940 sf) SPA (160 sf) POOL DECK AND LOUNGE AREA (5,234 sf)	4 SWMING LANES 10/v16" SPA 30 CHAISE LOUNGE SEATING	8,014 SF
		COMMON FITNESS, GAME AREA, SCREENING ROOM	OUTDOOR SCREENING ROOM (805 sf) FITNESS ZONE WITH EXERCISE EQUIPMENT (2,275 sf)	MOVIE SCREEN WITH 8 SEATING SPACES 2 FITNESS STATIONS, RUBBERIZED PLAYGROUND, 4 BENCHES	3,084 SF
		INDOOR AMENITY AREA	GAME ROOM, CLUBHOUSE, POOL FACILITIES		8,600 SF
					25,623 SF TOTAL

BUILDING 3 PODIUM

OUTDOOR SEATING, FIREPLACE	FIREPLACE WITH LOUNGE SEATING (2,035 sf) COVERED SEATING AREA (1,480 sf)	2 FIREPLACES, 15 LOUNGE SEATING SPACES, 6 PLANTER POTS 1 SHADE STRUCTURE, 20 SEATING SPACES, 7 PLANTER POTS	3,520 SF
OUTDOOR GRILL, DINING AREA		5 BBQ GRILLS, 2 COMMUNAL TABLES, 44 SEATING SPACES, 4 PLANTER POTS, 2 SHADE STRUCTURES	2,265 SF
COMMON FITNESS, GAME AREA, SCREENING ROOM	MINI GOLF ZONE	PUTTING GREEN, 2 BENCH SEATINGS	2,430 SF
INDOOR AMENITY AREA	CLUBHOUSE, GREAT ROOM		8,000 SF
			16,215 SF TOTAL

BUILDING 4 PODIUM

BUILDING	JEDING 4 PODION									
	OUTDOOR SEATING, FIREPLACE	FIREPLACE WITH LOUNGE SEATING (650 sf) LOUNGE SEATING AREA (2,545 sf) SCULPTURE FOREST WITH SEATING (3,840 sf) OUTDOOR WORK PLACE (135 sf)	1 FIREPLACE, 9 LOUNCE SEATING SPACES 50 LOUNCE SEATING SPACES, 4 PLANTER POTS VERTICAL SOLUPTURES, 4 HAMMOCKS, 25 SEATING SPACES, 8 PLANTER POTS 7 LOUNCE SEATING SPACES, CHARGING STATIONS, WIFI	7,180 SF						
	OUTDOOR GRILL, DINING AREA	BBQ COUNTER WITH OUTDOOR DINING AND COMMUNAL TABLES	4 BBQ GRILLS, 1 SHADE STRUCTURE, 3 HIGH TOPS WITH 6 SEATING SPACES, 2 COMMUNAL TABLES WITH 16 SEATING SPACES, 12 BAR SEATINGS	1,670 SF						
	POOL AND SPA	POOL WITH LAP SWIMMING (2,715 sf) SPA (160 sf) POOL DECK AND LOUNGE AREA (4,195 sf)	4 SWMING LANES 10/v16" SPA 21 CHAISE LOUNGE SEATING	7,075 SF						
	GAME AREA, SCREENING ROOM	OUTDOOR MOVIE SCREEN (775 sf) OUTDOOR GAME ROOM (515 sf)	MOWE SCREEN, 8 SEATING SPACES, 4 PLANTER POTS 1 BOCCE BALL COURT	1,295 SF						
	INDOOR AMENITY AREA	CLUBHOUSE, GREAT ROOM		1,1100 SF						
TOTAL	1051 DD01//D5	50 500 0N 0D405 BUILDING BODUN 15	ELO AND DINIDINO INTEDIOD 400 040 05 (4.75 A0050)	28,320 SF TOTAL						

TOTAL AREA PROVIDED FOR ON GRADE, BUILDING PODIUM LEVELS AND BUILDING INTERIOR: 189,848 SF (4.35 ACRES) SEE SHEET L-1.1 FOR PARK MASTER PLAN.

A BUFFER STRIP/SETBACK OF AT LEAST 4 FEET BETWEEN BUILDINGS AND PUBLIC PARKLAND/AMENITIES IS DEDUCTED FROM AREA CALCULATIONS.

SEE ARCHITECTURAL DRAWINGS FOR BUILDING INTERIOR AREA CALCULATIONS.

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CROSSINGS

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SCALE: As Noted

SHEET TITLE Park Credit Legend

SHEET NUMBER

L-1.2



181 Greenwich Street San Francisco, CA 94111 T 415 433 4672 F 415 433 5003

PLANTING NOTES

- All work shall be performed by persons familiar with planting work and under supervisions
 of a qualified planting foreman.
- Plant material locations shown are diagrammatic and may be subject to change in the field by the Landscape Architect before the maintenance period begins.
- 3. All trees are to be staked as shown in the staking diagrams.
- All tree stakes shall be cut 6" above tree ties after stakes have been installed to the depth indicated in the staking diagrams. Single stake all conifers per tree staking
- 5. Plant locations are to be adjusted in the field as necessary to screen utilities but not to block windows nor impede access. The Landscope Architect reserves the right to make minor adjustments in tree locations after planting at no cost to the Owner. All plenting located adjusted to signs shall be field adjusted so as not to interfere with visibility of the signs.
- The Landscape Architect reserves the right to make substitutions, additions, and deletions in the planting scheme as felt necessary while work is in progress. Such changes are to be accompanied by equitable adjustments in the contract price if/when necessary and subject to the Owner's approval.
- The contractor is to secure all vines to walls and columns with approved fasteners, allowing for two (2) years growth. Submit sample of fastener to Landscape Architect for review prior to ordering.
- All planting areas, except lowns and storm water treatment zones (as defined by the civil engineer), shall be top-dressed with a 3" layer of recycled wood mulch, Colored Wood Chip" by Walon Recycling (2014-261.100), www.sionerecycling.com)or equal. Planter pots shall be top-dressed with the smaller "Colored Lumber Fines" mulch, also from Valion Recycling. Mulch shall be drut brown in color. Submit sample to Landscape Architect for review prot to ordering. Hold all mulch six (6) inches from all plants where mulch is applied over the roblotal.
- All street trees to be installed in accordance with the standards and specifications of the City of Santa Clara. Contractor to contact the city arborist to confirm plant type the City of Santa Clara. Contractor to contact the city abords and specifications of plant are (at installation, installation detailing and locations prior to proceeding with plant are (at installation,) installation detailing and locations prior to proceeding with the contract of the
- 10. Seasonal color is to be current and locally ovaliable. Plant material is to be selected by the Landscape Architect from a list of currently ovaliable stock provided by the Landscape Contractor prior to installation. Seasonal color to be 4" pots at 12" o.c. unless otherwise noted.
- 11. The lown shall be sad or seeded (as noted) and consist of a drought tolerant hard fescue blend such as Pocific Sad Medallion Dwarf with Bonsai", installed per manufacturer's recommendations and specifications. The mix shall consist of the following proportions of grass species: 100% Bonsai Double Dwarf fescue. Available through: Pocific Sad 800/542/7633
- Trees planted in lawn areas shall not have lawn planted over the top of the rootball but shall have 12" diameter circle of lawn cut out for trimming purposes.
- 13. Plants shall be installed to anticipate settlement. See Tree and Shrub Planting Details.
- 14. All interior trees noted with 'deep root' and those planted within 5'-0" of concrete paving, curbs, and walls shall have deep root barriers installed per manufacturer's specifications. See specifications and details for materials, depth of material, and location of installation.
- 15. The Landscape Contractor shall arrange with a nursery to secure plant material noted on the drawings and have those plants available for review by the Owner and Landscape Architect within thirty (30) alogs of award of contract. The Contractor shall purchase the material and have it segregated and grown for the job upon approval of the plant contractor. Let deposit necessary for such contract grawing is to be form by the Contractor.
- 17. The Landscape Contractor shall verify the location of underground utilities and bring any conflicts with plant material locations to the attention of the Landscape Architect for a decision before proceeding with the work. Any utilities shown on the Landscape drawing are for reference and coordination purposes only. See Civil Drawings.
- 18. The design intent of the planting plan is to establish an immediate and attractive mature landscape appearance. Future plant growth will necessitate trimming, shaping and, in some cases, removal of trees and shrubs as an on-going maintenance procedure.
- 19. Install all plants per pian locations and per patterns shown on the pians. Install all shrubs to ensure that onticipated, maintained piant size is at least 2"-0" from the face of building(s) unless shown otherwise on the pians. Refer to Plant Spacing Diagram for plant masses indicated in a diagrammatic manner on the plans. Refer to Plant Spacing Diagram for spacing of forms it seeps rows.
- 20. Contractor to provide one (1) Reference Planting Area for review by Landscape Architect prior to installation of the project planting. The Reference Planting Area shall consist of Contractor to set out plants, in containers, in the locations and patterns shave not be plant, for field review by the Landscape Architect. The Reference Planting Area will be used as a guide for the remaining plant installation.
- 21. The Maintenance Period(s) shall be for 60 (sixty) days. Portions of the installed landscape of a project may be placed on a maintenance period prior to the completion of the project at the Owner's request and with the Owner's concurrence.
- Contractor to verify drainage of all tree planting pits. See Planting Specifications. Install drainage well per specifications and Tree Planting Detail(s) if the tree planting pit does not drain at a rate to meet the specifications.
- Contractor shall remove all plant and bar code labels from all installed plants and landscape materials prior to arranging a site visit by the Landscape Architect.
- 24. All trees to be planted 10' clear from the tree trunk to the sanitary sewer and storm drain mains and laterals and minimum 5' clear of any existing or proposed Electric Department facilities.

PLANT PALETTE

TREES KEY	SIZE	BOTANICAL NAME	COMMON NAME	NOTES	WUCOLS
ACE PAL	SIZE	Acer palmatum	Japanese Maple	NOTES	MOCOL:
ACE RUB		Acer rubrum 'Red Sunset'	Red Maple 'Red Sunset'		M
ARB MAR		Arbutus 'Marina'	Marina Strawberry Tree		L
BAM TEX		Bambusa 'Textilis'	Timber Bamboo		L
CAL DEC		Calocedrus decurrens	Incense-Cedar	-	М
CAR FAS		Carpinus betulus 'Fastigata'			- M
CER CAN		Cercis canadensis 'Forest Pansy'	Pyramidal European Hornbeam Forest Pansy Redbud		м
CHA HUM		Chamaerops humilis	Mediterranean Fan Palm		
CIT LEM		Citrus x meyeri	Meyer lemon		и и
CUP SEM		Cupressus sempervirens 'Stricta'	Columnar Italian Cypress		-
FIC CAR		Ficus carica 'Black Jack'	Edible Fig		м.
FRA AME		Fraxinus americana 'Autumn Purple'	Autumn Purple Ash		М
GIN BIL		Ginkgo biloba 'Fairmount'	Maindenhair Tree		М
LAG NAT		Lagerstroemia 'Natchez'	Crepe Myrtle		L
LAU SAR		Laurus 'Saratoga'	Sweet Bay		ī
LOP CON		Lophostemon confertus	Brisbane Box		i
MAG GRA		Magnolia grandiflora 'Kay Parris'	Kay Parris Magnolia		M
OLE EUR		Olea europaea 'Swan Hill'	Fruitless Olive		VL.
PIS CHI		Pistacia chinensis 'Keith Davey'	Chinese Pistache		L
PLA COL		Platanus acerfolia 'Columbia'	London Plane Tree		M
POD GRA		Podocarpus gracilior	Fern Pine		М
PRU CAR		Prunus caroliniana 'Bright and Tight'	Carolina Cherry Laurel		L
QUE FRA		Quercus frainetto 'Schmidt'	Hungarian Oak		L
QUE LOB		Quercus Iobata	Valley Oak	†	L
QUE SUB		Quercus suber	Cork Oak		L
QUE VIR		Quercus virginiana	Live Oak		м
WAS FIL		Washingtonia filifera	California Fan Palm		L
SHRUBS					
KEY	SIZE	BOTANICAL NAME	COMMON NAME	SPACING	WUCOLS
ABG	5 ggl	Anigozanthos 'Bush Gold'	Yellow Kangaroo Paw	24" o.c.	L
ACC	5 gal	Acacia cognata 'Cousin Itt'	Little River Wattle	30" o.c.	L
ADM	5 gal	Asparagus d. 'Meyers'	Myers Asparagus Fern	30" o.c.	М.
AGB	5 gal	Agave 'Blue Flame'	Blue Flame agave	30" o.c.	L
AMO	5 gal	Acanthus mollis	Blue Flame agave Bears Breech	36" o.c.	м
ARC	5 gal	Arctostaphylos densiflora 'Howard McMinn'		48" o.c.	-
BSG		. ,	Boxwood		М
CEC	5 gal	Buxus s. 'Green Beauty'		24" o.c.	٧L
	5 gal	Ceanothus 'Concha'	California Lilac	48" o.c.	
CHO	5 gal	Chondropetalum tectorum	Cape Rush	30" o.c.	L M
				18" o.c.	
CLB	5 gal	Clivia m. 'Belgian Hybrid Yellow'	Kaffir Lily		
CPC	5 gal	Coleonema p. 'Compacta'	Compact Breath of Heaven	36" o.c.	М
CPC CPS	5 gal 5 gal	Coleonema p. 'Compacta' Coleonema p. 'Sunset Gold'	Compact Breath of Heaven Gold Breath of Heaven	36" o.c.	М
CPC CPS CRE	5 gal 5 gal 5 gal	Coleonema p. 'Compacta' Coleonema p. 'Sunset Gold' Cycas revoluta	Compact Breath of Heaven Gold Breath of Heaven Sago Cycad	36" o.c. 36" o.c. 36" o.c.	М
CPC CPS CRE DBI	5 gal 5 gal 5 gal 5 gal	Coleonema p. 'Compacta' Coleonema p. 'Sunset Gold' Cycas revoluta Dietes Bicolor (s)	Compact Breath of Heaven Gold Breath of Heaven Sago Cycad Fortnight Lily	36" o.c. 36" o.c. 36" o.c. 36" o.c.	M M L
CPC CPS CRE DBI DLR	5 gal 5 gal 5 gal 5 gal 5 gal	Coleonema p. 'Compacta' Coleonema p. 'Sunset Gold' Cycas revoluta Dietes Bicolor (s) Dianella 'Little Rev'	Compact Breath of Heaven Gold Breath of Heaven Sago Cycad	36" o.c. 36" o.c. 36" o.c. 36" o.c. 18" o.c.	M M L
CPC CPS CRE DBI	5 gal 5 gal 5 gal 5 gal	Coleonema p. 'Compacta' Coleonema p. 'Sunset Gold' Cycas revoluta Dietes Bicolor (s)	Compact Breath of Heaven Gold Breath of Heaven Sago Cycad Fortnight Lily	36" o.c. 36" o.c. 36" o.c. 36" o.c.	M M L M
CPC CPS CRE DBI DLR	5 gal 5 gal 5 gal 5 gal 5 gal	Coleonema p. 'Compacta' Coleonema p. 'Sunset Gold' Cycas revoluta Dietes Bicolor (s) Dianella 'Little Rev'	Compact Breath of Heaven Gold Breath of Heaven Sago Cycad Fortnight Lily Dwarf Flax Lily	36" o.c. 36" o.c. 36" o.c. 36" o.c. 18" o.c.	M M L M
CPC CPS CRE DBI DLR DTV	5 gal 5 gal 5 gal 5 gal 5 gal 5 gal	Coleonema p. 'Compacta' Coleonema p. 'Sunset Gold' Cycas revoluta Dietes Bicolor (s) Dianella 'Little Rev' Dianella t. 'Variegata'	Compact Breath of Heaven Gold Breath of Heaven Sago Cycad Fortnight Lily Dwarf Flax Lily Varegated Flax Lily	36" o.c. 36" o.c. 36" o.c. 36" o.c. 18" o.c. 24" o.c.	M M L M
CPC CPS CRE DBI DLR DTV ECW	5 gal 5 gal 5 gal 5 gal 5 gal 5 gal 5 gal	Coleonema p. 'Compacta' Coleonema p. 'Sunset Cold' Cycos revoluta Dietes Bicolor (s) Dianella L'ittle Rev Dianella t. 'Variegata' Euphorbia c. 'Wulfenii'	Compact Breath of Heaven Gold Breath of Heaven Sago Cycad Fortnight Lily Dwarf Flax Lily Varegated Flax Lily Euphorbia	36" o.c. 36" o.c. 36" o.c. 36" o.c. 18" o.c. 24" o.c. 30" o.c.	M M L M
CPC CPS CRE DBI DLR DTV ECW ELA	5 gal 5 gal 5 gal 5 gal 5 gal 5 gal 5 gal 5 gal	Coleonema p. 'Compacta' Coleonema p. 'Sunset Gold' Cycar revoluta Dietes Bicolor (s) Dietes Bicolor (s) Dianella 'Litte Rev' Dianella 't. 'Variegata' Euphorbia c. 'Wulfenii' Euphorbia c. 'Wulfenii'	Compact Breath of Heaven Gold Breath of Heaven Sago Cycad Fortnight Lily Dwarf Flax Lily Varegated Flax Lily Euphorbia Yellow—Edge Elaeagnus	36" o.c. 36" o.c. 36" o.c. 18" o.c. 24" o.c. 48" o.c.	M L M L L
CPC CPS CRE DBI DLR DTV ECW ELA FJM	5 gal 5 gal 5 gal 5 gal 5 gal 5 gal 5 gal 5 gal 5 gal 5 gal	Coleonema p. 'Compocto' Coleonema p. 'Sunset Cold' Cyces revoluta Dietes Bicolor (s) Dianella 'Little Rev' Dianella t. 'Variegata' Euphorbia c. 'Wulfenii' Fatsia j. Moserr' Fatsia j. Moserr'	Compact Breath of Heaven Gold Breath of Heaven Sago Cyced Fortnight Lily Dwarf Flox Lilly Voregated Flox Lilly Euphorbia Yellow-Edge Elaeagnus Compact Jopanese Aralia	36" o.c. 36" o.c. 36" o.c. 36" o.c. 18" o.c. 24" o.c. 30" o.c. 48" o.c. 30" o.c.	M M L L L M M
CPC CPS CRE DBI DLR DTV ECW ELA FJM FSE	5 gal 5 gal	Coleonema p. 'Compacta' Coleonema p. 'Sunset Cola' Cycar revoluta Dietes Bicolar (s) Dietes Bicolar (s) Dinella 'Litte Rev' Dianella 'Litte Rev' Dianella 'Litte Rev' Dianella 'Li 'Variegata' Euphorbia c. 'Wulfenil' Euphorbia c. 'Wulfenil' Fatisia' j. Maseri' Feljoa sellowiana Grewillea 'Ruby Clusters'	Compact Breath of Heaven Gold Breath of Heaven Sago Cycad Fortnight Lily Dworf Flax Lily Voregated Flax Lily Euphorbia Yellow—Edge Elaeagnus Compact Japanese Aralia Pincapple Guava Grevillea	36" o.c. 36" o.c. 36" o.c. 36" o.c. 18" o.c. 24" o.c. 30" o.c. 48" o.c. 30" o.c. 42" o.c.	M M L L L M M L L L L M M
CPC CPS CRE DBI DLR DTV ECW ELA FJM FSE GRE HME	5 gal 5 gal	Coleonema p. Compacto Coleonema p. Sunset Cold Coleonema p. Sunset Cold Coleonema p. Sunset Cold Coleonema p. Sunset Cold Diarella Little Rev Dianella Little Rev Dianella Little Rev Euphorbia c. "Wulfenil" Fatja S Moseri Fatja s Moseri Faija sellowiana Corvillea Ruby Custers' Hydrongea m. Endless Summer'	Compact Breath of Heaven Gold Breath of Heaven Sago Cycod Fortnight Lily Dworf Flax Lily Waregoted Flax Lily Euphorbia Yellow-Edge Elaeagnus Compact Japanese Ardia Pineapple Guava Grevillea Hydrangea	36" o.c. 36" o.c. 36" o.c. 36" o.c. 18" o.c. 24" o.c. 30" o.c. 48" o.c. 42" o.c. 42" o.c. 430" o.c.	M M L L L L L L L L L
CPC CPS CRE DBI DLR DTV ECW ELA FJM FSE GRE	5 gal 5 gal	Coleonema p. 'Compacta' Coleonema p. 'Sunset Cola' Cycar revoluta Dietes Bicolar (s) Dietes Bicolar (s) Dinella 'Litte Rev' Dianella 'Litte Rev' Dianella 'Litte Rev' Dianella 'Li 'Variegata' Euphorbia c. 'Wulfenil' Euphorbia c. 'Wulfenil' Fatisia' j. Maseri' Feljoa sellowiana Grewillea 'Ruby Clusters'	Compact Breath of Heaven Gold Breath of Heaven Sago Cycad Fortnight Lily Dworf Flax Lily Voregated Flax Lily Euphorbia Yellow—Edge Elaeagnus Compact Japanese Aralia Pincapple Guava Grevillea	36" o.c. 36" o.c. 36" o.c. 36" o.c. 18" o.c. 24" o.c. 30" o.c. 48" o.c. 42" o.c. 48" o.c.	M M L L L M M L L M M

PLANT	OUAN	ITITY D	DIAGRAM
SPACING 'A'	SPACING 'B'	SPACING 'C'	NO. OF PLANTS/SQUARE FOOT
6" O.C.	5.20"	2.60*	4.60
8" O.C.	6.93"	3.47*	2.60
9" O.C.	7.79"	3.90*	1.78
10" O.C.	8.66"	4.33*	1.66
12" O.C.	10.40"	5.20*	1,15
15" O.C.	13.00"	6.50"	0.74
18" O.C.	15.60"	7.80*	0,51
24" O.C.	20.80*	10.40	0.29
30" O.C.	26.00*	13.00*	0.18
36" O.C.	30.00*	15.00*	0.12

0 0 0 0 0 0 Diagram for use when plants are spaced equidistant from each other as in all ground cover plantings and massed shrub plantings.

PLANT CALLOUT SYMBOL

PLANT SPACING DIAGRAM

Adjacent Curb, Sidewalk, Planting Bed or-Wall, where occurs.

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Quantity (or See Spacing Comments)
Plant Key (See Plant List)

SPACING 'A'		SPACING 'C'	NO. OF PLANTS/SQUARE FOOT
6" O.C.	5.20"	2.60*	4.60
8" O.C.	6.93"	3.47*	2.60
9" O.C.	7.79"	3.90*	1.78
10" O.C.	8.66"	4.33*	1.66
12" O.C.	10.40"	5.20*	1.15
15" O.C.	13.00"	6.50"	0.74
18" O.C.	15.60"	7.80*	0.51
24" O.C.	20.80*	10.40*	0.29
30° O.C.	26.00*	13.00	0.18
36" O.C.	30.00*	15.00*	0.12
48" O.C.	40.00*	20.00"	0.07
72* O.C.	62.35*	31.18"	0.04

LEY	5 gal	Leymus condensatus 'Canyon Prince'	Canyon Prince Wild Rye	36" o.c.	L
LLE	5 gal	Leonotis leonuris	Lion's Tail	36" o.c.	L
LLT	5 gal	Lomandra 'Lime Tuff'	Dwarf Mat Rush	24" o.c.	L
LPI	5 gal	Leucadendron 'Pisa'	Leucadendron	42" o.c.	L
MCI	5 gal	Muchlebergia capilaris 'Irvine'	Pink Muhly Grass	36" o.c.	L
NEP	5 gal	Nephrolepis cordifolia	Sword Fern	24" o.c.	М
OLO	5 gal	Olea e. 'Little Ollie'	Dwarf Olive	36" o.c.	VL
OSM	5 gal	Osmanthus fragrans	Sweet Olive	60" o.c.	М
PCA	5 gal	Prunus caroliana	Carolina Cherry Laurel	48" o.c.	L
PDA	5 gal	Polygala x dalmaisiana	Sweet Pea Shrub	36" o.c.	L
PDC	5 gal	Phormium 'Dusky Chief'	New Zealand Flax	36" o.c.	L
PFI	5 gal	Phormium 'Firebird'	New Zealand Flax	36" o.c.	L
PFR	5 gal	Phlomis fruticosa	Sweet Pea Shrub	36" o.c.	L
PIP	5 gal	Photinia x f. 'Indian Princess'	Chinese Photinia	36" o.c.	М
PIT	5 gal	Pittosporum tobira 'Cream de Mint'	'Cream de Mint' Pittosporum	24" o.c.	L
PLA	5 gal	Prunus Igurocerasus	English Laurel	48" o.c.	М
POM	15 gal	Podocarpus e. 'Monmal'	Icee Blue Yellow Wood	42" o.c.	М
PRS	5 gal	Phormium 'Rainbow Sunrise'	New Zealand Flax	30" o.c.	L
PRW	5 gal	Phormium 'Rainbow Warrior'	New Zealand Flax	30" o.c.	L
PYW	5 gal	Phormium 'Yellow Wave'	New Zealand Flax	36" o.c.	L
RHA	5 gal	Rhaphiolepis indica 'Clara'	Indian Hawthorn	36" O.C.	L
RHM	5 gal	Rhamnus californica 'Eve Case'	Coffeeberry	48" O.C.	L
RWS	5 gal	Rosa 'White Simplicity'	White Simplicity Rose	42" o.c.	М
RTB	5 gal	Rosmarinus 'Tuscan Blue'	Tuscan Blue Rosemary	36" o.c.	L
SLB	5 gal	Salvia leucantha 'Santa Barbara'	Mexican Sage	36" o.c.	L
SRE	5 gal	Strelitzia reginae	Bird of Paradise	36" o.c.	М
GROUNDCO	OVER				
KEY	SIZE	BOTANICAL NAME	COMMON NAME	SPACING	WUCOLS
AQ	1 gal	Agapanthus 'Queen Anne'	Lily of the Nile	18" o.c.	М
AR	5 gal	Arctostaphylos 'Pacific Mist'	Manzanita	30" o.c.	VL
BC	1 gal	Bergenia crassifolia	Winter Blooming Bergenia	18" o.c.	М
CE	5 gal	Ceanothus g. h. 'Yankee Point'	Yankee Point Ceanothus	30" o.c.	L
CH	5 gal	Cuphea hyssopifolia	Mexican Heather	24" o.c.	М
CK	1 gal	Coprosma x kirkli	Creeping Coprosma	30" o.c.	L
CM	1 gal	Convolvulus mauritanicus	Ground Morning Glory	30" o.c.	L
CP	1 gal	Campanula portenschlagiana	Serbian Bellflower	18" o.c.	М
CS	5 gal	Coleonema p. 'Sunset Gold'	Dwarf Breath of Heaven	30" o.c.	М
EF	1 gal	Euonymus fortunei	Wintercreeper	24" o.c.	L
LA	5 gal	Lavandula intermedia	Lavender	24" o.c.	L
Ш	1 gal	Liriope m. 'Big Blue'	Lily Turf	18" o.c.	М
MA	5 gal	Mahonia repens	Creeping Mahonia	30" o.c.	L
NH	5 gal	Nandina 'Harbour Dwarf'	Dwarf Heavenly Bamboo	30" o.c.	L
RP	1 gal	Rubus pentalobus 'Emerald Carpet'	No Common Name	36" o.c.	М
RS	5 gal	Rosa 'Flower Carpet Amber'	Amber Carpet Rose	36" o.c.	М
ST	5 gal	Stipa arundinacea	New Zealand Wind Grass	24" o.c.	М
VINES					
KEY	SIZE	BOTANICAL NAME	COMMON NAME	SPACING	WUCOLS
В	5 gal	Bougainvillea spectabilis	Bougainvillea		L
	1 gal	Ficus pumila	Creeping Fig		М
F	l dai		+		М
F P	1 gal	Parthenocissus tricuspidata	Boston Ivy		
Р		Parthenocissus tricuspidata	Boston Ivy		
		Parthenocissus tricuspidata Medallion Plus	Boston Ivy Medallion Plus		н

TREE MITIGATION CHART

KEY SIZE

LBA

BOTANICAL NAME

LEU 5 gal Leucospermum cordifolium 'Flame Spike' Nodding Pincushion

5 gal Lavatera t. 'Barnsley'

LCB 5 gal Loropetalum c .'Blush'

Total Existing Trees on Site	
Total Existing Trees Previously Removed	227
Additional Existing Trees to be Removed	5
Minimum Replacement Trees Required at 2:1 Ratio	464

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SPACING WUCOLS

48" o.c.

36" o.c.

48" o.c.

COMMON NAME

Tree Mallow

Red Fringe Flower

-S

S C A L E : As Noted

SHEET TITLE Planting Notes and Legends

SHEET NUMBER

L-1.3



181 Greenwich Street San Francisco, CA 94111 T 415 433 4672 F 415 433 5003









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STOR

DATE: 08.06.18 PROJECT#:

PROJECT#: SCALE: As Noted

SHEET TITLE

Schematic Landscape Plan -Site

SHEET NUMBER

L-2.2

THE GUZZARDO PARTNERSHIP INC. Landscape Architects - Land Planners

e Architects - Land Plar 181 Greenwich Street Son Francisco, CA 94111 T 415 423 4672





CROSSINGS GATEWAY



Landscape Plan -





10121 Miles Ave. Suite

STORM



DATE: 08.06.18
PROJECT#:
SCALE: As Noted

SHEET TITLE

Schematic Landscape Plan -Site

SHEET NUMBER

L-2.4

THE GUZZARDO PARTNERSHIP INC.

r Architects - Land Plan 181 Greenwich Street San Francisco, CA 94111 T 415 423 4672



STORM

DATE: 08.08.18

PROJECT#: SCALE: As Noted

SHEET TITLE

Schematic Landscape Plan -Site

SHEET NUMBER

L-2.5

THE GUZZARDO PARTNERSHIP INC.

181 Greenwich Street San Francisco, CA 94111 T 415 423 4672 F 415 433 5003



10121 Miller Ave. Sul

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STO



DATE: 08.08.18

PROJECT#: SCALE: As Noted

SHEET TITLE

Schematic Landscape Plan -Site

SHEET NUMBER

L-2.6



rchitects - Land Plans Greenwich Street Francisco, CA 94111 15 423 4572



CROSSINGS

GATEWAY

10121 Miller Ave. Suite

STO

DATE-06,28.18

PROJECT#:

SHEET TITLE

Schematic Landscape Plan-Podium Building 1

SHEET NUMBER

L-2.7

THE GUZZARDO PARTNERSHIP INC

rchitects - Land Plann I Greenwich Street In Francisco, CA 94511 15 433 4672

Building 1 - with Typical Fireplace Seating Area Planting Scheme

Countries and Low Previous Production Find Doos Previous Production 1. In Finding 1. In Findi

Hotel - Levels 4, 6 and Roof Deck



GATEWAY CROSSINGS

STOR

PROJECT#:

OJECT#: ALE: As Noted

SHEET TITLE

Schematic Landscape Plan-Podium Hotel

SHEET NUMBER

L-2.8



Architects - Land Pla 81 Greenwich Street on Francisco, CA 94111 415 483 4672



Building 2 - with Typical Sunny Area Planting Scheme



STOR



PROJECT#:

ALE: As Noted

SHEET TITLE

Schematic Landscape Plan-Podium Building 2

SHEET NUMBER

L-2.9

THE GUZZARDO PARTNERSHIP INC

r Architects - Land Plan 181 Greenwich Street Sen Francisco, CA 94111 T 415 433 4672



PROJECT#:

SCALE: As Nos

SHEET TITLE

Schematic Landscape Plan-Podium Building 3

SHEET NUMBER

L-2.10

THE GUZZARDO PARTNERSHIP INC.

Architects - Land Pla 81 Greenwich Street on Francisco, CA 94111 415 433 4672



and walk Miles

STO

PROJECT#:

SHEET TITLE

Schematic Landscape Plan-Podium Building 4

SHEET NUMBER

L-2.11



Architects - Land Plan 181 Greenwich Street Sen Francisco, CA 94111 1 415 433 4672

WATER USE LEGEND Key **Wucols Category** Area Low Water Use 124,395 sf Medium Water Use 68,935 sf High Water Use 26,762 sf Water Feature 1,809 sf ×

GATEWAY CROSSINGS

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S

DATE: 08.08.18
PROJECT#:
SCALE: As Noted

SHEET TITLE

Irrigation Zoning Diagram

SHEET NUMBER


L-3.1

THE GUZZARDO PARTNERSHIP INC. Landscape Architects · Land Planners

Architects * Land Plan 181 Greenwich Street San Francisco, CA 94111 T 415 433 4672

PRELIMINARY WATER EFFICIENT LANDSCAPE WORKSHEET Reference Evapotranspiratio, (ETa) 43.3 Implement State (ETAF (PFRE) Landscape (ETAF Area (Ethiology (ETAF (1.00 0.80 mia Total 193,866 82,165 2,313,015 1 200 200 78088 Park Turf Maximum Allowed Water Allowance (MARIA). 3.201.852 Andrews Miller Street #ETMY (Annual Saftons Required) - Eta x d.42 x ETAF x.Ansa share 3.62 is a convenior factor that convents some inches per actor per year to gallone per square foct per ±40/491 (Annual Gallains Albamed *(20)) (02) /(00) *(10) *(Regular Landscape Areas Total ETAF + Area (B) Average ETAF All Landscape Areas (6+0) 109,117 Sitewide ETAF (S+Q) + (A+C) 0.50

SANTA CLARA COUNTY LANDSCAPE WATER EFFICIENCY CHECKLIST

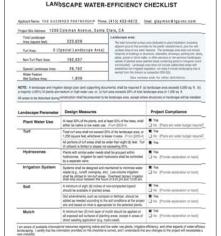

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nty Evaluation	Stuff Commode	
Not Approved	TA C	<u></u>

Applicant Comments

Hydrozone: A priftin of the temblopod area facing plants with similar water rewalls. A hydrozone may be impaind or num-propoled.

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IRRIGATION NOTES

INVIDENT TOTAL TOTAL STATES AND A ROCKING OF THE WORK TO BE RETAILED. ALL PIPAL, WAYES, LTC. SHOWN WITHIN PAVED AREA OF THE CHARGE OF THE ADMINISTRATION OF THE OWNERS OF THE OFFICENCE OF THE OWNERS OF THE OWNERS OF THE OFFICENCE OF THE OWNERS OF THE OWNE NOTIFICATION AND APPROVAL OF THE CHIEFS AN AUTHORIZED PRESIDENTAL AND AUCOURING TO THE CONTINCT SPECHGUISM. THE CONTINCTOR S CONTINCTOR AND AUTHORIZED THE REQUIRED TO NOTIFICATION OF SPECIAL PROPERTY AND COORDINATE IRROGATION OF SPEC, CONCLUT OR SLICENS THROUGH ON LODGE MALLS, ROUGHAYS, PANNE, STRUCTURE, ETC., BUTGER CONSTRUCTION. IN THE LIVENT THESE NOTIFICATIONS ARE NOT PERFORMED. THE CONTRACTOR SHALL ISSUE FILE RESPONSIBILITY FOR ALL REQUIRED REVISION.

- 2. THE CONTRACTOR SHALL EXERCISE CARE IN LOCATING PIPING AS TO NOT CONFLICT WITH OTHER UTILITIES. DO NOT INSTALL IRRIGATION PIPING PARALLEL TO AND DIRECTLY OVER OTHER UTILITIES.
- 3. THE INTENT OF THIS IRRIGATION SYSTEM IS TO PROVIDE THE MINIMUM AMOUNT OF WATER REQUIRED TO SUSTAIN GOOD PLANT HEALTH.
- 4. IT IS THE RESPONSIBILITY OF THE LANDSCAPE MANTENANCE CONTRACTOR AND/OR DIMER TO PRODORM THE IRRUATION CONTROLLER TO PROVIDE THE MANAGEM AMOUNT OF MATER MEDDED TO SUSTAIN GOOD PLANT HEALTH. THIS INCLUDES MANING ADJUSTMENTS TO THE PRODORM FOR SEASONAL WEATHER CHAMCES, PLANT MEDISAL, MIXTURE RECORDEDITIS, MOUNTES ON SUSCEPS, SIAN, 2004C, AND WAYD OFFOSIERS.
- AT THE END OF THE REQUIRED MAINTENANCE PERIOD OF THE CONTRACTOR, THE OWNER SHALL PROVIDE REQUIRE MAINTENANCE OF THE IRRIGATION SYSTEM ISSUE THE EFFICIENT USE OF WATER. MAINTENANCE SHALL INCLUDE, BUT NOT BE LIMITED TO CHECKING, ADJUSTING, AND REPAIRING IRRIGATION EQUIPMENT
- 6. 120 VOLT AC. (2.5 AMP DEMAND) ELECTRICAL SERVICE TO RENGATION CONTROLLER LOCATION TO BE PROVIDED UNDER ELECTRICAL CONTINUET WORK RENGLIGON CONTINUEDRE TO MAKE FINAL CONNECTION FROM ELECTRICAL STUB-OUT TO CONTROLLER AND PROVIDE PROPER CRICIADING PER CONTROLLER AMANEACTURIST'S RESTRICTIONS.
- 7. CONTROLLER SHALL HAVE ITS OWN GROUND ROD. THE GROUND ROD SHALL BE AN EIGHT FOOT LONG BY 5/8" DAMETER U.L. APPROVED COPPER CLAD BOOK DO. NAME: THAN 6" OF THE GROUND ROD TO BE ABONE CAPAGE. CONNECT: §5 QUICE WIRE WITH A LALL, APPROVED GROUND ROD CLAMP TO ROD AND BOOK TO GROUND SCENE AT BOOK OF A BOOK OF THE GROUND ROD CLAMP TO ROD AND BOOK OF THE ABONE AND BOOK OF THE GROUND ROD CLAMP TO ROD AND BOOK OF THE ABONE AND BOOK OF THE GROUND ROD CLAMP TO ROD AND BOOK OF THE ABONE A
- 8. IRRIGATION CONTROLLER "A" TO HAVE ITS OWN INDEPENDENT 24 VOLT COMMON GROUND WIRE. IRRIGATION CONTROLLER "16" WILL BE GROUNDED THROUGH THE BULDING ELECTRICAL PER CODE.

CONTRACTOR SHALL PROSPAM THE IRRIGATION CONTROLLERS TO PROVIDE IRRIGATION TO ALL PLANTING WITHIN THE ALLOWED WATERING WINDOW OF TIME AS REQUIRED. THE CONTRACTOR SHALL GREATE CONTROLLER PROSPAMING THAT WILL NOT EXCEED THE MAXIMAM GALLONS FOR MANUTE FLOW RATE STATED ON THE DRAWNISM, AND NOT DECEDE THE CONTROLT OF ANY MANUTE PRING.

- 10. IRRIGATION CONTROL WIRES SHALL BE HUNTER JACKETED DECODER CABLES WITH U.L. APPROVAL FOR DIRECT BURIAL IN GROUND, SIZE ∮14-1. SPLICE SHALL BE MADE WITH 3M-DOR/Y-6 SIZAL PACKS.
- 11. SPUCING OF DECODER CABLES IS NOT PERMITTED DICCEPT IN VALVE BOXES. SEAL WIRE SPUCES WITH 3M-DBR/Y-6 SPUCE SEALING DEVICES OF SIZE COMPARISE WITH WIRE SIZE. LEVAR A 30° LOND, 1° DAMETER COLO OF DICCESS WIRE AT EACH SPUCE AND A 30° LOND EVANSION LOOP DEEM 100 FEET ALONG WIRE RIN. THE'VER WEST DECIDENTED FUERY THE TIME TO MESS IS NOT REQUIRED TOORS SIZE-ES.
- 12. FLOW SENSOR CABLE SHALL BE A SHIELDED, TWISTED PAR CABLE, SIZE #16. NO SPLICES ALLOWED.
- 13. PLASTIC WALVE BOXES ARE TO BE BLACK IN COLOR WITH BOLT DOWN, NON-HNOZED COVER MARKED "RRIGATION". BOX BODY SHALL HAVE KNICK CUTS.
 MANUFACTURER SHALL BE CARSON INDUSTRIES.

14. INSTALL REMOTE CONTROL VALVE BOXES 12" FROM WALK, CURB, L/AMN, HEIGER BOXADO, BULLING, OR LANGSCAPE FEATURE. AT MULTIPLE VALVE BOX GROUPS, EACH BOX SHALL BE 12" APART. SHORT SDEE OF RECTANGLARE WALK BOXES SHALL BE 12" APART. SHORT SDEE OF RECTANGLARE WALK BOXES SHALL BE PARALLED OWN, CURB, ETC.

- 15. VALVE LOCATIONS SHOWN ARE DIAGRAMMATIC. INSTALL IN GROUND COVER/SHRUB AREAS WHERE POSSIBLE.
- 16. THE REMOTE CONTROL VALVE SPECIFIED ON THE DRAWINGS IS A PRESSURE REDUCING TYPE. SET THE DISCHARGE PRESSURE AS FOLLOWS:

17. THE IRRIGATION CONTRACTOR SHALL FLUSH AND ADJUST THE IRRIGATION SYSTEM FOR OPTIMUM PERFORMANCE AND FLOW. THROTTLE THE FLOW CONTROL AT EACH VALVE TO OBTAIN THE OPTIMUM OPERATING PRESSURE FOR EACH SYSTEM.

- 18. LOCATE BUBBLERS ON UP-HILL SIDE OF TREE.
- 19. INSTALL A VALCON 5000 SERES SPRING LOADED CHECK VALVE BELOW THOSE BUBBLERS AND EMITTERS WHERE LOW HEAD DRAINAGE WILL CAUSE EROSION AND/OR EXCESS WATER.

20. WERE IT IS NECESSARY TO EXCHANGE ADMINIST TO DISTRICT THE CONTRACTOR SHALL USE ALL PROSBEE CHAFT TO ADDIN JUST TO THISSE AND THESE ROOTS. DISCHANDING HE ARREST THE OLD (2) NOW HOUSER ROOTS COLD WHALL BE DON'T HOW. TREPOST ADMINIST THE THISSE AND CLOSED WHITH THE THIS IS NOT POSSBEE, THE SIDE OF THE TRENCH ADMINISTRATION TO THE TIESE SHALL BE KEPT SHADED WITH BEAUTH OF CHAPTER SHALL BE KEPT SHADED WITH BEAUTH OF CHAPTER SHADED.

- 21. IRRIGATION CONTRACTOR TO NOTIFY ALL LOCAL JURISDICTIONS FOR INSPECTION AND TESTING OF INSTALLED BACKFLOW PREVENTION DEVICE
- 22. PRESSURE TEST PROCEDURE. THE CONTRACTOR SHALL:

 A. NOTIFY ARCHITECT AT LEAST THREE (3) DAY IN ADVANCE OF TESTING.

 - A NOTIFY ADMITTED AT LIGHT THREE (3) DOWN A ADMINED OF TENTINE.

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- 23. THE SPRINGER SYSTEM DESIGN IS BASED ON THE MINIMAN OPERATING PRESSURE SHOWN ON THE REGISTION DAMANCS. THE REGISTION CONTROCTOR SHALL VERBY WATER PRESSURE PRIOR TO CONSTRUCTION. REPORT MY DEPERINCE RETRIES THE MATER PRESSURE REDOCATE ON THE DAMANCS AND THE ACTUAL PRESSURE REGISTION OF THE REPORT HOT OF THE PROPERTY AND THE P
- 24. IRRIGATION DEMAND: 39 GPM AT 70 PSI STATIC PRESSURE AT IRRIGATION POINT OF CONNECTION. FIELD VERIFY WATER PRESSURE PRIOR TO CONSTRUCTION.
 IF ACTUAL WATER PRESSURE DIFFERS FROM THE STATED PRESSURE CONTACT ARCHITECT FOR DIRECTION AND POSSIBLE REVISION.
- 25. PIPE THREAD SEALANT COMPOUND SHALL BE RECTOR SEAL T+2, CHRISTY'S ULTRA SEAL, OR APPROVED EQUAL.
- 26. SUB-SURFACE DRIP IRROUTION AREAS MUST BE HAND WATERED TO INCREASE SOL MUSTURE PRIOR TO PLANTING. AFTER PLANTING, THE SUBSURFACE DRIP SYSTEMS MUST BE OPERATED ON A PRECUENT MASS TO MAINTAIN SOLI MOSTURE CONTENT, DO NOT ALLOW SOLI TO DRY OUT. MAINTENANCE ROUTINE SHALL NOLLEW PROMERS ON, TO MAINTEN MOSTURE CONTENT. IN CECUNION WINE PROMERS SOL. DO NOT DAMAGE SUBSURPACE DEP TUBENS.
- 27. RECOMMENDED SHALL MANTAIN IN COSC ORCER IN THE FIELD OTTICE ONE COMPLETE SET OF BLOCK LINE FRIENDS OF ALL SPRINALER CHARRINGS.

 NEW OF FORM A PART OF THE CONTRICES, SHORM CALL MOTE BLOCK, SHORMUSE, WANTES, CONTRICLIES AND STRIN-DUSS. IN THE DOOR ANY WORK
 S NOT NEXTLEAD AS ROUGHTOON OF THE OPERANCES, SHORT WORK SHALL ES CONTRICLIES AND DUSTROOMS CONTRICTED FROM BELLEVING.

 8. ALL INSCRIPTIONS OF THE OWNERS SHALL SHOW WALKES SHALL BE LOCATED AND DIMENSIONED ACCURATELY FROM BELLEVING WALLS ON
 THE PART OF THE PART OF THE PROPERTY OF THE PART OF THE PAR
- ALL UNLESSIONUMD STUB-DUTS FOR FUTURE CONNECTIONS AND VALVES SHALL BE LOCATED AND DIMENSIONED ACCURATELY FROM BUILDING WAI ALL RECORD DIMENSIONS.

 LIFON COMPLETION OF THE WORK, OBTAIN REPRODUCIBLE PRINTS FROM ARCHITECT AND NEATLY CORRECT THE PRINTS TO SHOW THE AS-BULLT

IRRIGATION COORDINATION NOTES

1. ALL COPPER PIPING WITHIN STRUCTURE TO BE PROVIDED, ROUTED, AND INSTALLED BY PLUMBING CONTRACTOR. EXIT OF PIPE TO BE 18" BELOW FINISH GRADE.

- 3. ELECTRICAL CONTRACTOR TO PROVIDE CONDUIT, PULL BOXES AND DECODER CARLE IN STRUCTURE. THE DRAWNINGS INDICATED REQUIRED TWO-WERE PATH FROM A GREEN PLANTER LOCATION, THROUGH STRUCTURE, TO REDOTE CONTROL WAYLE LOCATIONS. 14 GAUGE RECODER CARLE SHALL BE USED FOR CONTROL WIRNO. PINAL CONNECTION OF WIRNST OF REMOTE CONTROL WAYLES SHALL BE OFFICED BY INFRACTION CONTRICTOR.
- 5. CONDUIT FOR DECODER CABLE SHALL BE INSTALLED UNDER ELECTRICAL CONTRACT WORK COORDINATE WITH ARCHITECT FOR CONDUIT ROUTING.

IRRIGATION LEGEND

SYMBOL	MODEL NUMBER	DESCRIPTION	
0	PROS-06-PRS40-CV-MP300090 ADJUSTABLE	HUNTER POP-UP SPRAY SPR NOZZLE (LAMIN)	INKLER WITH MP ROTATOR
⊕	PROS-06-PRS40-CV-MP300090 ADJUSTABLE	HUNTER POP-UP SPRAY SPR NOZZLE (LAWN)	INKLER WITH MP ROTATOR
•	PROS-06-PRS40-CY-MP200090 ADJUSTABLE	HUNTER POP-UP SPRAY SPRINKLER WITH MP ROTATOR NOZZLE (LAWN)	
	PROS-06-PRS40-CV-MP200090 ADJUSTABLE	HUNTER POP-UP SPRAY SPR NOZZLE (LAWN)	INKLER WITH MP ROTATOR
	1401	RAIN BIRD BUBBLER (TREE)	
	RMS-8-C-1401	RAIN BIRD BUBBLER WITH DEEP WATERING BUBBLER ASSEMBLY AND CHECK VALVE (TREE)	
	2*T-S	AMIAD FILTER WITH 155 MESI CONNECTION	
	1" COMPACT (1 GPM TO 19 GPM)	AMIAD FILTER WITH 155 MESI CONTROL VALVE	H SCREEN AT REMOTE
8	1½" SUPER (20 GPM TO 50 GPM)	AMAD FILTER WITH 155 MESI CONTROL VALVE SUPERIOR NORMALLY CLOSED	
l n			
"	FSI-T15-001-1½*/P7162D-A (PART OF CONTROLLER EQUIPMENT PACKAGE)	DESCRIPTION)	GY FLOW SENSOR WITH PAIGE BLE (SEE CONTROLLER
•	ICV-FS-AS-ADJ SERIES	HUNTER FILTER SENTRY PRES CONTROL VALVE	
_	T-FCH-H-FIPT	TORO FLUSH WALVE (PIPE TH	
	OPERIND - (SEE SUB-SURFACE DRIP LAYOUT DETAILS)	RAIN BIRD DRIP SYSTEM OPE	
+	HQ-33DRC	HUNTER QUICK COUPLING VA	
H	T-113	NIBCO GATE VALVE (LINE SIZ	
	975XL2-2*	WILKINS REDUCED PRESSURE (LEAD FREE)	BACKFLOW ASSEMBLY
₩	182199L	GROUNDING PLATE LOCATION CONTROL TWO-WIRE PATH. FACTURER'S (PAIGE ELECTRIC	AL COMPANY) INSTRUCTIONS
0	270DCFD	PAGE ELECTRIC DECODER CA	
& ®	IOARHUS-99/SP/PS/-150C/ SOLSE/IDMP-16/FRN-16/P7354D	IMPERIAL TECHNICAL SERVICE HINTER ACC TWO—WRE DECI- PROTECTION, CST FLOW SENS- DECORDES, HANTER ALEXETE ENCLADION EDITOR SENSION EDITOR SENSION EDITOR EDITOR SENSION EDITOR EDITOR SENSION EDITOR EDITOR SENSION ENTRE SI BOLT FOR ORDER, PURCHASS EQUIPMENT SENSION EDITOR EDITOR ORDER, PURCHASS EQUIPMENT SENSION EDITOR EDITOR ORDER, PURCHASS EDITOR ORDER, PURCHASS EDITOR ORDER, PURCHASS EDITOR ORDER EDITOR OR	S CONTROLLER ASSEMBLY WITH DOER CONTROLLER, SURGE OF ASSEMBLY, THO-MINE D DECODER CHAILE, ALL EARTH LESS STEEL TOP OPENING INTING PAD, ENCLOSURE FAN, EMPSOR. CONTROL PADING AND WARRANTY. AND WARRANTY. WITH QUESTIONS RECARDING POPENTS, INSTALLATION, WITHOUT OPENITS, INSTALLATION, WITHOUT MITH QUESTIONS RECARDING POPENTS, INSTALLATION, WITHOUT MITH QUESTIONS RECARDING POPENTS, INSTALLATION, WITHOUT MITH QUESTIONS RECARDING DECODER PROGRAMMING.
	ІСО-НР	HUNTER HAND-HELD DECODE SHALL PROVIDE ONE (1) PRO USING TO PROGRAM SYSTEM	R PROGRAMMER. CONTRACTOR CORAMINER TO OWNER AFTER DECODERS.
550	SOLAR SYNC-SEN	HUNTER SOLAR SYNC SENSOR CONTROLLER ENCLOSURE IN	r (mount on side of Vandal, resistant enclosure)
		PRECIPITATION RATE	
·		CONTROLLER & STATION NUM	BER .
(a -		APPROXIMATE FLOW (GPM)	
~~		REMOTE CONTROL VALVE SIZE	:
		PLANT TYPE/WATER REQUIRED UH = LWWN/HIGH WATER UM = LWWN/MODERATE WATER UL = LWWN/LOW WATER UM = SHRUB & GROUNDCOV SH = SHRUB & GROUNDCOV SL = SHRUB & GROUNDCOV SL = TREE/HIGH WATER UM = TREE/MODERATE WATER UM = TREE/LOW WATER	R ER/HICH WATER ER/MODERATE WATER ER/LOW WATER
		MAINLINE: 1120—SCHEDU SCHEDULE 40 18" COVER. PAVING.	LE 40 PVC PLASTIC PIPE WITH PVC SOLVENT-WELD FITTINGS, 24" COVER UNDER VEHICULAR
		LATERAL LINE: 1120-SCHEDULE 40 PVC PLASTIC PIPE WIT SCHEDULE 40 PVC SQLVENT-WELD FITTINGS 12" COVER. 24" COVER UNDER VEHICULAR PANING.	
		COPPER PIPE: TYPE 'K' COP COPPER SOLD AND INSTALLA SHALL BE PR CONTRACT.	PER PIPE WITH WROUGHT ER JOINT FITTINGS. ROUTING TION THROUGH STRUCTURE DVIDED UNDER PLUMBING
		DRIP (XFSCV-09-1 TECHNOLOGY) VALVE, INSTA SEE DRIP IRR LAYOUT AND I BOUNDARIES I TO BE CONNE CONTROL, VAL) DRAWING, 4"	S-CV SUB-SURFACE DRIPLINE 2) WITH COPPER SHELD AND HEAVY DUTY CHECK LL AS DETAILED 12° O.C. (GATION DETAILS FOR TUBING INSTALLATION METHODS. DEPIPEL AREAS FOR DRIPLINE COTED TO ASSOCIATED REMOTE LES AS DEPICTED IN THE COVER.
===	=====	SLEEVING: 1120-SCHEDU 18° COVER.	ILE 40 PVC PLASTIC PIPE. 24" UNDER VEHICULAR PAVING.

PRELIMINARY

NOT FOR CONSTRUCTION

GUZZARDO PARTNERSHIP INC San Francisco, CA 94111 T 415 433 4672 F 415 433 5003

SCALE:

NORTH

SHEET TITLE

Legends

SHEET NUMBER L-3.2

Irrigation Notes and

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DICKSON & ASSOCIATES, INC.

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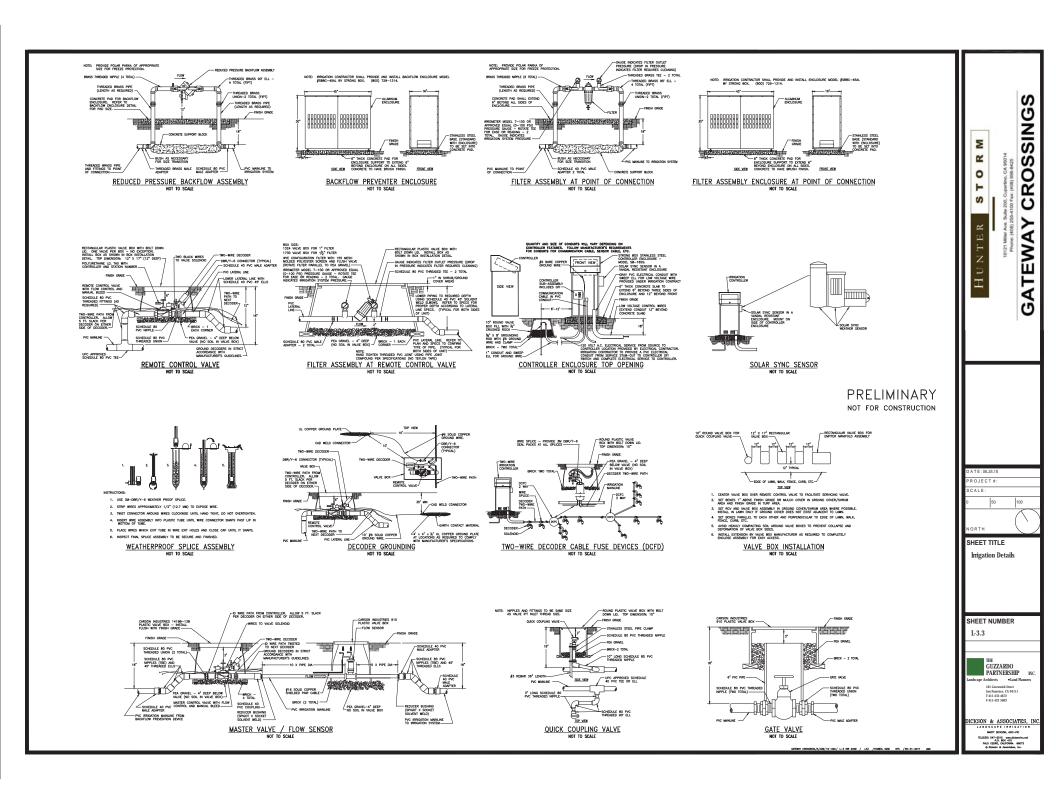
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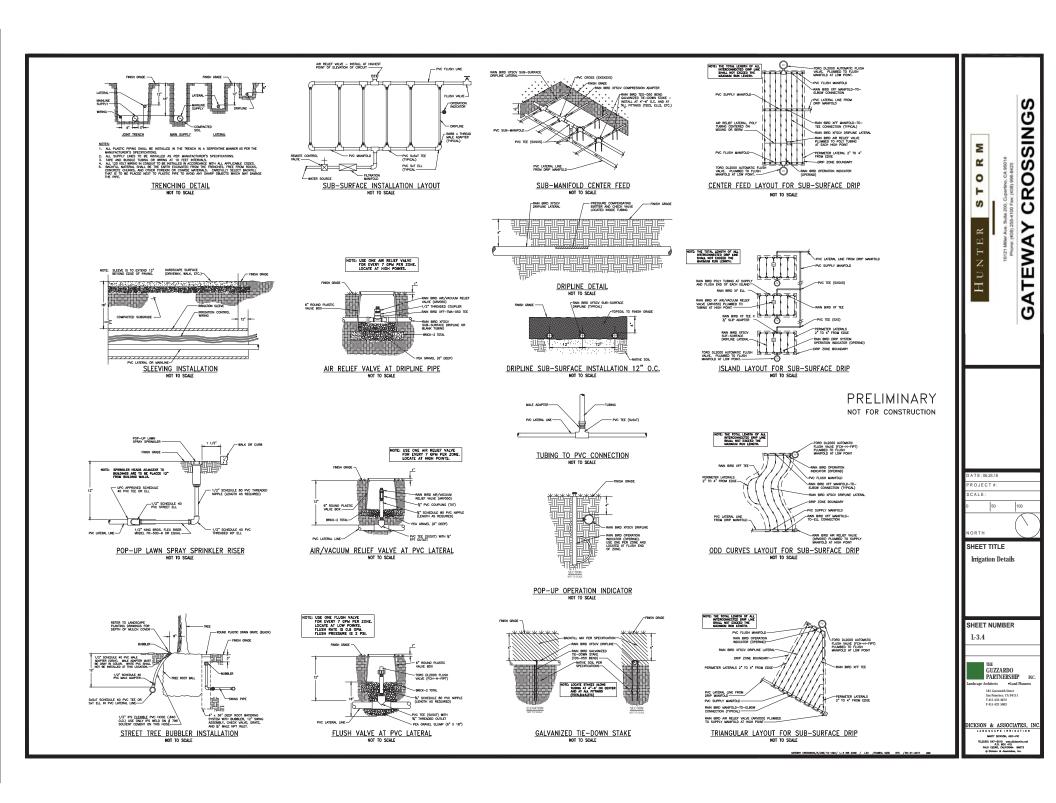
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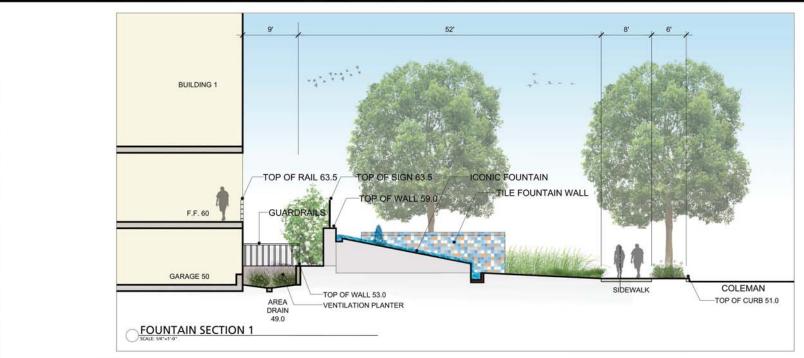
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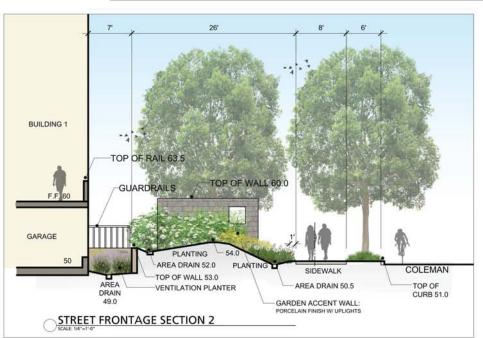
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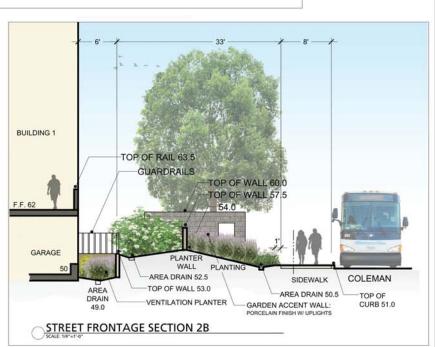
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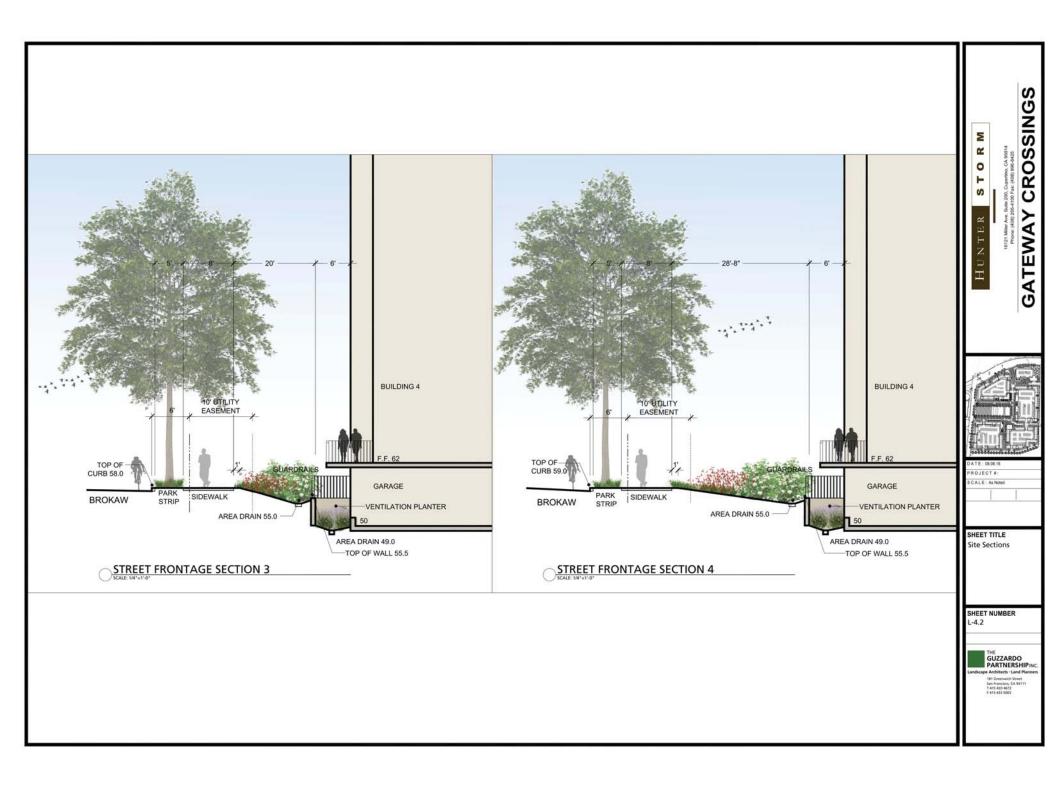



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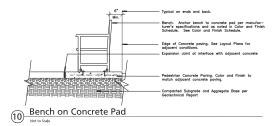
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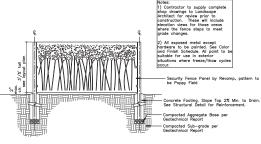
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THE GUZZARDO PARTNERSHIPINC. Landscape Architects - Land Planners 181 Greenwich Spreet San Francisco, CA 54111 T 415 433 4672











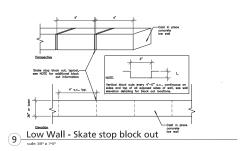

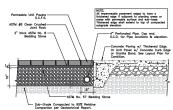


5 Permeable Unit Pavers

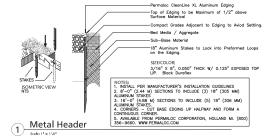


X Redwood Header. manuracturer's specifications.
mposed granite paving availabl
Feiton Quarry
End of San Lorenzo Avenue
Feiton, CA 95018
(831)335-3445 Compacted Sub-Grade and Base to 95% relative


6 Pedestrian Decomposed Granite Paving

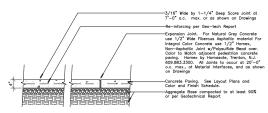

Pedestrian Concrete Paving

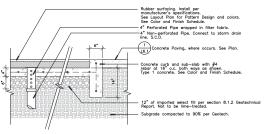


7 Poured-in-Place Rubber Surfacing

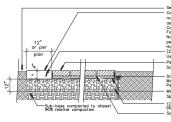


See Plans for Adjacent Conditions
Concrete Band, Provide expansion joints at
material or structural interface and Score Joints
noterial or structural interface and Score Joints
noterial or Score Score Score
Concrete use 1/2" Mide Fiberous Asphaltic Workerial
For Integral Color Concrete use 1/2" Minnex, Color
par Plans, See Color & Fibial Schedule.
Homes by Homosok, Tenton, No (609-883,3300
(2) \$4* Rebor, Cont. Centred in Pour as Snown.
Use (1) \$4* Rebor if Score Middle Score Score.
Score (1) \$4* Rebor if Score Middle Score Score.
Score (1) \$4* Rebor if Score Middle Score Score.
Score (1) \$4* Rebor if Score Middle Score Score Score.
Score (1) \$4* Rebor if Score Middle Score Sc StructurEdge 3/16" x 1 5/8" Paving Restraint Manufactured by Permaloc 1 (800) 356-9660. Install Per Manufacturers Recommendations.

Mirafi Filter Fabric, #140N, Continuous. Install per Mfr's Specifications. Turn Up Edges at Concrete Bands. 12" of non-expansive fill compacted to at least 90% relative compaction
 Sand Setting Bed. 1" Max.

Pedestrian Accent Paving

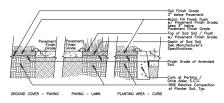

Fine Grading @ Paving Edges

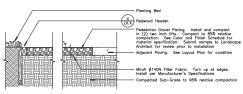

4 Pedestrian Gravel Paving

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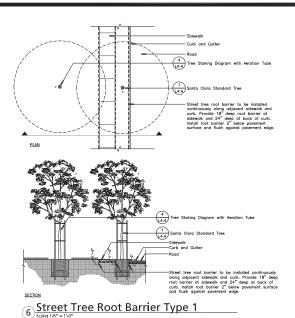
DATE:06,28,18 S C A L E : As Noted


SHEET TITLE Landscape Details


SHEET NUMBER



181 Greenwich Street San Francisco, CA 94111 T 415 433 4672 F 415 433 5003



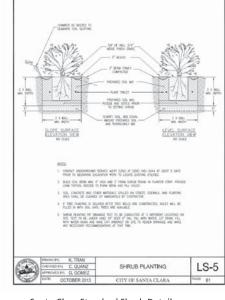

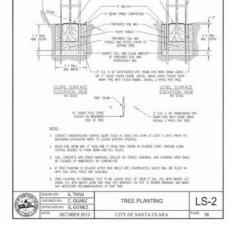


. ALL TREES EXCEPT PALMS

- TOP OF BALL 3/4" ABOVE THISH KIND


TI" X 4" RESMISSE WITH 2 GREY MILE TO METALL ON MINEMAND SEE OF THEE TO

DWAFTER AS NEEDED TO ELMINATE SOIL SCHEPING



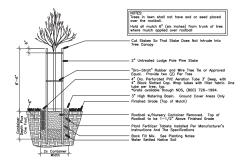




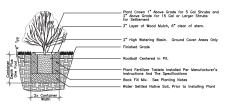


5 Shrub Planting Detail

Santa Clara Standard Tree Detail

Not to Scale

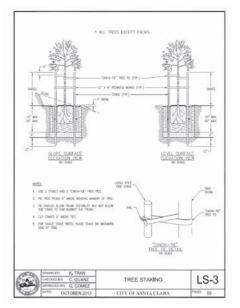



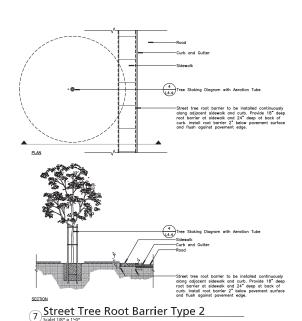



DATE:06,28,18

S C A L E : As Noted

SHEET TITLE

SHEET NUMBER

GUZZARDO PARTNERSHIPIN

181 Greenwich Street San Francisco, CA 94111 T 415 433 4672 F 415 433 5003

L-4.4

Landscape Details

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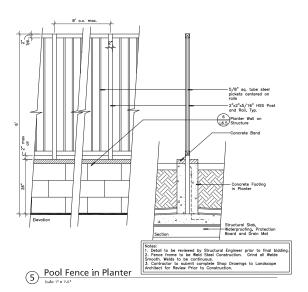
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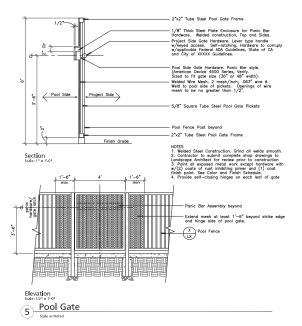
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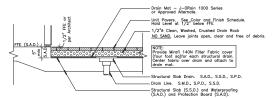
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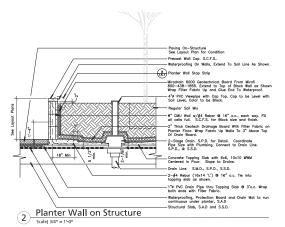
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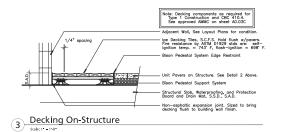







1 Unit Pavers on Structure





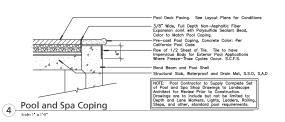



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DATE:06.28.18 S C A L E : As Noted

SHEET TITLE

Landscape Details

SHEET NUMBER

L-4.5

GUZZARDO PARTNERSHIPING

181 Greenwich Street San Francisco, CA 94111 T 415 433 4672 F 415 433 5003