


- 1. ALL RECEPTACLES ON KITCHEN COUNTERTOP AND ON ISLAND TO BE GFCI PROTECTED.
- 2. ALL BATHROOM EXHAUST FANS TO BE SEPARATELY SWITCHED FROM THE LIGHTING FIXTURE PER ENERGY CODE 150(k)(6)
- 3. ALL BRANCH CIRCUITS THAT SUPPLY 125V, SINGLE PHASE, 15- AND 20- AMPERE RECEPTACLE OUTLETS INSTALLED IN DWELLING UNIT FAMILY ROOMS, DINING ROOMS, LIVING ROOMS, PARLORS, LIBRARIES, DENS, BEDROOMS, SUNROOMS, RECREATION ROOMS, CLOSETS, HALLWAYS, KITCHEN AND SIMILAR ROOMS SHALL BE PROTECTED BY A LISTED ARC-FAULT CIRCUIT INTERRUPTER(S).
- 4. ALL BATHROOM RECEPTACLES SHALL BE SUPPLIED BY AT LEAST ONE 20-AMPERE BRANCH CIRCUIT. SUCH CIRCUITS SHALL HAVE NO OTHER OUTLETS. RECEPTACLE TO BE ON THE WALL WITHIN 3' OF SINK AND GFCI PROTECTED, AS/2013 CEC 2150.52 (D).
- 5. TWO SMALL APPLIANCE BRANCH CIRCUITS ARE REQUIRED FOR THE KITCHEN AND ARE LIMITED TO SUPPLYING WALL AND COUNTER SPACE OUTLETS FOR THE KITCHEN, PANTRY, BREAKFAST ROOM, DINING ROOM, OR SIMILAR AREAS. THE CIRCUIT CAN NOT SERVE OUTSIDE PLUGS, RANGE HOOD, DISPOSALS, DISHWASHER OR MICROWAVE, ONLY THE REQUIRED COUNTERTOP/WALL OUTLETS INCLUDING THE REFRIGERATOR. CEC 210.11(C)(1) AND 210.52(B).
- 6. OUTLETS REQUIRED EVERY 12' O.C. MAX. AND WITHIN 6' OF THE END OF WALLS, IN LIVING, BEDROOMS & DINING AREAS. CEC 210.52(A)(1) & 210.52(A)(2) AND (3)
- 7. SMOKE ALARMS ARE REQUIRED AT THE FOLLOWING LOCATIONS: (1) ALL BEDROOMS; (2) HALLWAYS LEADING TO BEDROOMS: (3) ABOVE TOP OF STAIRS: (4) AT LEAST ONE AT EVERY LEVEL. SMOKE ALARMS NEED TO BE HARDWIRED, WITH BATTERY BACKUP AND INTERCONNECTED. CRC R314.3.
- 8. CARBON MONOXIDE ALARMS ARE REQUIRED OUTSIDE EACH SLEEPING AREA IN THE IMMEDIATE VICINITY OF THE BEDROOMS AND AT EVERY FLOOR LEVEL INCLUDING BASEMENTS. CARBON MONOXIDE ALARMS SHALL BE LISTED AS COMPLYING WITH UL2034 AND UL2075, PER CRC R315.3. CARBON MONOXIDE ALARMS NEED TO BE HARDWIRED, AND INTERCONNECTED.
- 9. IN ALL AREAS SPECIFIED IN 210.52, ALL 125V, 15- & 20- AMP RECEPTACLES SHALL BE LISTED TAMPER-RESISTANT RECEPTACLES.

ELECTRICAL NOTES

SCALE: NS

| | CTRICAL/POWER LEGEND | | LIGHTING LEGEND |
|---------------------|--|--------------------------|---|
| Ф | DUPLEX RECEPTACLE OUTLET | \(\rightarrow \) | INCANDESCENT RECESSED CEILING DOWN LIGHT, 6" |
| ф _{сесі} | GFCI DUPLEX RECEPTACLE OUTLET | - → _{FL} | FLUORESCENT OR LED RECESSED CEILING DOWN LIGHT, 6" |
| Φ_{Hor} | HORIZONTAL DUPLEX RECEPTACLE OUTLET | -Adj. | ADJUSTABLE RECESSED CEILING LOV VOLTAGE DOWN LIGHT, 4" |
| # | FOURPLEX RECEPTACLE OUTLET | -\$\rightarrow\text{WP} | WATER PROOF RECESSED CEILING DOWN LIGHT, 4", FLUDRESCENT |
| Ф | 220V RECEPTACLE OUTLET | \oplus | HANGING LIGHT FIXTURE |
| ф | HALF SWITCHED RECEPTACLE OUTLET | | FLUORESCENT SURFACE MOUNTED LIGHT FIXTURE |
| 0 | FLOOR OUTLET | | LED ROPE LIGHT |
| ф | DUPLEX RECEPTACLE OUTLET WITH WATERPROOF COVER | [c | FLUORESCENT TUBE LIGHT (ABOVE CABS/RECESSED CLGS) |
| \$ | SINGLE POLE SWITCH | ¤ | HALOGEN OR LED PUC LIGHT |
| \$\$ | STACKED SWITCH | ~~~~ | SQUARE FOOTLIGHT IN RISERS |
| \$ _D | SWITCH ON A DIMMER | | INSIDE CLOSET LIGHT |
| \$ ₃ | 3-WAY OR 4-WAY SWITCH | | WALL SCONCE |
| \$ _V | SWITCH ON VACANCY SENSOR | | WALL MOUNTED VANITY LIGHT |
| \$_ | OUTDOOR SWITCH | a | LIGHT/FAN FIXTURE |
| _TH_ | THERMOSTAT | | BATHROOM EXHAUST FAN |
| DB | DOORBELL | | CEILING FAN |
| | LOW VOLTAGE TRANSFORMER BOX/ DRIVER BOX FOR LED'S | | CEILING FAN WITH LIGHT |
| T | CABLE LINE | FL | SUNTUNNEL WITH LIGHT |
| Ճ | PHONE LINE | <u> </u> | TRACK LIGHT |
| • | SMOKE DETECTOR / ALARM | 0 | LANDSCAPE UPLIGHT |
| G— | GAS SUPPLY | ⊩⊕ MS PC | WALL MNT EXTERIOR LIGHT (ON MOTION SENSOR & PHOTO CONTROL |
| (G) | GAS METER | GD [▽] | GARBAGE DISPOSAL |
| | PANEL BOX | | HEATING DIFFUSER |
| - | HOSE BIB | Ø | CEILING MOUNT LIGHT FIXTURE |
| o AIR | AIR SWITCH | | CHANDELIER |
| • | CARBON MONOXIDE ALARM | ⊕ _{BAT} | BATTERY OPERATED SMOKE ALAR |
| | | l | |

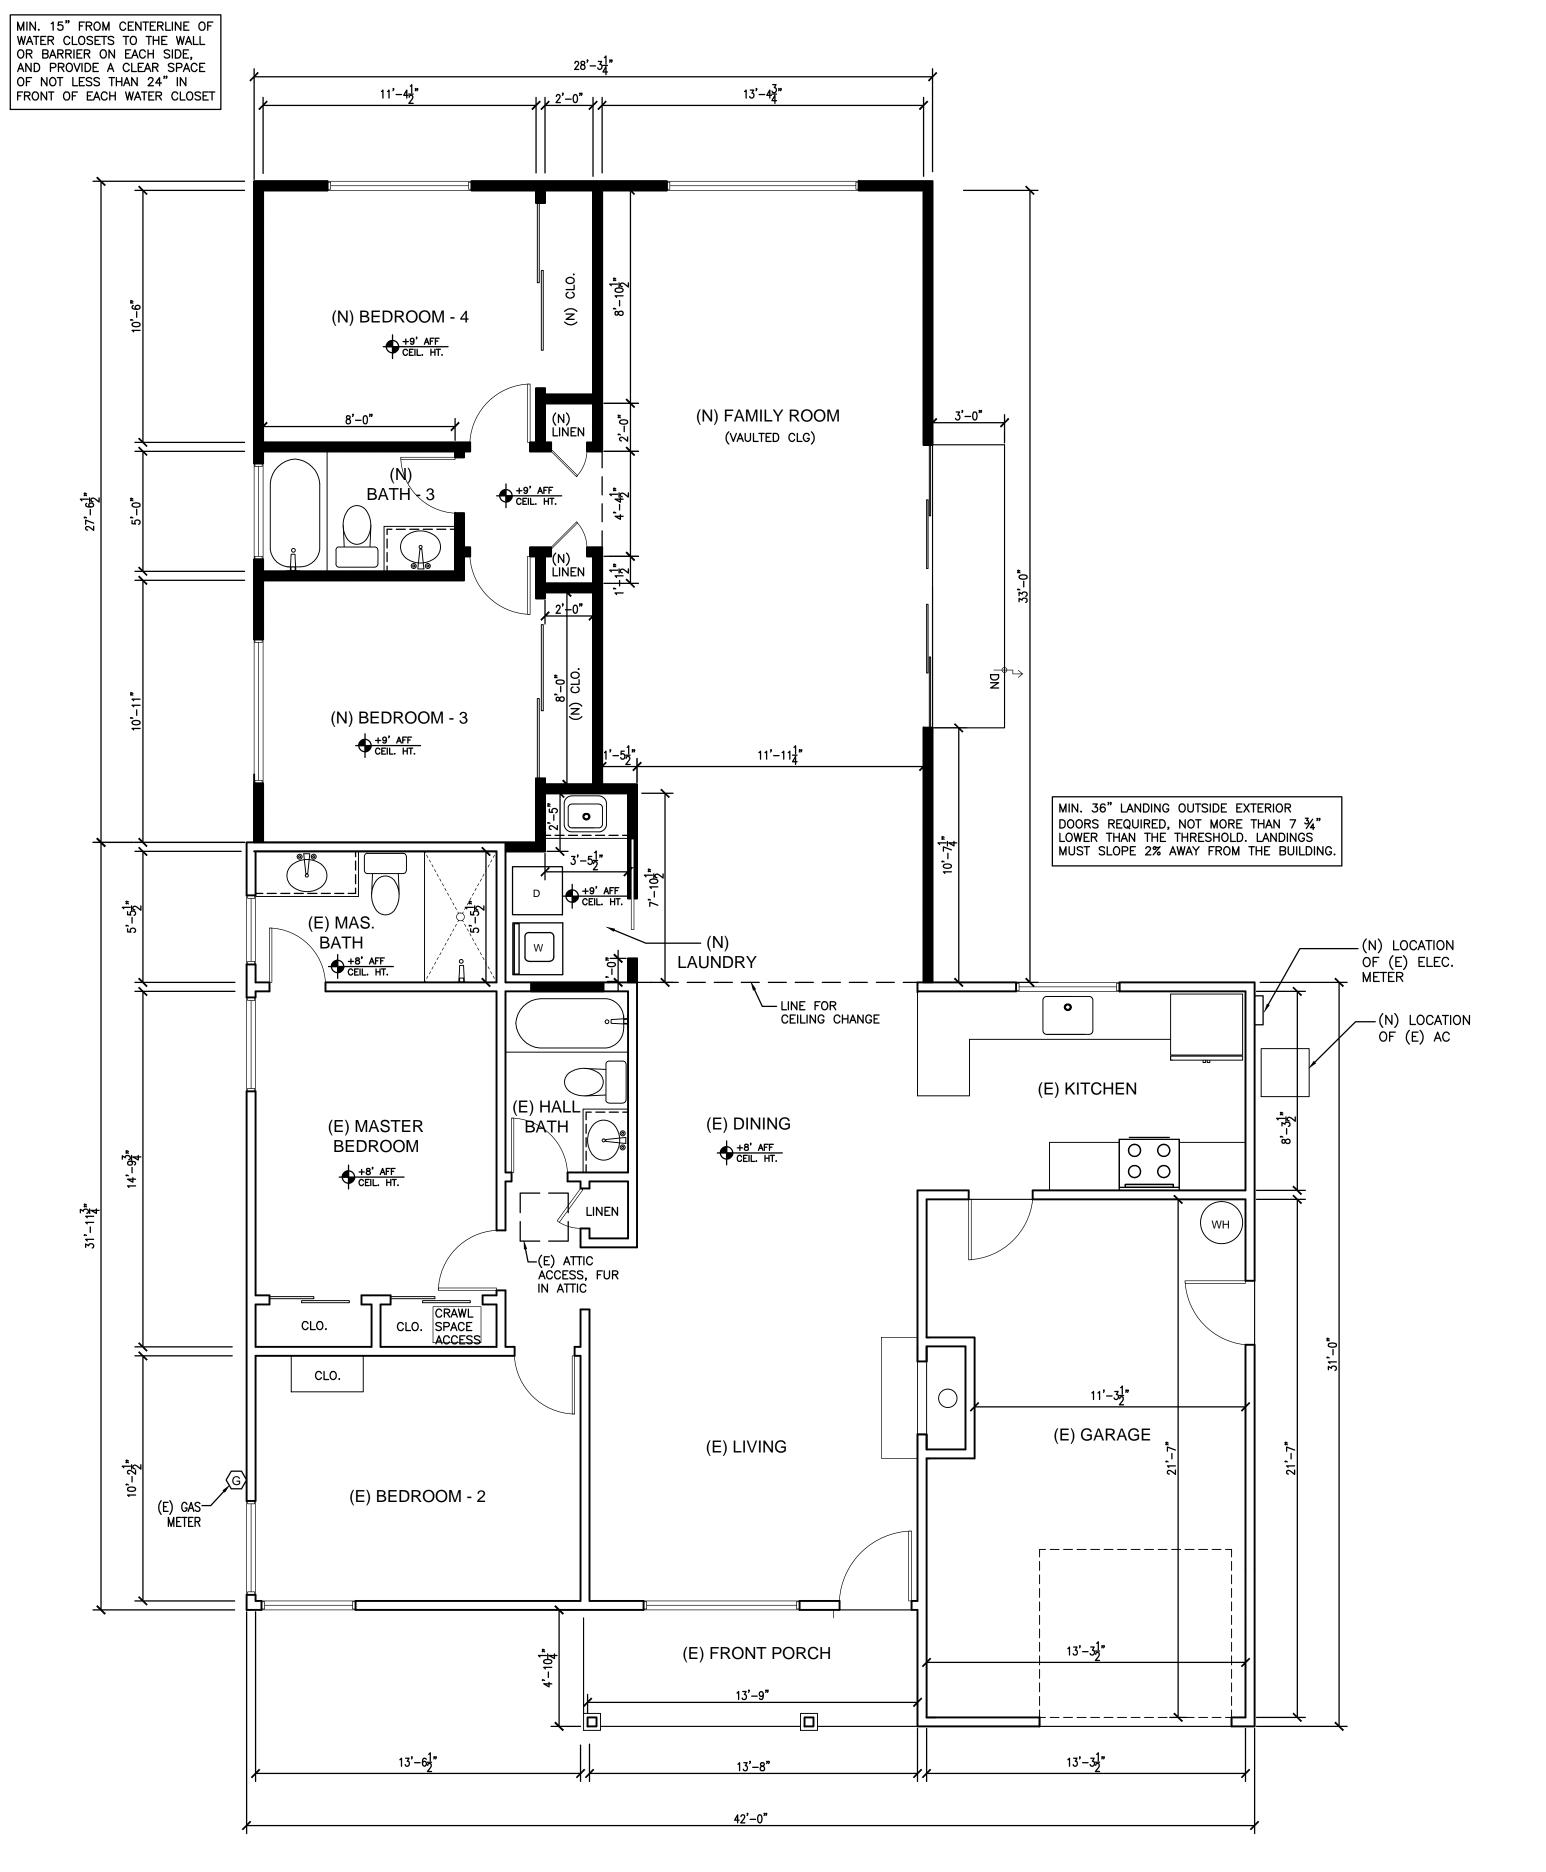

1. ALL HIGH EFFICACY LUMINARIES SHALL MEET SECTION 150.0 (K) AND JOINT APPENDIX JA8 REQUIREMENTS. THEY MUST BE CERTIFIED OR MARKED AS JA8-2016 OR JA8-2016-E. THE PRODUCT SHOULD BE LISTED IN THE ENERGY COMMISSION DATA BASE. THE BUILDER MUST PROVIDE THE HOMEOWNER WITH A LUMINAIRE SCHEDULE THAT INCLUDES A LIST OF INSTALLED LAMPS & LUMINARIES.

2. RECESSED LIGHTING: ALL CONCEALED LIGHT FIXTURES WILL BE I.C. RATED WHENEVER INSULATION IS REQUIRED. THE HOUSING OF LUMINARIES SHALL BE AIRTIGHT PER T24 150(K) 5, 2013 CEC 410-66

3. BATHROOM: ALL LIGHTING MUST BE HIGH EFFICIENCY


4. ALL LIGHTS IN THE KITCHEN TO BE HIGH EFFICACY LUMINARIES. LIGHTING IN AREAS ADJACENT TO THE KITCHEN, INCLUDING BUT NOT LIMITED TO DINING & NOOK AREAS ARE CONSIDERED KITCHEN LIGHTING IF THEY ARE NOT SEPARATELY SWITCHED FROM KITCHEN LIGHTING)

5. ALL OUTDOOR LIGHTING MUST BE HIGH EFFICACY AND CONTROLLED BY ONE OF THE FOLLOWING COMBINATIONS: (A) PHOTOCELL & MOTION SENSOR, (B) PHOTOCELL & TIME SWITCH, (C) ASTRONOMICAL TIME CLOCK, (D) EMCS WITH FEATURES OF ASTRONOMICAL TIME CLOCK, DOES NOT ALLOW THE LUMINARIES TO BE ON DURING THE DAY & MAY BE PROGRAMMED TO BE AUTOMATICALLY TURN LIGHTING OFF AT NIGHT.

6. BEDROOMS/CLOSETS: ALL LIGHTS IN THESE ROOMS TO BE HIGH EFFICIENCY LUMINARIES OR COMPLY WITH THE EXCEPTION AS FOLLOWS:

- PROVIDE DIMMER SWITCH CLOSETS LESS THAN 70 SF ARE EXEMPT FROM LIGHTING
- REQUIREMENTS.

7. AT LEAST ONE LUMINAIRE IN THE BATHROOM, GARAGE, LAUNDRY ROOM, AND UTILITY ROOM MUST BE CONTROLLED BY A VACANCY SENSOR.

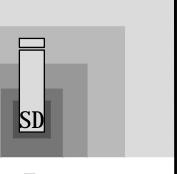

>an ∐nterior Design

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LIGHTING NOTES SCALE: NS

1. TERMINATION OF ALL ENVIRONMENTAL AIR DUCTS SHALL BE MIN. OF 3 FEET FROM ANY OPENINGS INTO THE BUILDING (I.E. DRYERS, BATH AND UTILITY FANS, ETC. MUST BE 3 FEET AWAY FROM DOORS, WINDOWS, OPENING SKYLIGHTS OR ATTIC VENTS). CMC 504.5

2. SHOWER & TUB-SHOWER COMBINATIONS SHALL BE PROVIDED WITH INDIVIDUAL CONTROL VALVES OF THE PRESSURE BALANCE OR THERMOSTATIC MIXING VALVE TYPE. CPC 418.0

3. MECHANICAL VENTILATION TO BE PROVIDED AT BATHROOMS WITH A MINIMUM 50 cu.ft./min. (FOR INTERMITTENT VENTILATION) OR 25 cu.ft./min FOR CONTINUOUS VENTILATION. (PER CRC R303.3). FANS SHALL BE ENERGY STAR & VENTED DIRECTLY TO THE OUTSIDE.

4. MECHANICAL VENTILATION IN ALL BATHROOMS, UNLESS FUNCTIONING AS A COMPONENT OF A WHOLE HOUSE VENTILATION SYSTEM. FANS MUST BE CONTROLLED BY A HUMIDITY CONTROL.

I HUMIDITY CONTROLS SHALL BE CAPABLE OF ADJUSTMENT BETWEEN RELATIVE HUMIDITY RANGE OF < OR = 50%, TO A MAX. OF 80%. A HUMIDITY CONTROL MAY UTILIZE MANUAL OR AUTOMATIC MEANS OF

ii A HUMIDITY CONTROL MAY BE A SEPARATE COMPONENT TO THE EXHAUST FAN & IS NOT REQUIRED TO BE INTEGRAL (i.e. BUILT-IN)

5. GARAGE INSTALLED WATER HEATER AND FURNACE (i.e. THAT GENERATE A GLOW, SPARK OR ARE CAPABLE OF IGNITING FLAMMABLE VAPORS -INCLUDING DRYER IF GAS FUELED) MUST BE INSTALLED AT LEAST 18" ABOVE THE FLOOR AND BE PROTECTED FROM VEHICLE IMPACT (e.g. BOLLARD), PER CMC 308

6. SEISMIC ANCHORAGE OF WATER HEATER TO INCLUDE ANCHORS OR STRAPS AT POINTS WITHIN THE UPPER AND LOWER ONE THIRD OF ITS VERTICAL DIMENSION, THE LOWER ANCHOR STRAP LOCATED TO MAINTAIN A MINIMUM DISTANCE OF 4" ABOVE THE CONTROLS (PER CPC 507.2)

7. WATER HEATER SHALL HAVE A PRESSURE RELIEF VALVE WITH DRAIN TO THE EXTERIOR (OR FLOOR DRAIN ETC.), PER CPC 608.5

MECH./PLUMB.NOTES

REVISIONS DATE B SCALE:

TABLE - MAXIMUM FIXTURE WATER USE FIXTURE TYPE **FLOW RATE** SHOWER HEADS (RESIDENTIAL) 1.8 GMP @ 80 PSI LAVATORY FAUCETS MAX. 1.2 GPM @ 60 PSI (RESIDENTIAL) MIN. 0.8 GPM @ 20 PSI LAVATORY FAUCETS IN COMMON & PUBLIC USE 0.5 GPM @ 60 PSI AREAS KITCHEN FAUCETS 1.8 GPM @ 60 PSI METERING FAUCETS 0.25 GAL/CYCLE WATER CLOSET 1.28 GAL/FLUSH URINALS 0.125 GAL/FLUSH

> 12/04/18 DRAWN BY: SANCHALI SRIVASTAVA SCALE: AS NOTED SHEET TITLE:

PROPOSED FLOOR PLAN / ELEC. PLAN

SHEET #:

A2.1

(E) WALLS TO REMAIN ———— (E) DOOR/WINDOW/ITEMS TO REMAIN (N) 2X4 WALL, 16" O.C. STUDS

LEGEND:

----- (N) GAS LINE

ELECTRICAL LEGEND

