PROJECT DIRECTORY

ARCHITECT:

415.802.7447

MEP ENGINEER:

TENANT:

BAREBOTTLE BREWING CO. 1525 CORTLAND AVE. 650.714.0506 **CONTACT: MICHAEL SEITZ** E-MAIL: mike@barebottle.com

LANDLORD:

3265 SCOTT BOULEVARD L.L.C. C/O THE IRVINE COMPANY 110 INNOVATION IRVIINE, CA 92617 949.720.3164 CONTACT: KRISTI CRAFT ROWLEY E-MAIL: krowley@irvinecompany.com

DESIGNER:

GUERRERO DESIGN 2322 LARKIN STREET SAN FRANCISCO, CA 94109 415.815.8419 CONTACT: JULIO GUERRERO E-MAIL: guerrero.design@mail.com

* REFER TO SHEET A1.2 A1.3 FOR LANDLORD REQUIRED CONTRACTORS

2520 AUGUSTINE DRIVE

OCCUPANCY LOAD CALCULATION (CBC TABLE 1004.1.2)

NORTH

ARROW

ELEVATION TAG

ELEVATION TAG

INTERIOR

DETAIL

REFERENCE

ASSEMBLY (SEATING):

1,110 S.F. / 15

LOAD FACTOR =

A.D.A. - ACCESSIBLE

PATH OF TRAVEL

DRAWING TITLE

SHEET NUMBER

SHEET NUMBER

ELEVATION NUMBER

— ELEVATION NUMBER

74 OCCUPANTS

SANTA CLARA, CA 95054

VICINITY MAP

LMR ENGINEERS 1165 A STREET HAYWARD, CA 94541 CONTACT: LEONARD ROSE E-MAIL: team@Imrenginners.com

CRUZ ARCHITECTURE + DESIGN

1161 MISSION STREET

CONTACT: MARK CRUZ

SAN FRANCISCO, CA 94103

E-MAIL: mark@cruzad.space

ZEIGER ENGINEERS 478 3RD STREET OAKLAND, CA 94607 CONTACT: RON ZEIGER

BOTTLE CO

2520 AUGUSTINE DRIVE

PROJECT DATA / CODES

E-MAIL: ron@zeigerengineers.com SANTA CLARA, CA 95054

OCCUPANCY DIAGRAM

496 S.F. / 5 LOAD

100 OCCUPANTS

ARCHITECTURAL SYMBOLS KEY

CEILING TAG

DOOR TAG

WALL TAG

FINISH TAG

DATUM

Benchmark Elevation FLEVATION TAG

SHEET KEY NOTE

REVISION TAG

STRUCTURAL GRID

WINDOW TAG

CEILING FINISH


11'-6" — CEILING HEIGHT

Benchmark Title

(F2 ′)

FACTOR =

ASSEMBLY (STANDING):-

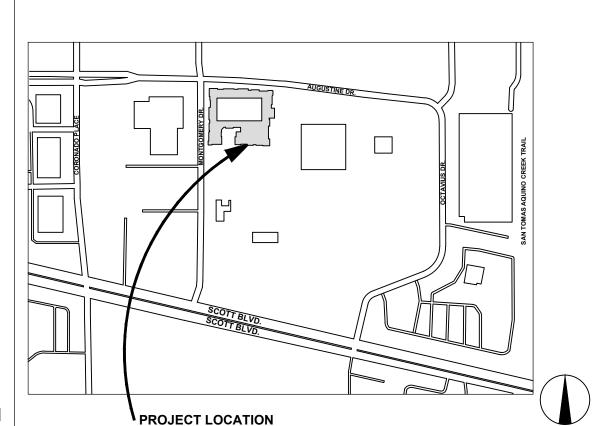

KITCHEN:

327 S.F. / 200

LOAD FACTOR =

SEE SHEET A 0.2 FOR COMMON PATH OF EGRESS TRAVEL INFORMATION

FIRE EXTINGUISHER

WALL RECEPTACLE

FLOOR OUTLET BOX

FLOOR DRAIN

3 OCCUPANTS

1 OCCUPANT

BLOCK PLAN

ADDRESS: 2520 AUGUSTINE DRIVE

SANTA CLARA, CA 95054

APPLICABLE CODES: 2013 CALIFORNIA BUILDING CODE 2013 CALIFORNIA PLUMBING CODE 2013 CALIFORNIA FIRE CODE 2013 CALIFORNIA MECHANICAL CODE 2013 CALIFORNIA ELECTRICAL CODE

2013 CALIFORNIA BUILDING ENERGY EFFICIENCY STANDARDS 2013 CALIFORNIA BUILDING STANDARDS CODE 2013 TITLE 24 NFPA 12, 2013 EDITION WITH CBC SECTION 903.2.8

NFPA 72. 2013 EDITION WITH CITY AMENDMENTS NFPA 14, 2013 EDITION WITH CITY AMENDMENTS NFPA 24, 2013 EDITION **AMERICAN W/ DISABILITIES ACT 2010 STANDARDS**


YEAR BUILT: **CONSTRUCTION TYPE:** NUMBER OF STORIES: PROPOSED USE: PREVIOUS USE: PROPOSED OCCUPANCY: PREVIOUS OCCUPANCY: BUILDING AREA:

SPRINKLERS:

COMMERCIAL RESTAURANT/ FOOD SERVICE RETAIL A2 4,976 S.F.

FULLY SPRINKLED

OCCUPANCY LOAD

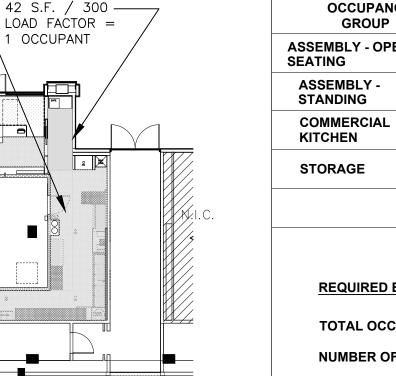

EQUIPMENT TYPE

FLOOR ASSEMBLY

KEY NOTE

GRID LINE REFERENCE

OCCUPANCY GROUP	AREA (SF)	OCCUPANT LOAD	OCCUPANTS
ASSEMBLY - OPEN BEATING	1,110 SF	15 NET	74
ASSEMBLY - STANDING	496 SF	5 NET	99.2
COMMERCIAL KITCHEN	327 SF	200 GROSS	2.92
STORAGE	42 SF	300 GROSS	0.14
	'	TOTAL	177 (176.26) OCCUPANT

FACTOR PER C.B.C. 1004.1.2

EXT. EXTERIOR

FIN. FINISH

FLOOR

F.O.S. FACE OF

FURR. FURRING

FUT. FUTURE

GA. GAUGE

G.C. GENERAL

GEN. GENERAL

GYP. GYPSUM

HR. HOUR

HT. HEIGHT

H.B. HOSE BIB

H.C. HANDICAPPED

H.M. HOLLOW METAL

HORIZ. HORIZONTAL

C.P.C. CALIFORNIA PLUMBING F.F. FIRE ALARM

DRINKING FOUNTATIN FLUOR.FLUORESCENT

EXTR. EXTRUSION

F.E. FIRE EXTINGUISHER

F.E.C. FIRE EXTINGUISHER

F.O.C. FACE OF CONCRETE

F.O.F. FACE OF FINISH

FT. FOOT or FEET

F.V. FIELD VERIFY

GALV. GALVANIZED

CONTRACTOR

F.O.P. FACE OF PLYWOOD

ABBREVIATIONS

JAN. JANITOR

J.C. JANITOR'S

KIT. KITCHEN

LAM. LAMINATE

LAV. LAVATORY

MAX. MAXIMUM

MECH. MECHANICAL

MEMB. MEMBRANE

MEZZ. MEZZANINE

MIN. MINIMUM

MTD. MOUNTED

MTG. MOUNTING

MUL. MULLION

NO. NUMBER

NOM. NOMINAL

O.A. OVERALL

OFF.

O.C. ON CENTER

OFFICE

NORTH

N.T.S. NOT TO SCALE

O.F.S. OUTSIDE FACE OF

(N) NEW

MFR. MANUFACTURER

MISC. MISCELLANEOUS

M.O. MASONRY OPENING

MET. METAL

CLOSET

REQUIRED EXITS: (CBC 1006)

TOTAL OCCUPANT LOAD: 49

CENTERLINE

ALUMINUM

ALUM. ALUMINUM

ANOD. ANODIZED

BD.

APPROXAPPROXIMATE

A.R. AS REQUIRED

ARCH. ARCHITECTURAL

A/V AUDIO/VISUAL

BOARD

BLDG. BUILDING

BLKG. BLOCKING

BTWN. BETWEEN

CLG. CEILING

CLKG. CAULKING

C.O. CLEAN OUT

CLOS. CLOSET

CLR. CLEAR

COL. COLUMN

B.O. BOTTOM OF

& INSTALL

BLK. BLOCK

PLUS OR MINUS

PROPERTY LINE

POUND OR NUMBER

CAB. CABINET C.F.C.I. CONTACTOR FURNISH E.J.

A.F.F. ABOVE FINISH FLOOR DEPT. DEPARTMENT

NUMBER OF EXITS REQUIRED: 2 PER CBC TABLE 1006.3.1

CONT. CONTINUOUS

CTSK. COUNTERSUNK

DIAMETER

DIMENSION

DISPENSER

DOOR

DRAWING

DRAWER

EXISTING

ELEVATION

E.P. ELECTRICAL PANEL

EACH

ELEC. ELECTRICAL

ELEV. ELEVATION

ENGR. ENGINEER

EQPT EQUIPMENT

EXST. EXISTING

EQ. EQUAL

EMER. EMERGENCY

DOOR OPENING

EXPANSION JOINT

CORR. CORRIDOR

DBL. DOUBLE

DET. DETAIL

SEE DRAWING 1, SHEET A0.1 FOR EXITING INFORMATION

CTR.

DIA.

DIM.

DN.

D.O.

DR.

DWG.

DWR.

DISP.

NUMBER OF EXITS PROVIDED: 5

SCOPE OF WORK

RETAIL SPACE IN A FIVE STORY HIGH RISE RESIDENTIAL BUILDING. NEW INTERIOR PARTITIONS, KITCHEN EQUIPMENT, MILLWORK AND FINISHES.

NEW SPRINKLER SYSTEM AT THE GROUND FLOOR UNDER DEFERRED

GENERAL CONTRACTOR NOTES

- GENERAL CONTRACTOR SHALL REVIEW THE CONTRACT DOCUMENTS AND VERIFY ALL DIMENSIONS AND CONDITIONS ON THE JOB SITE PRIOR TO EXECUTING THE WORK. CONTRACTOR SHALL NOTIFY THE ARCHITECT AND/OR OWNERS REPRESENTATIVE IMMEDIATELY OF ANY DISCREPANCIES. GENERAL CONTRACTOR SHALL BE RESPONSIBLE FOR ALL COSTS INCURRED DUE TO HIS
- ALL COSTS REQUIRED BY THESE CONTRACT DOCUMENTS OR GOVERNMENT AGENCY IN REGARD TO INSPECTION.
- 4. ALL WORK AND MATERIAL SHALL BE EXECUTED IN FULL ACCORDANCE WITH
- 5. EXTERIOR SIGNAGE AS SHOWN ON THESE DOCUMENTS IS FOR CONVENIENCE
- GENERAL CONTRACTOR SHALL MAKE NO REVISIONS. ALTERATIONS OR THE PRIOR WRITTEN APPROVAL OF THE ARCHITECT AND/OR OWNERS SHALL BE CONSIDERED AND THE WORK MAY BE REQUIRED TO BE REMOVED
- REQUIRED BY CODE. LOCATIONS TO BE APPROVED BY ARCHITECT AND/OR
- CONTRACTOR IS TO VERIFY ALL DIMENSIONS AND EXISTING CONDITIONS ON THE SITE AND BE RESPONSIBLE FOR CONFIRMING AND CORRELATING ALL QUANTITIES AND DIMENSIONS, SELECTING FABRICATION PROCESSES AND TECHNIQUES OF CONSTRUCTION, COORDINATING HIS/HER WORK WITH ALL OTHER TRADES AND PERFORMING HIS/HER WORK IN A SAFE, COMPLETE, AND
- 11. PROVIDE BLOCKING AT WALLS WHERE REQUIRED FOR SUPPORT OF SHELVING.

P.LAM PLASTIC LAMINATE

PLYWD. PLYWOOD

PAIR

POINT

RISER

ROOM

SOUTH

SCHED. SCHEDULE

SECT. SECTION

SQ.

STD.

STL.

PARTITION

REFERENCE

REQUIRED

REINFORCED

FIBERGLASS PANEL

S.E.D. SEE ELECTRICAL DWGS V.I.F.

ROUGH OPENING

S.C.D. SEE CIVIL DRAWINGS

SQUARE FEET

SIMILAR

SQUARE

STEEL

STOR. STORAGE

S.M.D. SEE MECHANICAL

DRAWINGS

DRAWINGS

TAINLESS

SPECIFICATION

SEE STRUCTURAL

REFIGERATOR

12. ALL EXITS TO BE OPENED FROM INSIDE WITHOUT USE OF A KEY.

NO CHANGES TO EXTERIOR BUILDING UNDER THIS PERMIT.

STRUCT.STRUCTURAL

TO BE

THICK

T.O.S. TOP OF SLAB

T.O.W. TOP OF WALL

TYPICAL

VERTICAL

VOLUME

WEST

WITH

WOOD

WEIGHT

W/O WITHOUT

YD. YARD

X or x BY

UNDERWRITERS

LABORATORY

OTHERWISE N

VERIFY IN FIELD

WIDE or WIDTH

WATER CLOSET

WHERE OCCURS

T.O. TOP OF

DETERMINED

TELEPHONE

TEMPORARY

T.B.D.

TEMP.

THK.

TYP.

VOL.

WD.

WD.

W.O.

WT.

E2.2

BC1

- ALL FEES, PERMITS, UTILITY CONNECTION FEES AND OTHER ASSOCIATED COSTS AS REQUIRED BY GOVERNMENT AGENCIES OR UTILITY COMPANIES.

- ONLY AND ANY PERMITS REQUIRED SHALL BE UNDER A SEPARATE CONTRACT
- CHANGES TO THE WORK AS SHOWN IN THE CONTRACT DOCUMENTS WITHOUT REPRESENTATIVE. NO ADDITIONAL COSTS FROM THE GENERAL CONTRACTOR
- GENERAL CONTRACTOR SHALL PROVIDE ACCESS PANELS FOR ALL TRADES AS
- SATISFACTORY MANNER.

SHEET

TENANT IMPROVEMENT OF A NEW TAPROOM IN AN EXISTING GROUND FLOOR

- PERMIT EXPEDITER OR GENERAL CONTRACTOR SHALL BE RESPONSIBLE FOR
- PERMIT EXPEDITER OR GENERAL CONTRACTOR SHALL BE RESPONSIBLE FOR

- FIRE EXTINGUISHERS AND CABINETS AS REQUIRED BY LOCAL GOVERNMENT AGENCY SHALL BE PROVIDED BY GENERAL CONTRACTOR AND INCLUDED IN CONTRACT.
- WITHOUT SUCH APPROVAL BY ARCHITECT.
- OWNERS REPRESENTATIVE PRIOR TO EXECUTION OF WORK.
- 10. ALL WALL DIMENSIONS ARE F.O.F. TO F.O.F., U.N.O.

ENVIRONMENTAL HEALTH DEPARTMENT NOTES

MEP/STRUCTURAL/ OTHER CONSULTANTS

MECHANICAL SPECIFICATIONS, NOTES, LEGEND & SCHEDULES

MECHANICAL SPECIFICATIONS, NOTES, LEGENDS & SCHEDULES

PLUMBING SPECIFICATIONS, NOTES, LEGEND & SCHEDULES

PLUMBING WASTE & VENT PIPING FLOOR PLANS

ELECTRICAL LOAD CALCULATION PANEL SCHEDULE

PLUMBING COLD & HOT WATER PIPING PLAN

LEGEND, SINGLE LINE DIAGRAM AND DETAILS

LIGHTING CERTIFICATE OF COMPLIANCE FORMS

DRAWING INDEX

COVER SHEET, INDEX & PROJECT DIRECTORY

ACCESS & CODE DETAILS

GROUND FLOOR PLAN GROUND FLOOR PLAN 02

INTERIOR ELEVATIONS

INTERIOR ELEVATIONS

INTERIOR ELEVATIONS

INTERIOR ELEVATIONS

INTERIOR DETAILS

PROJECT DETAILS

MILLWORK DETAILS -

MILLWORK DETAILS - 2 **CEILING DETAILS**

REFLECTED CEILING PLAN

REFLECTED CEILING PLAN 02

FINISH PLAN & FINISH SCHEDULE

EXTERIOR ELEVATIONS - NOT USED

EXTERIOR ELEVATIONS - NOT USED

PARTITION & INTERIOR DETAILS

TOILET ROOM PLAN & DETAILS SHEET 1 OF 3

TOILET ROOM PLAN & DETAILS SHEET 2 OF 3 **TOILET ROOM PLAN & DETAILS SHEET 3 OF 3**

EQUIPMENT PLAN, SCHEDULE & NOTES

EQUIPMENT PLAN, SCHEDULE & NOTES

MECHANICAL FLOOR PLAN

MECHANICAL TITLE-24 FORMS

MECHANICAL TITLE-24 FORMS

PLUMBING DETAILS

ELECTRICAL PLAN

LIGHTING PLAN

SITE PLAN

ROOF PLAN

ROOF PLAN 02

NOTES AND WALL SCHEDULE

DEMOLITION & SITE CONDITION PLAN DEMOLITION & SITE CONDITION PLAN 02

THE FOLLOWING NOTES REFER TO ALL FOOD PREPARATION AND STORAGE AREAS, DISHWASHER. GARBAGE. AND REFRIGERATION ROOMS. LOCALLY ADOPTED CODES PREVAIL IN THE EVENT OF ANY CONFLICTS.

- ALL FOOD SERVICE EQUIPMENT SHALL MEET DESIGN, MATERIALS AND CONSTRUCTION STANDARDS OF THE NATIONAL SANITATION FOUNDATION (NSF) WOOD AND PLASTIC LAMINATE CONSTRUCTED COUNTERS AND BARDS MUST MEET HEALTH DEPARTMENT STANDARDS AND ALL EXPOSED WOOD MUST HAVE AN APPROPRIATE SEALER OR BE OTHERWISE PROTECTED FROM DETERIORATION.
- ALL EQUIPMENT, OTHER THAN EASILY MOVABLE EQUIPMENT, (ON CASTERS OR LIGHT ENOUGH FOR EASY MOVEMENT), SHALL BE INSTALLED WITH SUFFICIENT, UNOBSTRUCTED SPACE BETWEEN AND BEHIND THE EQUIPMENT TO PERMIT CLEANING OR BE SEALED TO THE WALL AND ADJOINING EQUIPMENT. EQUIPMENT NOT ON CASTERS SHALL HAVE AT LEAST 6 INCHES OF CLEAR SPACE BENEATH, BE SEALED TO THE FLOOR, OR PLACED ON A 6" MINIMUM CURBS AND SEALED TO THE CURB.
- ALL FOOD SERVICE EQUIPMENT DRAINS SHALL BE INDIRECTLY CONNECTED TO SEWER WITH A PROPER VACUUM BREAK PROVIDED. FLOOR SINKS MUST BE INSTALLED FLUSH WITH THE FINISHED FLOOR AND ACCESSIBLE FOR CLEANING (AT LEAST (1/2 EXPOSED FROM UNDER EQUIPMENT).
- . A CENTRAL REFUSE FACILITY IS PROVIDED BY THE LANDLORD FOR USE BY THIS
- 5. FLOORS AND WALLS IN FLOOD PREPARATION AND STORAGE AREAS SHALL BE OF SMOOTH, DURABLE, IMPERVIOUS TO WATER, ACID, AND GREASE AND FINISHED SO AS TO BE EASILY CLEANABLE. FLOOR/WALL JUNCTURES SHALL BE SEALED AND PROPERLY COVED. BARE CEMENT FLOORS MUST HAVE AN APPROPRIATE SEALER-HARDENER APPLIED. ALL WALL SURFACES SHALL BE SEALED WITH AT LEAST AND OIL-BASE ENAMEL PAINT.
- 6. DOORS AND OTHER OPENINGS TO OUTSIDE SHALL BE TIGHT-FITTING AND SELF-CLOSING.
- FLOOR SURFACES IN AREAS WITH REQUIRED FLOOR DRAINS SHALL BE SLOPED 1:50 TO THE FLOOR DRAINS.
- 8. LOCATION AND INSTALLATION OF MOP SINK MUST BE MADE TO PRECLUDE THE POSSIBILITY OF CONTAMINATION OF FOODSTUFFS AND PREPARATION AREAS.
- ADEQUATE AND SUFFICIENT EXHAUST AND FRESH-AIR INTAKE VENTILATION SHALL BE PROVIDED IN FOOD PREPARATION AREAS, FOOD SERVING ARES, UTENSIL WASHING ROOMS, GARBAGE AND RUBBISH ROOMS. VENTILATION HOODS WITH ADEQUATE MECHANICAL EXHAUST SHALL BE PROVIDED ABOVE ALL COOKING EQUIPMENT SUCH AS RANGES, OVENS, GRILLES, ETC., TO EFFECTIVELY REMOVE COOKING ODORS, SMOKE GREASE AND STEAM. EXHAUST HOODS HALL MEET NSF
- 11. FIFTY (50) FOOTCANDLES OF LIGHT (30" ABOVE THE FLOOR) IS REQUIRED WHERE FOOD IS PREPARED, MANUFACTURED, PROCESSED OR PACKAGED, AND WHERE UTENSILS ARE CLEANED (EXCEPT THAT SURFACES ON WHICH ALCOHOLIC BEVERAGES ARE PREPARED OR WHERE UTENSILS USED IN THE PREPARATION OR SERVICE OF ALCOHOLIC BEVERAGES ARE CLEANED SHALL HAVE AT LEAST 10 FOOTCANDLES OF LIGHT). TWENTY (20) FOOTCANDLES OF LIGHT (30" ABOVE THE FLOOR) IS REQUIRED DURING GENERAL CLEANING. LIGHT FIXTURES IN AREAS WHERE FOOD IS PREPARED OF OPEN FOOD IS STORED OR WHERE UTENSILS ARE CLEANED SHALL BE OF SHATTERPROOF CONSTRUCTION OF HAVE SHATTERPROOF SHIELDS AND SHALL BE
- 12. EXCEPT FOR LARGE OR BULKY CONTAINERS, ALL FOOD SHALL BE STORED AT LEAST 6" OFF OF THE FLOOR.

DEFERRED SUBMITTALS

THE FOLLOWING SCOPES MAY REQUIRE SEPARATE ADDITIONAL PERMITS. SCOPES INCLUDING, BUT NOT LIMITED TO:

- 1. SIGNAGE BY OTHERS
- 2. FIRE SPRIKLERS BY OTHERS

BAREBOTTLE BREW COMPANY SANTA CLARA SQUARE BUILDING ONE 2520 AUGUSTINE SQUARE


SANTA CLARA, CA 95054

LANDLORD/PERMIT 12/21/18 SUBMITTAL SET

PROJECT DATA &

SHEET NUMBER

CODE INFORMATION

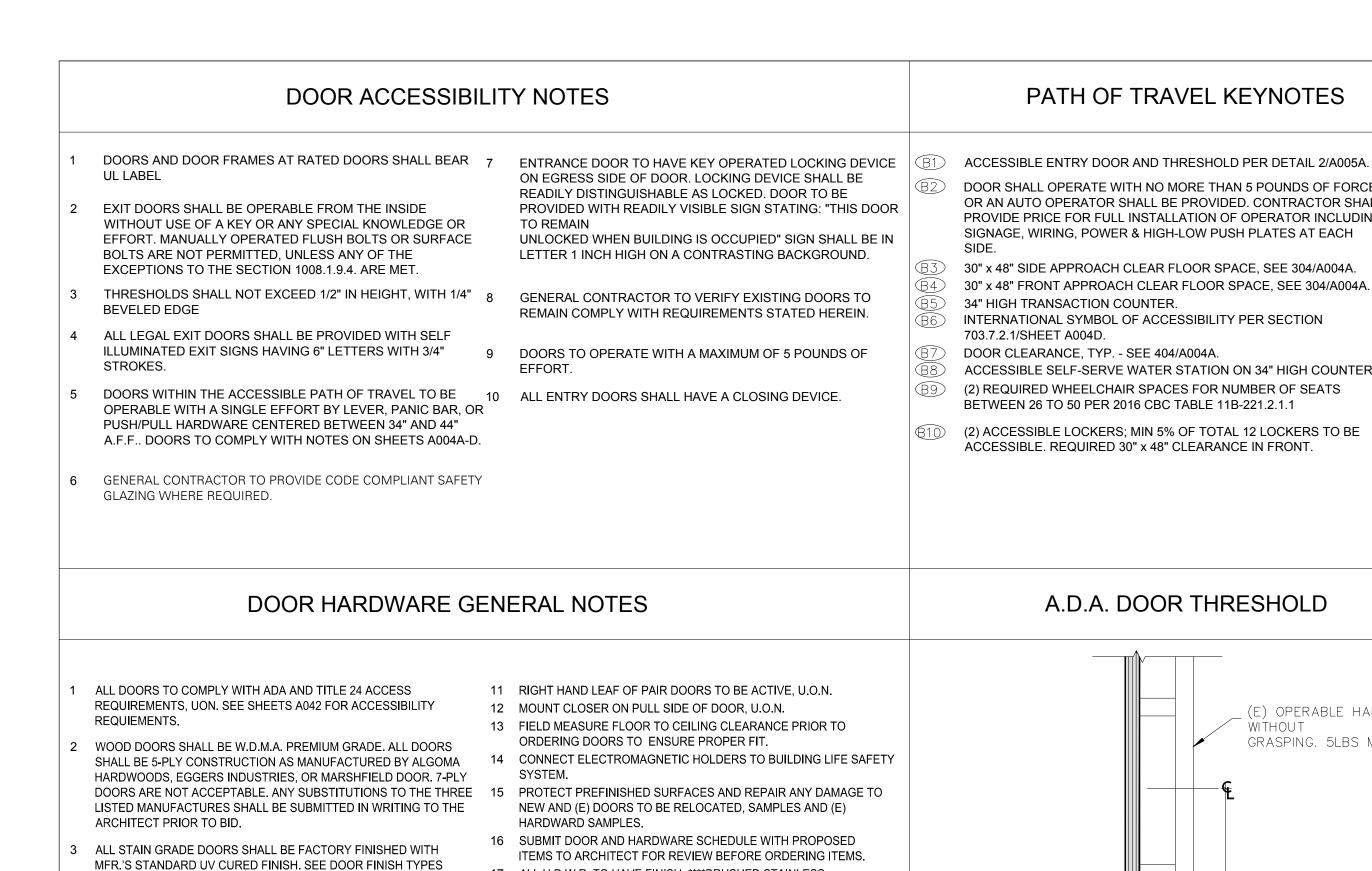

OPENINGS WITH CLOSERS AND ALL RATED OPENINGS SHALL HAVE 19 PROVIDE APPROPRIATE SMOKE SEALS AND 'S' LABEL ASSEMBLIES

FOR ADDITIONAL INFORMATION.

EACH 30" OF DOOR HEIGHT.

CONTROLS INTERNATIONAL.

NECESSARY.

HINGES SHALL BE BY HAGER, MCKINNEY, OR STANLEY. ALL

6 CLOSERS SHALL BE BY LCN. ALL CORRIDOR DOORS SHALL HAVE

DOORS SHALL HAVE 1461 MODEL CLOSERS WITH INDICATED

7 FLUSH BOLTS AND COORDINATORS SHALL BE BY IVES OR DOOR

9 SMOKE GASKET, THRESHOLDS, ASTRAGALS, DOOR BOTTOMS, ETC.

SIZE

HEIGHT

7' - 0"

7' - 0"

7' - 0"

7' - 0"

7' - 0"

3' - 0" 7' - 0"

THICK

3/4"

1 3/4" SC WD

1 3/4" SC WD

1 3/4" SC WD

2" PER MFR

PER MFR

MATERIAL

FINISH

STAINLESS

PER MFR

PER MFR

WIDTH

3' - 0"

3' - 0"

3' - 0"

4' - 0"

ELEV.

01 EXISTING

07 PER MFR

08 PER MFR

10 EXISTING

EXISTING

02

03

04

05

TYPE

8 FLAT GOODS SHALL BE BY IVES, HAGER, OR ROCKWOOD.

SHALL BE BY PEMKO OR NATIONAL GUARD PRODUCTS

10 PROVIDE FLOOR STOP AT ALL LOCATIONS WHERE DOOR WILL

STRIKE PARTITION. PROVIDE RISERS AND DOOR MATES AS

4010/4110 MODEL CLOSERS WITH INDICATED FINISH. INTERIOR

5 LOCKS SHALL MATCH BUILDING STANDARD, U.O.N.

BALL BEARING HINGES. DOORS GREATER THEN 36" IN WIDTH SHALL

HAVE HEAVYWEIGHT HINGES. ONE HINGE SHALL BE PROVIDED FOR

17 ALL H.D.W.R. TO HAVE FINISH: ****BRUSHED STAINLESS

20 COORDINATE WITH SECURITY VENDOR ON ALL DOORS REQUIRING

CARD READERS OR OTHER EXITING / SECURITY DEVICES.

21 ALL RATED DOORS WITH GLASS TO HAVE CLEAR RATED GLASS

23 ANY FIRE RATED DOORS THAT ARE TO BE REMOVED AND BE

REPLACED ARE TO REMAIN IN PLACE UNTIL (N) DOORS ARE READY

DOOR SCHEDULE

HEAD

1/A5.1

1/A5.1

1/A5.1

DETAILS

(E)

2/5.1

2/5.1

2/A5.1

JAMB

MATERIAL

STL

PER MFR

PER MFR

FINISH

PER MFR

PER MFR

RATING

NR

NR

HDWR

GP-2

GP-2

PER MFR

COMMENTS

WALK-IN COOLER GLASS DOOR PER MFR.

22 LEVER TYPE TO BE: ****SHLAGE RHODES STYLE, WITH 2"

18 SALVAGE H.D.W.R. AT DOORS TO BE RELOCATED.


AT ALL RATED DOORS.

ESCUCHEON*****

FOR INSTALLATION.

24 KEYING BY LANLORD, UON.

WITH RATING TO MATCH DOOR.

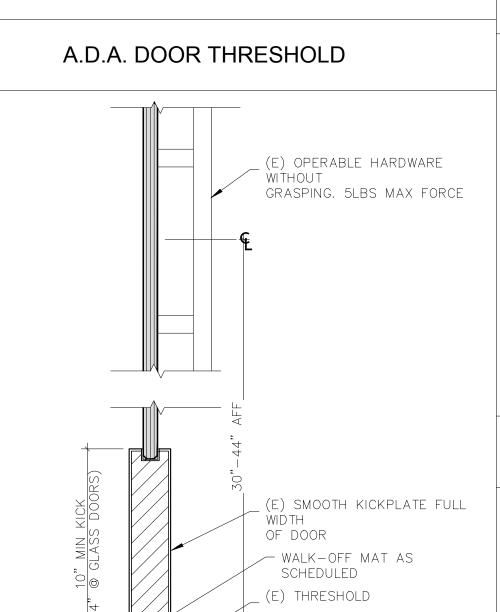

PATH OF TRAVEL KEYNOTES

DOOR SHALL OPERATE WITH NO MORE THAN 5 POUNDS OF FORCE

OR AN AUTO OPERATOR SHALL BE PROVIDED. CONTRACTOR SHALL

PROVIDE PRICE FOR FULL INSTALLATION OF OPERATOR INCLUDING

SIGNAGE, WIRING, POWER & HIGH-LOW PUSH PLATES AT EACH

30" x 48" SIDE APPROACH CLEAR FLOOR SPACE, SEE 304/A004A.

INTERNATIONAL SYMBOL OF ACCESSIBILITY PER SECTION

34" HIGH TRANSACTION COUNTER.

DOOR CLEARANCE, TYP. - SEE 404/A004A.

703.7.2.1/SHEET A004D.

30" x 48" FRONT APPROACH CLEAR FLOOR SPACE, SEE 304/A004A.

ACCESSIBLE SELF-SERVE WATER STATION ON 34" HIGH COUNTER.


(2) REQUIRED WHEELCHAIR SPACES FOR NUMBER OF SEATS


(2) ACCESSIBLE LOCKERS; MIN 5% OF TOTAL 12 LOCKERS TO BE

BETWEEN 26 TO 50 PER 2016 CBC TABLE 11B-221.2.1.1

ACCESSIBLE. REQUIRED 30" x 48" CLEARANCE IN FRONT.


SIDE.

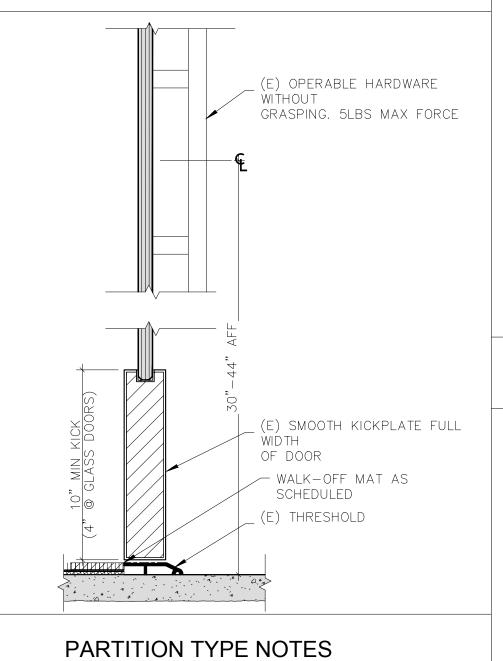

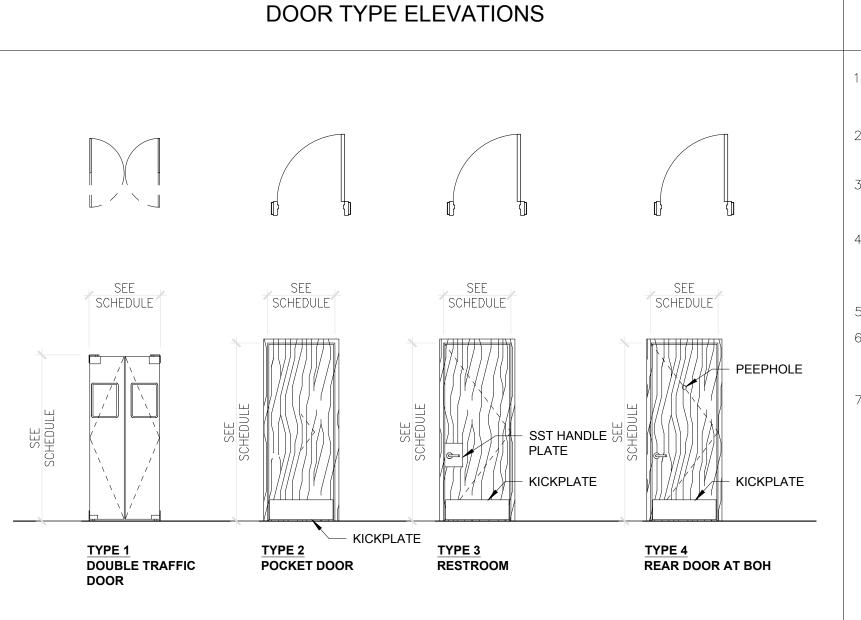


- SEE STRUCTURAL DRAWINGS FOR WOOD STUD SPACING, STUD DOUBLING, NAILING & SCREWING SCHEDULE, AND ADDITIONAL INFORMATION.
- REFER TO GYPSUM ASSOCIATION FIRE RESISTANCE DESIGN MANUAL AND CBC TABLE 720.1 (2) [CRC R302] FOR REFERENCE RATED WALL ASSEMBLIES, FIREBLOCKING, DRAFTSTOPPING. ATTACHMENT OF WALL SHEATHING AND FINISHES TO COMPLY WITH THE REQUIREMENTS OF THE REFERENCED WALL RATED WALL ASSEMBLY AND STRUCTURAL DRAWINGS
- THERMAL INSULATION TO FILL WALL CAVITY. MINIMUM R-13 INSULATION IN 2X4 WOOD-FRAME WALLS & MINIMUM R-19 INSULATION IN 2X6 WOOD-FRAME WALLS OR EQUIVALENT U-FACTOR.
- REFER TO ASTM C1063 FOR CEMENT PLASTER ASSEMBLIES. WHERE INFORMATION DIFFERS FROM CONSULTANT DRAWINGS, USE MORE STRINGENT CRITERIA & CONTACT ARCHITECT TO CONFIRM.
- VERIFY STUD SIZES WITH STRUCTURAL DRAWINGS AND DETAILS, AND NOTIFY ARCHITECT OF ANY CONFLICTS.

ACCESSIBLE PATH OF TRAVEL PLAN * ADA PATH OF TRAVEL TO BE 44" MIN WIDTH √**6**-**F**

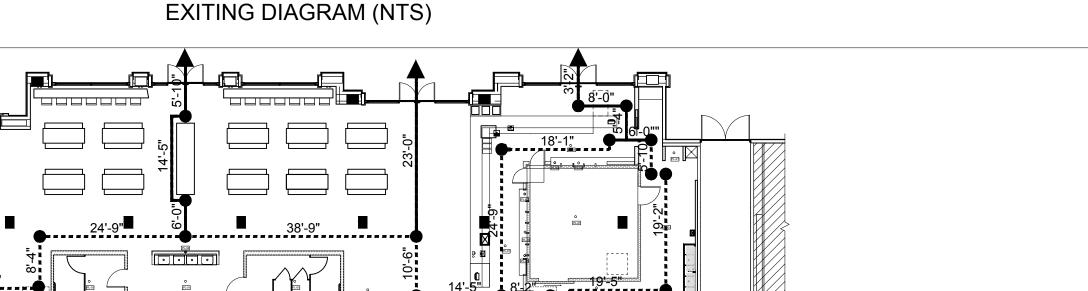

WALL PARTITION SCHEDULE

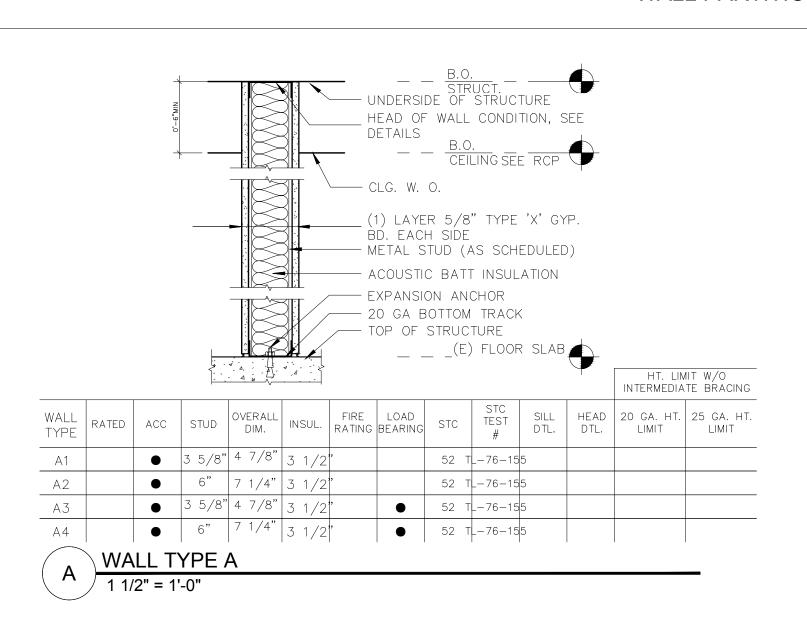

CODE COMPLIANCE ANALYSIS

ACTUAL PROVIDED

(1) EXIT REQUIRED

(2) EXITS PROVIDED

MAX. COMMON PATH OF TRAVEL

(WITH SPRINKLERS)

MAX. DISTANCE TO EXIT

56'-9"

48'-11"

MAX. COMMON PATH OF

TRAVEL

(WITH SPRINKLERS)

150'-0"

MAXIMUM

LOAD

290

MAXIMUM COMMON PATH OF EGRESS TRAVEL DISTANCE:


OCCUPANCY OCCUPANT

26'-3" = 6'-0" + 14'-5" + 5'-10"

26'-3" = 6'-0" + 14'-5" + 5'-10"

A2

INSULATED WALK-IN COOLER WITH VIEW WINDOW PER MFR. | MAXIMUM ACTUAL EXIT ACCESS TRAVEL DISTANCE:

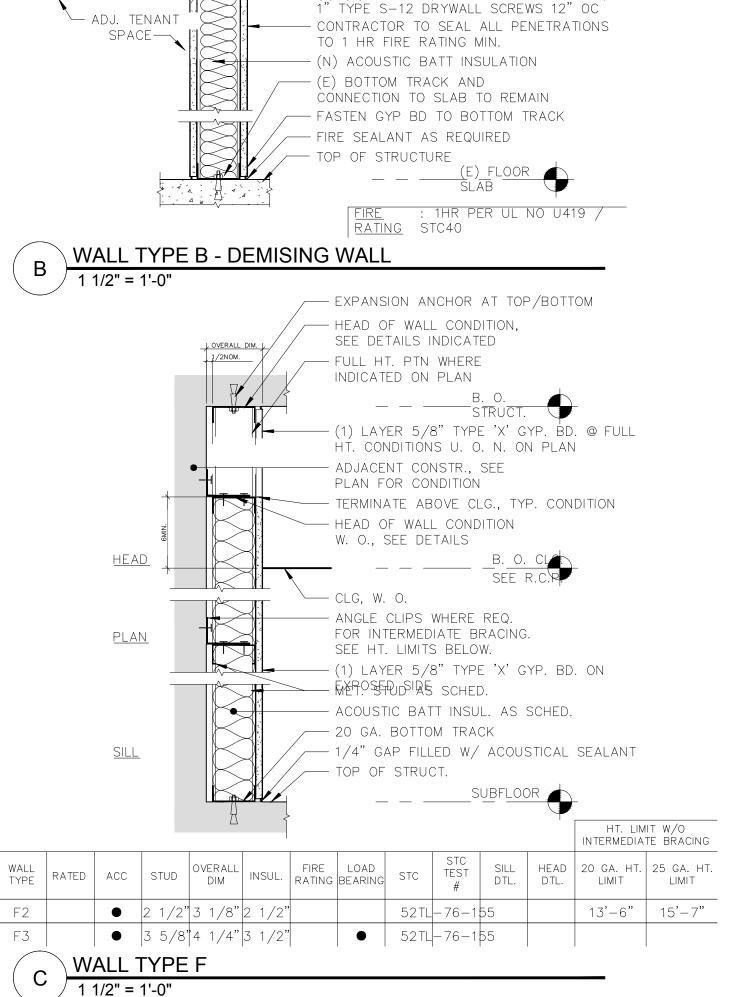

- FIRE SEALANT AS REQUIRED

CONDITION TO REMAIN

(E) GYP BD AT OPPOSITE SIDE BY OTHERS

- (E) STUDS TO REMAIN

CLG. W. O.

— (E) TOP TRACK AND HEAD OF WALL

-(1)(N) LAYER 5/8" TYPE 'X' GYP BD. W/


BAREBOTTLE BREW COMPANY

SANTA CLARA SQUARE BUILDING ONE 2520 AUGUSTINE SQUARE SANTA CLARA, CA 95054

SUBMITTAL/REVISIONS LANDLORD/PERMIT SUBMITTAL SET

12/21/18

GENERAL NOTES WALL SCHEDULE & DETAILS DOOR SCHEDULE, EXITING DIAGRAM-GROUND FLOOR

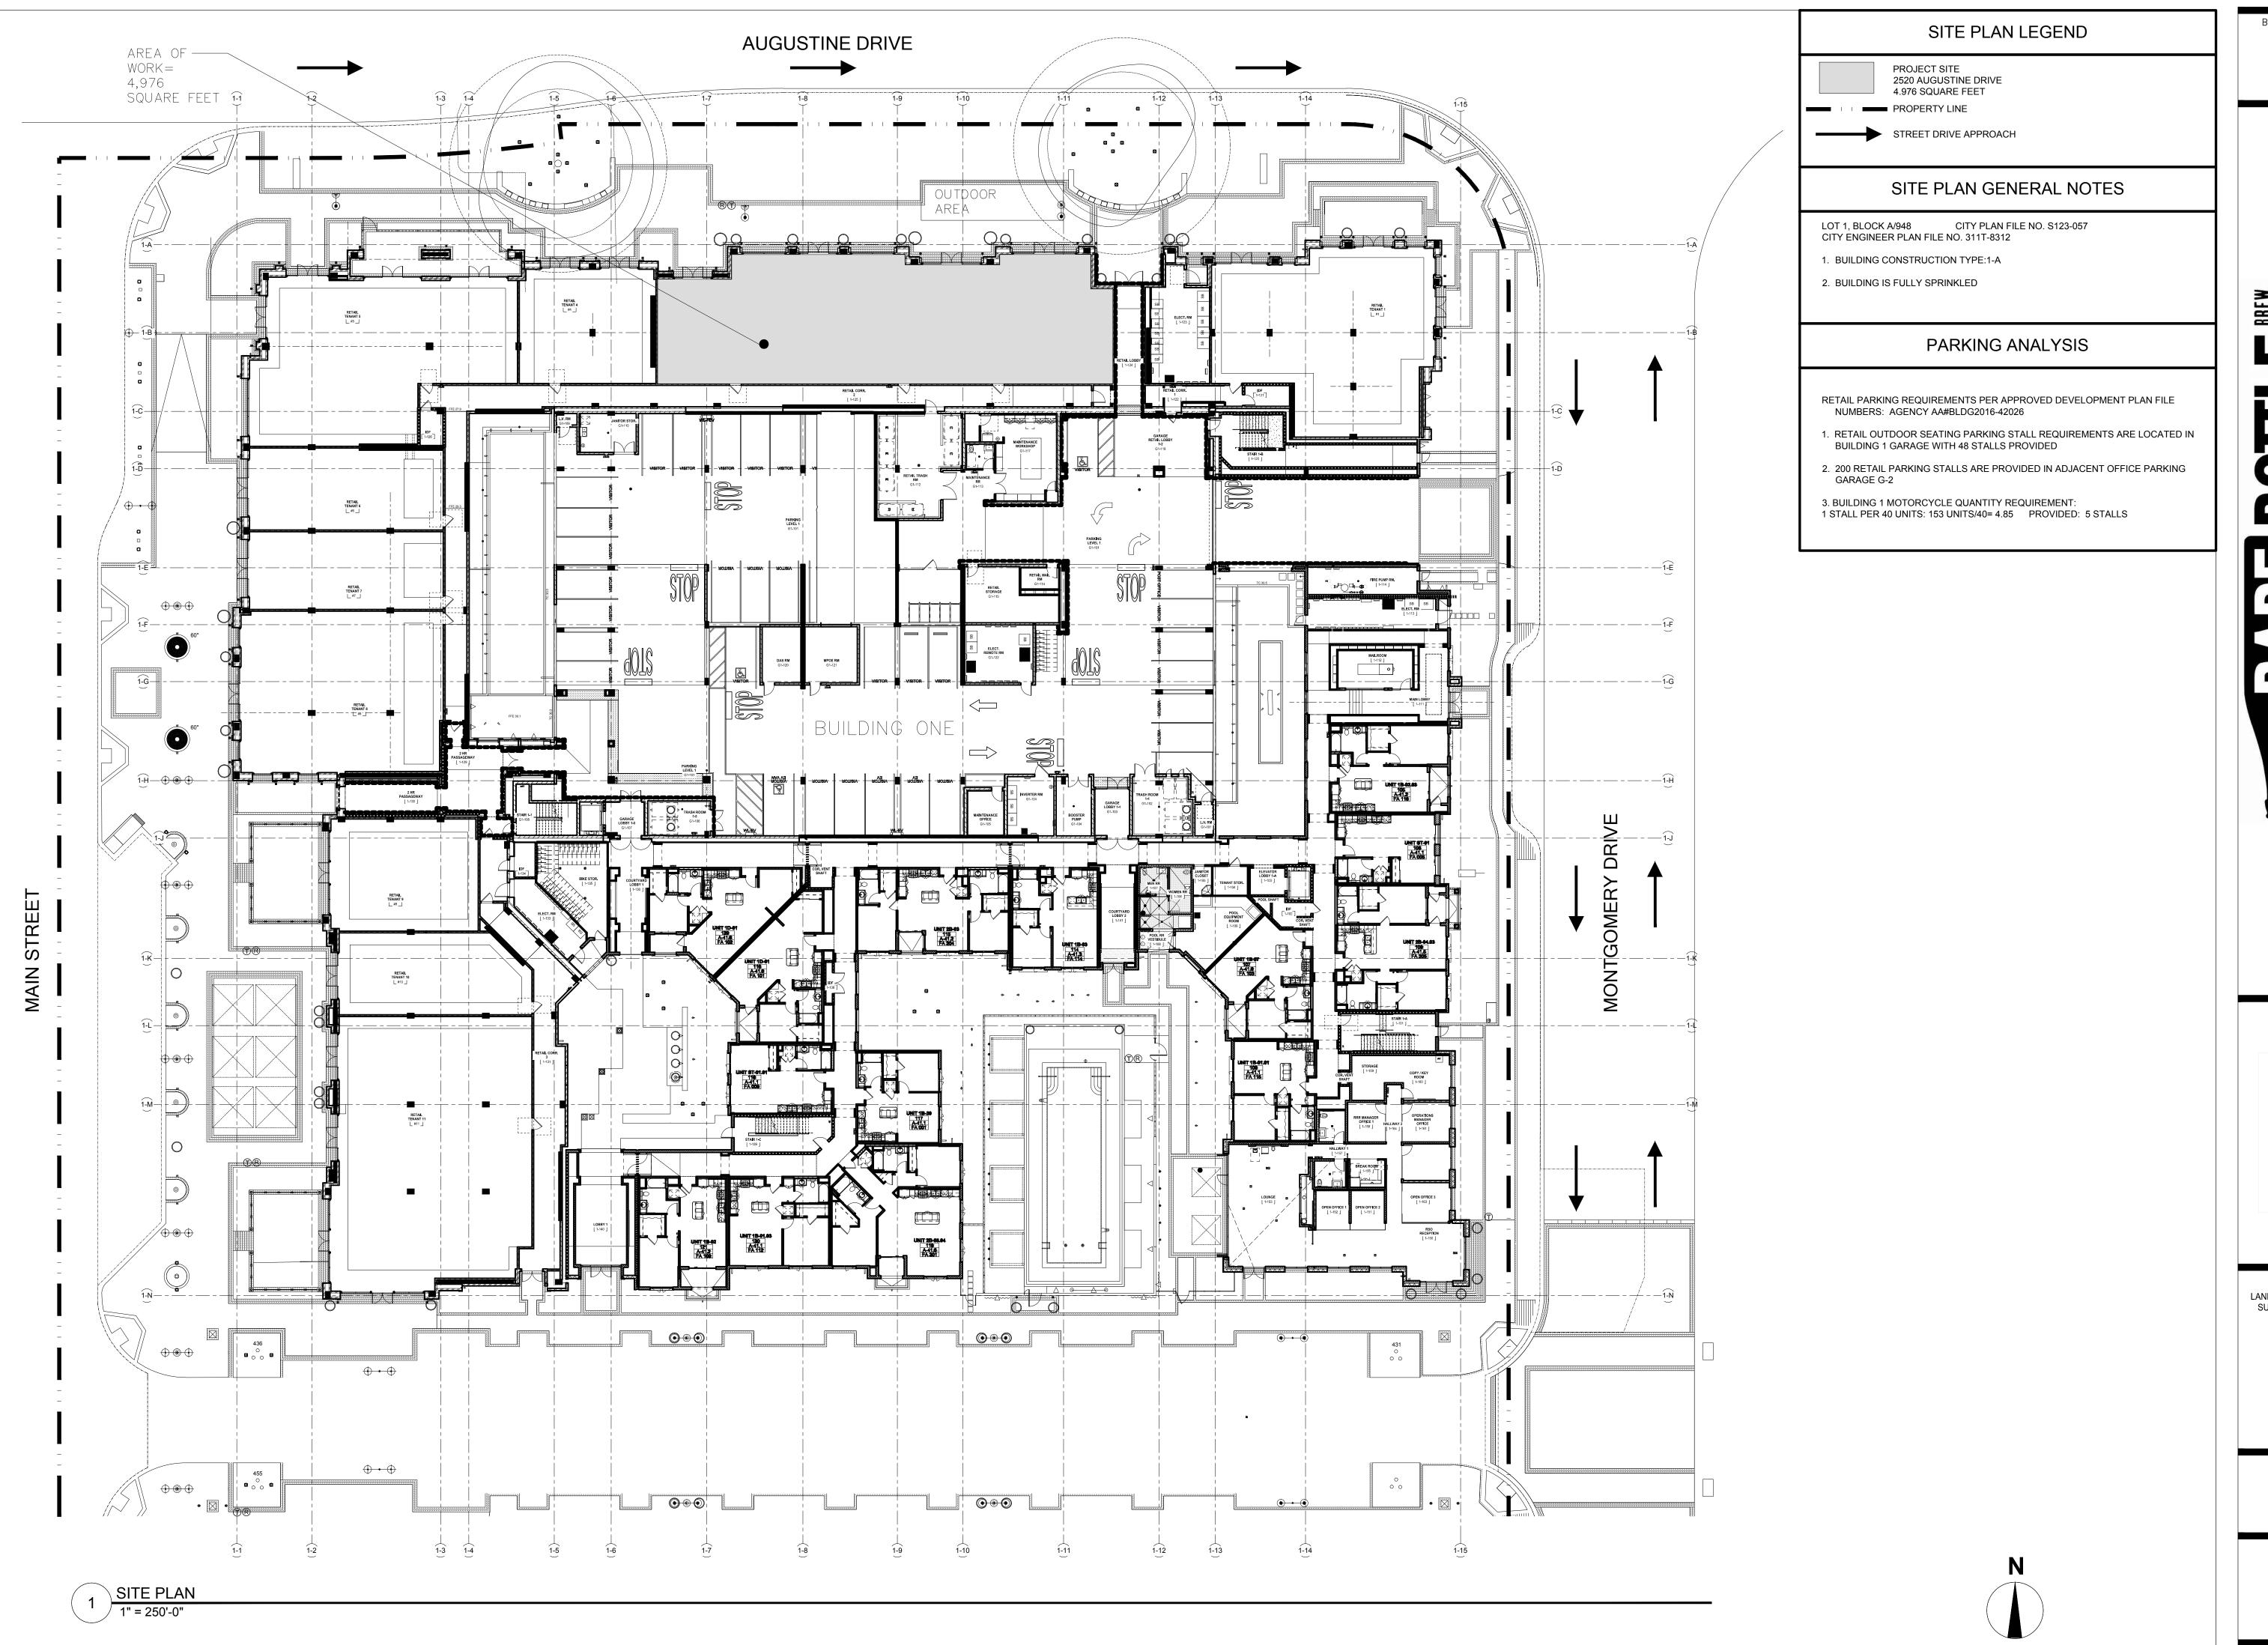


BAREBOTTLE BREW COMPANY SANTA CLARA SQUARE BUILDING ONE

2520 AUGUSTINE SQUARE SANTA CLARA, CA 95054

SUBMITTAL/REVISIONS LANDLORD/PERMIT SUBMITTAL SET

SITE PLAN

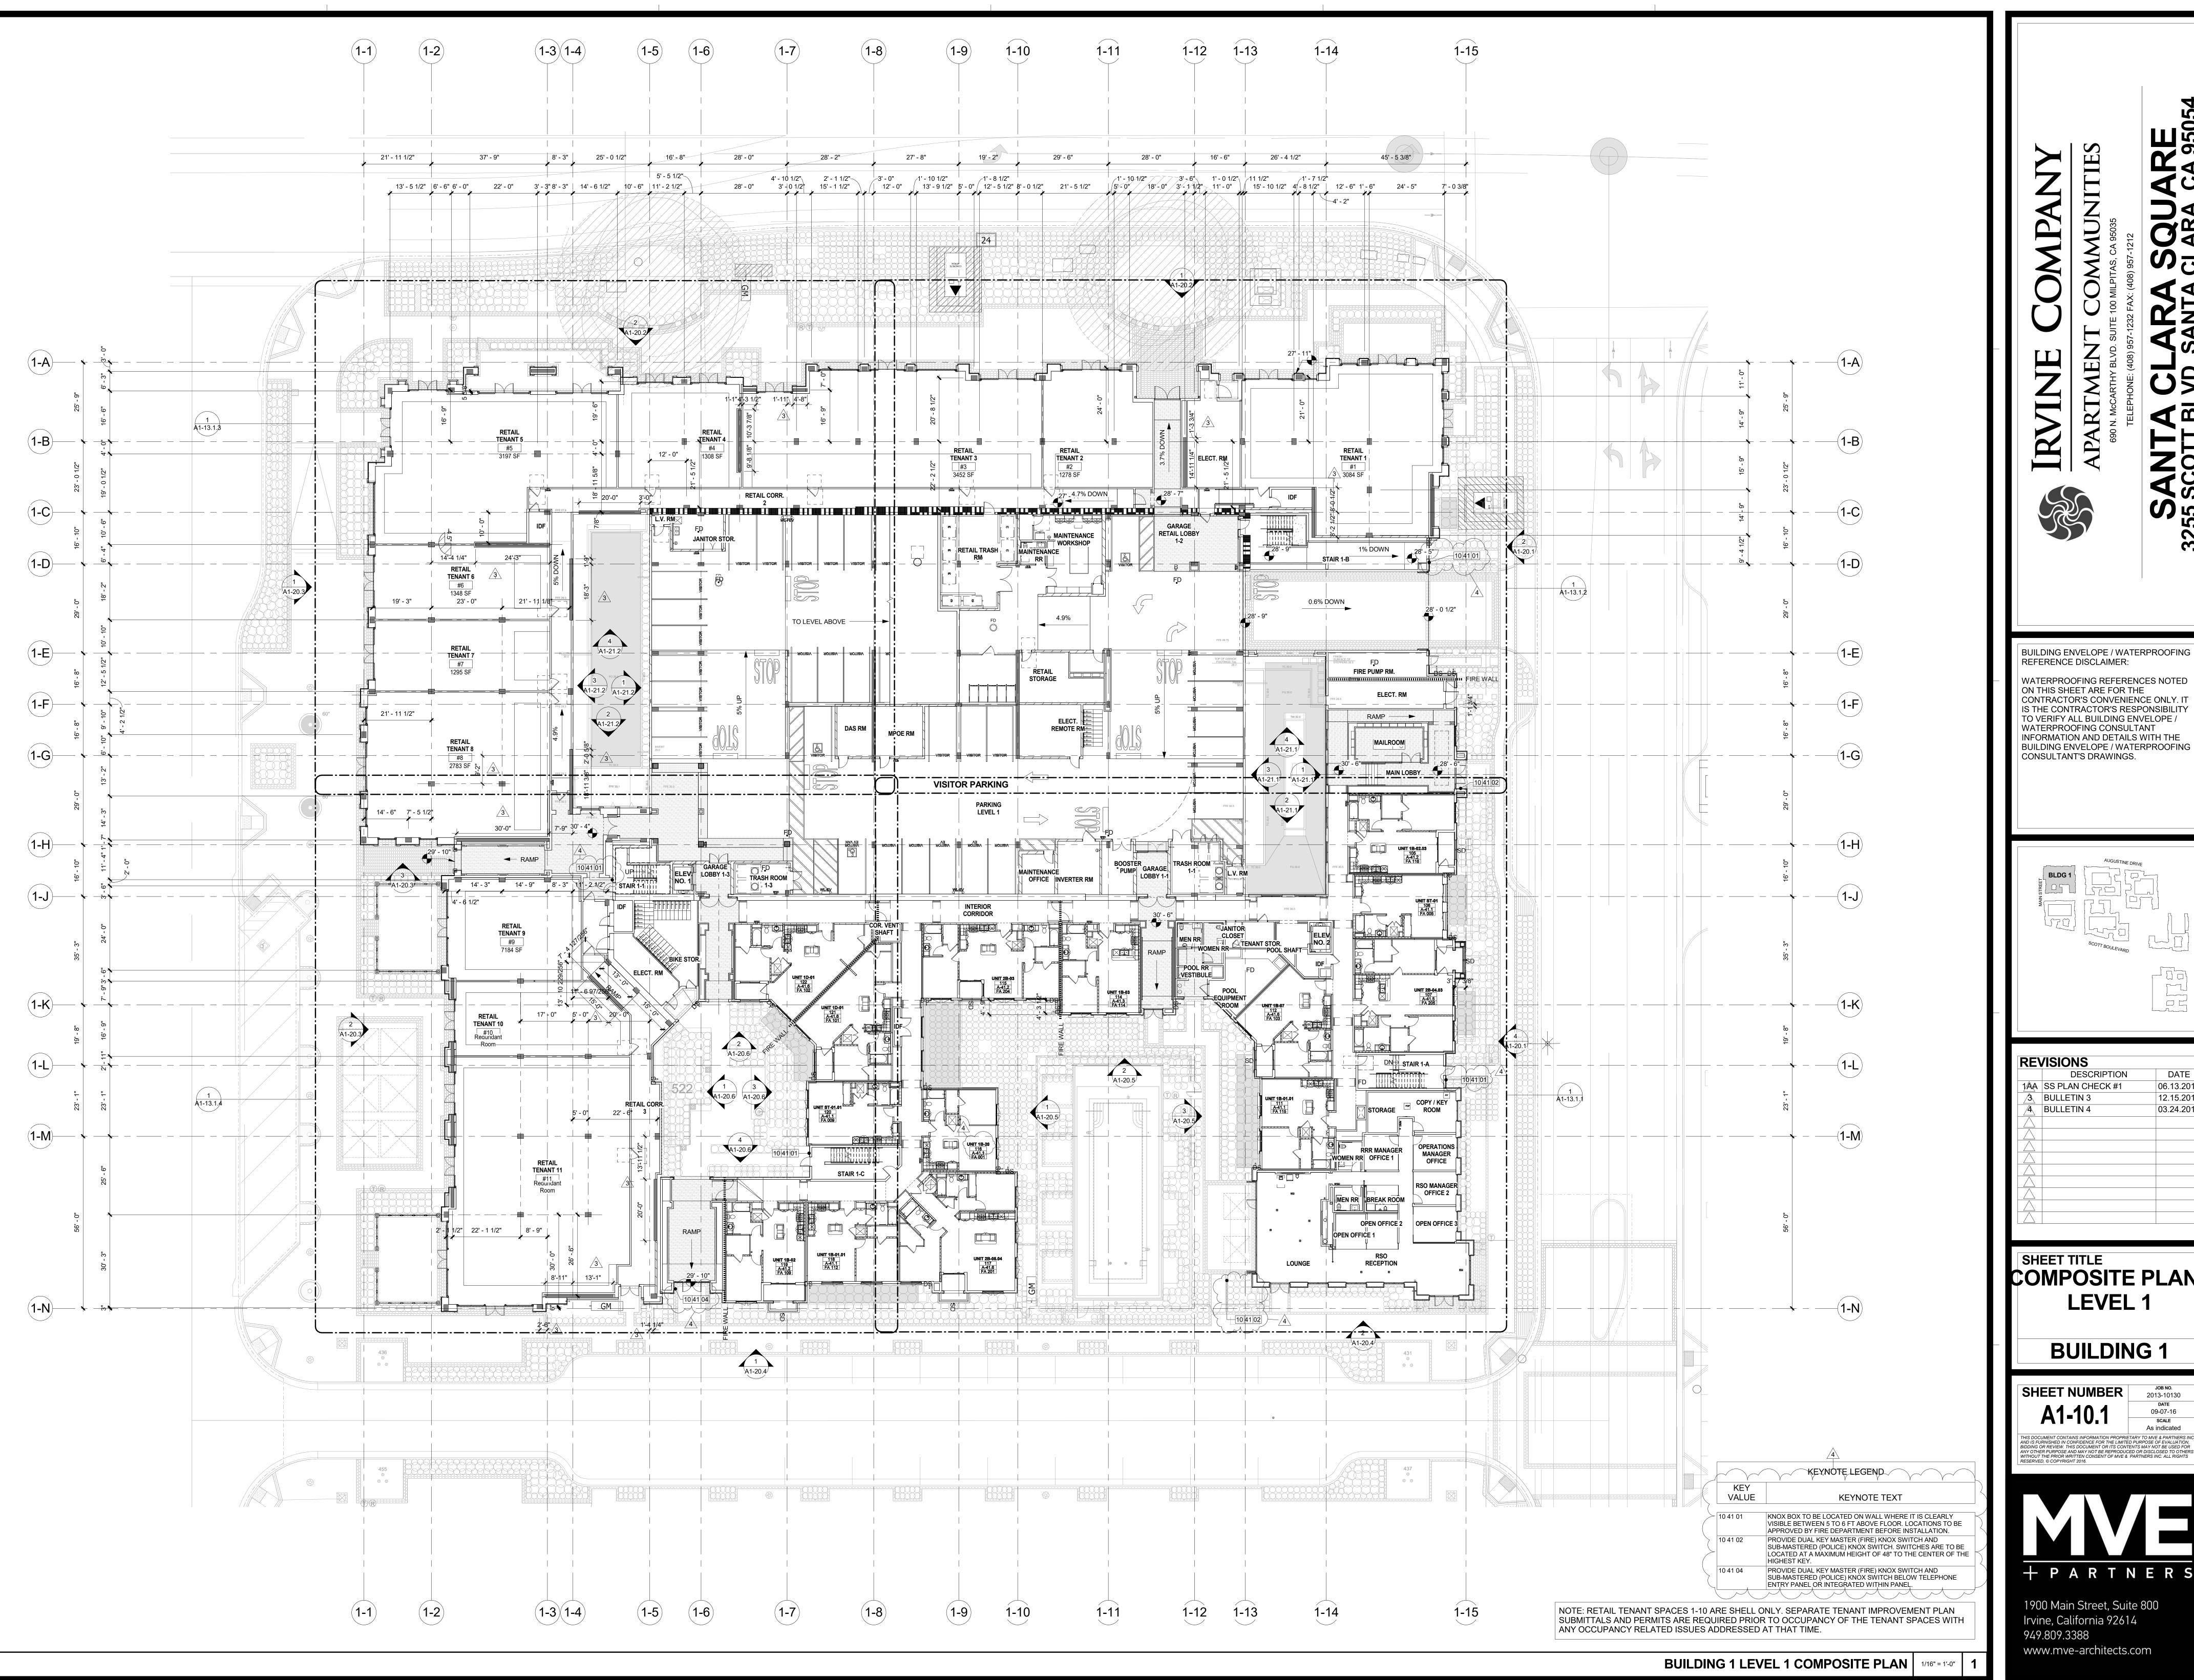



REVISIONS DATE 06.13.2016 1/AA SS PLAN CHECK #1 12.15.2016 **BULLETIN 3** BULLETIN 4 03.24.2017

SHEET TITLE COMPOSITE PLAN -LEVEL 1


BUILDING 1

2013-10130 **DATE** 09-07-16 SCALE As indicated THIS DOCUMENT CONTAINS INFORMATION PROPRIETARY TO MVE & PARTINERS INC.
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DATE DESCRIPTION 1ÂA SS PLAN CHECK #1

CODE ANALYSIS


BUILDING 1

DATE
09-07-16
SCALE
As indicated **A1-GEN-3**

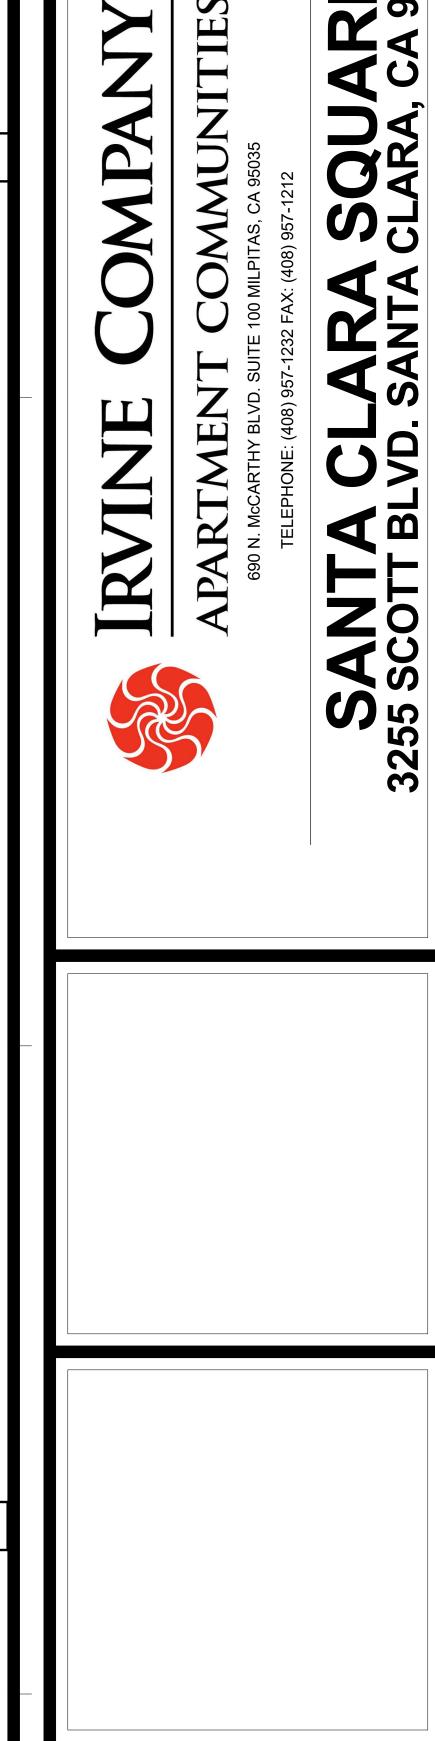

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Irvine, California 92614

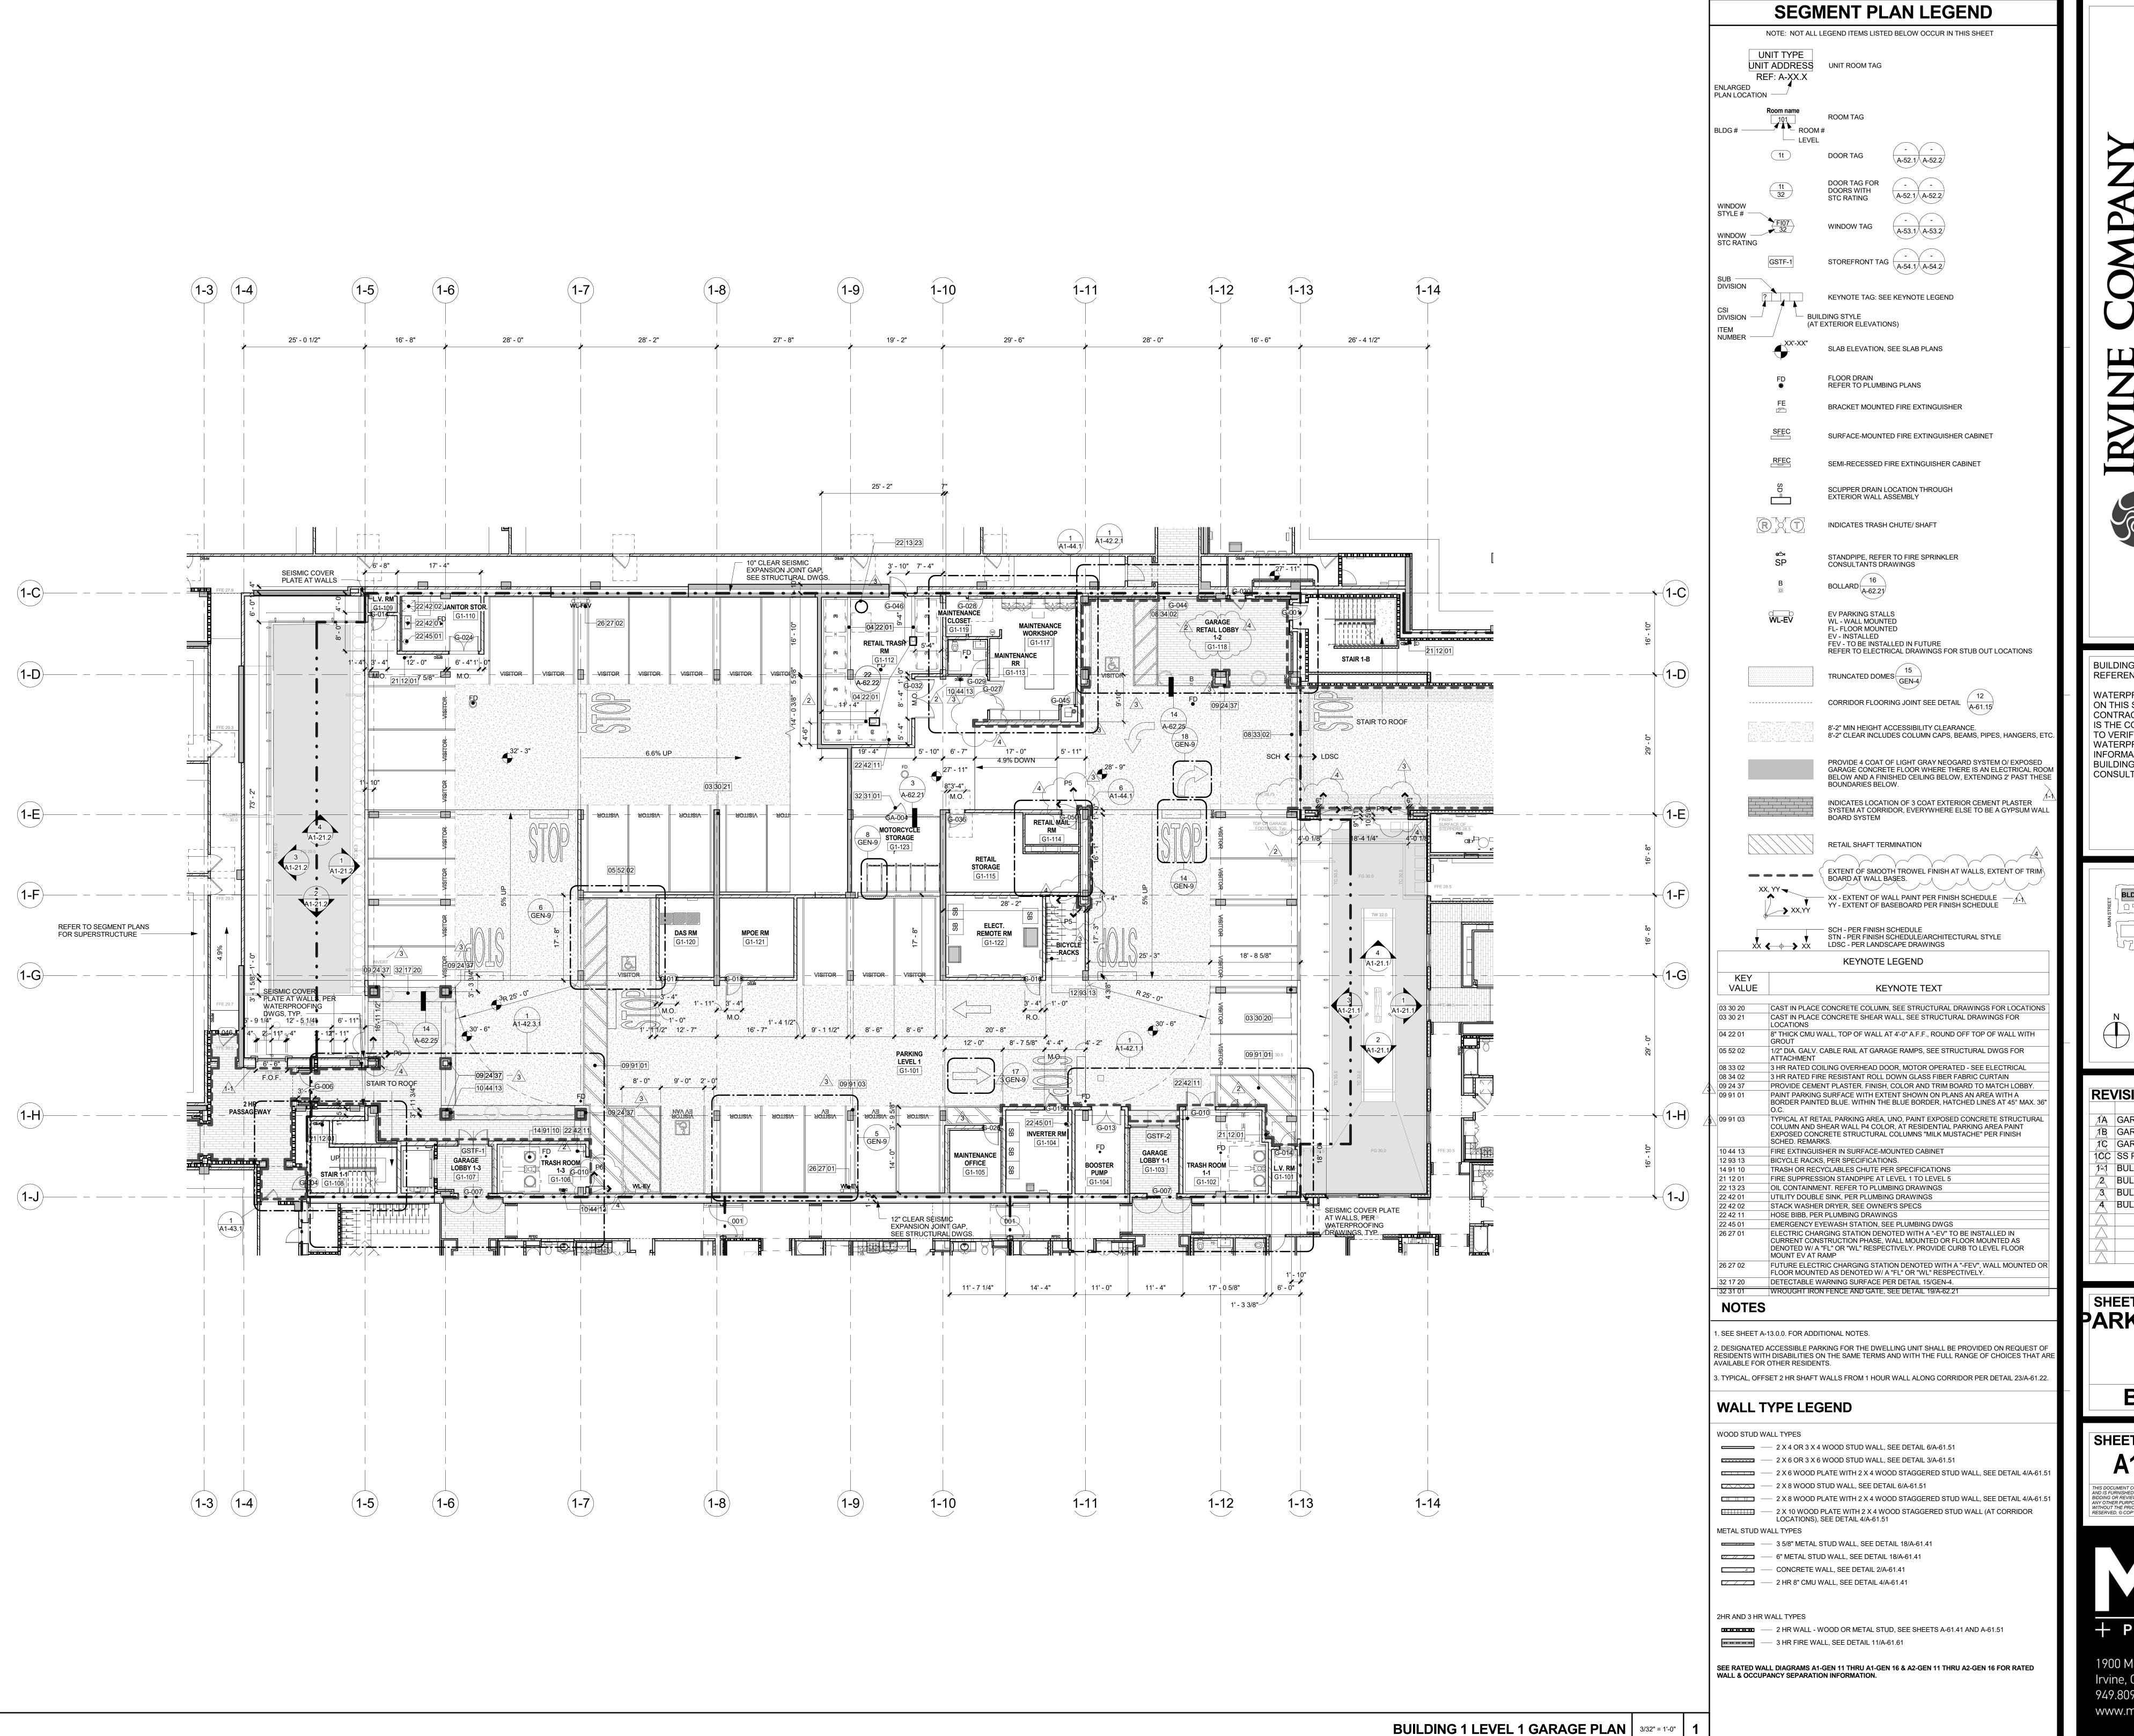

IRVINE COMPANY

APARTMENT COMMUNITIES


690 N. McCARTHY BLVD. SUITE 100 MILPITAS, CA 95035

TELEPHONE: (408) 957-1212

SANTA CLARA SQUARE
3255 SCOTT BLVD. SANTA CLARA, CA 95054

BUILDING ENVELOPE / WATERPROOFING REFERENCE DISCLAIMER:

WATERPROOFING REFERENCES NOTED ON THIS SHEET ARE FOR THE CONTRACTOR'S CONVENIENCE ONLY. IT IS THE CONTRACTOR'S RESPONSIBILITY TO VERIFY ALL BUILDING ENVELOPE / WATERPROOFING CONSULTANT INFORMATION AND DETAILS WITH THE BUILDING ENVELOPE / WATERPROOFING CONSULTANT'S DRAWINGS.

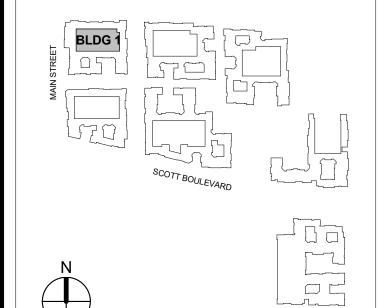

RE \	/ISIONS	
	DESCRIPTION	DATE
1A	GARAGE PLAN CHECK #1	02.23.2016
1B	GARAGE PLAN CHECK #2	04.06.2016
1°C	GARAGE PLAN CHECK #3	06.16.2016
1CC	SS PLAN CHECK #3	09.19.2016
7-1	BULLETIN 1-1	10.11.2016
<u></u>	BULLETIN 2	11.04.2016
<u></u>	BULLETIN 3	12.15.2016
4	BULLETIN 4	03.24.2017
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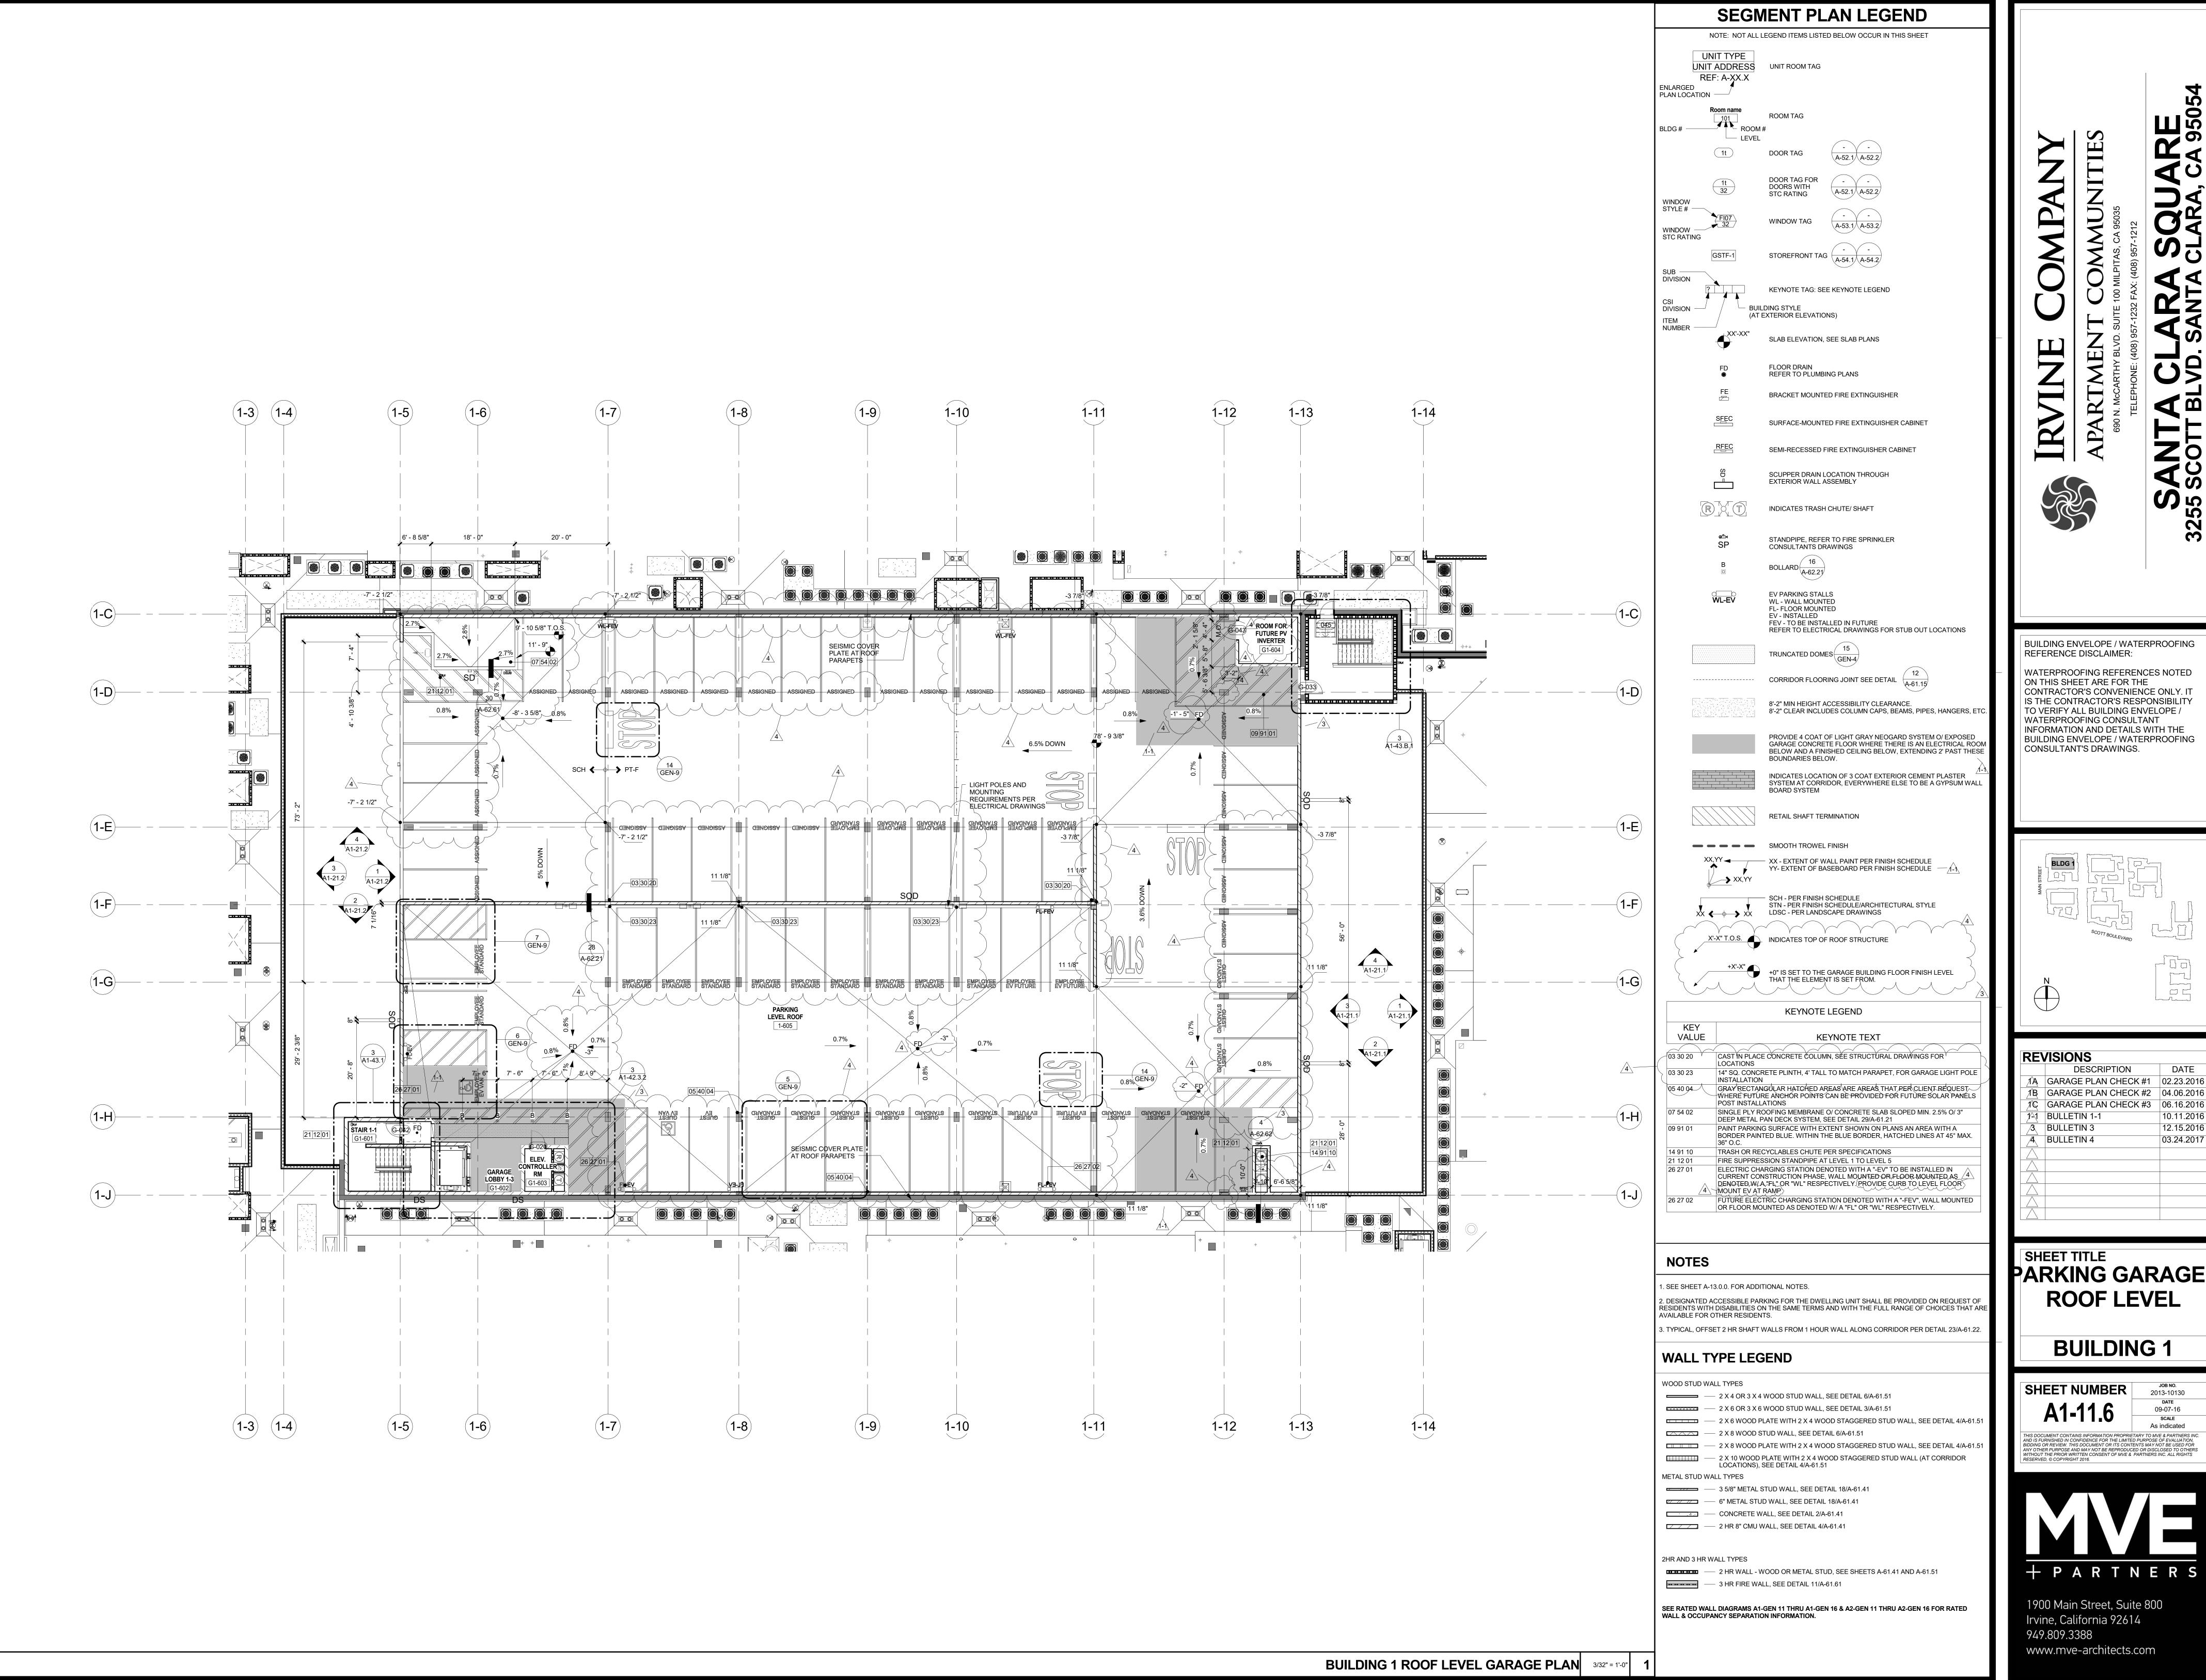
PARKING GARAGE
LEVEL 1

BUILDING 1

CHEET MILIMPED	JOB NO.	
SHEET NUMBER	2013-10130	
	DATE	
A1-11.1	09-07-16	
	SCALE	
	As indicated	
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SHEET TITLE PARKING GARAGE

10.11.2016

12.15.2016

03.24.2017

S55


BUILDING 1


SHEET NUMBER	јов No. 2013-10130
A1-11.6	DATE 09-07-16
A1-11.0	scale As indicated
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SEGMENT PLAN LEGEND

SHEET TITLE PARKING GARAGE **UPPER ROOF** RESIDENTS WITH DISABILITIES ON THE SAME TERMS AND WITH THE FULL RANGE OF CHOICES THAT ARE **LEVEL BUILDING 1**

REVISIONS

BULLETIN 2

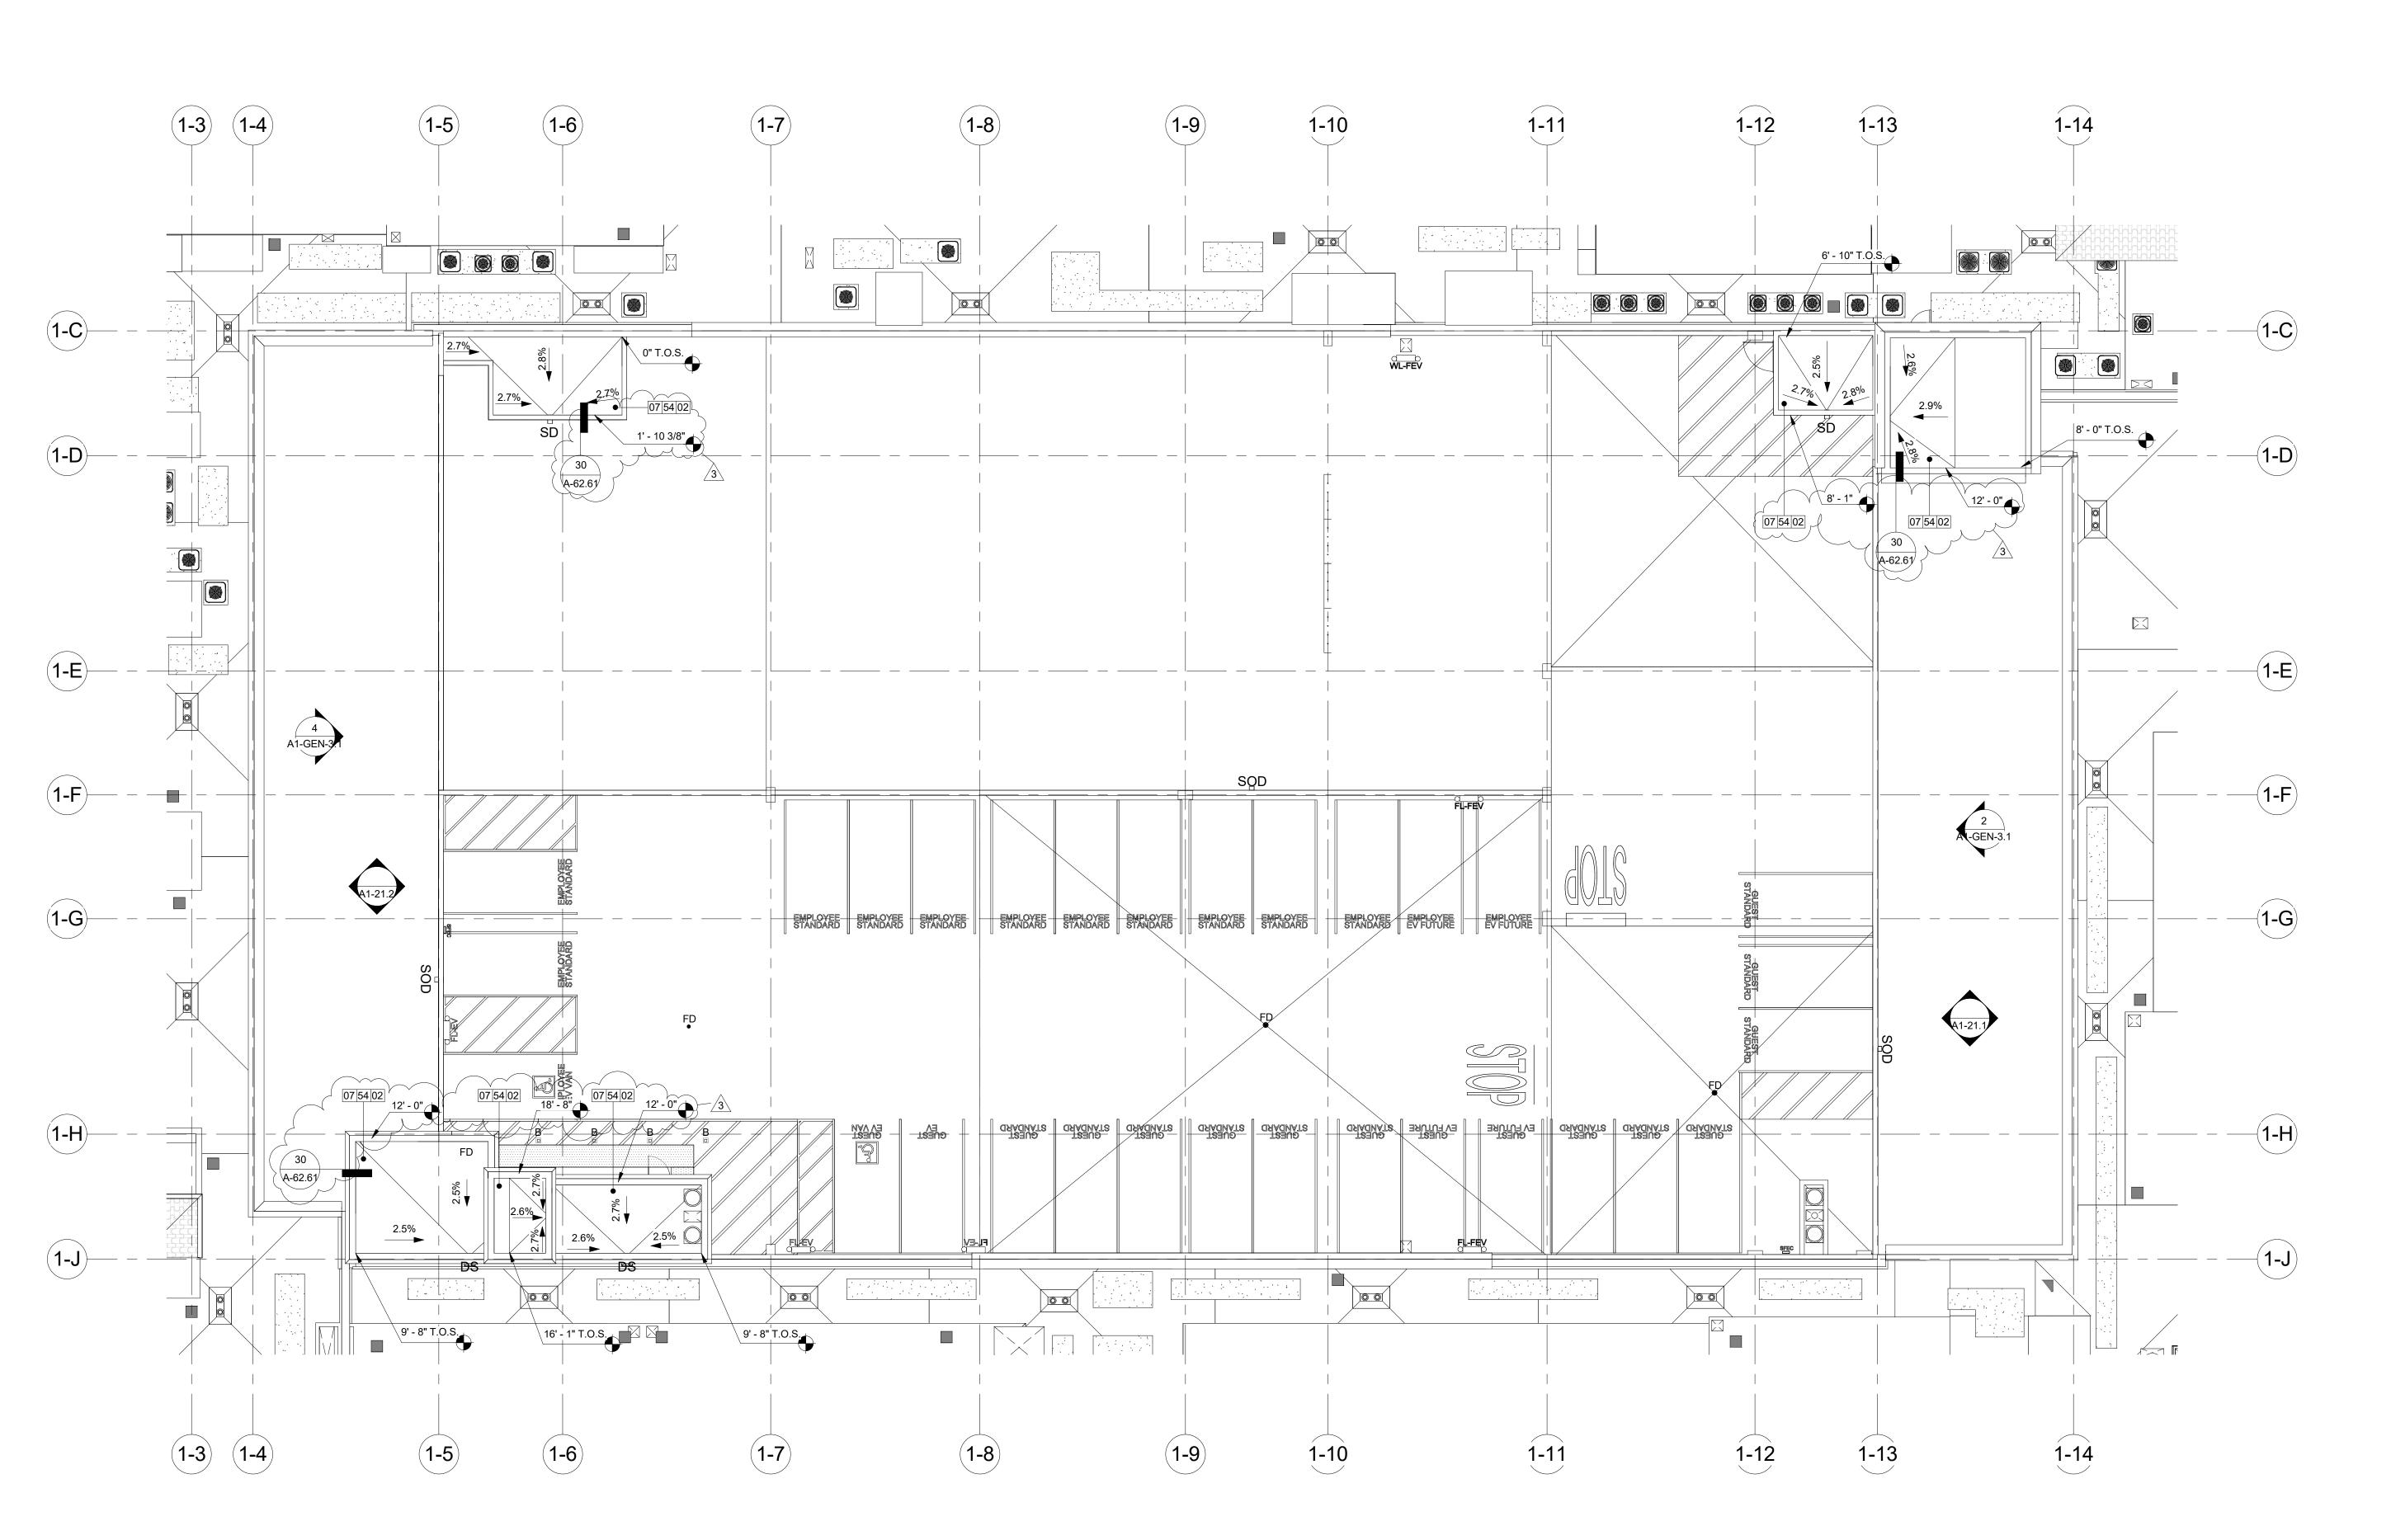BULLETIN 3

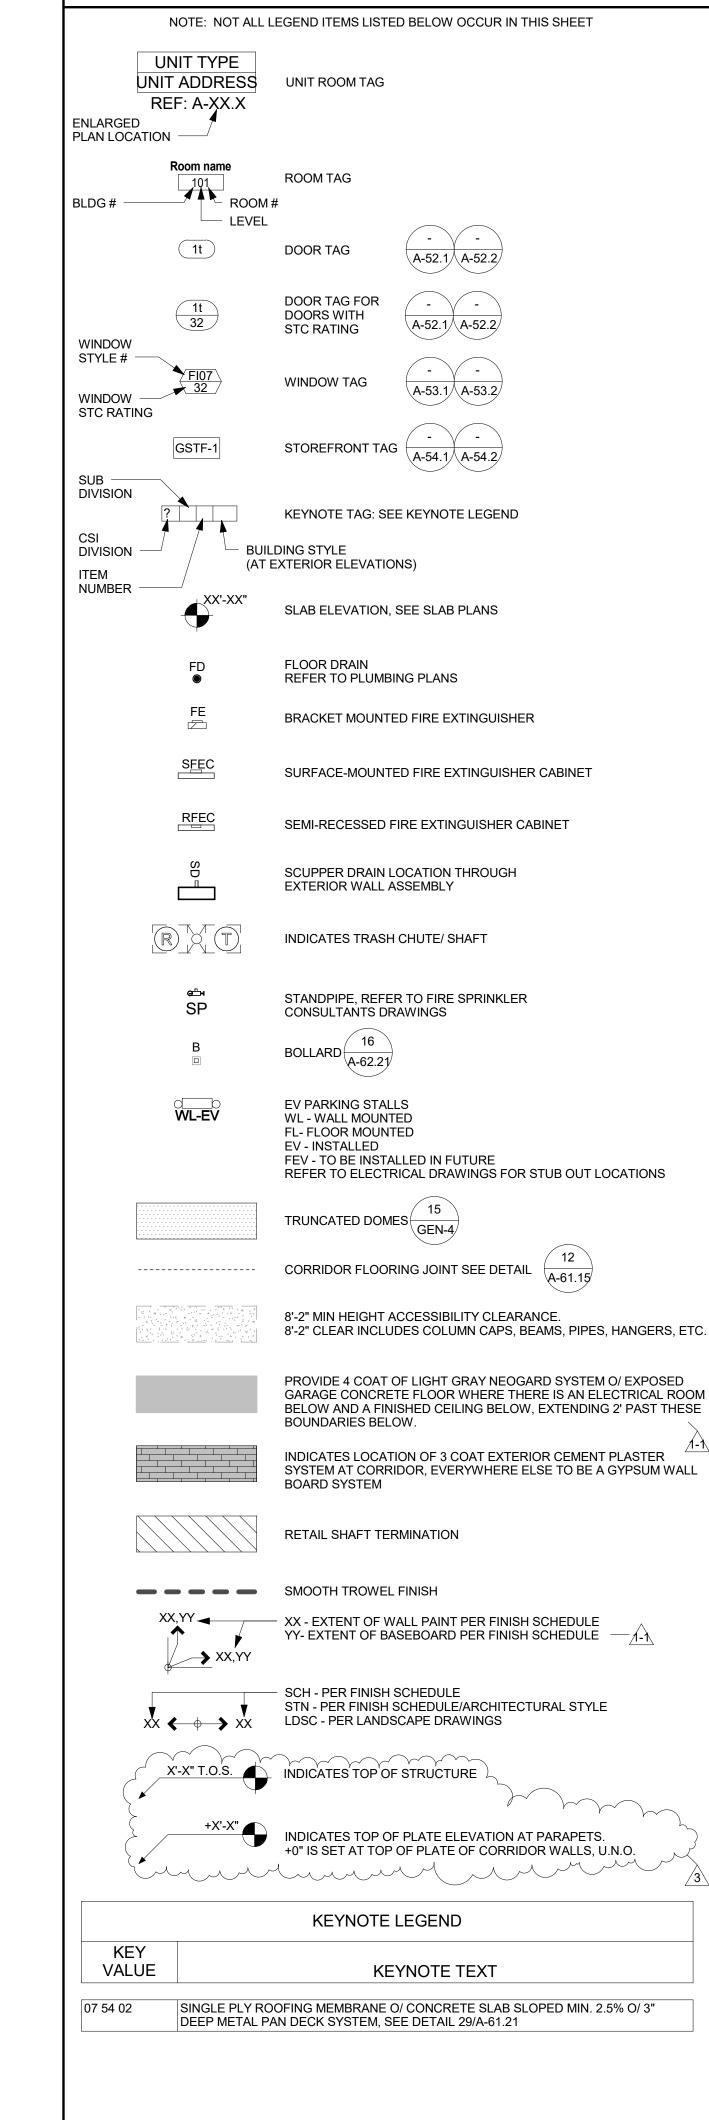SHEET NUMBER	јов No. 2013-10130	
A1-11.7	DATE 09-07-16	
A1-11.1	scale As indicated	
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NOTES

1. SEE SHEET A-13.0.0. FOR ADDITIONAL NOTES.

AVAILABLE FOR OTHER RESIDENTS.

WOOD STUD WALL TYPES

METAL STUD WALL TYPES

2HR AND 3 HR WALL TYPES

WALL TYPE LEGEND

2. DESIGNATED ACCESSIBLE PARKING FOR THE DWELLING UNIT SHALL BE PROVIDED ON REQUEST OF

3. TYPICAL, OFFSET 2 HR SHAFT WALLS FROM 1 HOUR WALL ALONG CORRIDOR PER DETAIL 23/A-61.22.

2 X 6 WOOD PLATE WITH 2 X 4 WOOD STAGGERED STUD WALL, SEE DETAIL 4/A-61.51

2 X 8 WOOD PLATE WITH 2 X 4 WOOD STAGGERED STUD WALL, SEE DETAIL 4/A-61.51

2 X 10 WOOD PLATE WITH 2 X 4 WOOD STAGGERED STUD WALL (AT CORRIDOR LOCATIONS), SEE DETAIL 4/A-61.51

2 HR WALL - WOOD OR METAL STUD, SEE SHEETS A-61.41 AND A-61.51

SEE RATED WALL DIAGRAMS A1-GEN 11 THRU A1-GEN 16 & A2-GEN 11 THRU A2-GEN 16 FOR RATED

— 2 X 4 OR 3 X 4 WOOD STUD WALL, SEE DETAIL 6/A-61.51 2 X 6 OR 3 X 6 WOOD STUD WALL, SEE DETAIL 3/A-61.51

— 2 X 8 WOOD STUD WALL, SEE DETAIL 6/A-61.51

— 3 5/8" METAL STUD WALL, SEE DETAIL 18/A-61.41

CONCRETE WALL, SEE DETAIL 2/A-61.41 2 HR 8" CMU WALL, SEE DETAIL 4/A-61.41

3 HR FIRE WALL, SEE DETAIL 11/A-61.61

WALL & OCCUPANCY SEPARATION INFORMATION.

S55

DATE

11.04.2016

12.15.2016

BUILDING ENVELOPE / WATERPROOFING

WATERPROOFING REFERENCES NOTED

CONTRACTOR'S CONVENIENCE ONLY. IS THE CONTRACTOR'S RESPONSIBILITY

TO VERIFY ALL BUILDING ENVELOPE / WATERPROOFING CONSULTANT


INFORMATION AND DETAILS WITH THE

BUILDING ENVELOPE / WATERPROOFING

REFERENCE DISCLAIMER:

ON THIS SHEET ARE FOR THE

CONSULTANT'S DRAWINGS.

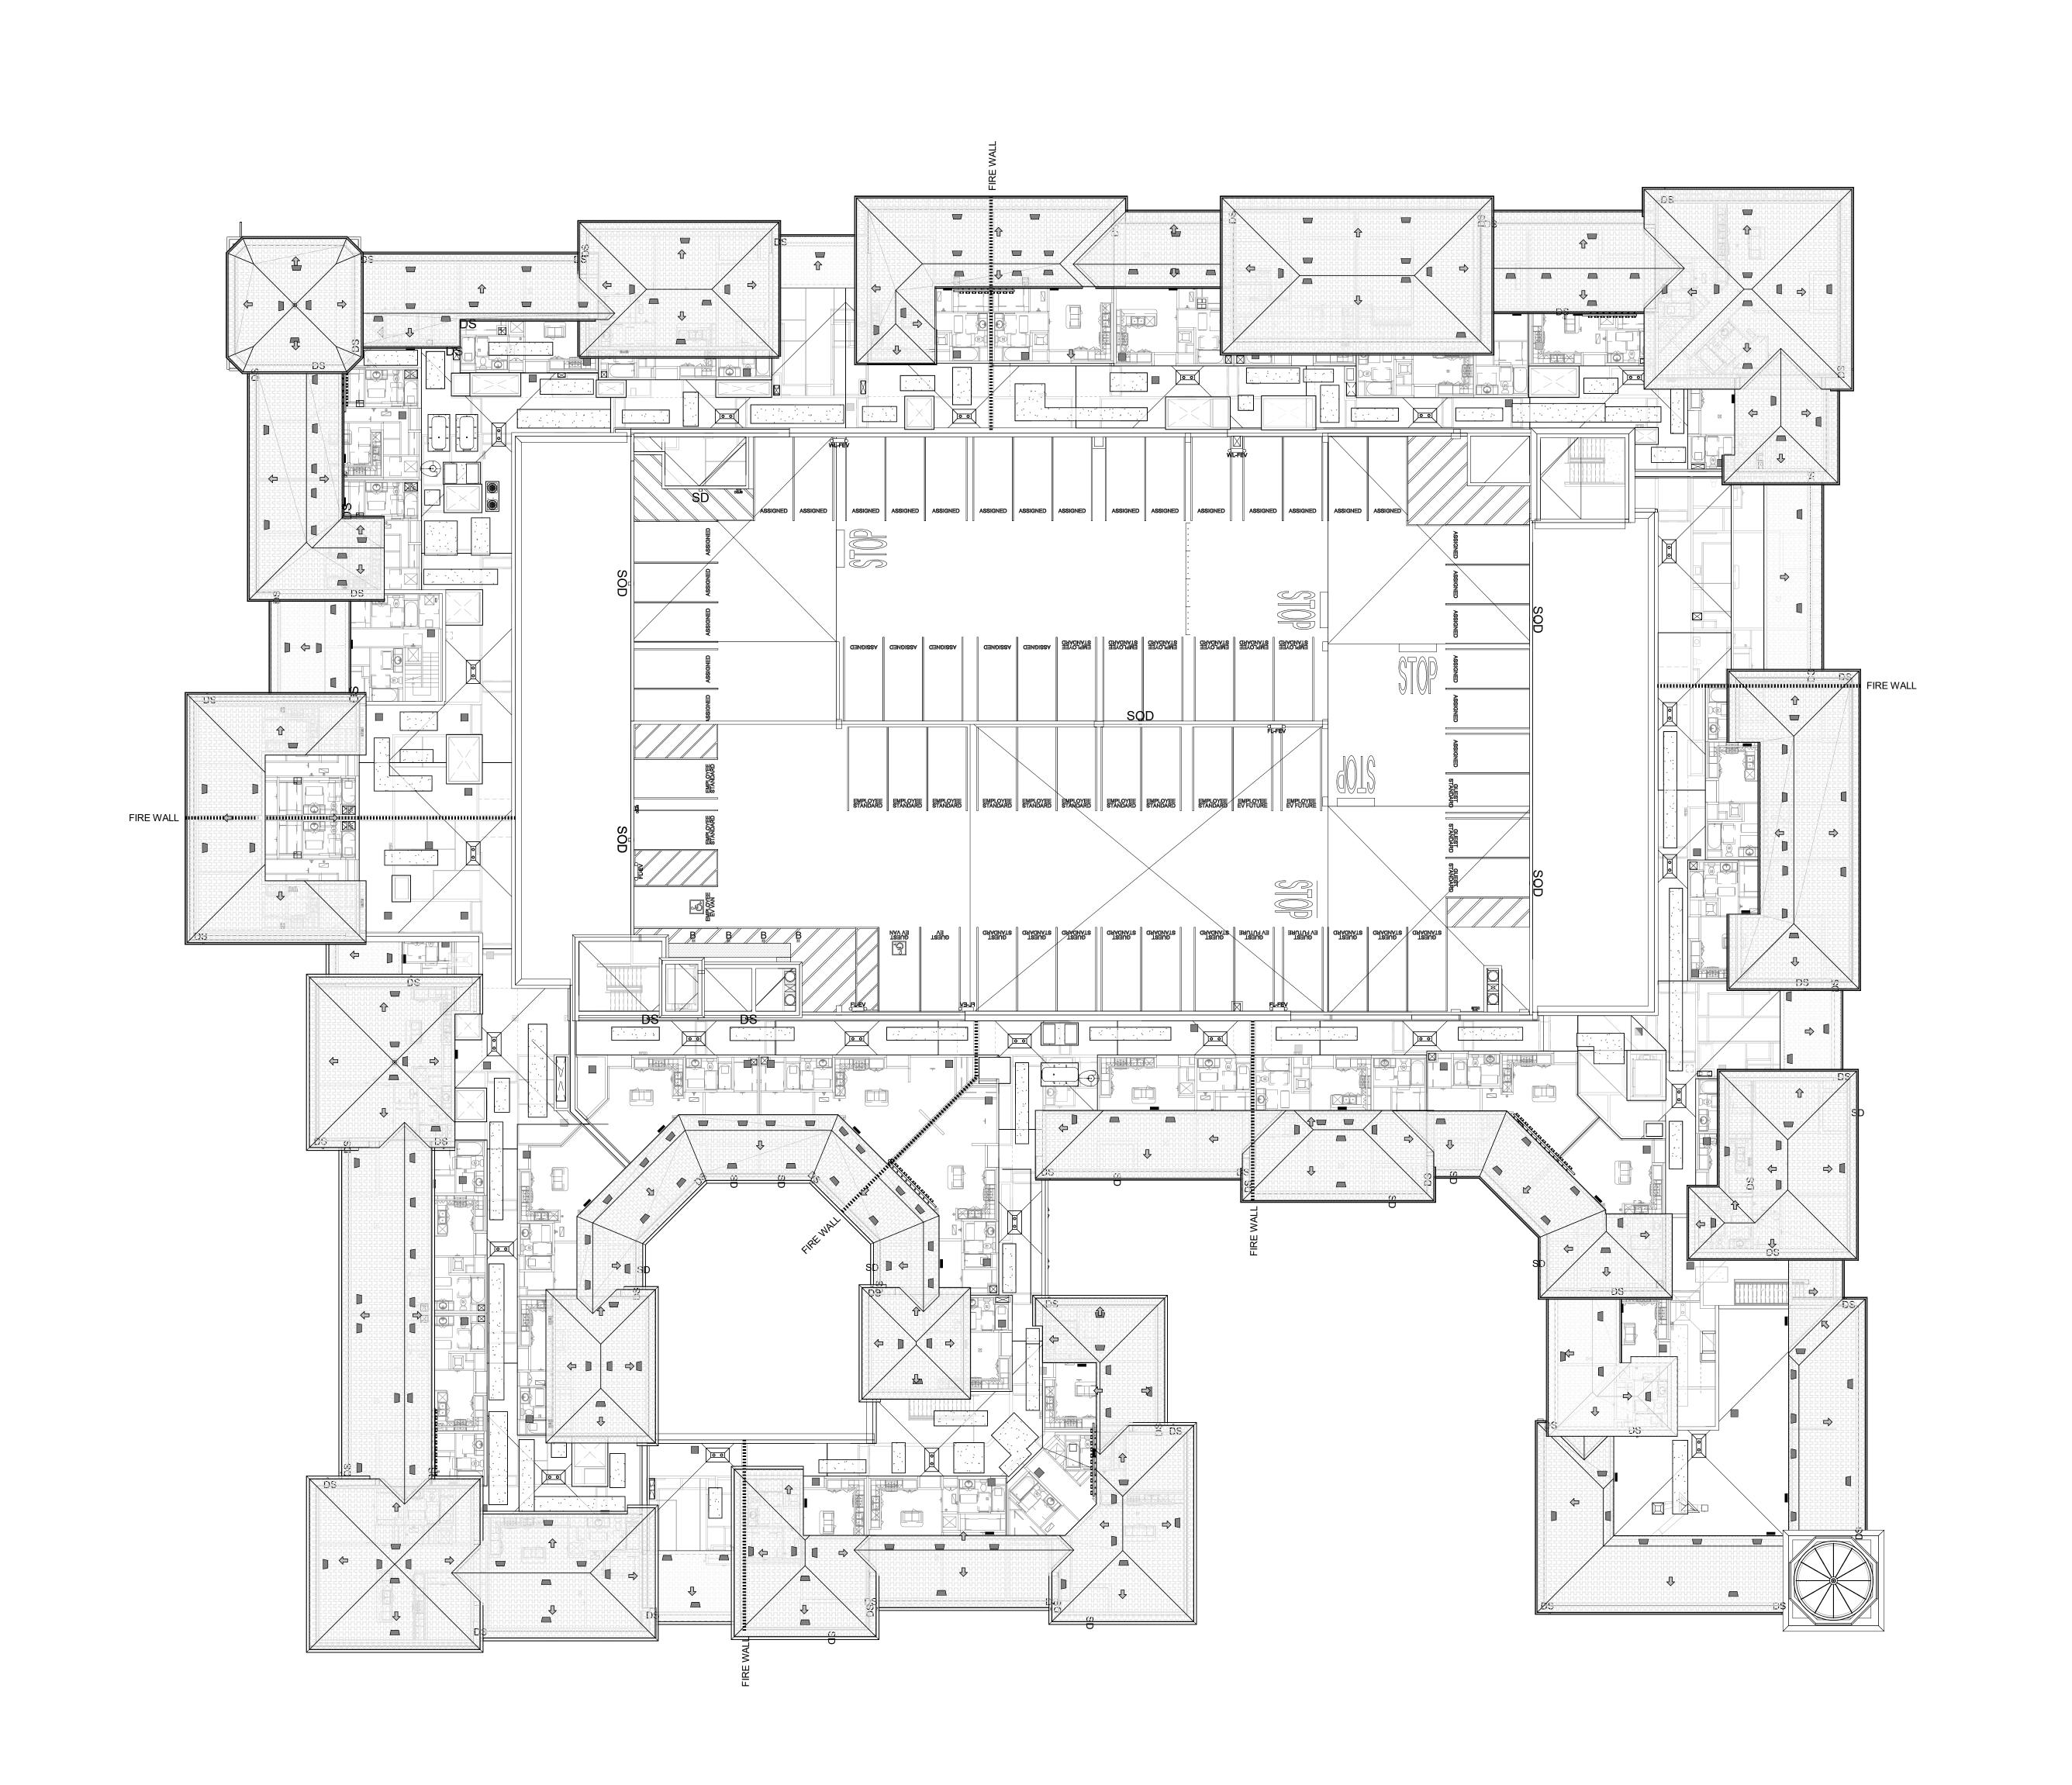

	DESCRIPTION	DATE
1 <u>A</u> A	SS PLAN CHECK #1	06.13.2016
1-1	BULLETIN 1-1	10.11.2016

SHEET TITLE COMPOSITE PLAN **UPPER ROOF** LEVEL **BUILDING 1**

JOB NO. 2013-10130 DATE 09-07-16 SCALE As indicated SHEET NUMBER A1-10.7



1900 Main Street, Suite 800 Irvine, California 92614

SHEET TITLE

SEGMENT 2

BUILDING 1

DESIGNING LIGHT 15231 Laguna Canyon Road, Suite 100 Irvine, California 92618 949.751.5800 - www.studiok1.com Salwa Osman

BUILDING 1 LEVEL 1 LIGHTING PLAN SEGMENT 2 1/8" = 1'-0" 1

minimum.

FIRE PUMP RM.

1-114

ELECT. RM 1-113

MAILROOM

MAIN LOBBY

RETAIL TENANT 1

#1

1-120

—

ELECT. RM 1-123

MAINTENANCE WORKSHOP

RETAIL CORR. 2

RETAIL TRASH RM

G1-112

1-10

PLAN NOTES:

LIGHT FIXTURE MOUNTED IN-GROUND AIMED UP. REFER TO DETAIL AND SHEET NUMBER AS NOTED FOR MOUNTING INFORMATION.

3 STEPLIGHT FIXTURE TYPE S1 MOUNTING HEIGHT TO BE 18-INCHES A.F.F. TO CENTER OF FIXTURE TYPICAL U.0.N.

FIXTURE TYPE Z1 MOUNTED WITHIN TOWER DECORATIVE WINDOW GRILL. SEE DETAIL 3 SHEET LT-00.3.B FOR MOUNTING INFORMATION.

9 FIXTURE TYPE D11 PIER MOUNTED TO FIREPLACE HEARTH. SEE DETAIL 13 SHEET LT-00.3.B FOR MOUNTING INFORMATION.

EXISTING TYPE P1 POLE LIGHT FIXTURE INSTALLED PER PREVIOUS RETAIL PHASE PLANS. PROVIDE TYPE K1 ACCENT LIGHTS WHERE INDICATED ON PLAN.

2 LIGHT FIXTURE MOUNTING HEIGHT PER ELEVATION.

FIXTURE TYPE Z2 MOUNTED TO DECORATIVE FACADE CORNICE. SEE DETAIL 2 SHEET LT-00.3.B FOR MOUNTING INFORMATION.

6 FIXTURE TYPE Z3 MOUNTED TO BASE OF DOME STRUCTURE. SEE DETAIL 5 SHEET LT-00.3.B FOR MOUNTING INFORMATION.

FIXTURE TYPE L7 SUSPENDED FROM CANOPY TREE BRANCHES. SEE DETAIL 11 SHEET LT-00.3.B FOR MOUNTING INFORMATION. FIXTURE TYPE D10 PIER MOUNTED TO PLINTH. SEE DETAIL 12 SHEET LT-00.3.B FOR MOUNTING INFORMATION.

FIXTURE TYPE D7A UNIT ENTRY SCONCE TO BE CENTERED IN WALL BETWEEN DOOR FRAME AND ADJACENT WALL. MOUNTING HEIGHT TO BE PER ARCHITECT'S

12) FIXTURE TYPE K1 MOUNTED TO LIGHT POLE. SEE DETAIL 8 SHEET LT-003.B.

BLDG-1

LEVEL 1 LIGHTING PLAN

SHEET NUMBER	JOB NO.
SHEET NUMBER	2013-10130
	DATE
LT1-13.1.2	02/23/2016
	SCALE
	As indicated

SK1 Job #: 2015-0293

FIXTURE AND THE ENCLOSURE.

LIGHTING PLAN GENERAL NOTES:

LIGHTING DESIGNER'S ATTENTION IMMEDIATELY.

NEUTRAL CONDUCTOR FOR EACH ZONE/CHANNEL.

SITE LIGHTING FIXTURES AND DEVICES.

MOUNTING HARDWARE.

FIXTURES AS REQUIRED.

CONTROL/BALLAST TYPE.

1. REFER TO ARCHITECTURAL PLANS FOR EXACT LOCATION & ELEVATION OF ALL

WHERE THEY ARE PLACED ON THE LIGHTING DESIGN DRAWINGS, PAYING PARTICULAR ATTENTION TO ALIGNMENT WITH CORRIDOR CORNERS, WINDOWS AND OPENINGS, AND CENTERING THE LIGHT FIXTURES LATERALLY WITHIN CORRIDORS. ANY QUESTIONS OR DISCREPANCIES ARE TO BE BROUGHT TO THE

3. VERIFY EXACT CEILING CONSTRUCTION WITH ARCHITECTURAL REFLECTED CEILING PLAN AND PROVIDE LIGHTING FIXTURES WITH ALL NECESSARY

4. ALL RECESSED FIXTURES SHALL BE PROVIDED WITH ALL REQUIRED

THE UNIFORM BUILDING CODE, AS WELL AS ANY LOCAL CODES.

LIGHTING FIXTURES AND ALL DEVICES. ALL WALL-MOUNTED DEVICE HEIGHTS

SHALL BE VERIFIED WITH THE ARCHITECT PRIOR TO ROUGH-IN. IN AREAS WHERE THERE IS NOT A DIMENSIONED ARCHITECTURAL RCP, THE CONTRACTOR IS TO USE THEIR BEST EFFORT TO ALIGN LIGHT FIXTURES AS CLOSELY AS POSSIBLE TO

2. UNLESS OTHERWISE NOTED OR DETAILED IN LIGHTING DESIGN DRAWINGS, REFER TO LANDSCAPE ARCHITECT'S PLANS FOR EXACT LOCATION AND ELEVATION OF ALL

STRUCTURAL SUPPORTS AS REQUIRED BY THE CURRENTLY ADOPTED ISSUE OF


5. ALL COVE MOUNTED FIXTURES SHALL EXTEND THE FULL LENGTH OF THE COVE. CONTRACTOR TO FIELD MEASURE COVE LENGTH AND ORDER QUANTITY OF

6. ALL DIMMING BRANCH CIRCUITS SHALL BE PROVIDED WITH A DEDICATED

7. ALL FLUORESCENT DIMMING ZONES/CHANNELS SHALL BE PROVIDED WITH 3 LINE VOLTAGE CONDUCTORS (NEUTRAL, DIMMED HOT, SWITCHED HOT) OR 2 LINE VOLTAGE CONDUCTORS/2 CONTROL CONDUCTORS AS REQUIRED BY THE

8. RECESSED FIXTURES LOCATED IN A FIRE-RATED CEILING OR WALL SHALL BE

PROVIDED WITH A 5-SIDED RATED ENCLOSURE SO CONSTRUCTED AS TO ALLOW CODE AND MANUFACTURER-REQUIRED CLEARANCES BETWEEN THE

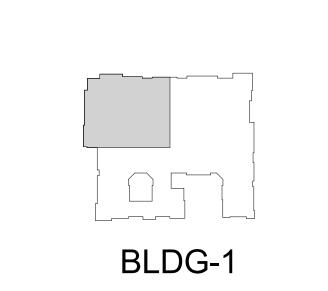

	SIONS DESCRIPTION	DATE
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SHEET TITLE

LEVEL 1 LIGHTING PLAN SEGMENT 3

BUILDING 1

02/23/2016 SCALE As indicated



DESIGNING LIGHT 15231 Laguna Canyon Road, Suite 100 Irvine, California 92618 949.751.5800 - www.studiok1.com

Salwa Osman SK1 Job #: 2015-0293

DEMOLITION PLAN GENERAL NOTES

- SEE SHEET A0.0 FOR SYMBOL LEGEND AND ABBREVIATIONS.
 LIGHTING AT (E) COMMON CORRIDOR TO REMAIN, REFER TO
 KEYNOTES, ALL OTHER LIGHTING WITHIN AREA OF WORK TO BE
 REMOVED. PULL ABANDONDED WIRING BACK TO SOURCE.
 PARTITIONS MODIFIED AS PART OF "SCOPE OF WORK" TO BE
 PATCHED AND FINISHED TO 'LIKE NEW' CONDITION, LEVEL 4
- ALL REQUIRED RATED ASSEMBLIES ARE TO REMAIN. PATCH AND REPAIR DAMAGE TO ENSURE RATING IS MAINTAINED.

DEMOLITION KEYNOTES

- G.C. TO REMOVE & SAVE EXISTING REAR ENTRY DOOR. PATCH & REPAIR WALL AS NEW
- 2 EXISTING SLAB +/-5" BELOW GRADE. G.C. TO INSTALL:
- -5" CONCRETE SLAB W/ #4 @ 16" O.C. EACH WAY, CENTERED -10 MIL. THICK VAPOR RETARDER PER SOILS REPORT -4" MIN. OF $\frac{3}{4}$ " CLEAN, CRUSHED, UNIFORMLY GRADED GRAVEL PROPERLY PREPARED SOIL SUBGRADE- PER SOIL REPORT
- G.C. TO REMOVE EXISTING STOREFRONT DOORS AND SIDE GLAZING SYSTEM
- G.C. TO RELOCATE BACK ENTRY DOOR. REPLACE HARDWARE AS REQUIRED TO MAKE NEW
- GC TO REMOVE EXISTING FULL HEIGHT G.W.B. DEMISING WALL. PATCH & REPAIR AS REQUIRED
- GC TO PROVIDE ACCESS TO LANDLORD PROVIDED FIRE RATED SHAFT FOR DUCTING. REFERENCE MEP DRAWINGS
- 7 SEE A.D.A. THRESHOLD DETAIL ON SHEET A0.2

CONSTRUCTION PLAN LEGEND

AREA NOT IN CONTRACT.

(E) 1-HR WALL TO REMAIN

AREA OF WORK.
REFER TO ENLARGED
PLAN 1/A1.0

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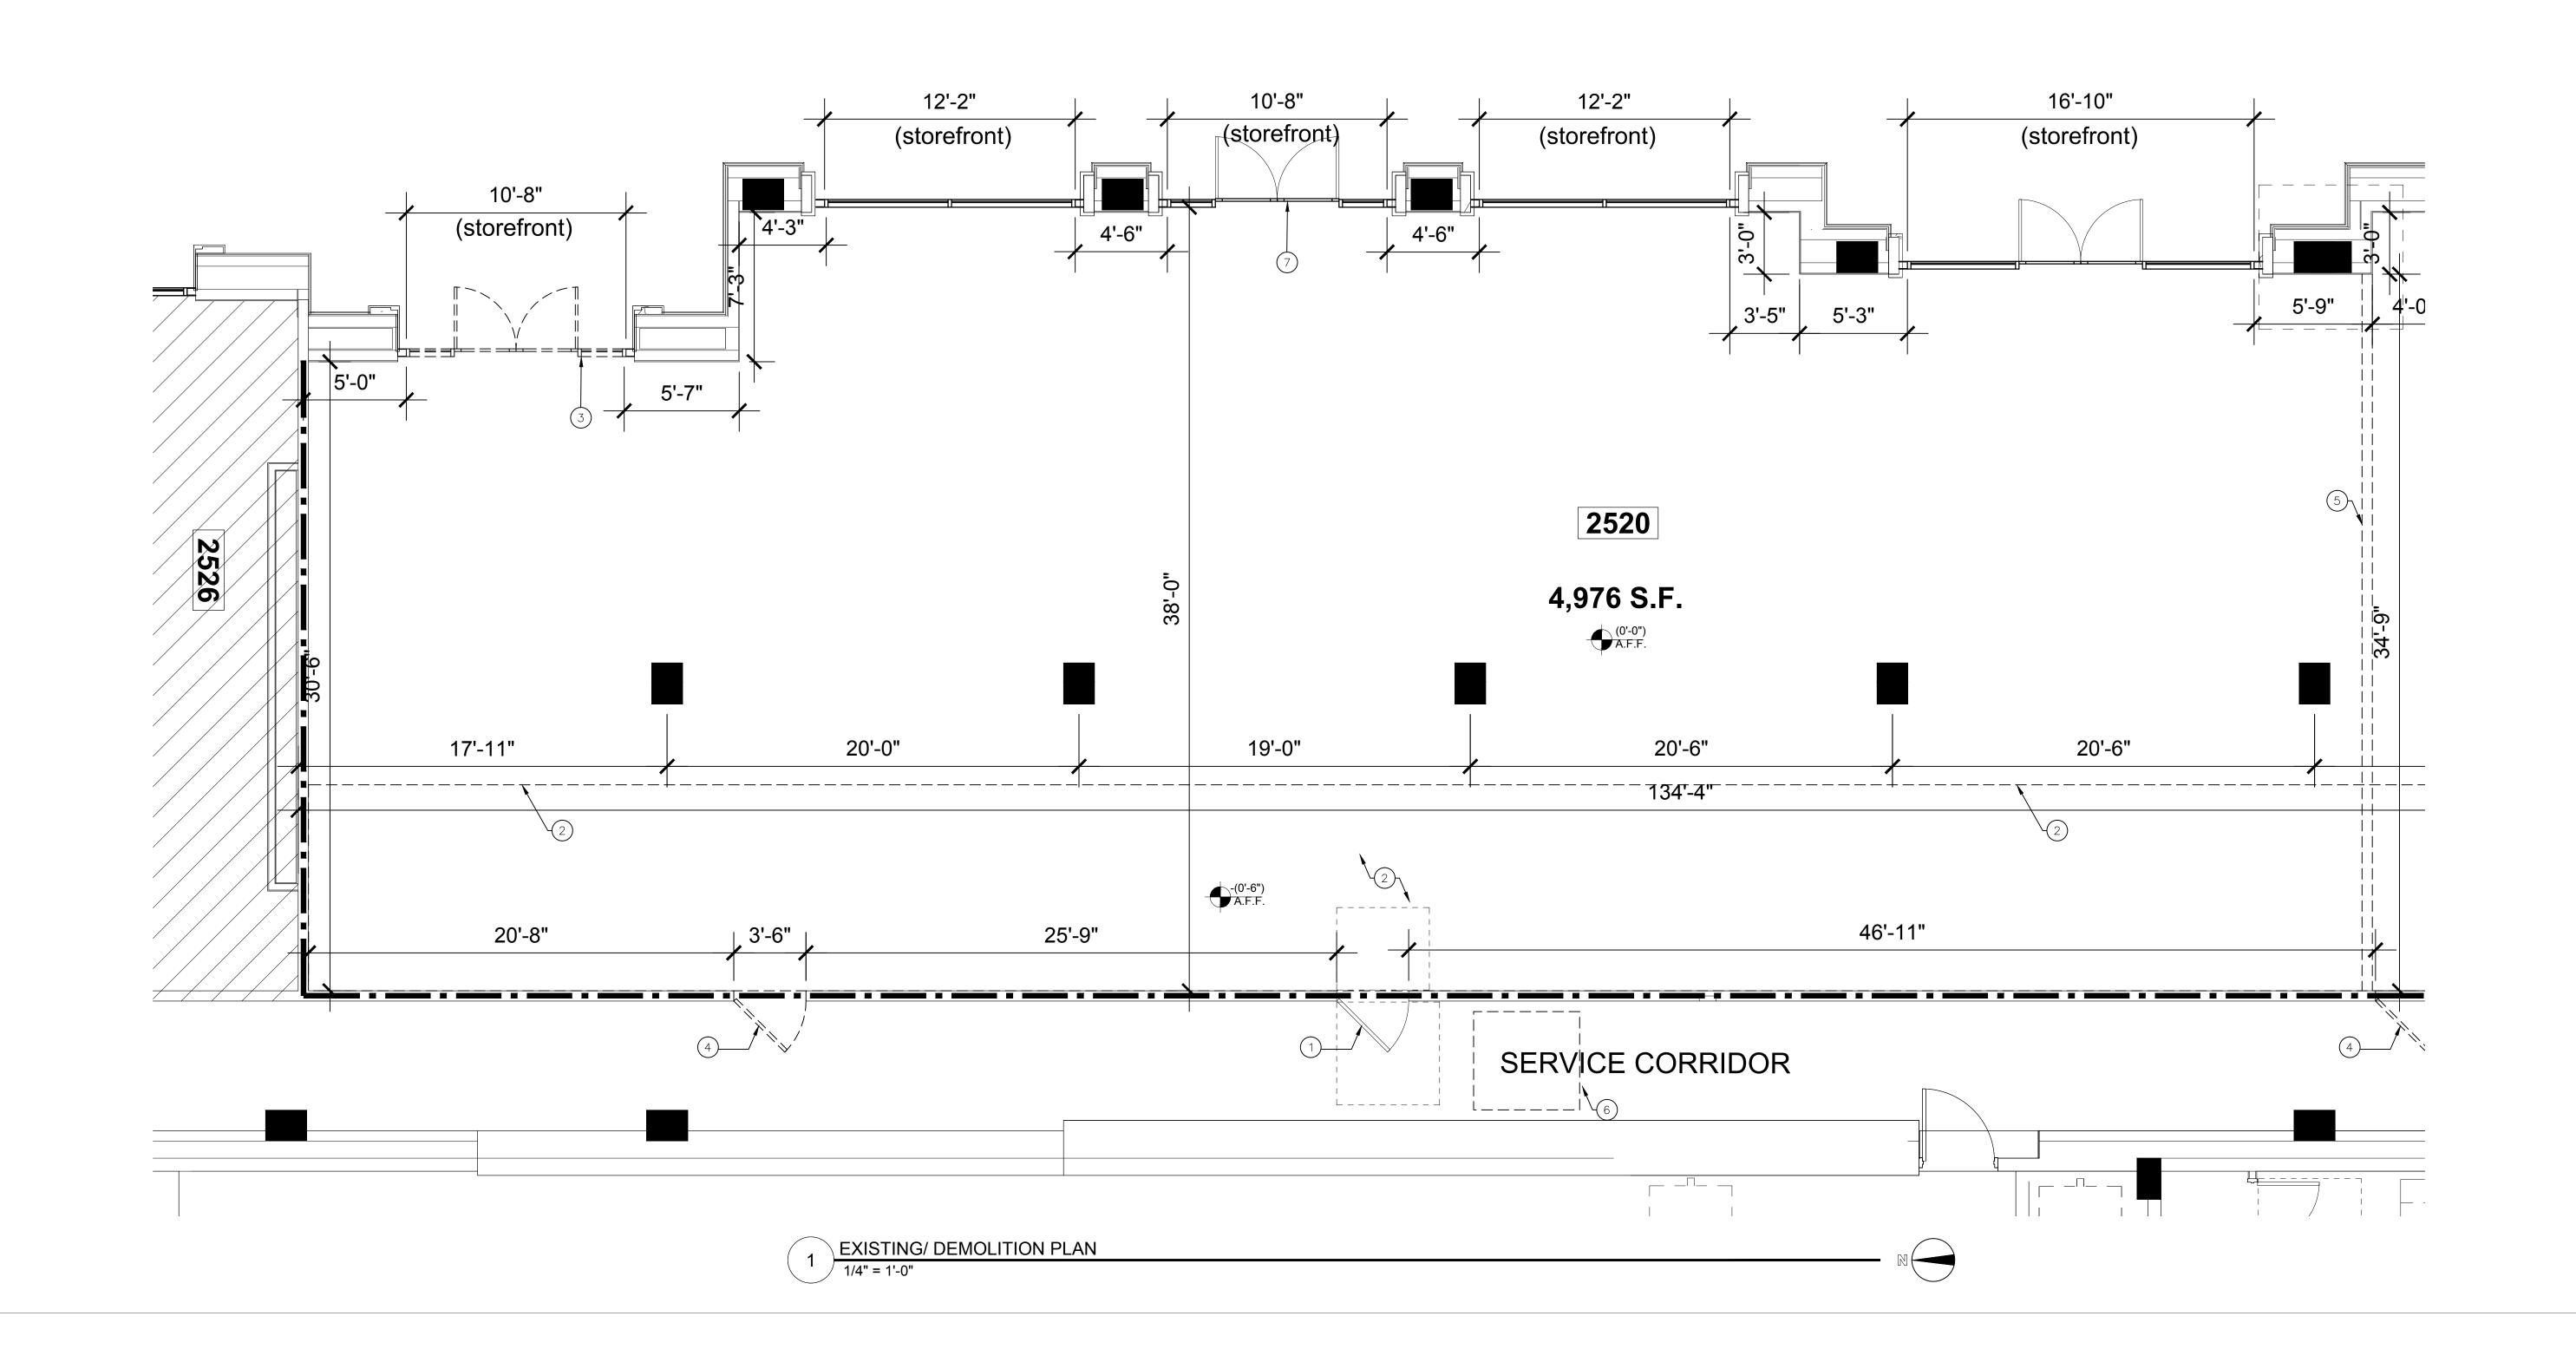
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2 DEMOLITON KEY PLAN



BAREBOTTLE BREW COMPANY
SANTA CLARA SQUARE
BUILDING ONE
2520 AUGUSTINE SQUARE
SANTA CLARA, CA 95054

NTA CLARA SQUARE - BUILDINGONE 2520 AUGUSTINE DRIVE

SUBMITTAL/REVISIONS

LANDLORD/PERMIT 12/2

SUBMITTAL SET

EXISTING FLOOR PLAN DEMOLITION PLAN SHEET 1

DEMOLITION PLAN GENERAL NOTES

- SEE SHEET A0.0 FOR SYMBOL LEGEND AND ABBREVIATIONS. LIGHTING AT (E) COMMON CORRIDOR TO REMAIN, REFER TO KEYNOTES, ALL OTHER LIGHTING WITHIN AREA OF WORK TO BE REMOVED. PULL ABANDONDED WIRING BACK TO SOURCE. PARTITIONS MODIFIED AS PART OF "SCOPE OF WORK" TO BE PATCHED AND FINISHED TO 'LIKE NEW' CONDITION, LEVEL 4
- ALL REQUIRED RATED ASSEMBLIES ARE TO REMAIN. PATCH AND REPAIR DAMAGE TO ENSURE RATING IS MAINTAINED.

DEMOLITION KEYNOTES

- G.C. TO REMOVE & SAVE EXISTING REAR ENTRY DOOR. PATCH & REPAIR WALL AS NEW
- 2 EXISTING SLAB +/-5" BELOW GRADE. G.C. TO INSTALL:
- -5" CONCRETE SLAB W/ #4 @ 16" O.C. EACH WAY, CENTERED -10 MIL. THICK VAPOR RETARDER PER SOILS REPORT -4" MIN. OF $\frac{3}{4}$ " CLEAN, CRUSHED, UNIFORMLY GRADED GRAVEL - PROPERLY PREPARED SOIL SUBGRADE- PER SOIL REPORT
- G.C. TO REMOVE EXISTING STOREFRONT DOORS AND SIDE GLAZING SYSTEM
- G.C. TO RELOCATE BACK ENTRY DOOR. REPLACE HARDWARE AS REQUIRED TO MAKE NEW
- (5) GC TO REMOVE EXISTING FULL HEIGHT G.W.B. DEMISING WALL. PATCH & REPAIR AS REQUIRED
- GC TO PROVIDE ACCESS TO LANDLORD PROVIDED FIRE RATED SHAFT FOR DUCTING. REFERENCE MEP DRAWINGS
- 7) SEE A.D.A. THRESHOLD DETAIL ON SHEET A0.2


CONSTRUCTION PLAN LEGEND

AREA NOT IN CONTRACT.


(E) 1-HR WALL TO REMAIN

AREA OF WORK.
REFER TO ENLARGED PLAN 1/A1.1 SERVICE CORRIDOR

DEMOLITON KEY PLAN

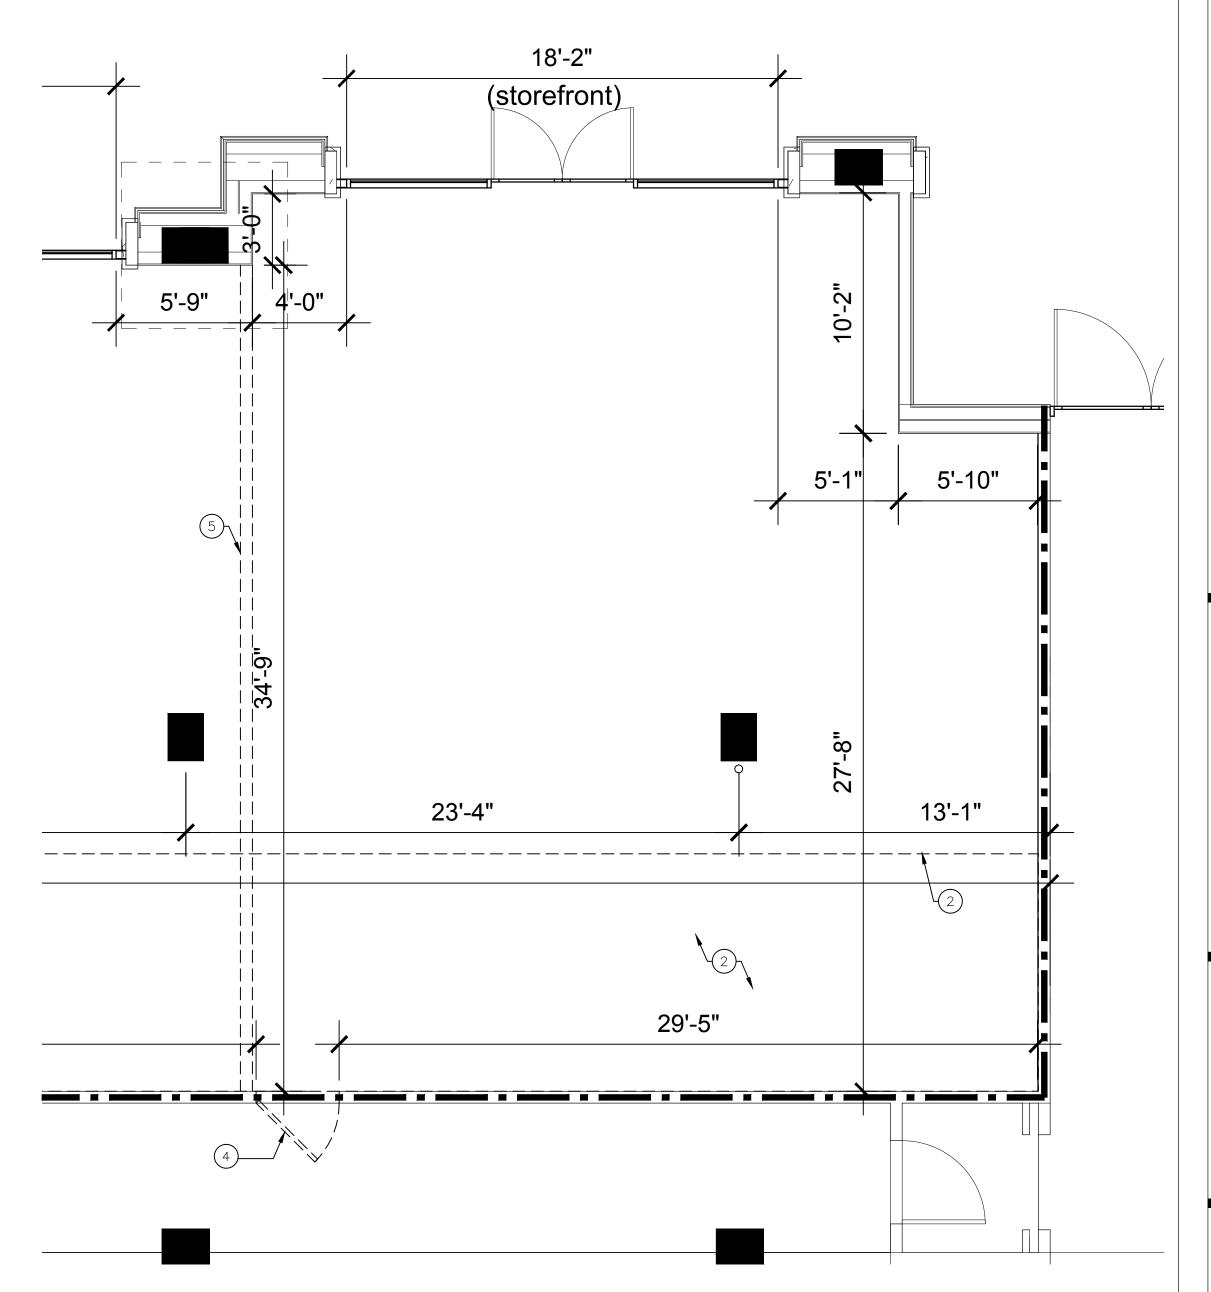


EXISTING/ DEMOLITION PLAN

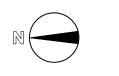

BAREBOTTLE BREW COMPANY SANTA CLARA SQUARE BUILDING ONE 2520 AUGUSTINE SQUARE SANTA CLARA, CA 95054

SUBMITTAL/REVISIONS LANDLORD/PERMIT SUBMITTAL SET

EXISTING FLOOR PLAN DEMOLITION PLAN SHEET 2

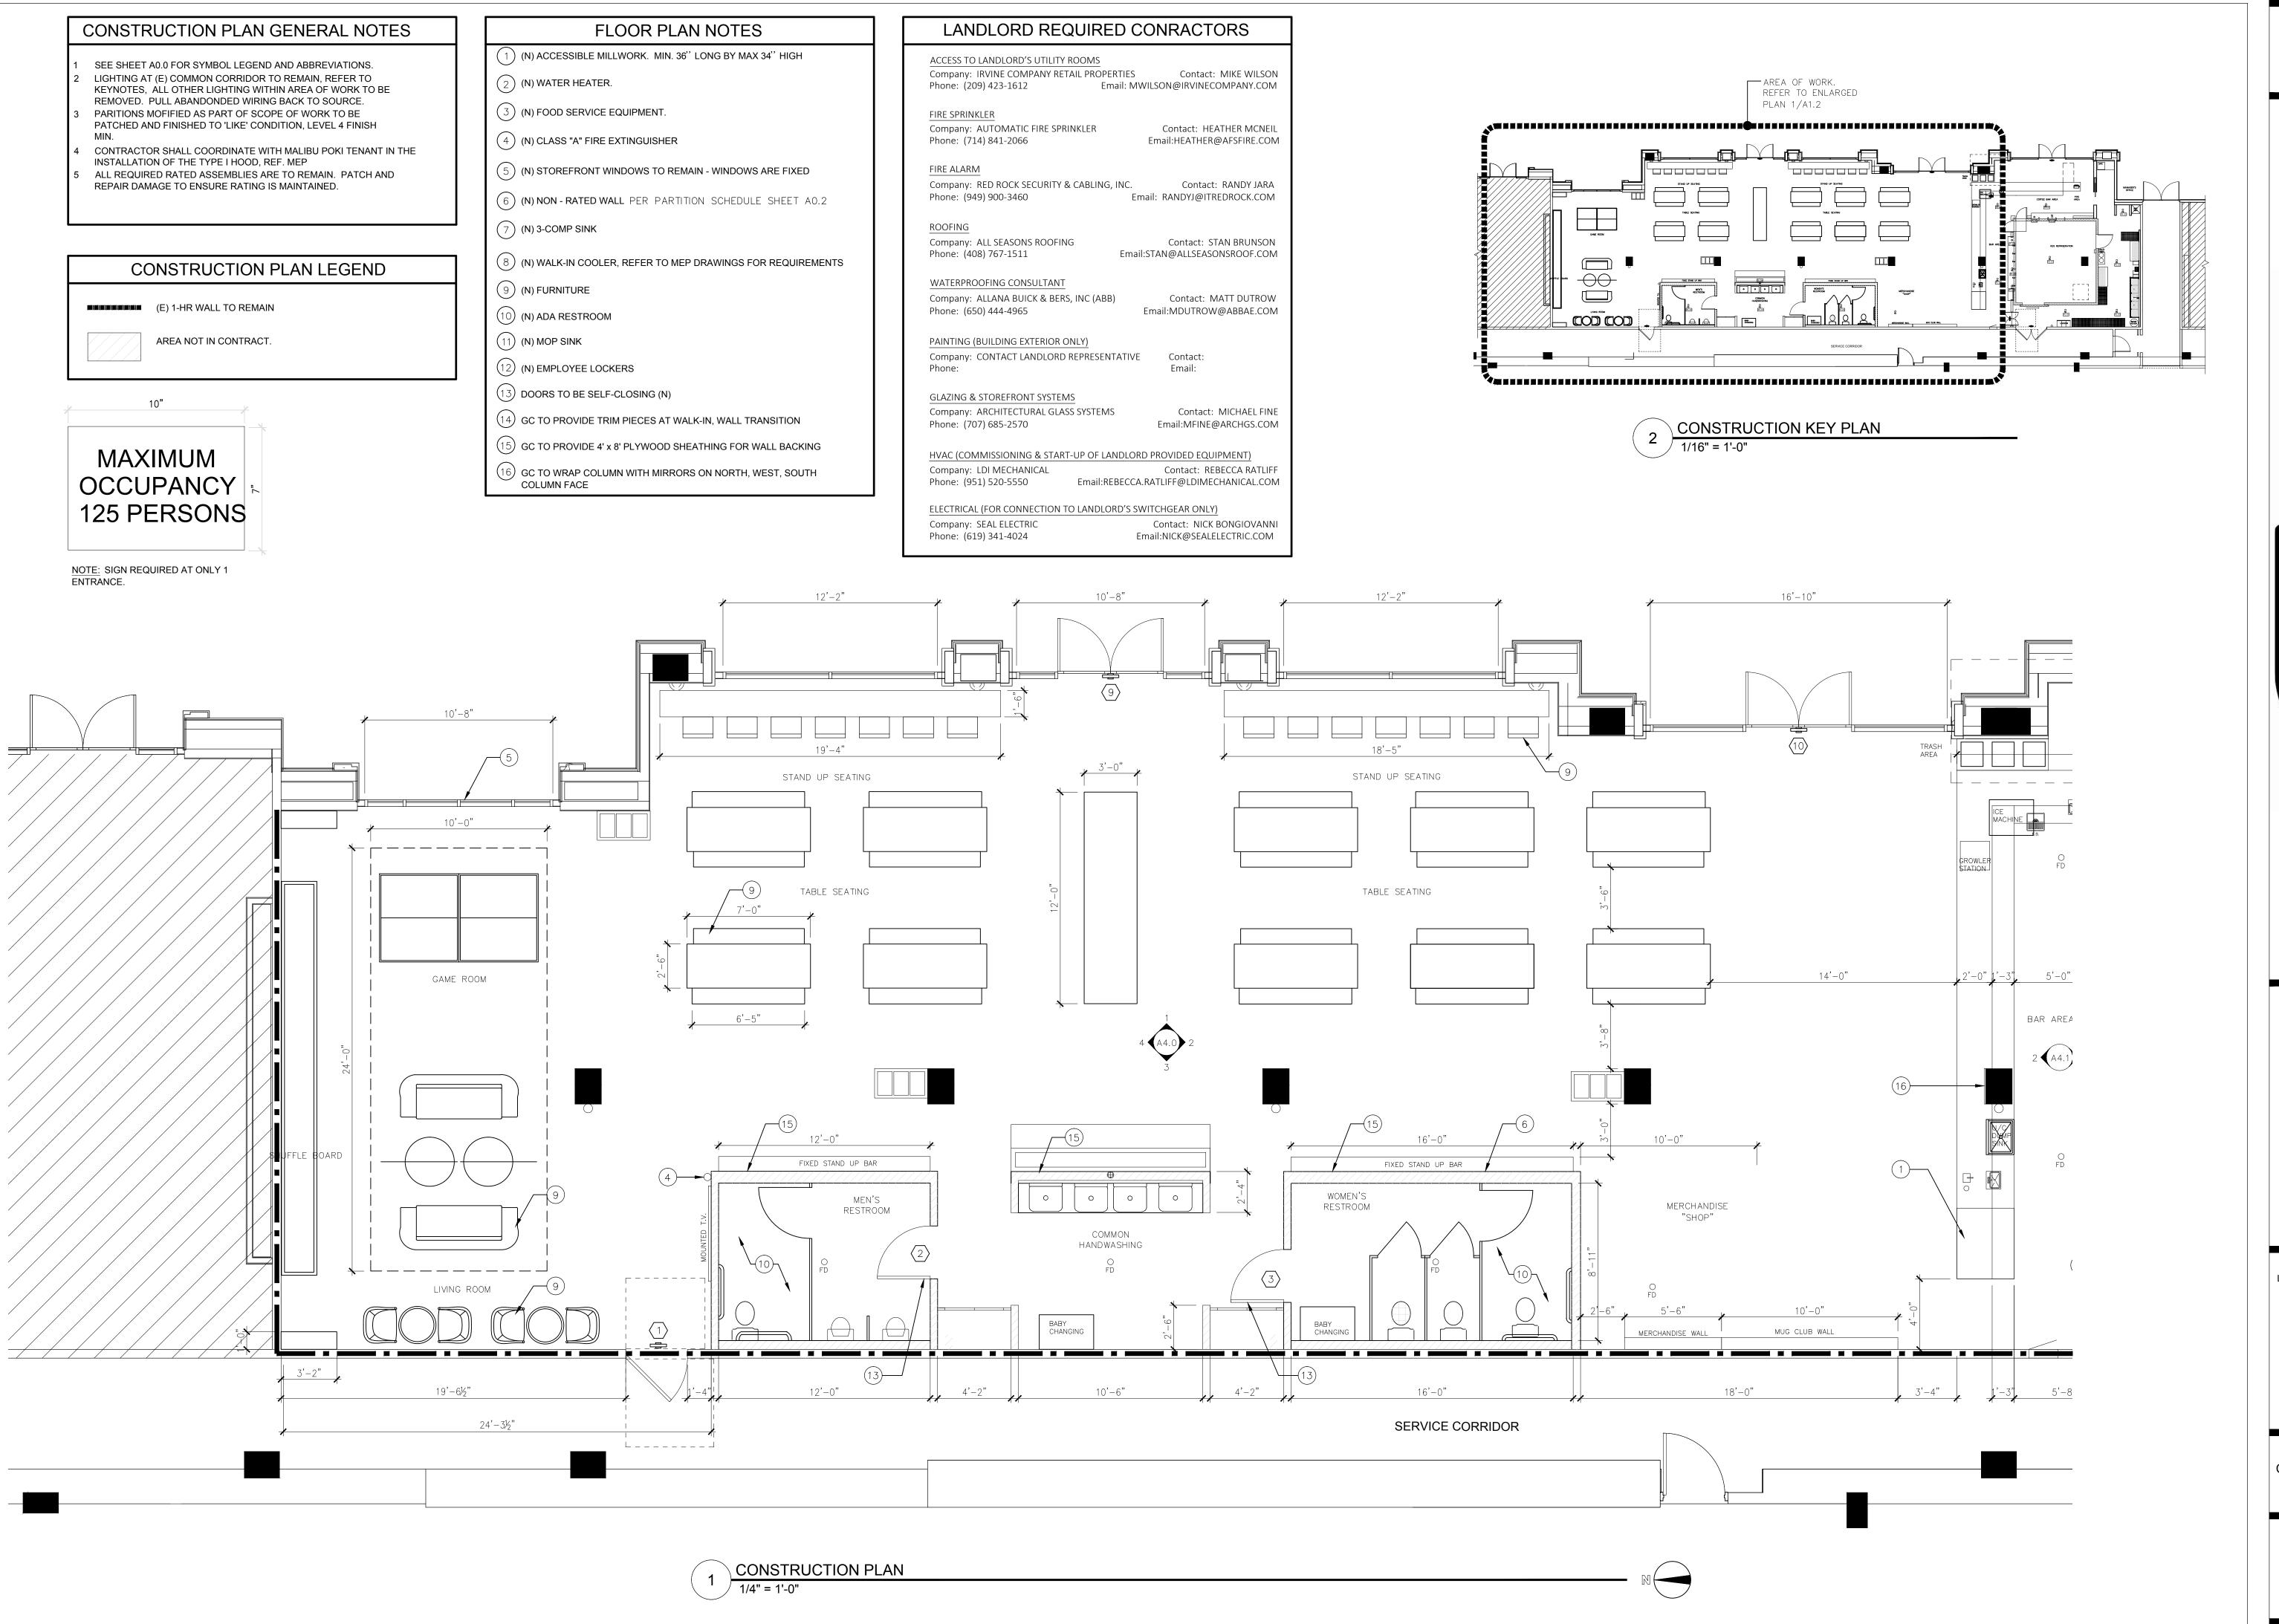

BAREBOTTLE BREW COMPANY SANTA CLARA SQUARE BUILDING ONE 2520 AUGUSTINE SQUARE

SANTA CLARA, CA 95054

SUBMITTAL/REVISIONS LANDLORD/PERMIT SUBMITTAL SET

CONSTRUCTION FLOOR PLAN SHEET 1

CONSTRUCTION PLAN GENERAL NOTES

- SEE SHEET A0.0 FOR SYMBOL LEGEND AND ABBREVIATIONS. LIGHTING AT (E) COMMON CORRIDOR TO REMAIN, REFER TO KEYNOTES, ALL OTHER LIGHTING WITHIN AREA OF WORK TO BE REMOVED. PULL ABANDONDED WIRING BACK TO SOURCE.
- PARITIONS MOFIFIED AS PART OF SCOPE OF WORK TO BE PATCHED AND FINISHED TO 'LIKE' CONDITION, LEVEL 4 FINISH
- CONTRACTOR SHALL COORDINATE WITH MALIBU POKI TENANT IN THE INSTALLATION OF THE TYPE I HOOD, REF. MEP
- ALL REQUIRED RATED ASSEMBLIES ARE TO REMAIN. PATCH AND REPAIR DAMAGE TO ENSURE RATING IS MAINTAINED.

CONSTRUCTION PLAN LEGEND

(E) 1-HR WALL TO REMAIN

AREA NOT IN CONTRACT.

MAXIMUM OCCUPANCY 5 125 PERSONS

NOTE: SIGN REQUIRED AT ONLY 1 ENTRANCE.

FLOOR PLAN NOTES

- (1) (N) ACCESSIBLE MILLWORK. MIN. 36" LONG BY MAX 34" HIGH
- (2) (N) WATER HEATER.
- (3) (N) FOOD SERVICE EQUIPMENT.
- (4) (N) CLASS "A" FIRE EXTINGUISHER
- (5) (N) STOREFRONT WINDOWS TO REMAIN WINDOWS ARE FIXED
- (6) (N) NON RATED WALL PER PARTITION SCHEDULE SHEET A0.2
- (7) (N) 3-COMP SINK
- (8) (N) WALK-IN COOLER, REFER TO MEP DRAWINGS FOR REQUIREMENTS
- 9 (N) FURNITURE
- (N) ADA RESTROOM
- (11) (N) MOP SINK
- (12) (N) EMPLOYEE LOCKERS (13) DOORS TO BE SELF-CLOSING (N)
- (14) GC TO PROVIDE TRIM PIECES AT WALK-IN, WALL TRANSITION
- (15) GC TO PROVIDE 4' x 8' PLYWOOD SHEATHING FOR WALL BACKING
- (16) GC TO WRAP COLUMN WITH MIRRORS ON NORTH, WEST, SOUTH **COLUMN FACE**

LANDLORD REQUIRED CONRACTORS

ACCESS TO LANDLORD'S UTILITY ROOMS

Company: IRVINE COMPANY RETAIL PROPERTIES Contact: MIKE WILSON Email: MWILSON@IRVINECOMPANY.COM Phone: (209) 423-1612

FIRE SPRINKLER

Company: AUTOMATIC FIRE SPRINKLER Contact: HEATHER MCNEIL Phone: (714) 841-2066 Email:HEATHER@AFSFIRE.COM

FIRE ALARM

Company: RED ROCK SECURITY & CABLING, INC. Contact: RANDY JARA Email: RANDYJ@ITREDROCK.COM Phone: (949) 900-3460

Company: ALL SEASONS ROOFING Contact: STAN BRUNSON Phone: (408) 767-1511 Email:STAN@ALLSEASONSROOF.COM

WATERPROOFING CONSULTANT

Company: ALLANA BUICK & BERS, INC (ABB) Contact: MATT DUTROW Phone: (650) 444-4965 Email:MDUTROW@ABBAE.COM

PAINTING (BUILDING EXTERIOR ONLY)

Company: CONTACT LANDLORD REPRESENTATIVE Contact:

GLAZING & STOREFRONT SYSTEMS


Company: ARCHITECTURAL GLASS SYSTEMS Contact: MICHAEL FINE Phone: (707) 685-2570 Email:MFINE@ARCHGS.COM

HVAC (COMMISSIONING & START-UP OF LANDLORD PROVIDED EQUIPMENT) Company: LDI MECHANICAL Contact: REBECCA RATLIFF


Phone: (951) 520-5550 Email:REBECCA.RATLIFF@LDIMECHANICAL.COM

ELECTRICAL (FOR CONNECTION TO LANDLORD'S SWITCHGEAR ONLY)

Contact: NICK BONGIOVANNI Company: SEAL ELECTRIC Email:NICK@SEALELECTRIC.COM Phone: (619) 341-4024

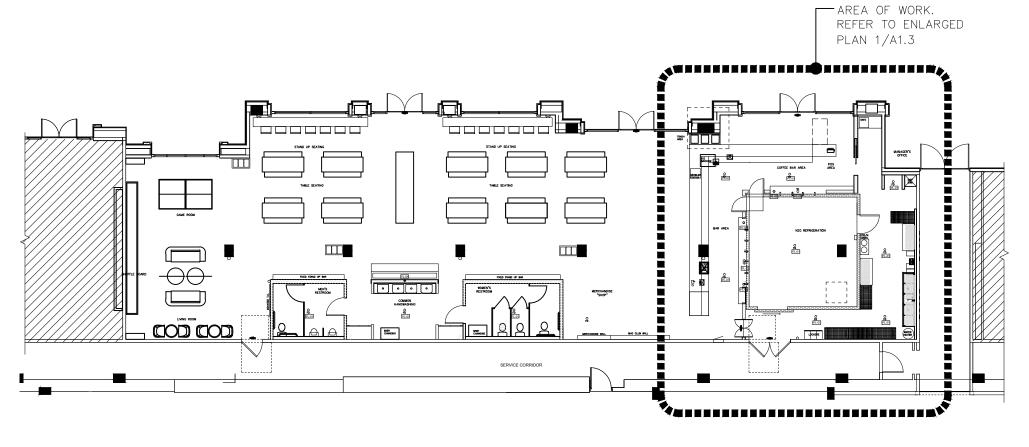

CONSTRUCTION KEY PLAN

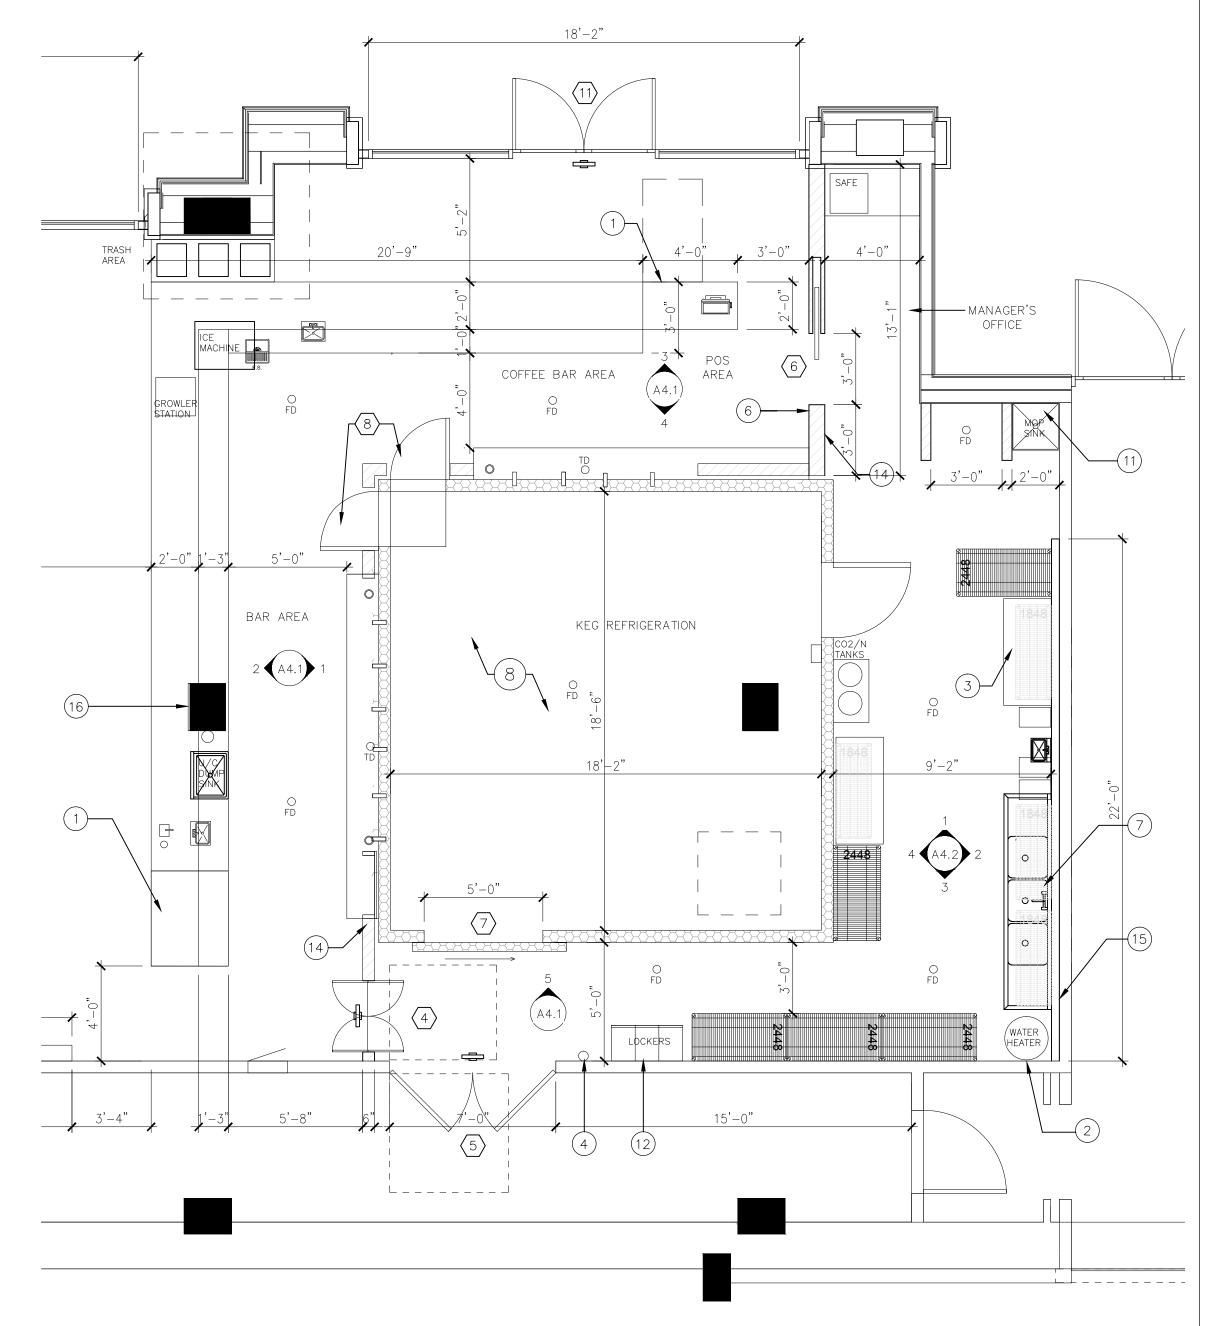


BAREBOTTLE BREW COMPANY SANTA CLARA SQUARE BUILDING ONE 2520 AUGUSTINE SQUARE SANTA CLARA, CA 95054

SUBMITTAL/REVISIONS LANDLORD/PERMIT SUBMITTAL SET 12/21/18

CONSTRUCTION FLOOR PLAN SHEET 2

SHEET NUMBER

CONSTRUCTION PLAN

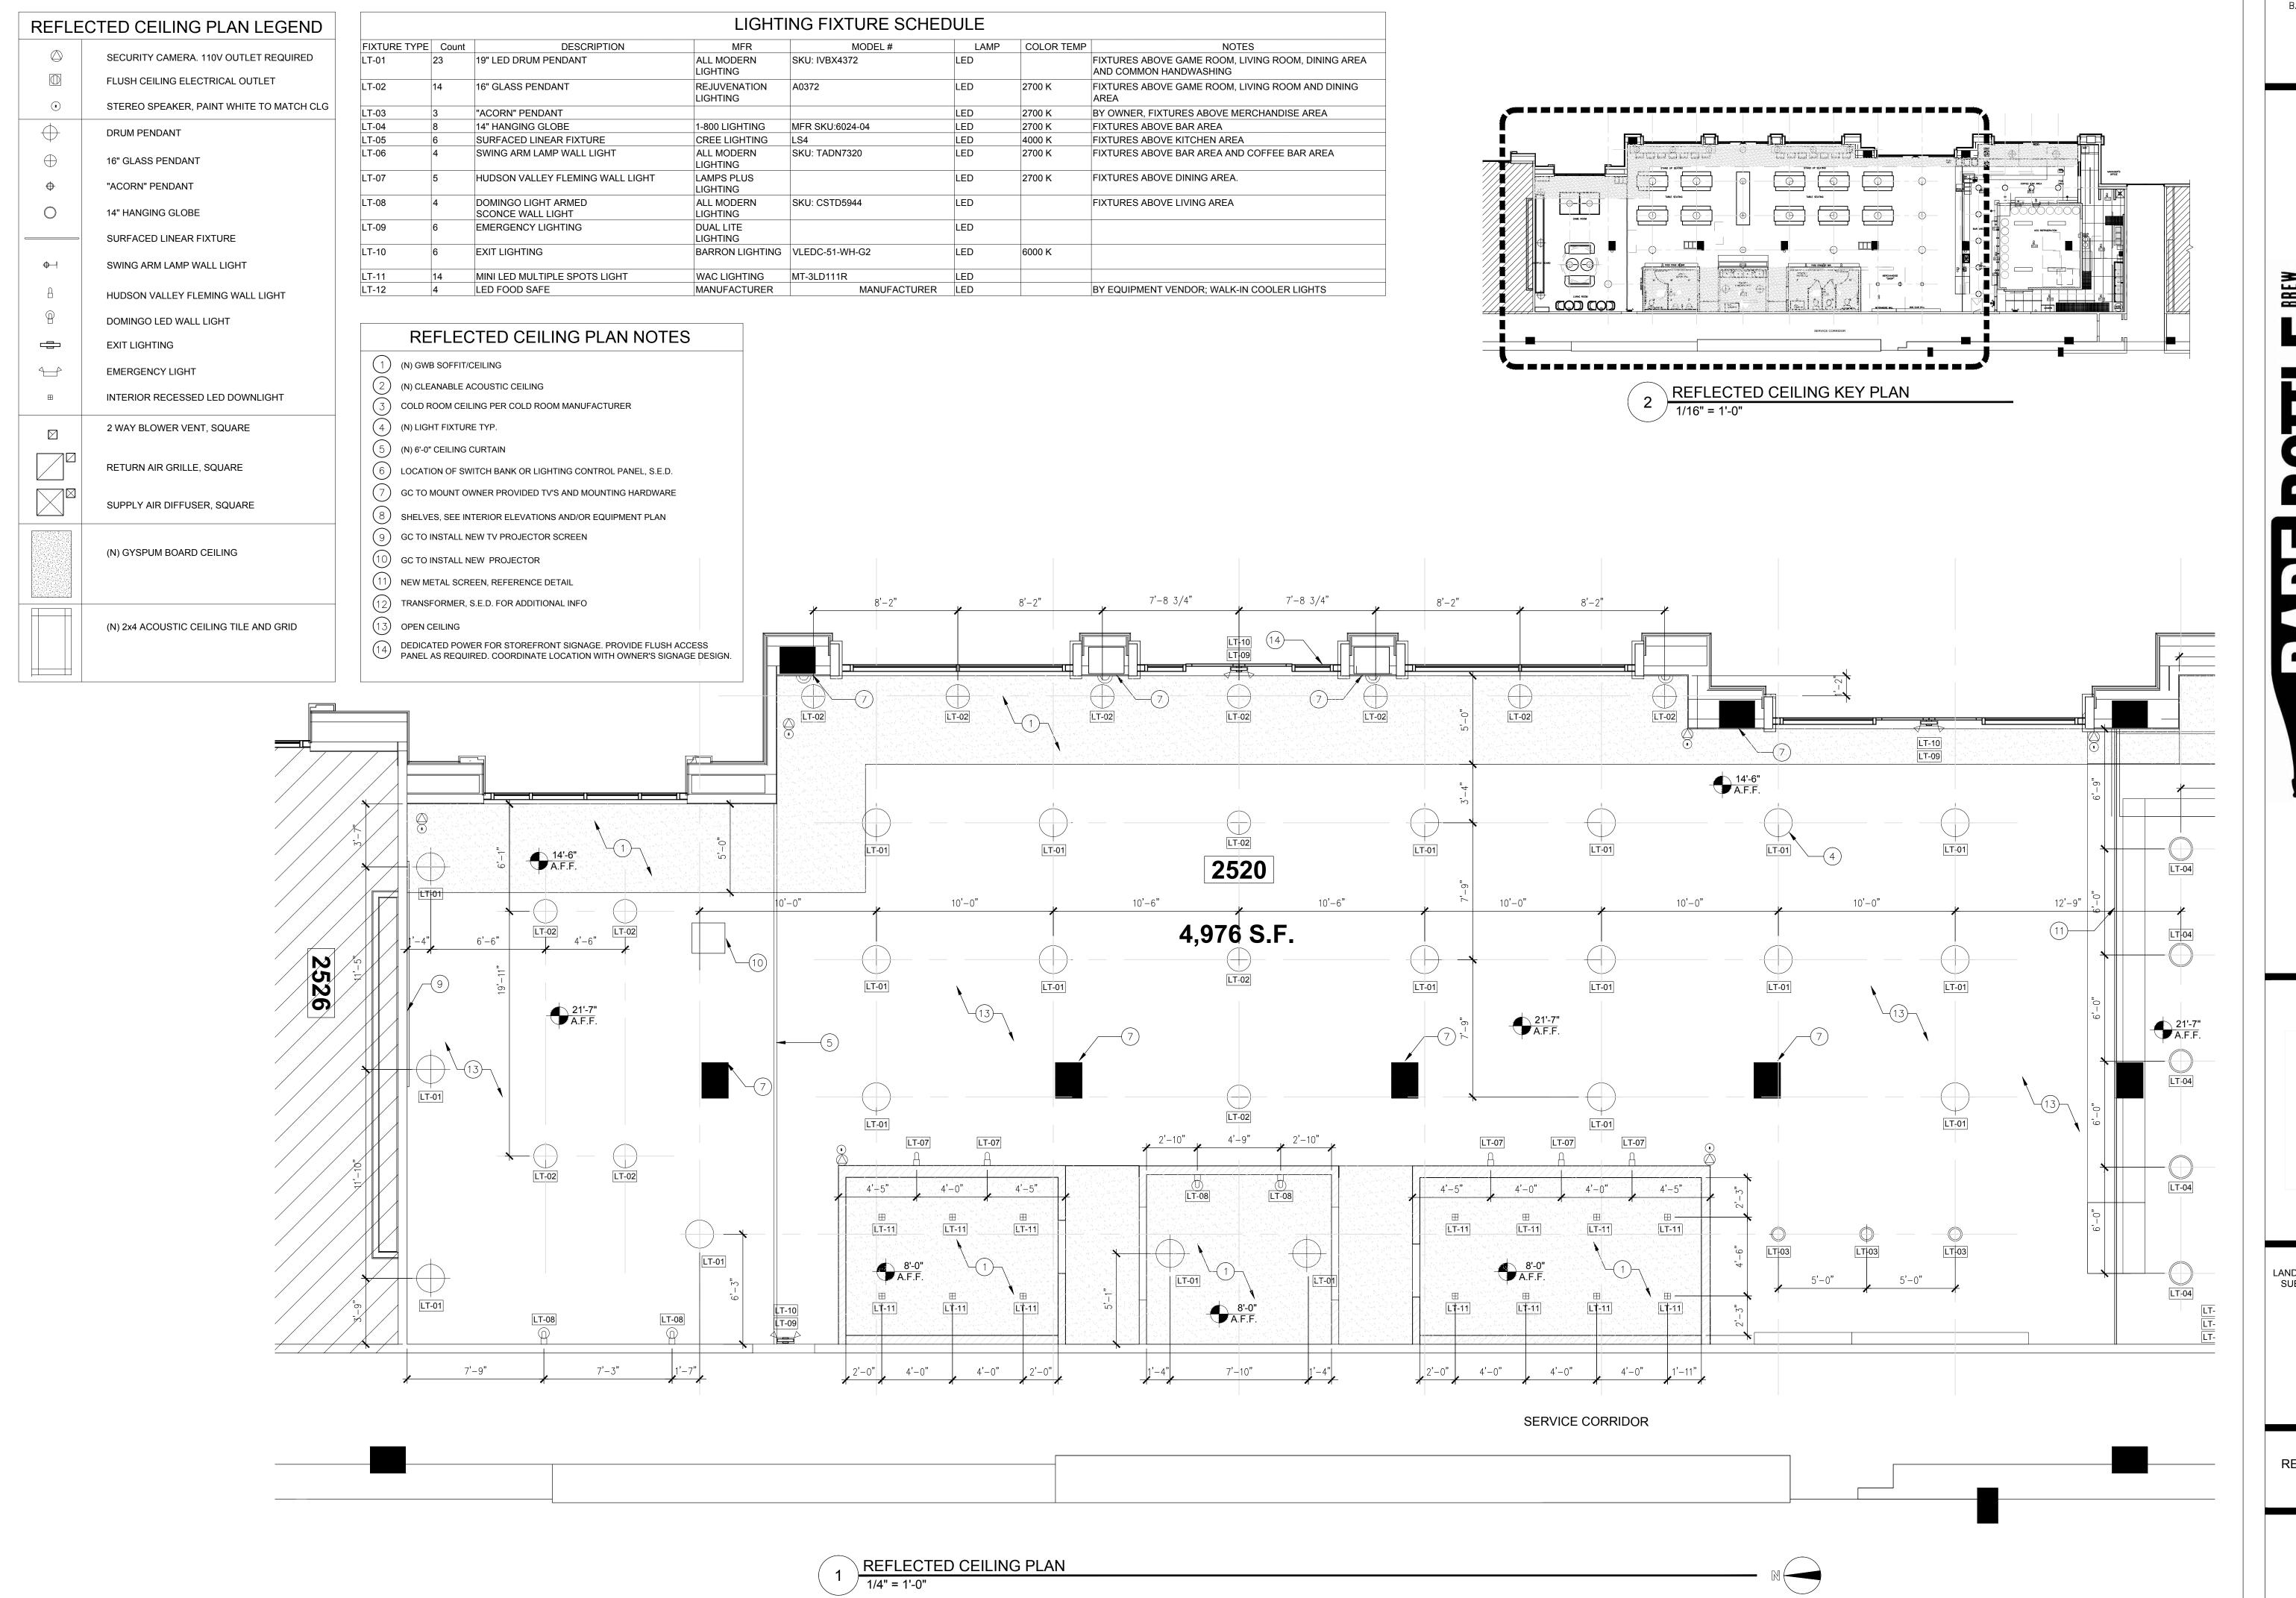

BAREBOTTLE BREW COMPANY SANTA CLARA SQUARE BUILDING ONE 2520 AUGUSTINE SQUARE

SANTA CLARA, CA 95054


SUBMITTAL/REVISIONS LANDLORD/PERMIT SUBMITTAL SET 12/21/18


REFLECTED CEILING PLAN SHEET 1

REFLE	ECTED CEILING PLAN LEGEND
	SECURITY CAMERA. 110V OUTLET REQUIRED
	FLUSH CEILING ELECTRICAL OUTLET
\$	STEREO SPEAKER, PAINT WHITE TO MATCH CLG
\bigoplus	DRUM PENDANT
\oplus	16" GLASS PENDANT
•	"ACORN" PENDANT
	14" HANGING GLOBE
	SURFACED LINEAR FIXTURE
• -	SWING ARM LAMP WALL LIGHT
А	HUDSON VALLEY FLEMING WALL LIGHT
9	DOMINGO LED WALL LIGHT
	EXIT LIGHTING
	EMERGENCY LIGHT
⊞	INTERIOR RECESSED LED DOWNLIGHT
	2 WAY BLOWER VENT, SQUARE
	RETURN AIR GRILLE, SQUARE
	SUPPLY AIR DIFFUSER, SQUARE
	(N) GYSPUM BOARD CEILING
	(N) 2x4 ACOUSTIC CEILING TILE AND GRID

			LIGHTI	NG FIXTURE SCHED) E		
FIXTURE 1	TYPE Count	DESCRIPTION	MFR	MODEL#	LAMP	COLOR TEMP	NOTES
LT-01	23	19" LED DRUM PENDANT	ALL MODERN LIGHTING	SKU: IVBX4372	LED		FIXTURES ABOVE GAME ROOM, LIVING ROOM, DINING AREA AND COMMON HANDWASHING
LT-02	14	16" GLASS PENDANT	REJUVENATION LIGHTING	A0372	LED	2700 K	FIXTURES ABOVE GAME ROOM, LIVING ROOM AND DINING AREA
LT-03	3	"ACORN" PENDANT			LED	2700 K	BY OWNER, FIXTURES ABOVE MERCHANDISE AREA
LT-04	8	14" HANGING GLOBE	1-800 LIGHTING	MFR SKU:6024-04	LED	2700 K	FIXTURES ABOVE BAR AREA
LT-05	6	SURFACED LINEAR FIXTURE	CREE LIGHTING	LS4	LED	4000 K	FIXTURES ABOVE KITCHEN AREA
LT-06	4	SWING ARM LAMP WALL LIGHT	ALL MODERN LIGHTING	SKU: TADN7320	LED	2700 K	FIXTURES ABOVE BAR AREA AND COFFEE BAR AREA
LT-07	5	HUDSON VALLEY FLEMING WALL LIGHT	LAMPS PLUS LIGHTING		LED	2700 K	FIXTURES ABOVE DINING AREA.
LT-08	4	DOMINGO LIGHT ARMED SCONCE WALL LIGHT	ALL MODERN LIGHTING	SKU: CSTD5944	LED		FIXTURES ABOVE LIVING AREA
LT-09	6	EMERGENCY LIGHTING	DUAL LITE LIGHTING		LED		
LT-10	6	EXIT LIGHTING	BARRON LIGHTING	VLEDC-51-WH-G2	LED	6000 K	
LT-11	14	MINI LED MULTIPLE SPOTS LIGHT	WAC LIGHTING	MT-3LD111R	LED		
LT-12	4	LED FOOD SAFE	MANUFACTURER	MANUFACTURER	LED		BY EQUIPMENT VENDOR; WALK-IN COOLER LIGHTS

	DEEL FOTED OF UNIO DI ANIMOTEO
	REFLECTED CEILING PLAN NOTES
1	(N) GWB SOFFIT/CEILING
2	(N) CLEANABLE ACOUSTIC CEILING
3	COLD ROOM CEILING PER COLD ROOM MANUFACTURER
4	(N) LIGHT FIXTURE TYP.
5	(N) 6'-0" CEILING CURTAIN
6	LOCATION OF SWITCH BANK OR LIGHTING CONTROL PANEL, S.E.D.
7	GC TO MOUNT OWNER PROVIDED TV'S AND MOUNTING HARDWARE
8	SHELVES, SEE INTERIOR ELEVATIONS AND/OR EQUIPMENT PLAN
9	GC TO INSTALL NEW TV PROJECTOR SCREEN
10	GC TO INSTALL NEW PROJECTOR
11	NEW METAL SCREEN, REFERENCE DETAIL
12	TRANSFORMER, S.E.D. FOR ADDITIONAL INFO
13	OPEN CEILING
14	DEDICATED POWER FOR STOREFRONT SIGNAGE. PROVIDE FLUSH ACCESS PANEL AS REQUIRED. COORDINATE LOCATION WITH OWNER'S SIGNAGE DESIGN.

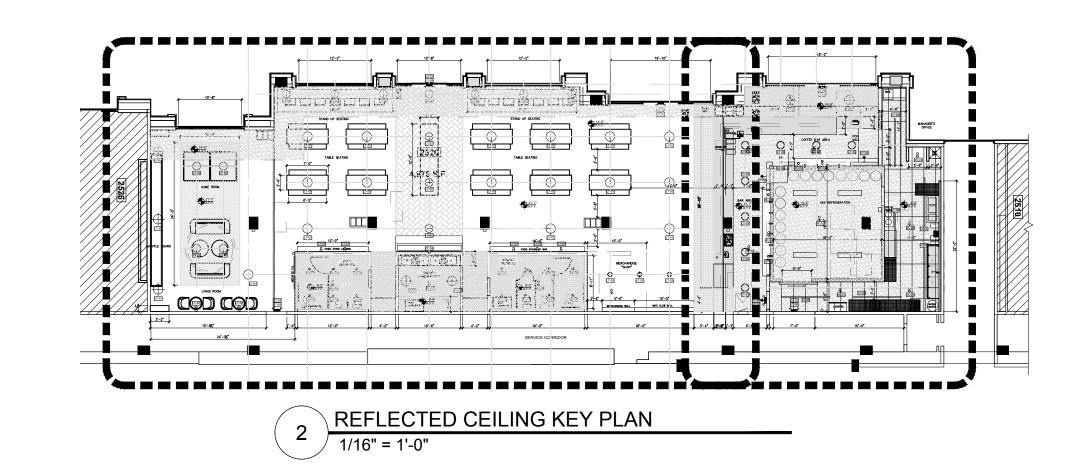

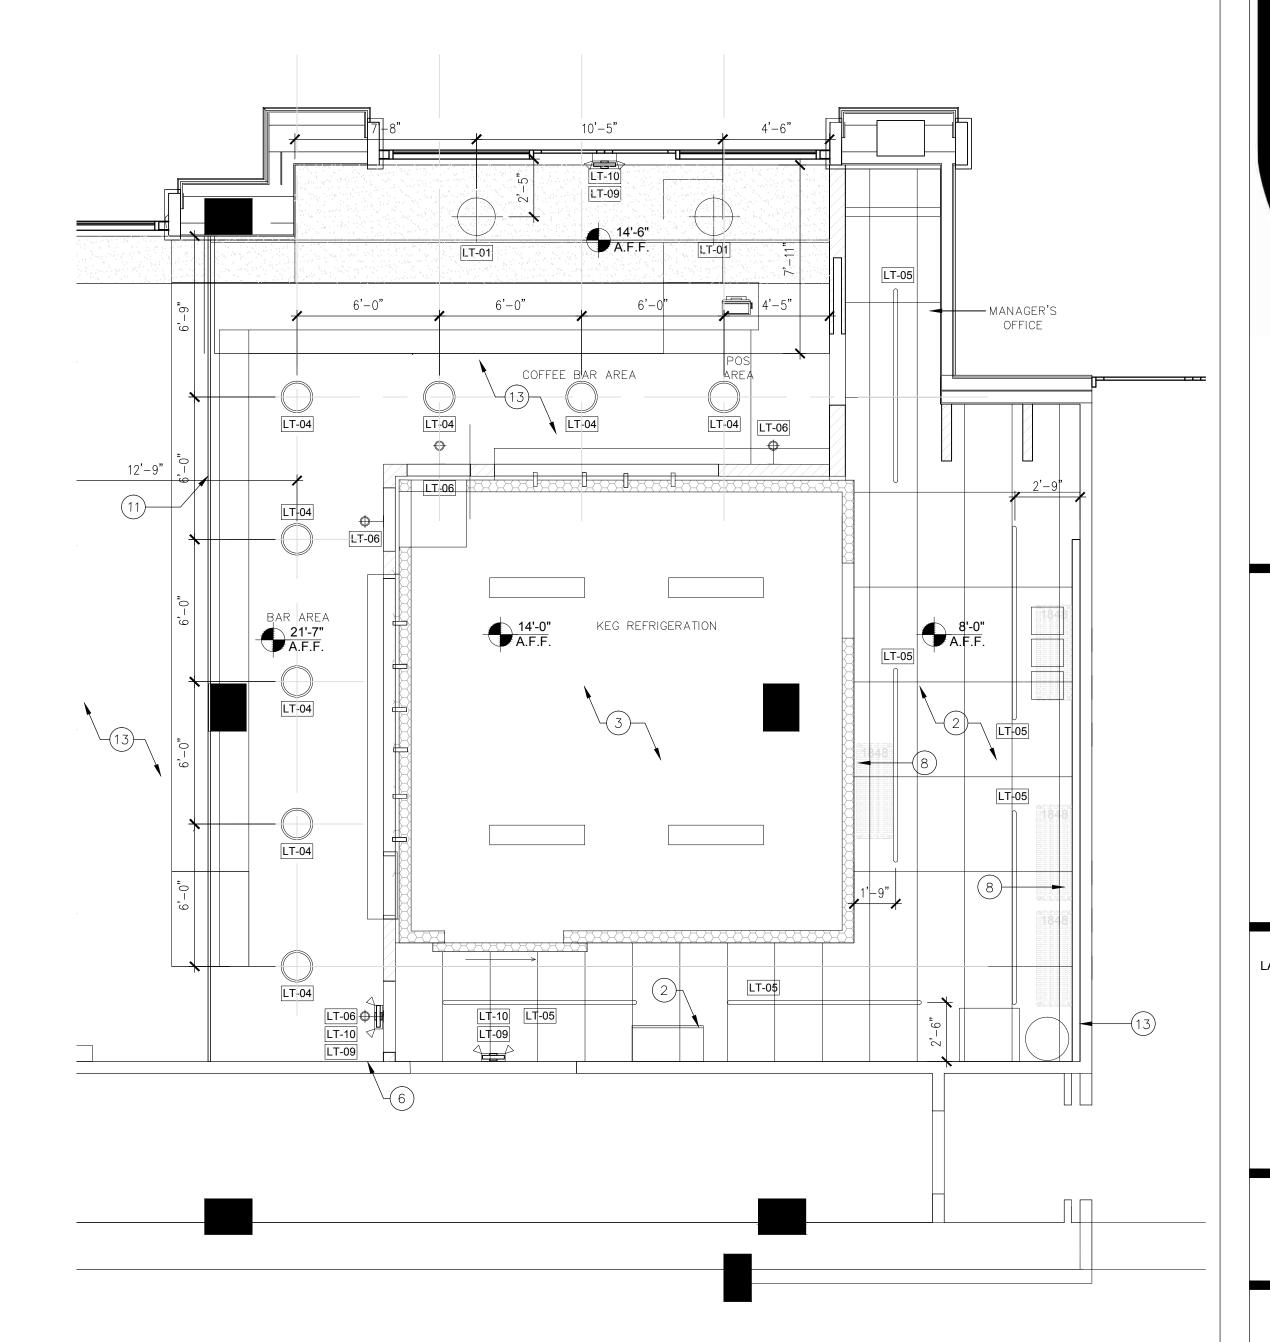

BAREBOTTLE BREW COMPANY
SANTA CLARA SQUARE
BUILDING ONE
2520 AUGUSTINE SQUARE
SANTA CLARA, CA 95054

BOTTLE CO E - BUILDINGONE

SANTA CLARA
2520 AU

SUBMITTAL/REVISIONS


LANDLORD/PERMIT 12/21/18

SUBMITTAL SET

REFLECTED CEILING PLAN SHEET 2

SHEET NUMBER

A2.1

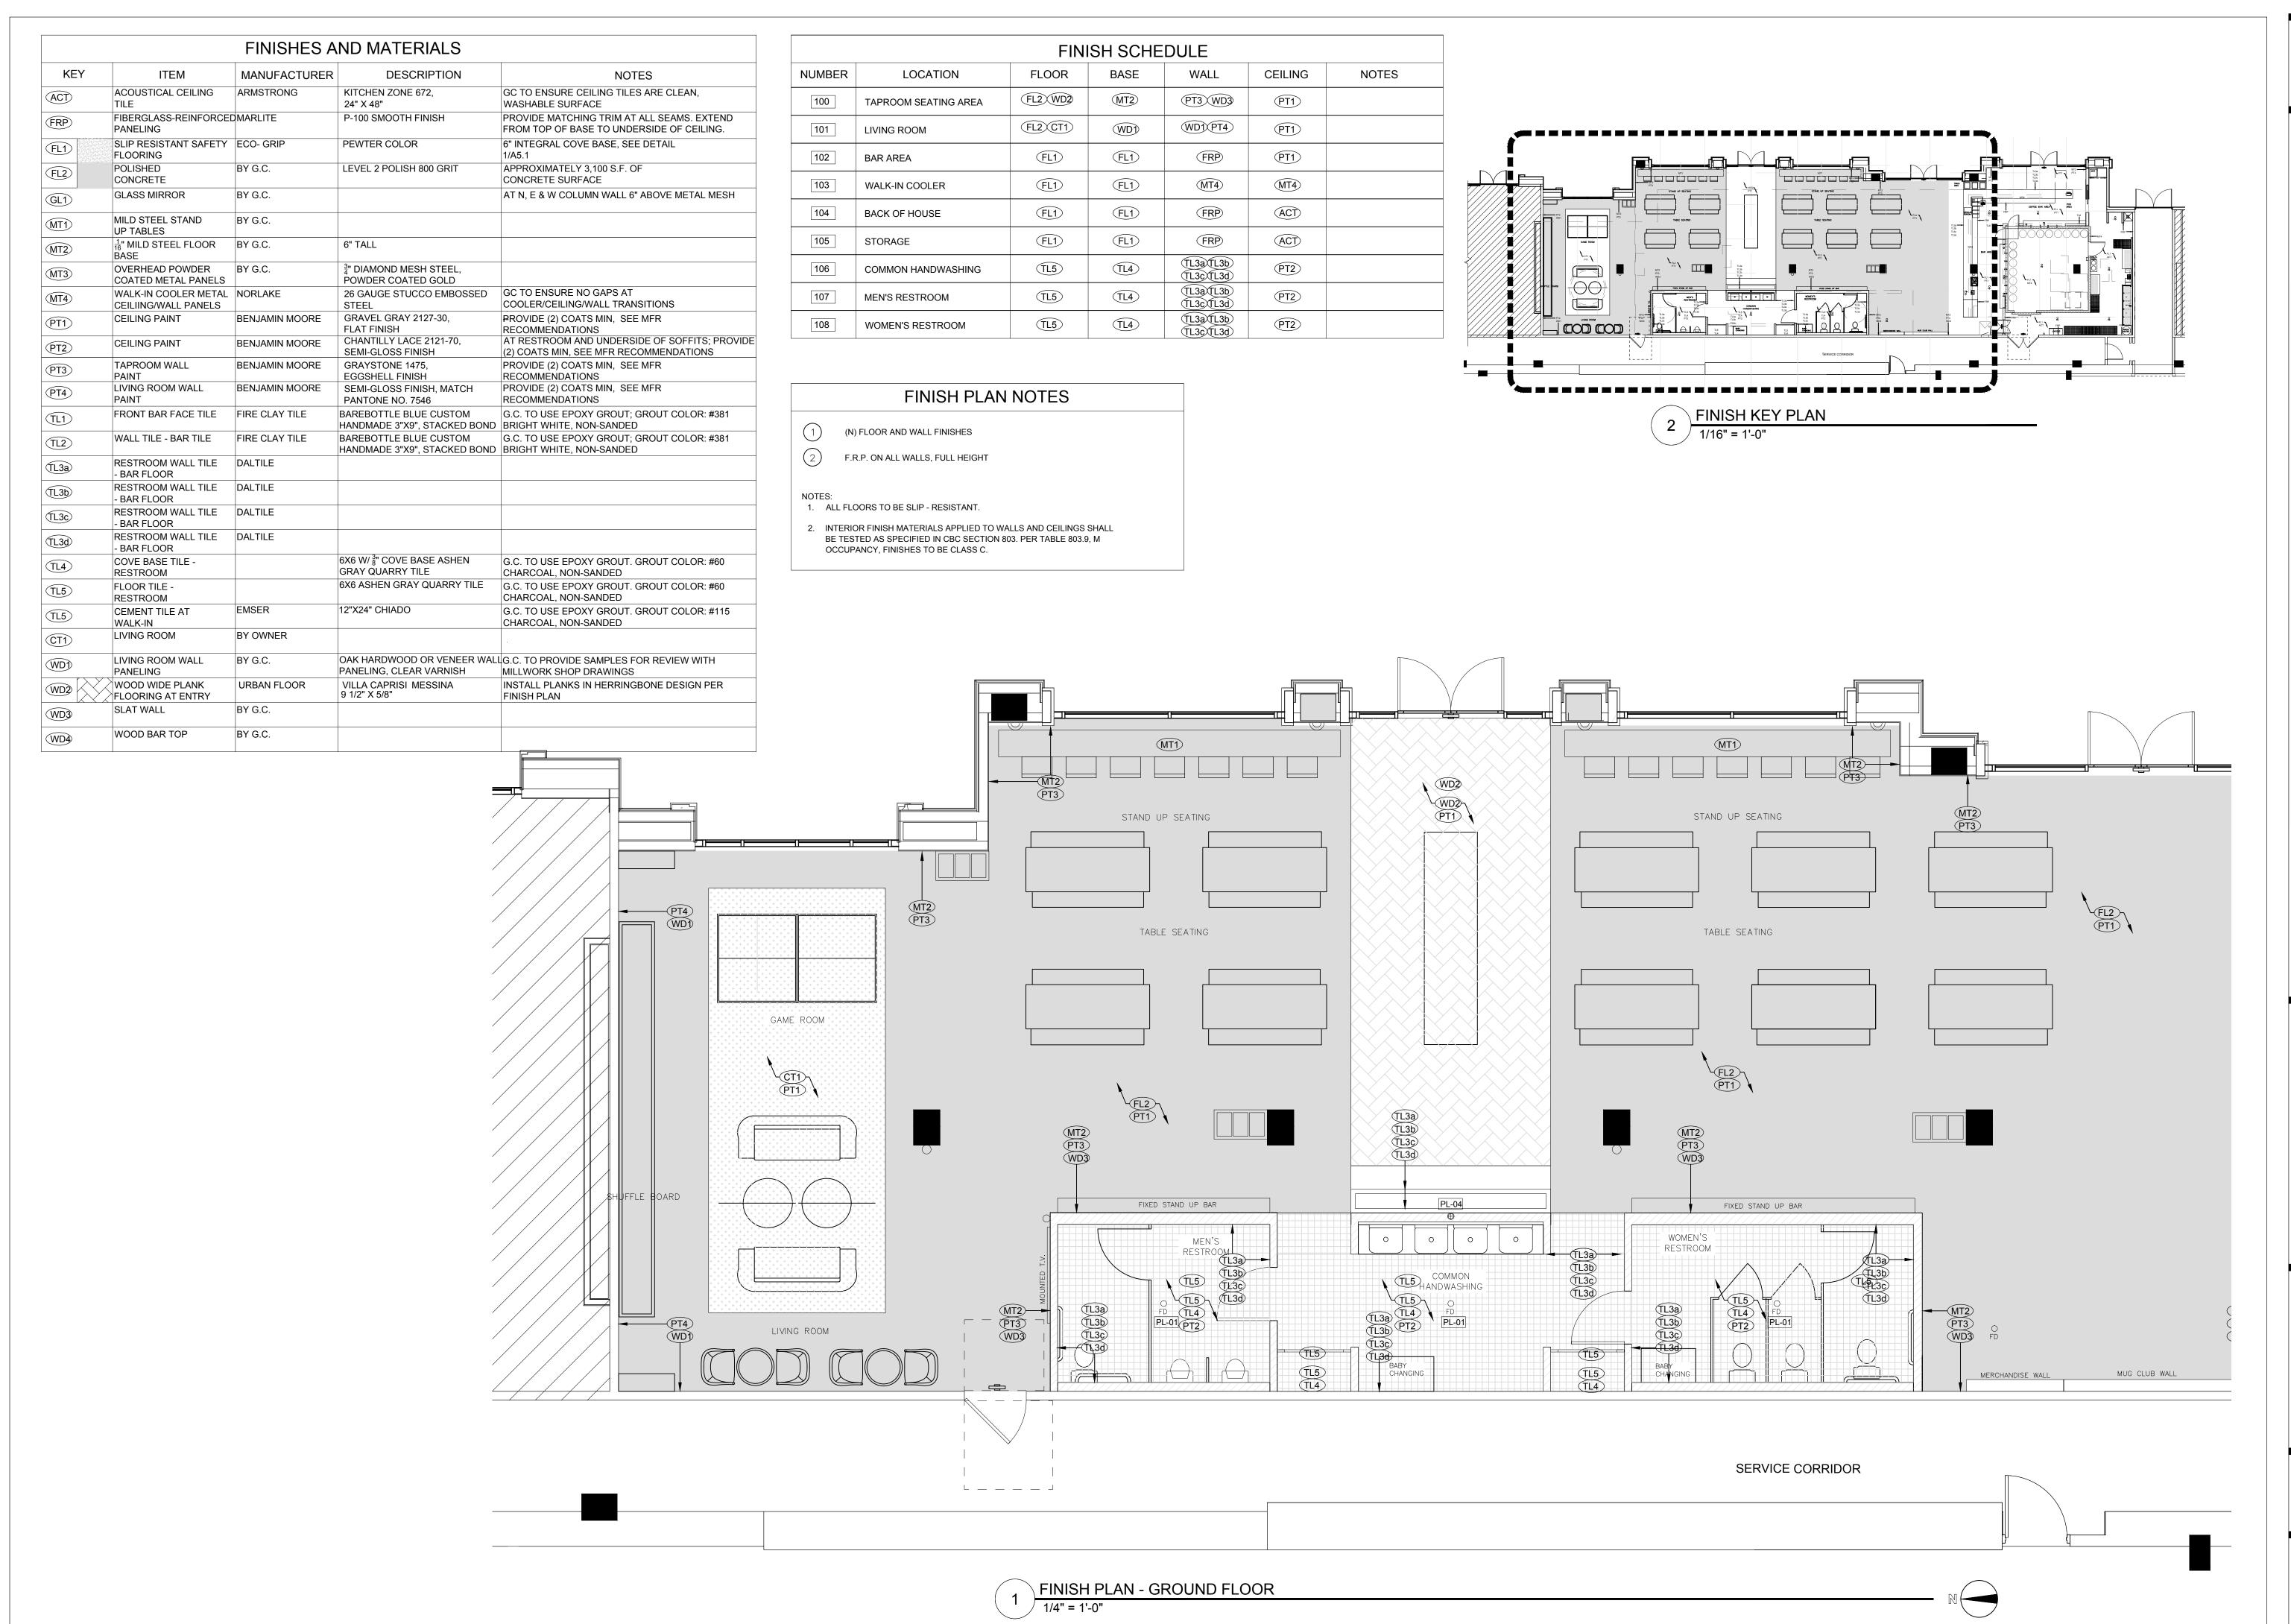

BAREBOTTLE BREW COMPANY SANTA CLARA SQUARE BUILDING ONE 2520 AUGUSTINE SQUARE

SANTA CLARA, CA 95054

SUBMITTAL/REVISIONS LANDLORD/PERMIT 12/21/18 SUBMITTAL SET

> FINISH PLAN SHEET 1

KEY	ITEM	MANUFACTURER	DESCRIPTION	NOTES
ACT	ACOUSTICAL CEILING TILE	ARMSTRONG	KITCHEN ZONE 672, 24" X 48"	GC TO ENSURE CEILING TILES ARE CLEAN, WASHABLE SURFACE
FRP	FIBERGLASS-REINFORCEI PANELING	DMARLITE	P-100 SMOOTH FINISH	PROVIDE MATCHING TRIM AT ALL SEAMS. EXTEND FROM TOP OF BASE TO UNDERSIDE OF CEILING.
FL1	SLIP RESISTANT SAFETY FLOORING	ECO- GRIP	PEWTER COLOR	6" INTEGRAL COVE BASE, SEE DETAIL 1/A5.1
FL2	POLISHED CONCRETE	BY G.C.	LEVEL 2 POLISH 800 GRIT	APPROXIMATELY 3,100 S.F. OF CONCRETE SURFACE
GL1	GLASS MIRROR	BY G.C.		AT N, E & W COLUMN WALL 6" ABOVE METAL MESH
MT1	MILD STEEL STAND UP TABLES	BY G.C.		
MT2	1/16" MILD STEEL FLOOR BASE	BY G.C.	6" TALL	
MT3	OVERHEAD POWDER COATED METAL PANELS	BY G.C.	3" DIAMOND MESH STEEL, POWDER COATED GOLD	
MT4	WALK-IN COOLER METAL CEILIING/WALL PANELS	NORLAKE	26 GAUGE STUCCO EMBOSSED STEEL	GC TO ENSURE NO GAPS AT COOLER/CEILING/WALL TRANSITIONS
PT1	CEILING PAINT	BENJAMIN MOORE	GRAVEL GRAY 2127-30, FLAT FINISH	PROVIDE (2) COATS MIN, SEE MFR RECOMMENDATIONS
PT2	CEILING PAINT	BENJAMIN MOORE	CHANTILLY LACE 2121-70, SEMI-GLOSS FINISH	AT RESTROOM AND UNDERSIDE OF SOFFITS; PROVIDE (2) COATS MIN, SEE MFR RECOMMENDATIONS
PT3	TAPROOM WALL PAINT	BENJAMIN MOORE	GRAYSTONE 1475, EGGSHELL FINISH	PROVIDE (2) COATS MIN, SEE MFR RECOMMENDATIONS
PT4	LIVING ROOM WALL PAINT	BENJAMIN MOORE	SEMI-GLOSS FINISH, MATCH PANTONE NO. 7546	PROVIDE (2) COATS MIN, SEE MFR RECOMMENDATIONS
TL1	FRONT BAR FACE TILE	FIRE CLAY TILE	BAREBOTTLE BLUE CUSTOM HANDMADE 3"X9", STACKED BOND	·
TL2	WALL TILE - BAR TILE	FIRE CLAY TILE	BAREBOTTLE BLUE CUSTOM HANDMADE 3"X9", STACKED BOND	G.C. TO USE EPOXY GROUT; GROUT COLOR: #381 BRIGHT WHITE, NON-SANDED
TL3a	RESTROOM WALL TILE - BAR FLOOR	DALTILE		
TL3b	RESTROOM WALL TILE - BAR FLOOR	DALTILE		
TL3c	RESTROOM WALL TILE - BAR FLOOR	DALTILE		
TL3d	RESTROOM WALL TILE - BAR FLOOR	DALTILE		
TL4	COVE BASE TILE - RESTROOM		6X6 W/ 8" COVE BASE ASHEN GRAY QUARRY TILE	G.C. TO USE EPOXY GROUT. GROUT COLOR: #60 CHARCOAL, NON-SANDED
TL5	FLOOR TILE - RESTROOM		6X6 ASHEN GRAY QUARRY TILE	G.C. TO USE EPOXY GROUT. GROUT COLOR: #60 CHARCOAL, NON-SANDED
TL5	CEMENT TILE AT WALK-IN	EMSER	12"X24" CHIADO	G.C. TO USE EPOXY GROUT. GROUT COLOR: #115 CHARCOAL, NON-SANDED
CT1	LIVING ROOM	BY OWNER		
WD1)	LIVING ROOM WALL PANELING	BY G.C.	PANELING, CLEAR VARNISH	G.C. TO PROVIDE SAMPLES FOR REVIEW WITH MILLWORK SHOP DRAWINGS
WD2	WOOD WIDE PLANK FLOORING AT ENTRY	URBAN FLOOR	VILLA CAPRISI MESSINA 9 1/2" X 5/8"	INSTALL PLANKS IN HERRINGBONE DESIGN PER FINISH PLAN
WD3	SLAT WALL	BY G.C.		


		FINI	SH SCHE	DULE		
NUMBER	LOCATION	FLOOR	BASE	WALL	CEILING	NOTES
100	TAPROOM SEATING AREA	FL2 WD2	MT2	PT3 WD3	PT1	
101	LIVING ROOM	FL2 CT1	WD1)	WD1 PT4	PT1	
102	BAR AREA	FL1	(FL1)	FRP	PT1	
103	WALK-IN COOLER	FL1	(FL1)	MT4)	MT4	
104	BACK OF HOUSE	FL1	FL1)	FRP	ACT	
105	STORAGE	FL1	(FL1)	FRP	ACT	
106	COMMON HANDWASHING	TL5	TL4	TL3a TL3b TL3c TL3d	PT2	
107	MEN'S RESTROOM	TL5	TL4	TL3a(TL3b) TL3c(TL3d)	PT2	
108	WOMEN'S RESTROOM	TL5	TL4	TL3a TL3b TL3c TL3d	PT2	


FINISH PLAN NOTES

- (N) FLOOR AND WALL FINISHES
- F.R.P. ON ALL WALLS, FULL HEIGHT

1. ALL FLOORS TO BE SLIP - RESISTANT.

INTERIOR FINISH MATERIALS APPLIED TO WALLS AND CEILINGS SHALL BE TESTED AS SPECIFIED IN CBC SECTION 803. PER TABLE 803.9, M OCCUPANCY, FINISHES TO BE CLASS C.

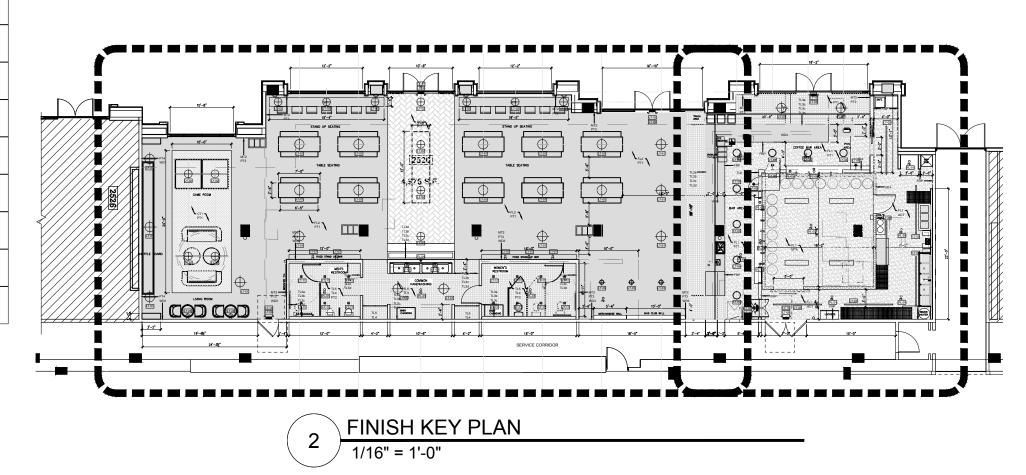

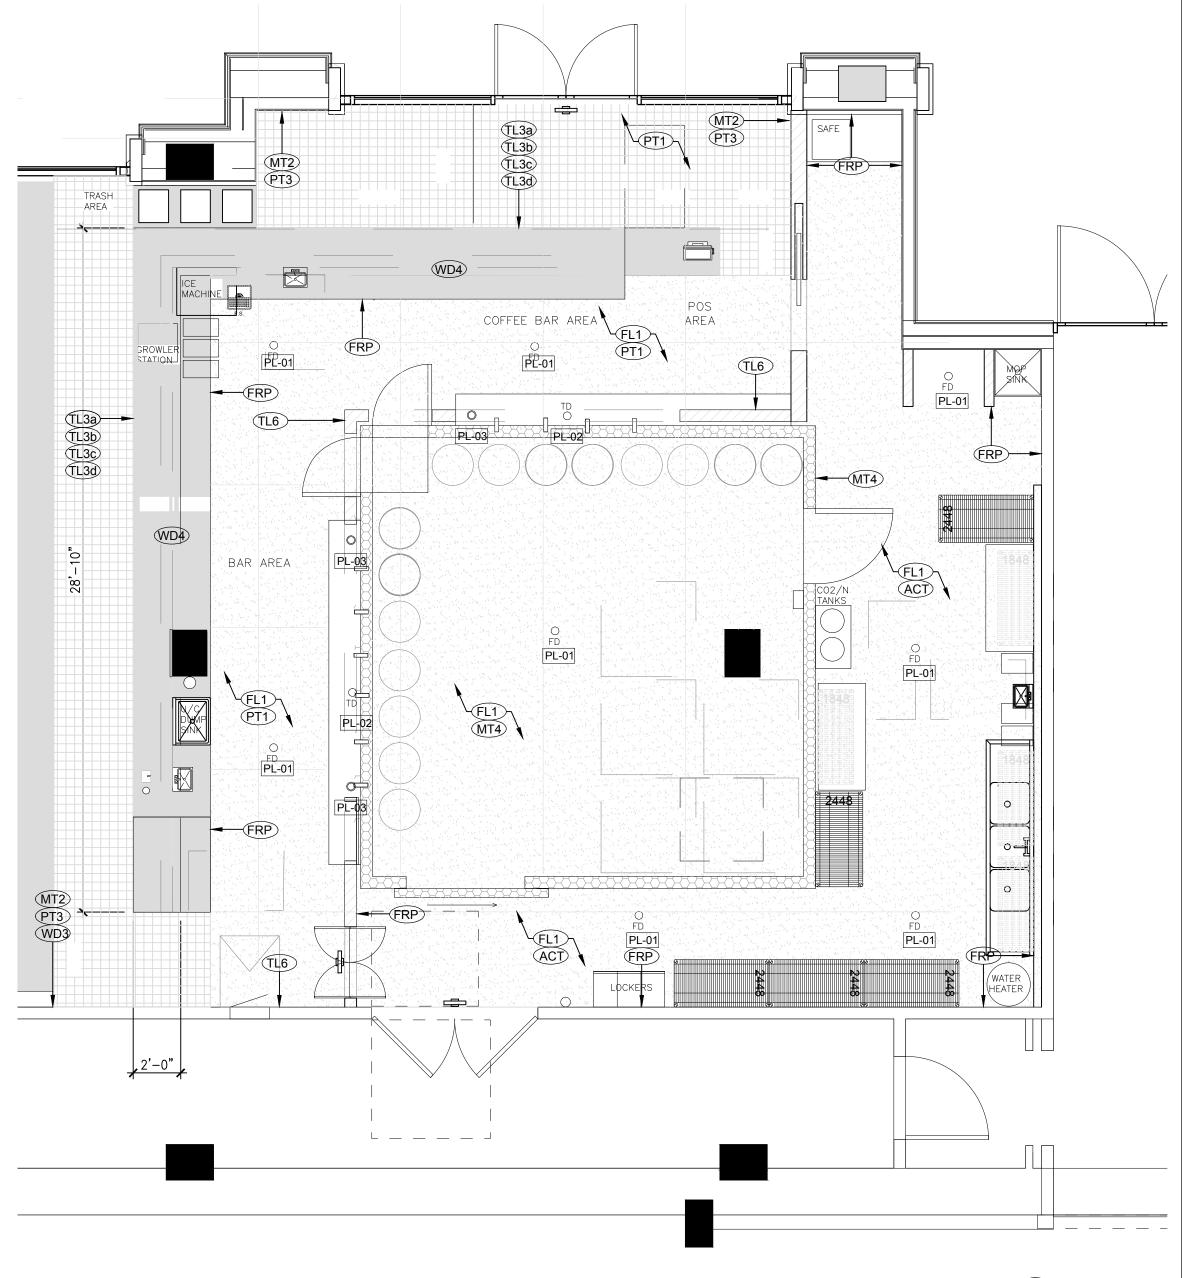

BAREBOTTLE BREW COMPANY SANTA CLARA SQUARE BUILDING ONE 2520 AUGUSTINE SQUARE

SANTA CLARA, CA 95054

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FINISH PLAN SHEET 2


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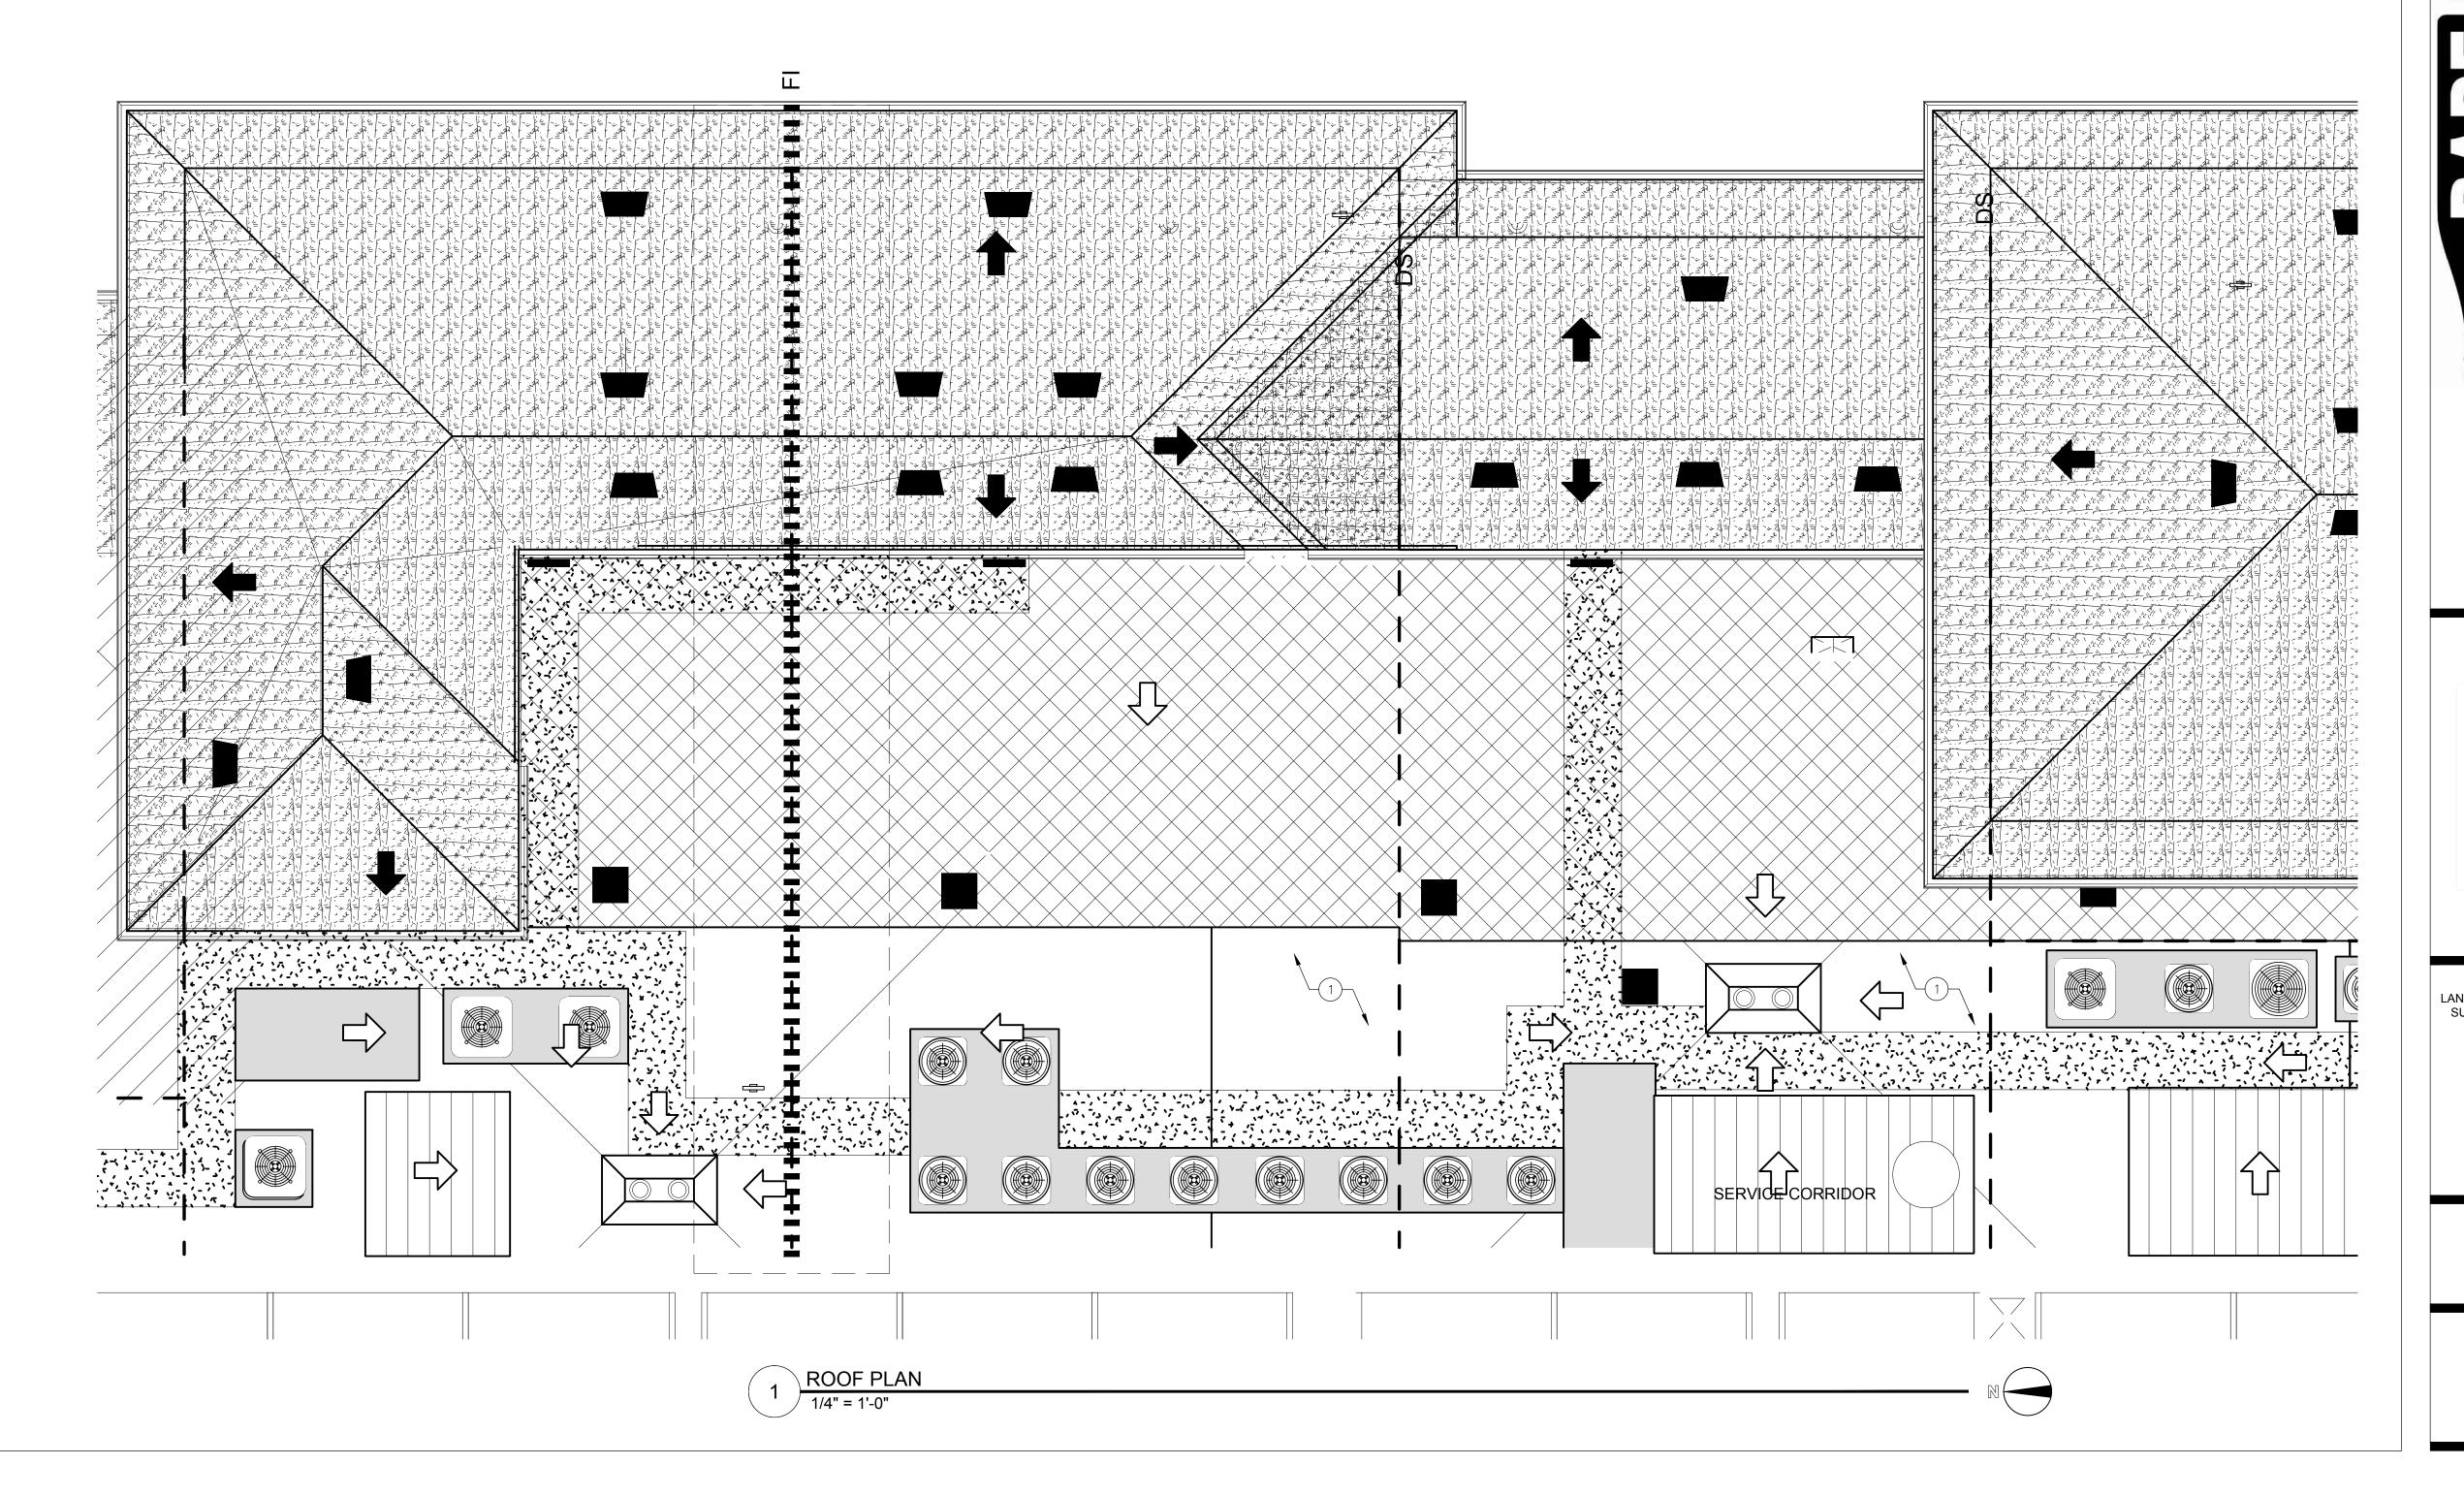
FINISH PLAN - GROUND FLOOR
1/4" = 1'-0"

1 CLEA

CLEAR ROOFTOP AREA FOR TENANT'S MEP EQUIPMENT, REFERENCE MEP DRAWINGS

NOTES:
1. FIRE RATED SHAFT PROVIDED BY LANDLORD.



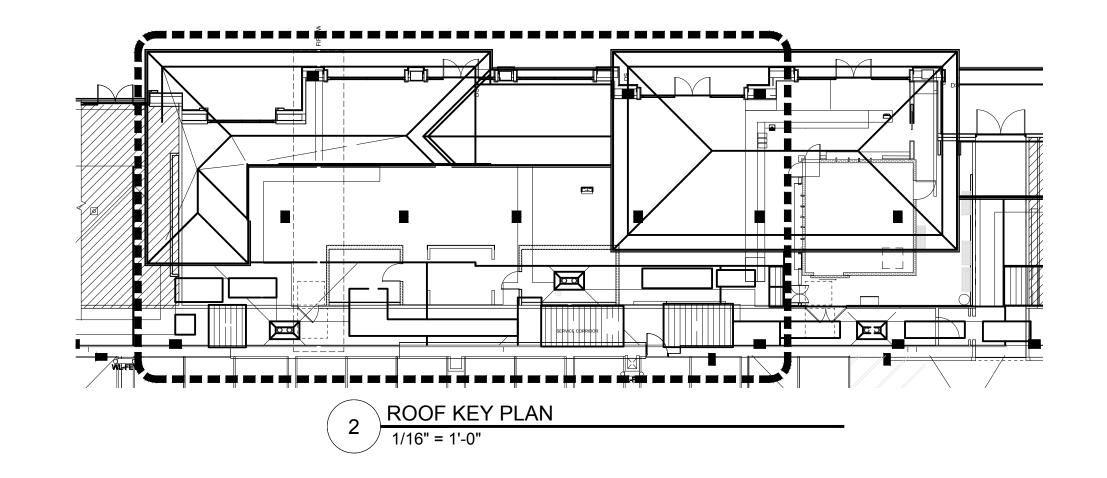

BAREBOTTLE BREW COMPANY
SANTA CLARA SQUARE
BUILDING ONE
2520 AUGUSTINE SQUARE
SANTA CLARA, CA 95054

GONE

BOTTLE COARA SQUARE - BUILDINGONE 20 AUGUSTINE DRIVE

SUBMITTAL/REVISIONS

LANDLORD/PERMIT 12/21/18
SUBMITTAL SET


ROOF PLAN SHEET 1


ROOF PLAN NOTES

(1)

CLEAR ROOFTOP AREA FOR TENANT'S MEP EQUIPMENT, REFERENCE MEP DRAWINGS

NOTES:
1. FIRE RATED SHAFT PROVIDED BY LANDLORD.

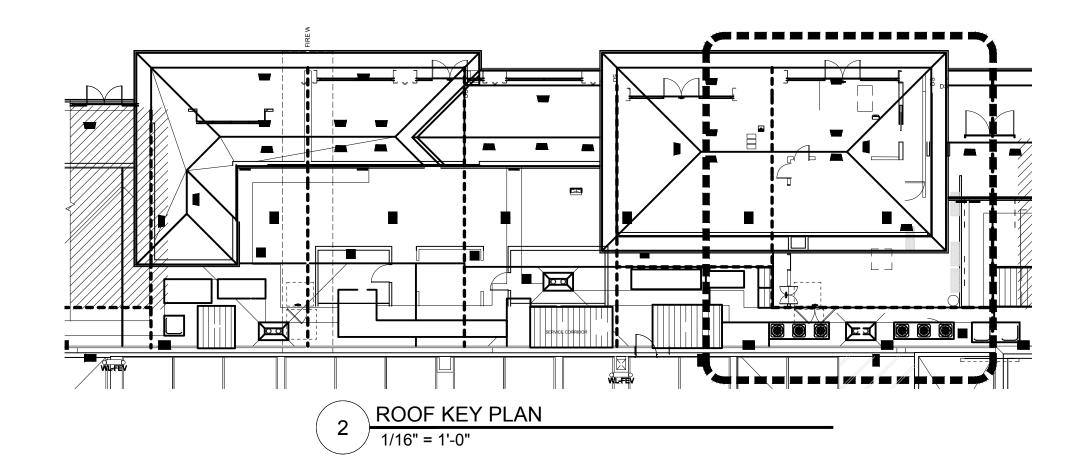

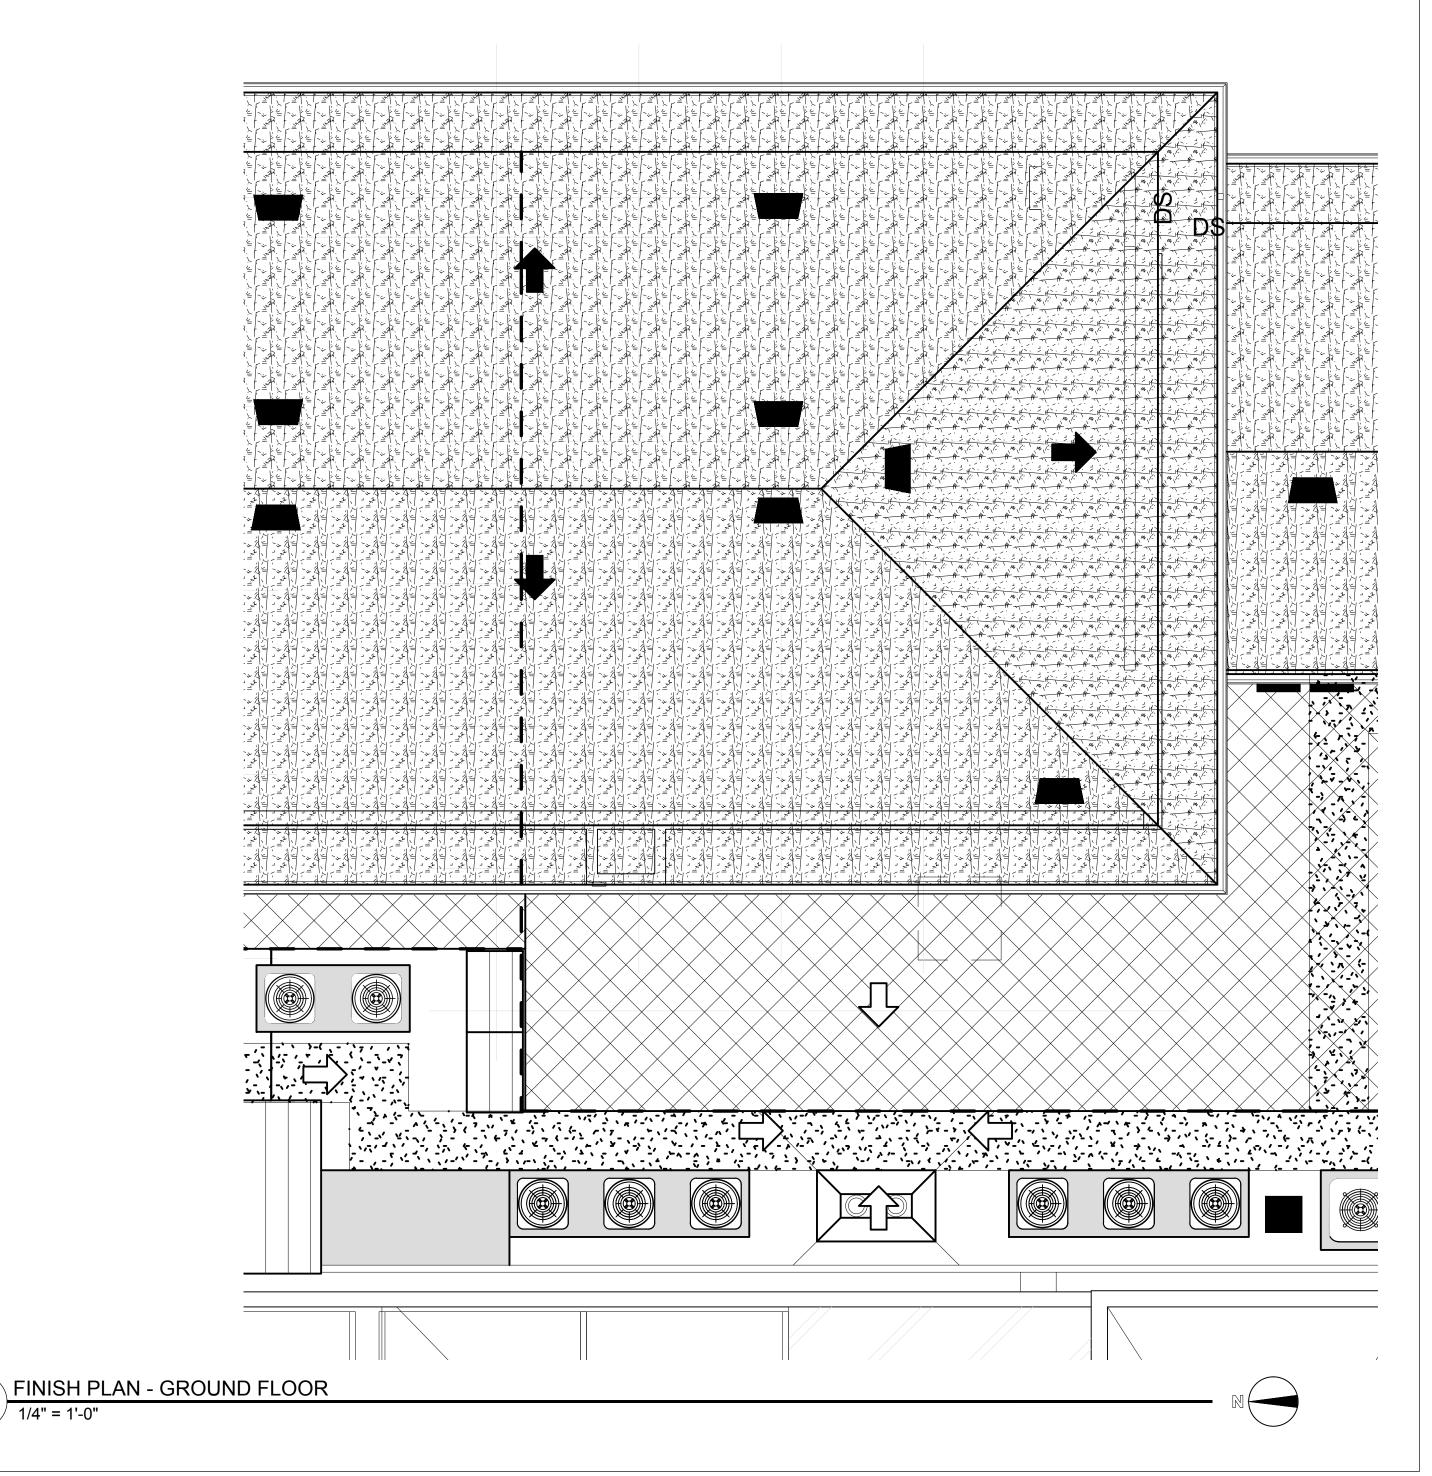

BAREBOTTLE BREW COMPANY
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SANTA CLARA, CA 95054

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A SQUARE - BUILDINGONE AUGUSTINE DRIVE


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SUBMITTAL SET

ROOF PLAN SHEET 2

SHEET NUMBER

A2.5

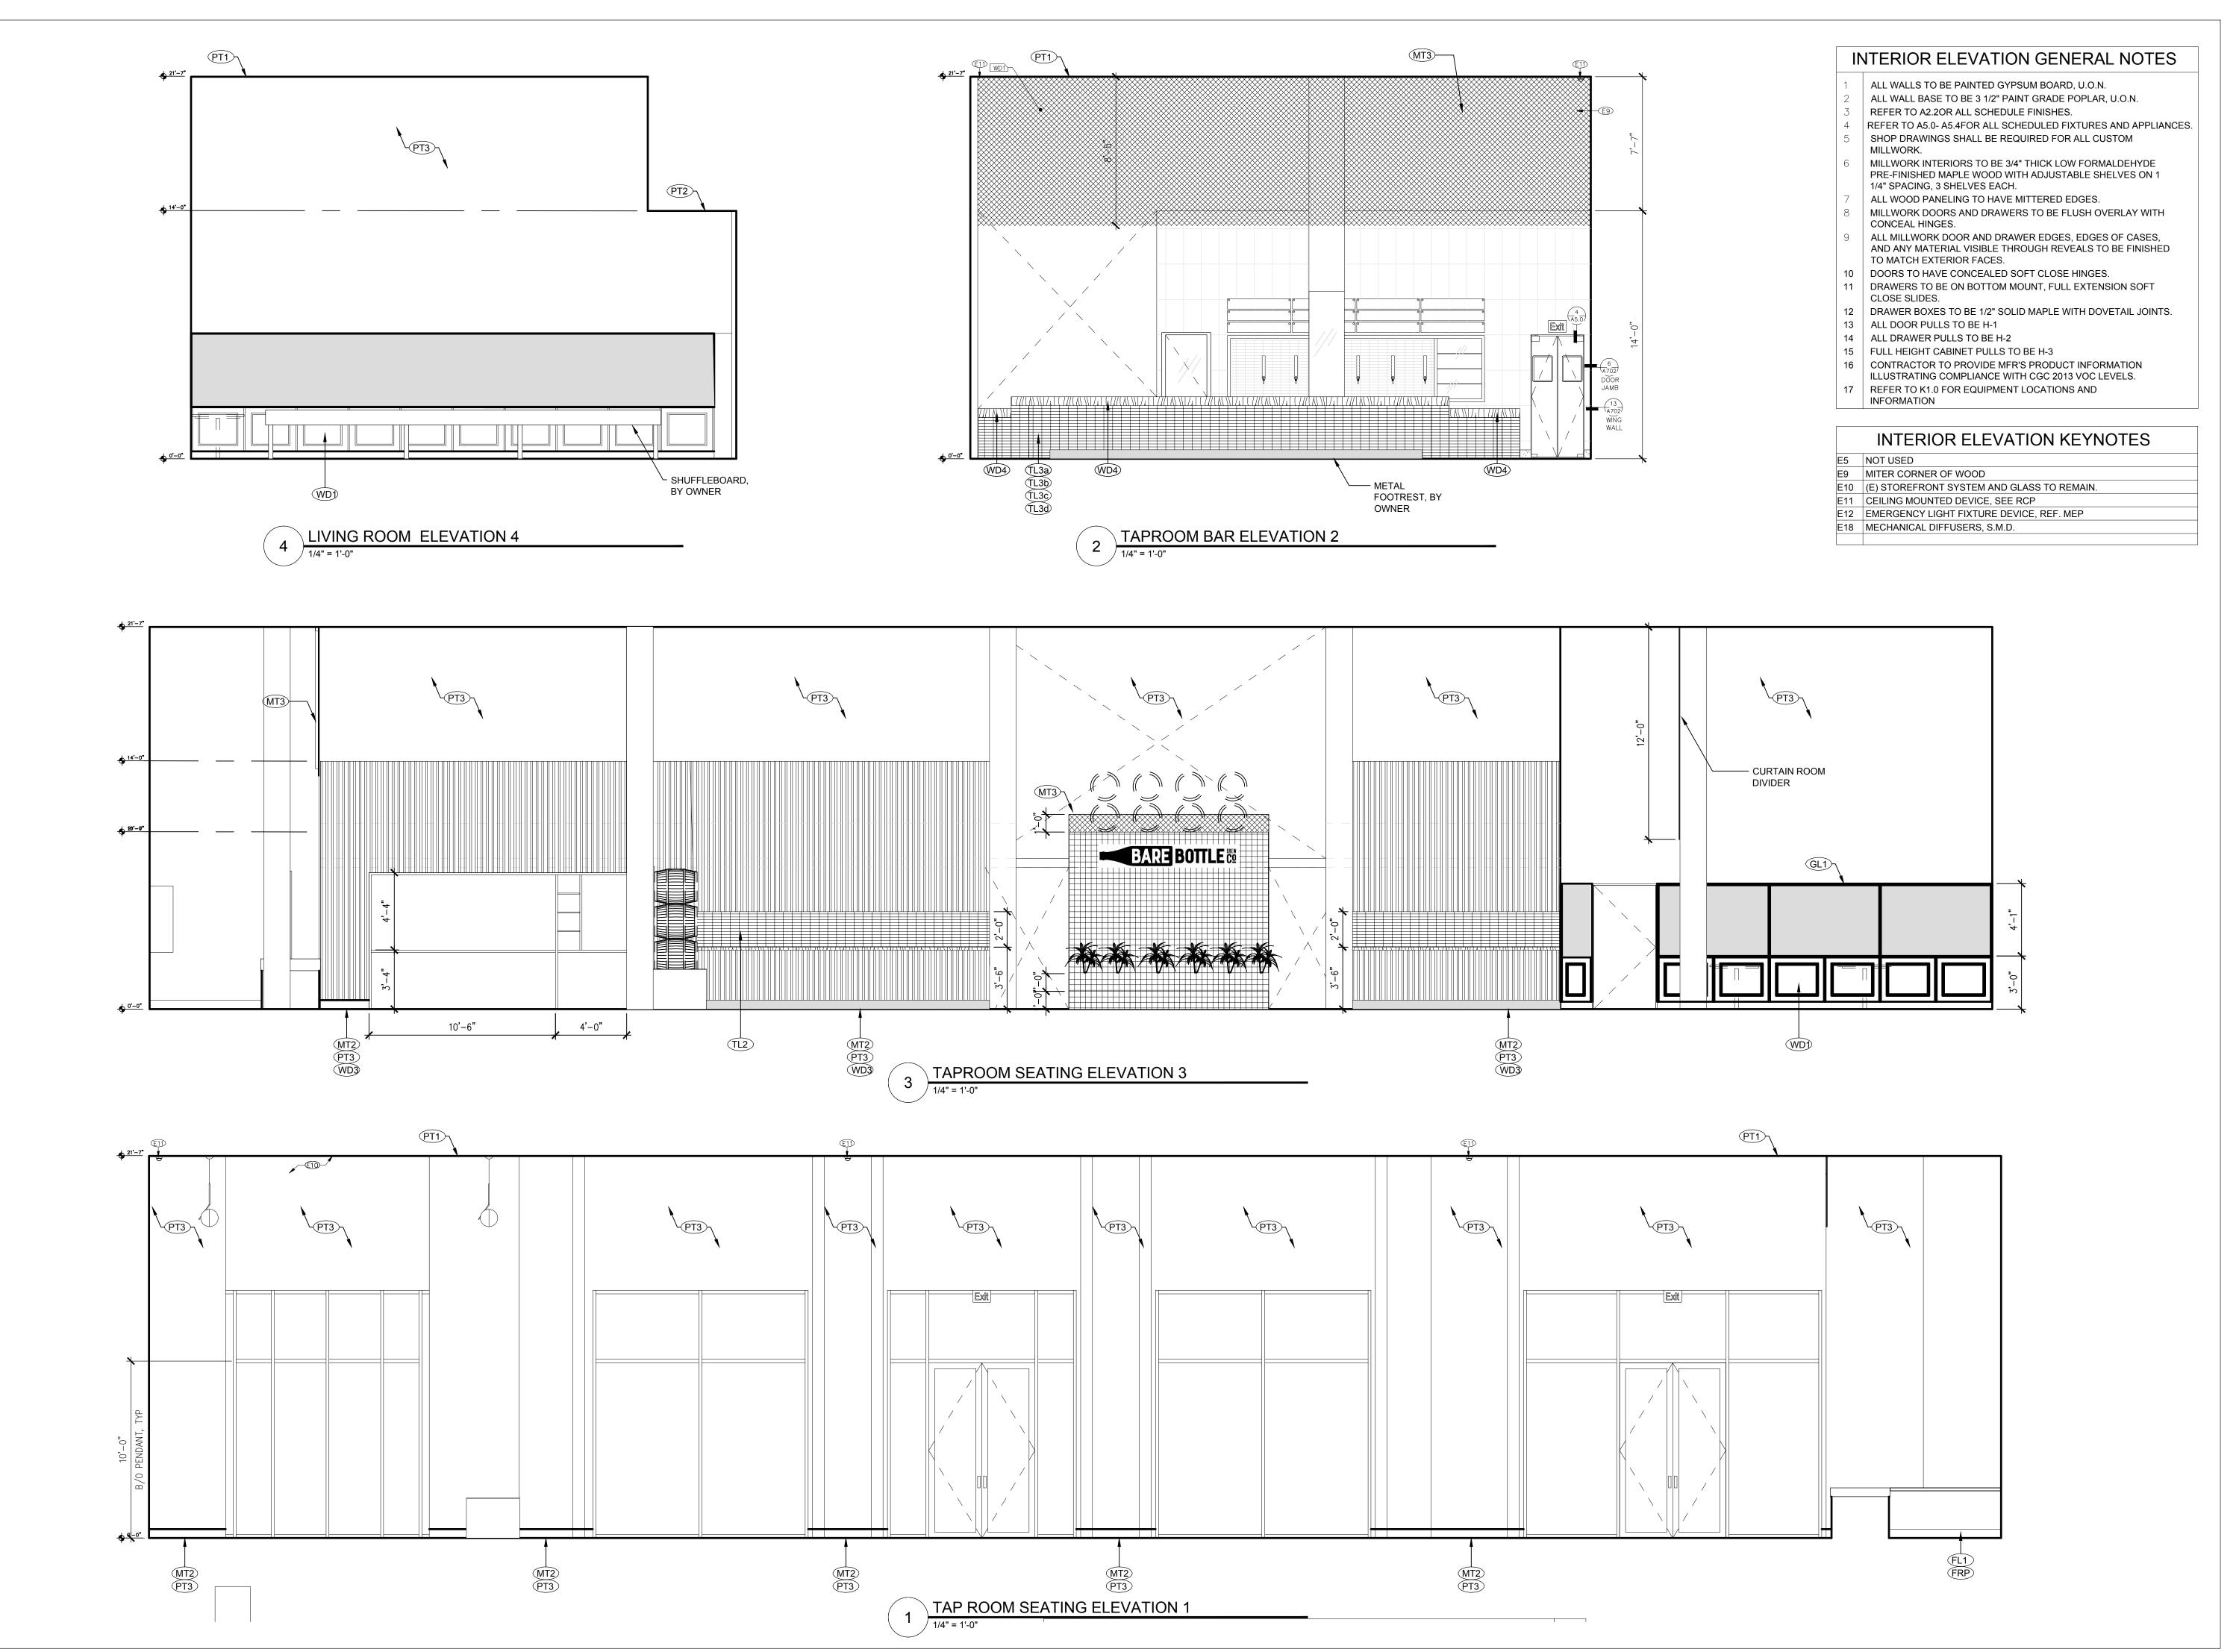

BAREBOTTLE BREW COMPANY SANTA CLARA SQUARE

> BUILDING ONE 2520 AUGUSTINE SQUARE SANTA CLARA, CA 95054

SANTA CLARA SQUARE - BUILDINGONE 2520 AUGUSTINE DRIVE

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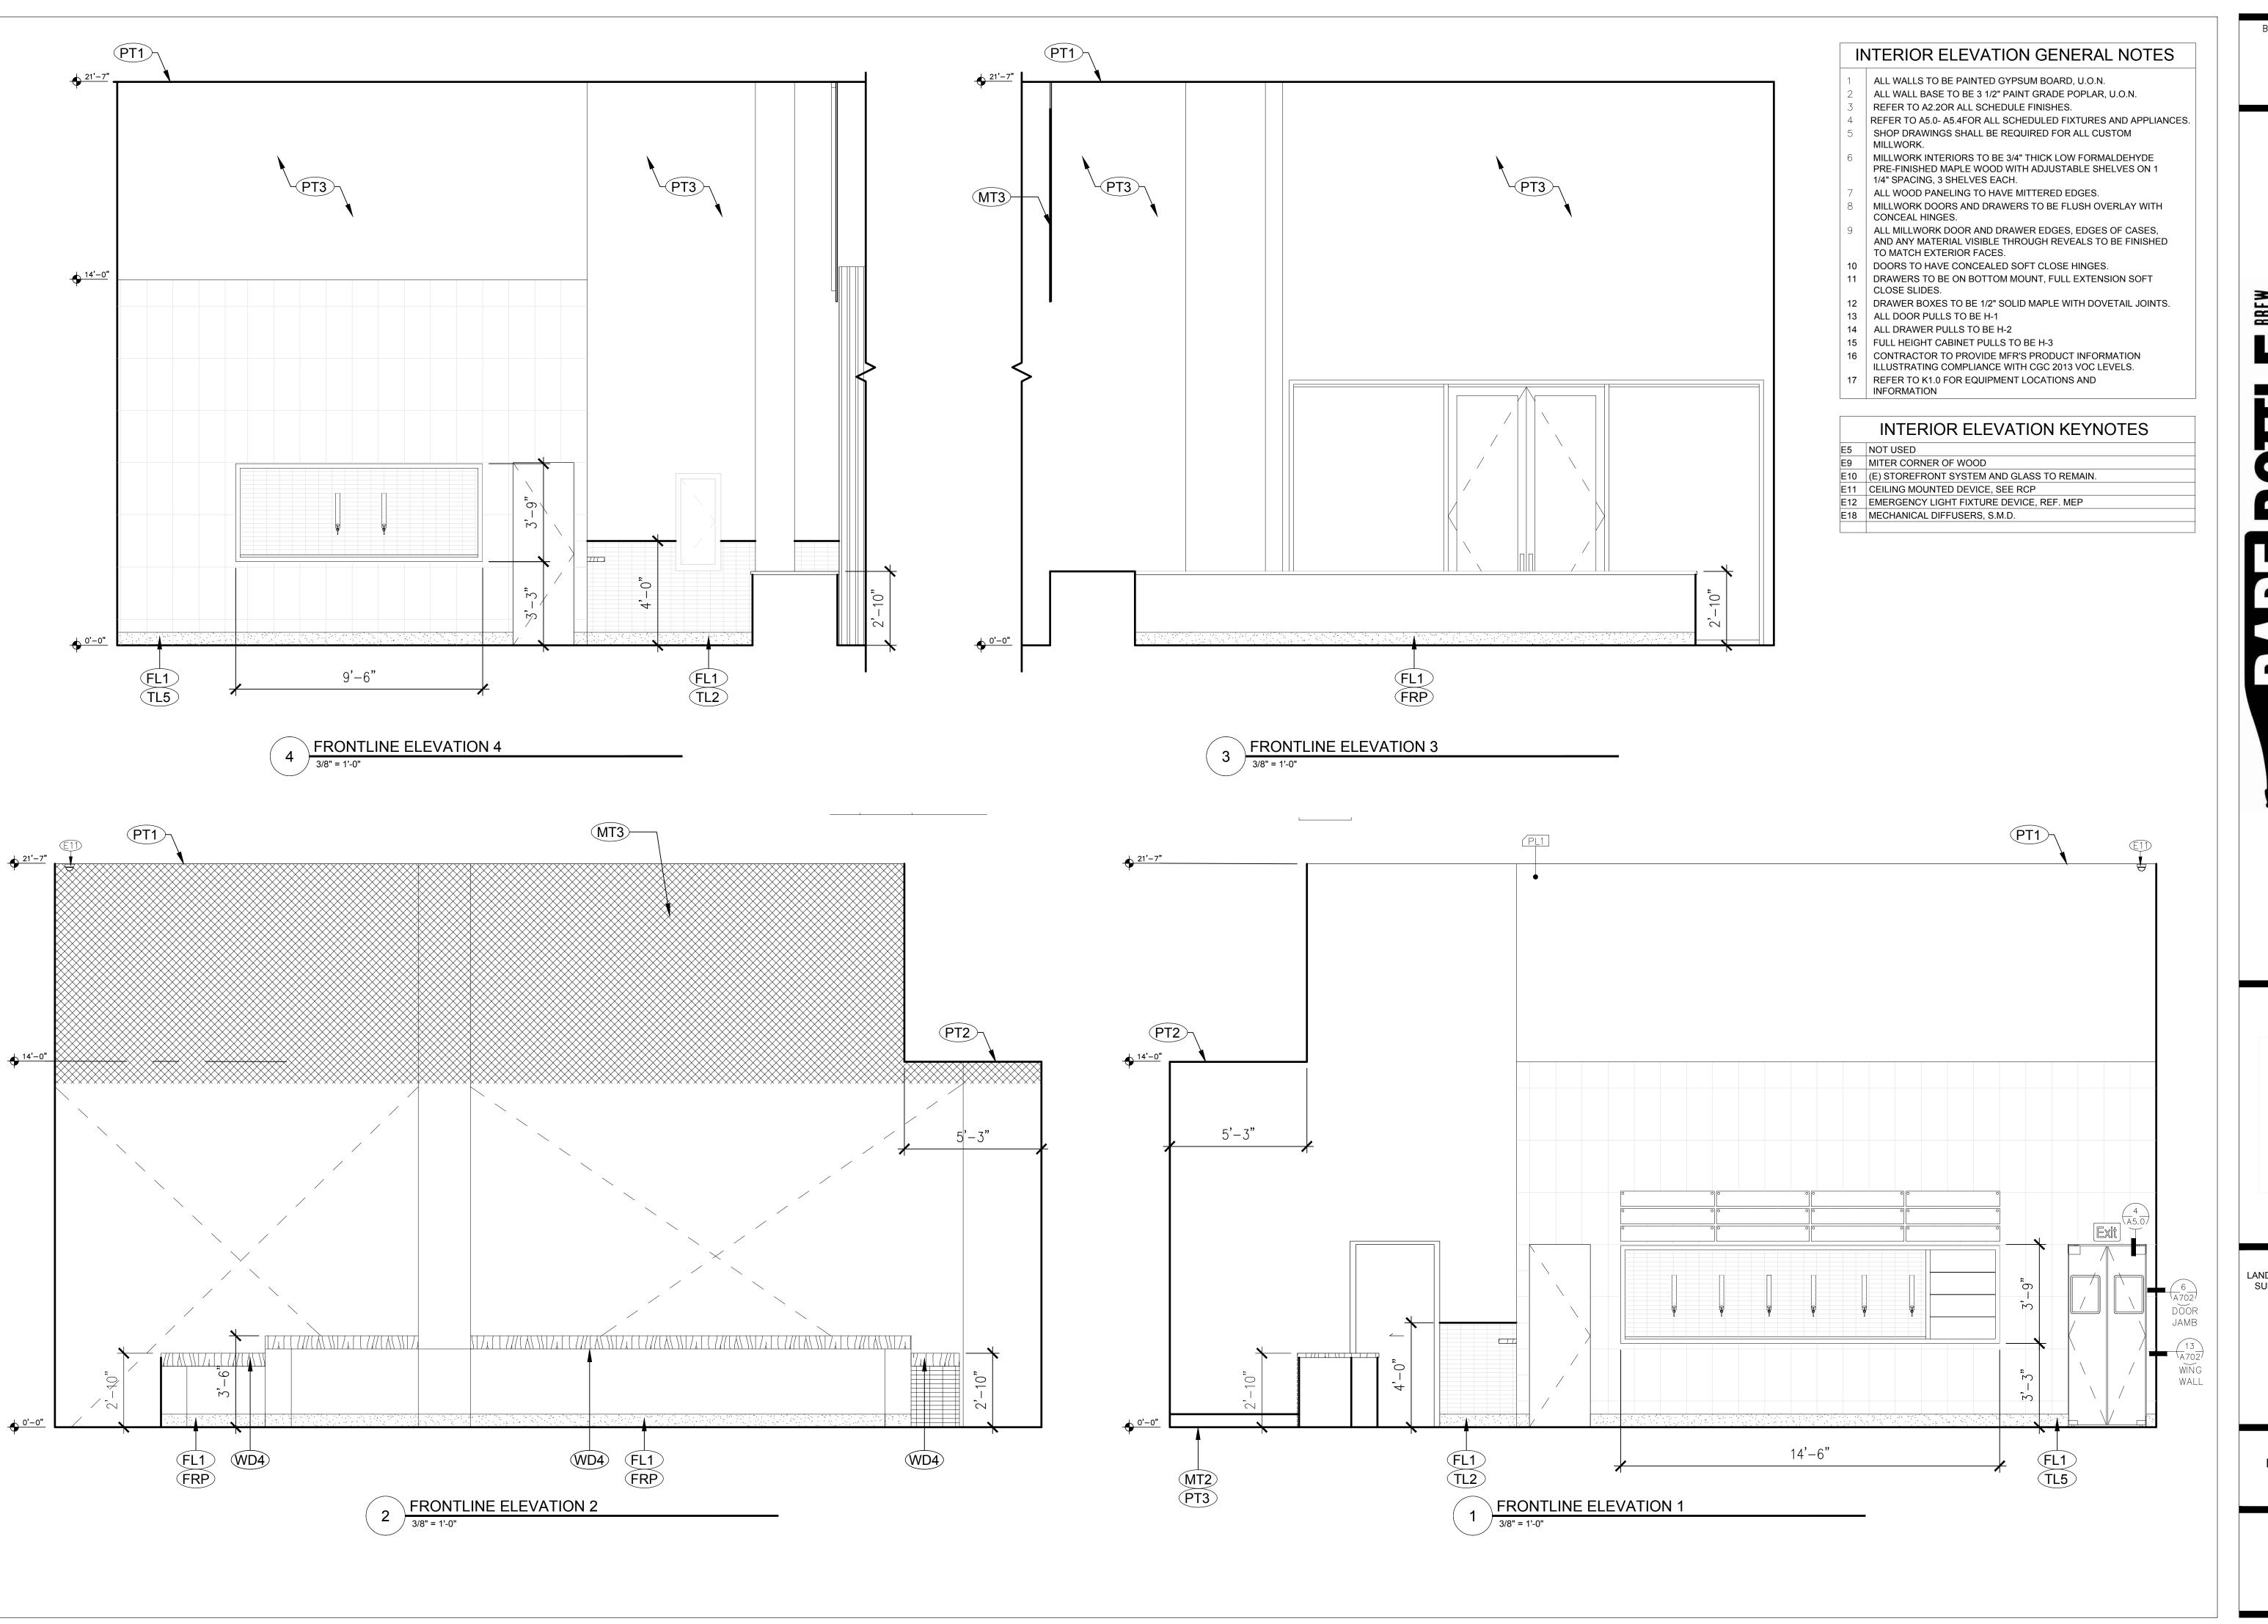
LANDLORD/PERMIT 1

SUBMITTAL SET

INTERIOR ELEVATIONS

SHEET NUMBER

A4.0



BAREBOTTLE BREW COMPANY
SANTA CLARA SQUARE

BUILDING ONE 2520 AUGUSTINE SQUARE SANTA CLARA, CA 95054

BOTTLE BEINGONE SE AUGUSTINE DRIVE


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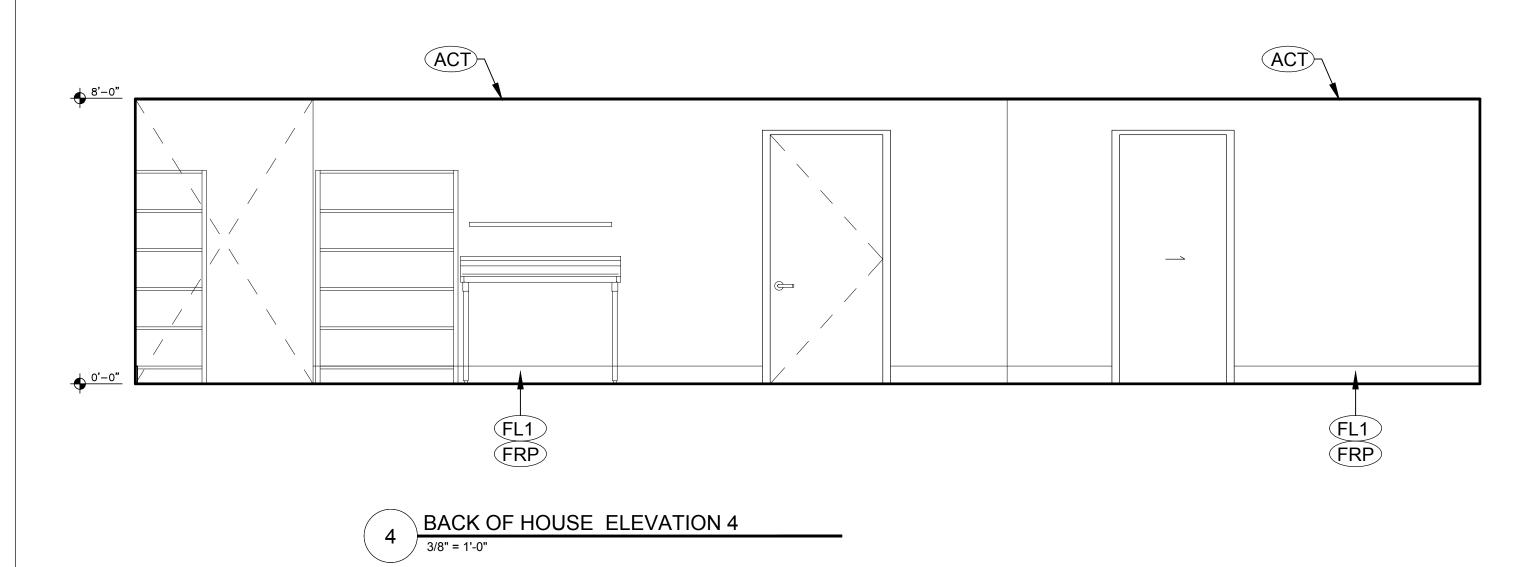
LANDLORD/PERMIT 12/21/18
SUBMITTAL SET


INTERIOR ELEVATIONS


SHEET NUMBER

A4.1



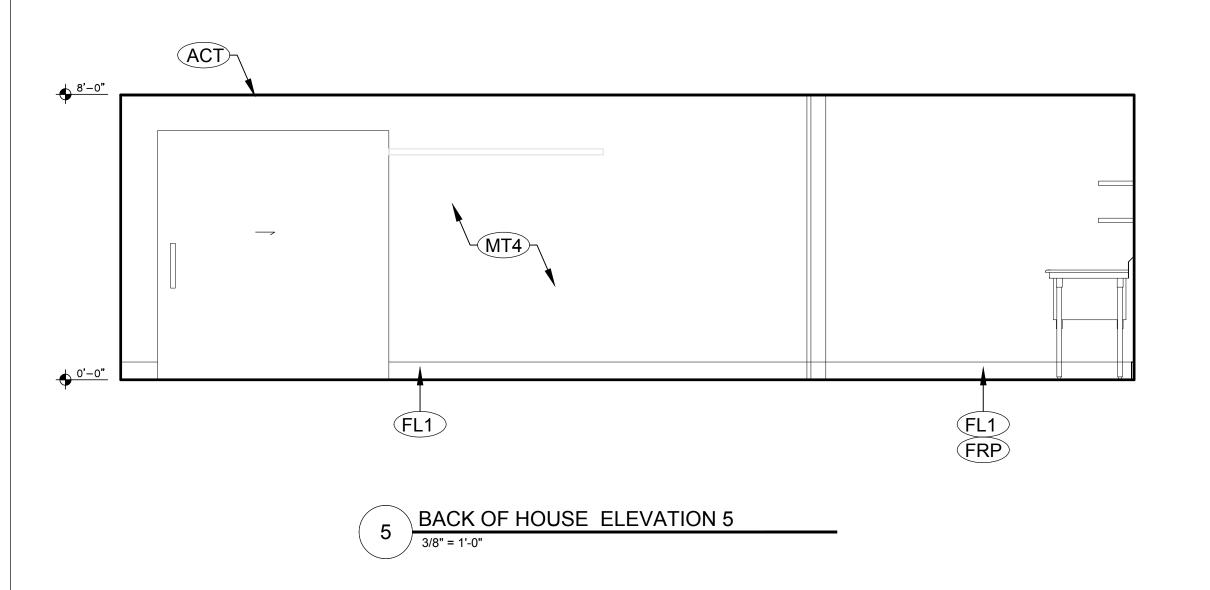

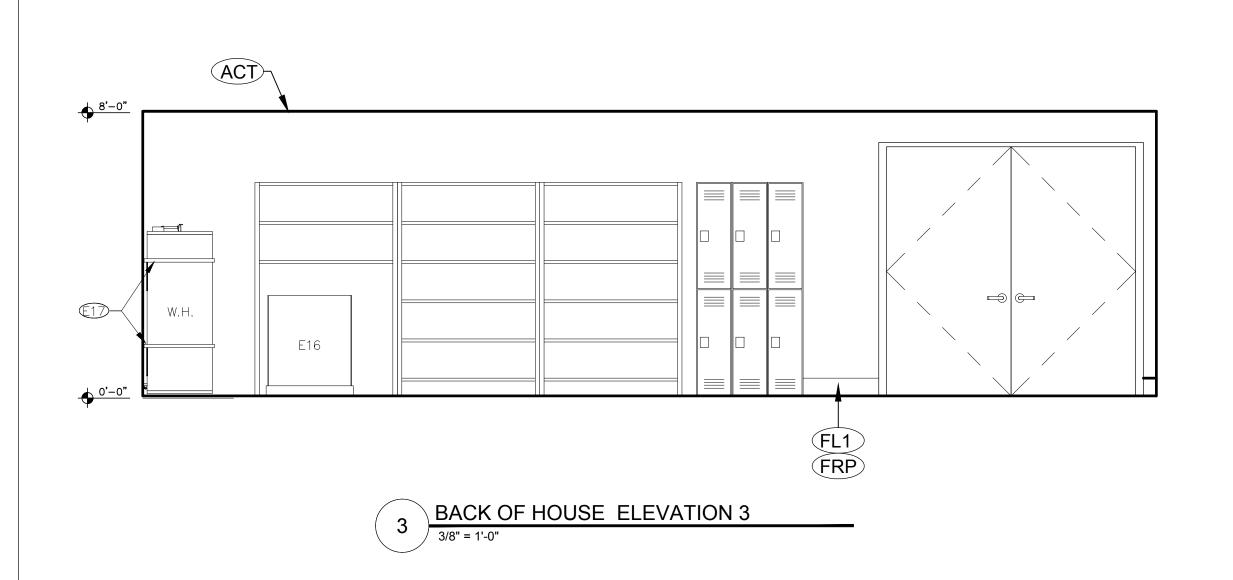

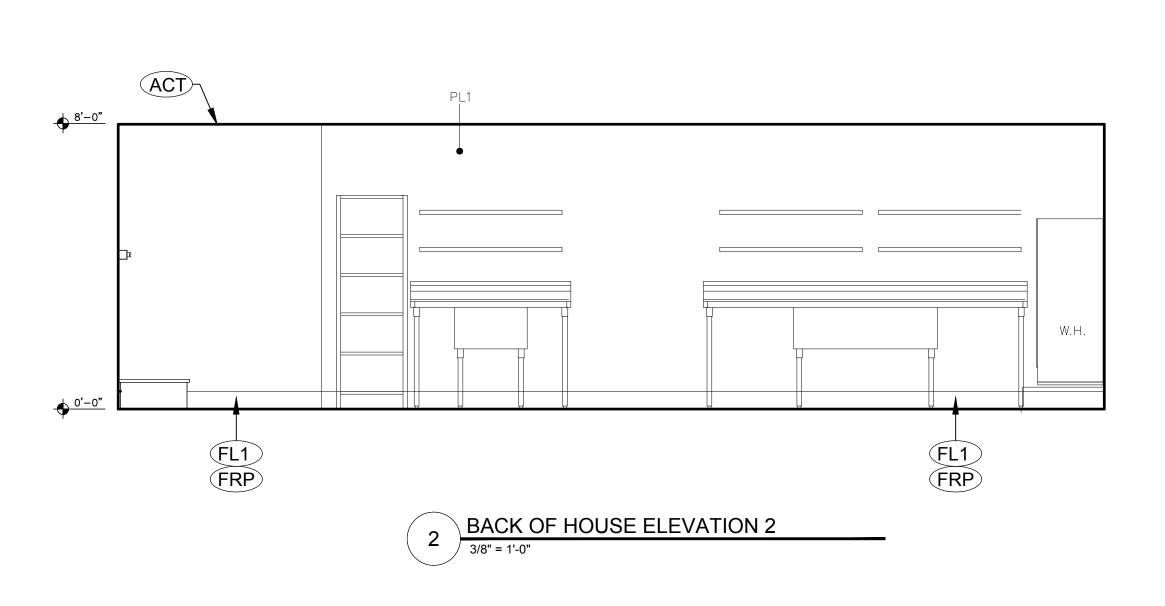

INTERIOR ELEVATION GENERAL NOTES

- ALL WALLS TO BE PAINTED GYPSUM BOARD, U.O.N.
- ALL WALL BASE TO BE 3 1/2" PAINT GRADE POPLAR, U.O.N.
- REFER TO A2.2OR ALL SCHEDULE FINISHES.
- REFER TO A5.0- A5.4FOR ALL SCHEDULED FIXTURES AND APPLIANCES. SHOP DRAWINGS SHALL BE REQUIRED FOR ALL CUSTOM MILLWORK.
- MILLWORK INTERIORS TO BE 3/4" THICK LOW FORMALDEHYDE PRE-FINISHED MAPLE WOOD WITH ADJUSTABLE SHELVES ON 1
- 1/4" SPACING, 3 SHELVES EACH.
- ALL WOOD PANELING TO HAVE MITTERED EDGES.
- MILLWORK DOORS AND DRAWERS TO BE FLUSH OVERLAY WITH CONCEAL HINGES.
- ALL MILLWORK DOOR AND DRAWER EDGES, EDGES OF CASES, AND ANY MATERIAL VISIBLE THROUGH REVEALS TO BE FINISHED
- TO MATCH EXTERIOR FACES. 10 DOORS TO HAVE CONCEALED SOFT CLOSE HINGES.
- 11 DRAWERS TO BE ON BOTTOM MOUNT, FULL EXTENSION SOFT
- CLOSE SLIDES. 12 DRAWER BOXES TO BE 1/2" SOLID MAPLE WITH DOVETAIL JOINTS.
- 13 ALL DOOR PULLS TO BE H-1
- 14 ALL DRAWER PULLS TO BE H-2 15 FULL HEIGHT CABINET PULLS TO BE H-3
- 16 CONTRACTOR TO PROVIDE MFR'S PRODUCT INFORMATION
- ILLUSTRATING COMPLIANCE WITH CGC 2013 VOC LEVELS. 17 REFER TO K1.0 FOR EQUIPMENT LOCATIONS AND
- INFORMATION

INTERIOR ELEVATION KEYNOTES


PL1 E21

BACK OF HOUSE ELEVATION 1
3/8" = 1'-0"

- E5 NOT USED
- E9 MITER CORNER OF WOOD E10 (E) STOREFRONT SYSTEM AND GLASS TO REMAIN.
- E11 CEILING MOUNTED DEVICE, SEE RCP
- E12 EMERGENCY LIGHT FIXTURE DEVICE, REF. MEP
- E18 MECHANICAL DIFFUSERS, S.M.D.


SANTA CLARA SQUARE BUILDING ONE 2520 AUGUSTINE SQUARE SANTA CLARA, CA 95054

BAREBOTTLE BREW COMPANY

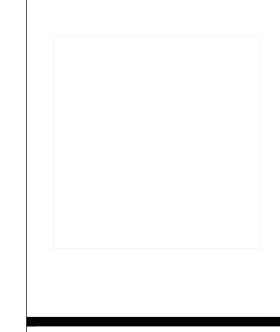

LANDLORD/PERMIT SUBMITTAL SET


INTERIOR ELEVATIONS

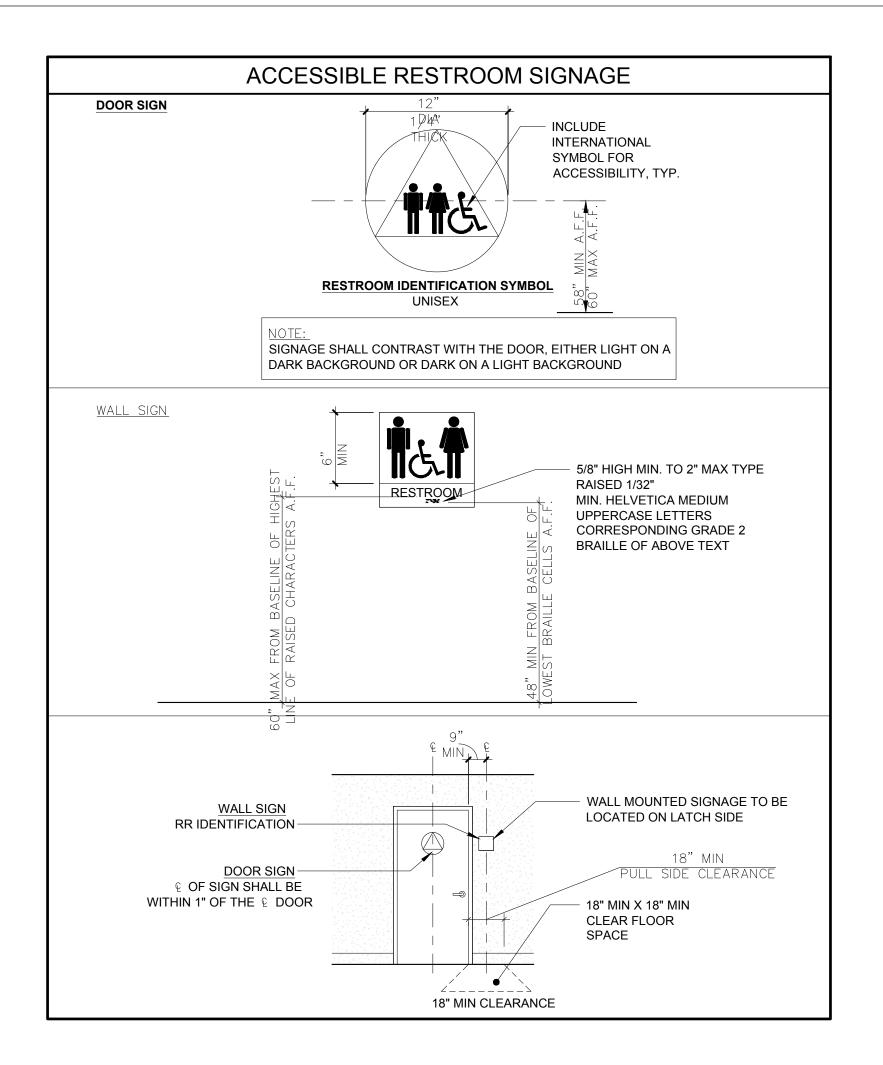



			RESTRO	OOM FIXTURES AND ACCESSORIES
FIXTURE TYPE	DESCRIPTION	MFR	MODEL#	FINISH NOTES
	WATER CLOSET - TANK TYPE, FLOOR MOUNTED	тото	DRAKE II	FLUSH HANDLE AT WIDE SIDE.
P-2	LAVATORY - WALL HUNG	KOHLER	K-2005-R KINGSTON	
P-3	LAVATORY FAUCET	MOEN	8416	CHROME
	BOBRICK B-3942 CLASSIC SERIES SEMI-RECESSED CONVERTIBLE COMBINATION TOWEL AND WASTE UNIT	BOBRICK WASHROOM EQUIPMENT, INC.	B-3942	
P-5	VANITY MIRROR	BOBRICK	B-293 2436	SATIN STAINLESS STEEL MOUNT AT 40" MAX. TO B.O. REFLECTIVE SURFACE OF MIRROR. USE SURFACE MTD. BRACKET FROM MFR. MTG. BRACKET TO BE SECURELY FASTENED TO WALL BACKING TOP AND BOTTOM. (THROUGH TILE AT B.O. BRACKET AND THROUGH SHIM AT T.O. BRACKET). PROVIDE 6" WIDE SHEET METAL BACKING AT TOP & BOTTOM OF MIRROR CENTER VERTICALLY ON MOUNTING BRACKET ANCHOR POINTS. WIDTH TO SPAN & BE ATTACHED TO 3 STUDS MINIMUM AND EXTEND BEYOND EDGE OF MIRROR EACH SIDE.
P-6	TOILET TISSUE DISPENSER	BRADLEY CORP.	5412	
	SOAP DISPENSER - LAVATORY MOUNTED	BOBRICK WASHROOM EQUIPMENT, INC.	B-82316	
P-8	GRAB BARS	BOBRICK	B-5806 x 36; B-5806 x 42	SATIN STAINLESS STEEL
P-9	URINAL	KOHLER	K-4991-ET-0 BARDON	
P-10	TOILET SEAT COVER DISPENSER	BRADLEY CORP.	5847	
P-11	BABY CHANGING TABLE			
P-12	TOILET PARTITIONS	BRADLEY CORP.		STAINLESS STEEL


	_		
			RESTROOM KEYNOTES
		RR1	NOT USED
		RR2	IMPERVIOUS WALL TILE WAINSCOT, SEE FINISH PLAN A2.3 FOR SCHEDULE. TILE IN STACKED BOND PATTERN
		RR3	CONTINUOUS CONCEALED BACKING PLATE AT WALL MOUNTED ITEM. REFER TO SCHEDULED ITEM FOR ADDITIONAL INFORMATION.
		RR4	CONTINUOUS BLACK SHIM BEHIND MIRROR TO MATCH THICKNESS OF TILE. SHIM TO BE RECESSED FROM MIRROR EDGE 2"MIN.
.		RR5	LOCATE WATER VALVES HIGH AND TIGHT TO BOTTOM OF SINK BUT OUTSIDE OF DRAIN SKIRT/SHROUD
T OR.		RR6	ALIGN TOP OF ACCESSORY TO TILE GROUT JOINT SUCH THAT OPERABLE PART IS NO HIGHER THAN 40" AFF.
		RR7	NOT USED
		RR9	ACCESSIBLE INSULATED SAFETY SHROUD AT DRAIN AND SUPPLY PIPES
		RR10	FLUSH VALVE AT WIDE SIDE OF TOILET


R CALIFORNIA PLUMBING CODE CHAPT	ΓER 4		
OCCUPANCY GROUP	TENANT AREA (SF)	OCCUPANT LOAD	OCCUPANTS
ASSEMBLY - OPEN SEATING	1,110 SF	15 NET	74
ASSEMBLY - STANDING	496 SF	5 NET	99.2
COMMERCIAL KITCHEN	327 SF	200 GROSS	2.92
STORAGE	42 SF	300 GROSS	0.14
		TOTAL	177 (176.26) OCCUPANTS (89 MEN 89 WOMEN)
REQUIRED PLUMBING FIXTURES			
WATER CLOSETS REQUIRED: B PER CPC 422.2 FOR WOMEN PER CPC 422.2		WATER CLOSETS PROVIDE 2 (3 IN WOMEN'S RESTRO	
AVATORIES REQUIRED: PER CPC 422.2 *SEE BELOW		LAVATORIES PROVIDED:	

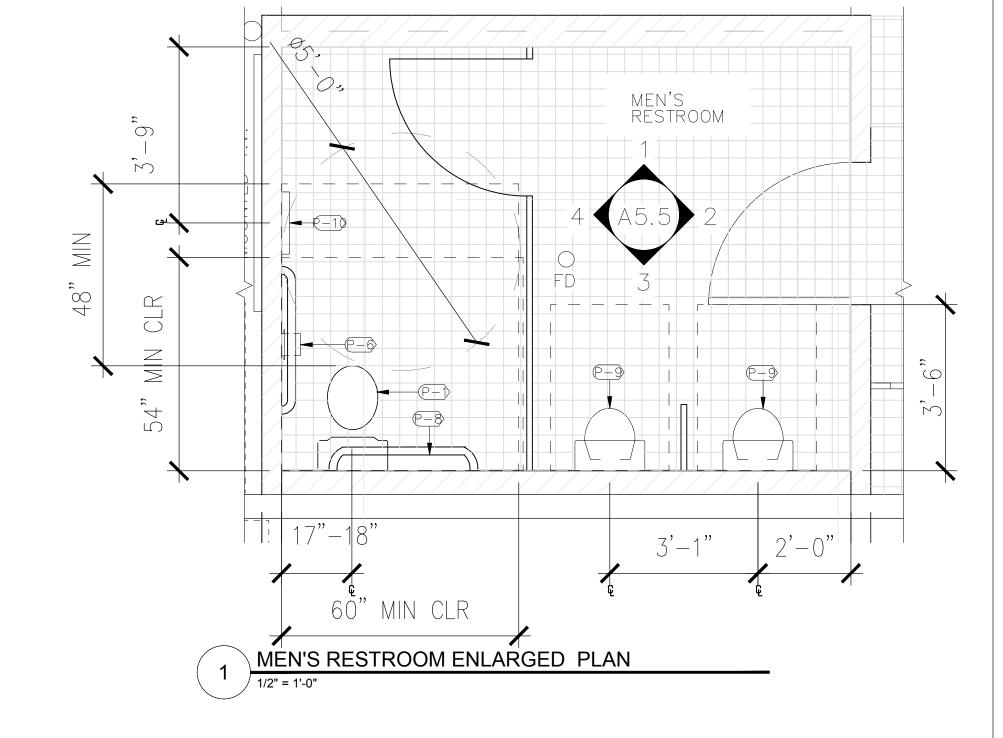

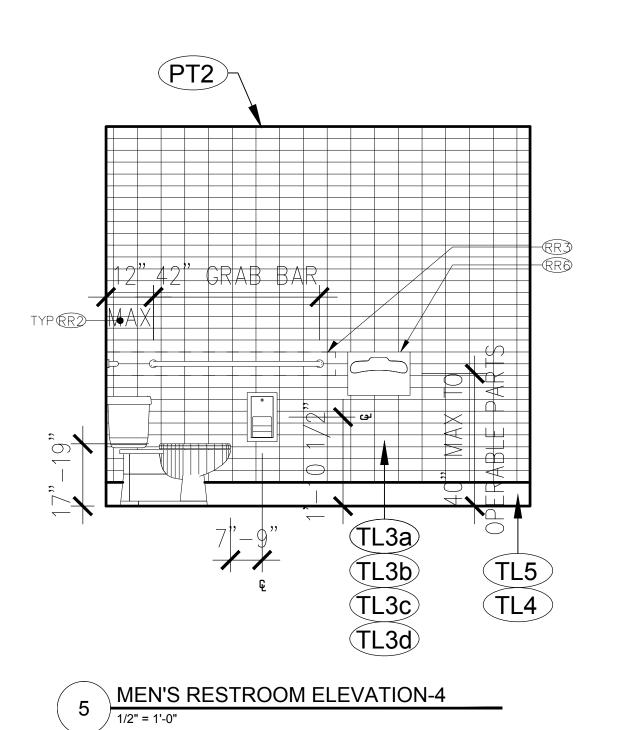

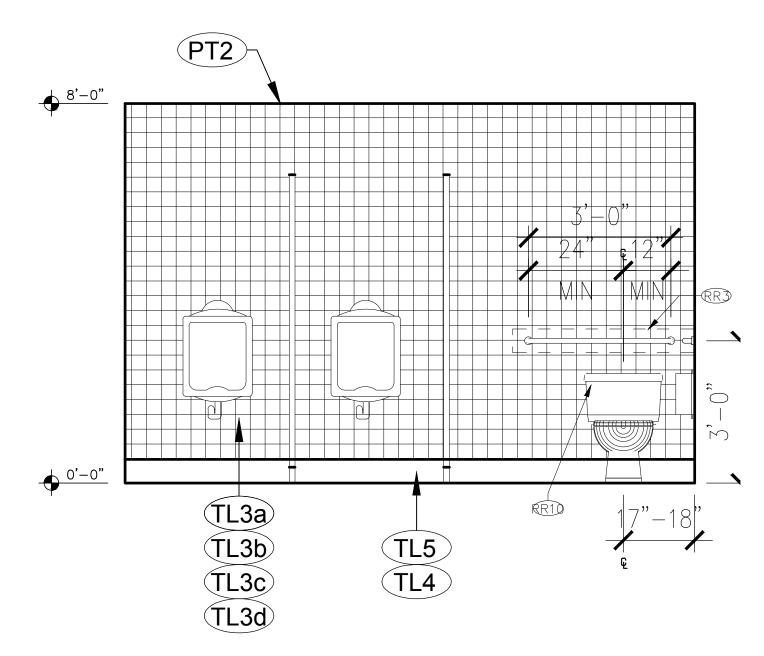

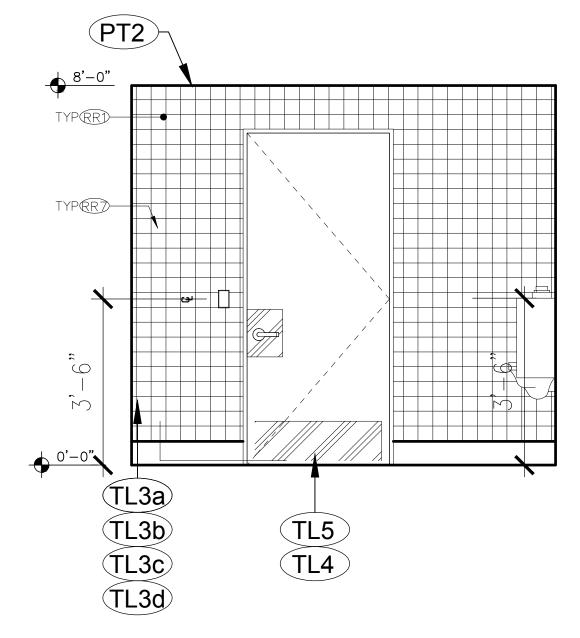

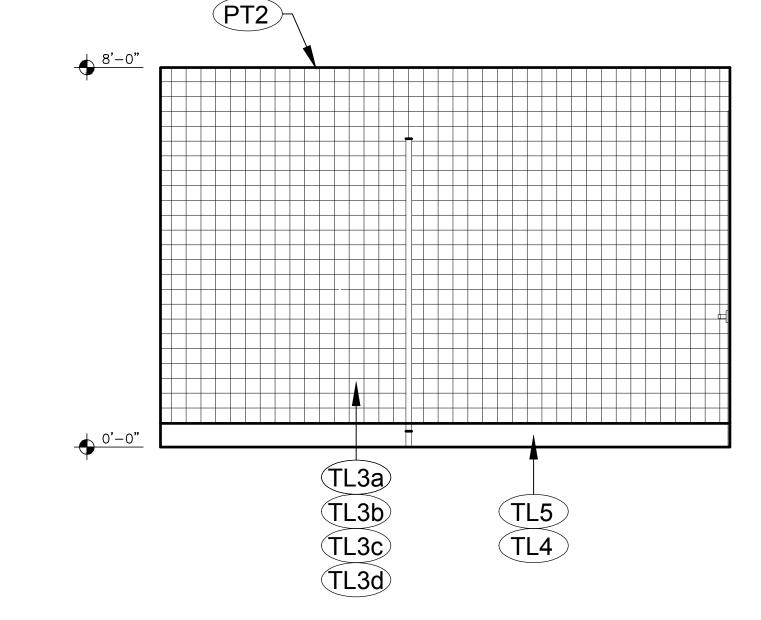

MEN'S RESTROOM ELEVATION-3

1/2" = 1'-0"

3 MEN'S RESTROOM ELEVATION-2

1/2" = 1'-0"

2 MEN'S RESTROOM ELEVATION-1

1/2" = 1'-0"

BAREBOTTLE BREW COMPANY
SANTA CLARA SQUARE
BUILDING ONE
2520 AUGUSTINE SQUARE
SANTA CLARA, CA 95054

ARA SQUARE - BUILDINGONE O AUGUSTINE DRIVE


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SUBMITTAL SET

ACCESSIBLE RESTROOM PLAN & DETAILS SHEET 1 OF 3

A5.5



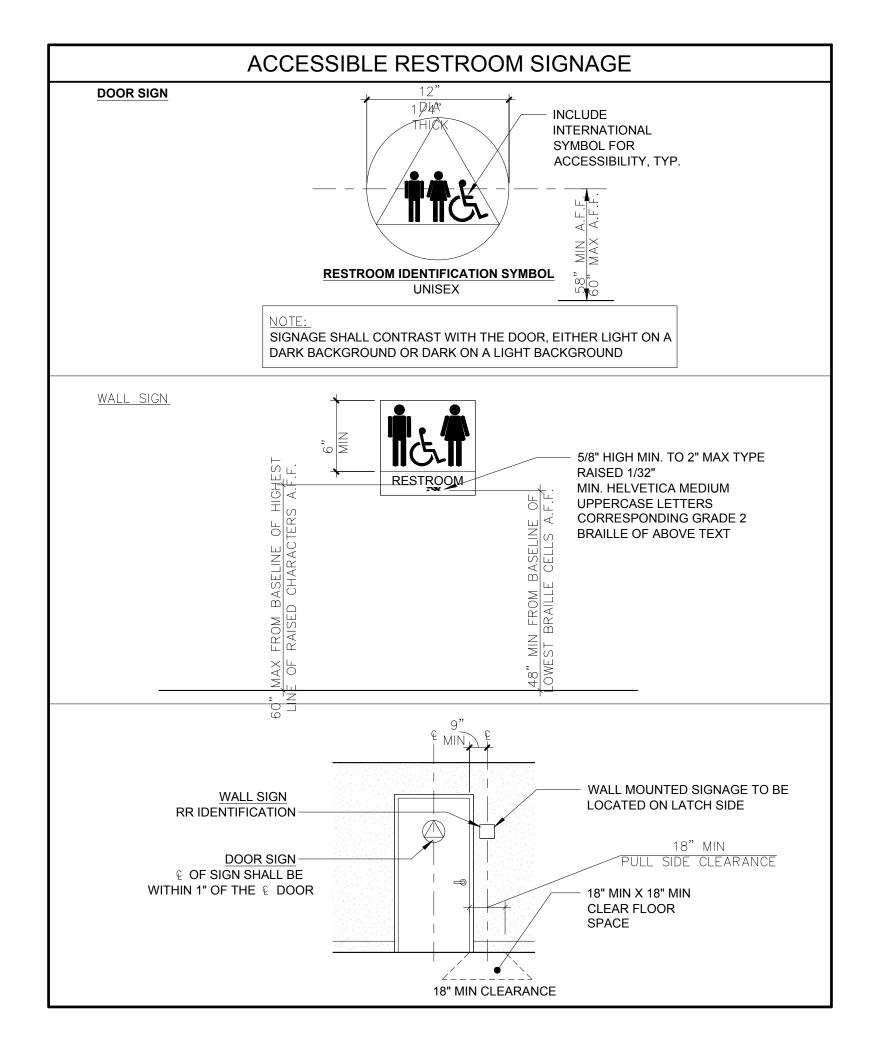



	RESTROOM KEYNOTES
RR′	NOT USED
RR	IMPERVIOUS WALL TILE WAINSCOT, SEE FINISH PLAN A2.3 FOR SCHEDULE. TILE IN STACKED BOND PATTERN
RR	CONTINUOUS CONCEALED BACKING PLATE AT WALL MOUNTED ITEM. REFER TO SCHEDULED ITEM FOR ADDITIONAL INFORMATION.
RR	CONTINUOUS BLACK SHIM BEHIND MIRROR TO MATCH THICKNESS OF TILE. SHIM TO BE RECESSED FROM MIRROR EDGE 2"MIN.
RR	LOCATE WATER VALVES HIGH AND TIGHT TO BOTTOM OF SINK BUT OUTSIDE OF DRAIN SKIRT/SHROUD
RR	ALIGN TOP OF ACCESSORY TO TILE GROUT JOINT SUCH THAT OPERABLE PART IS NO HIGHER THAN 40" AFF.
RR	NOT USED
RRS	ACCESSIBLE INSULATED SAFETY SHROUD AT DRAIN AND SUPPLY PIPES
RR'	0 FLUSH VALVE AT WIDE SIDE OF TOILET


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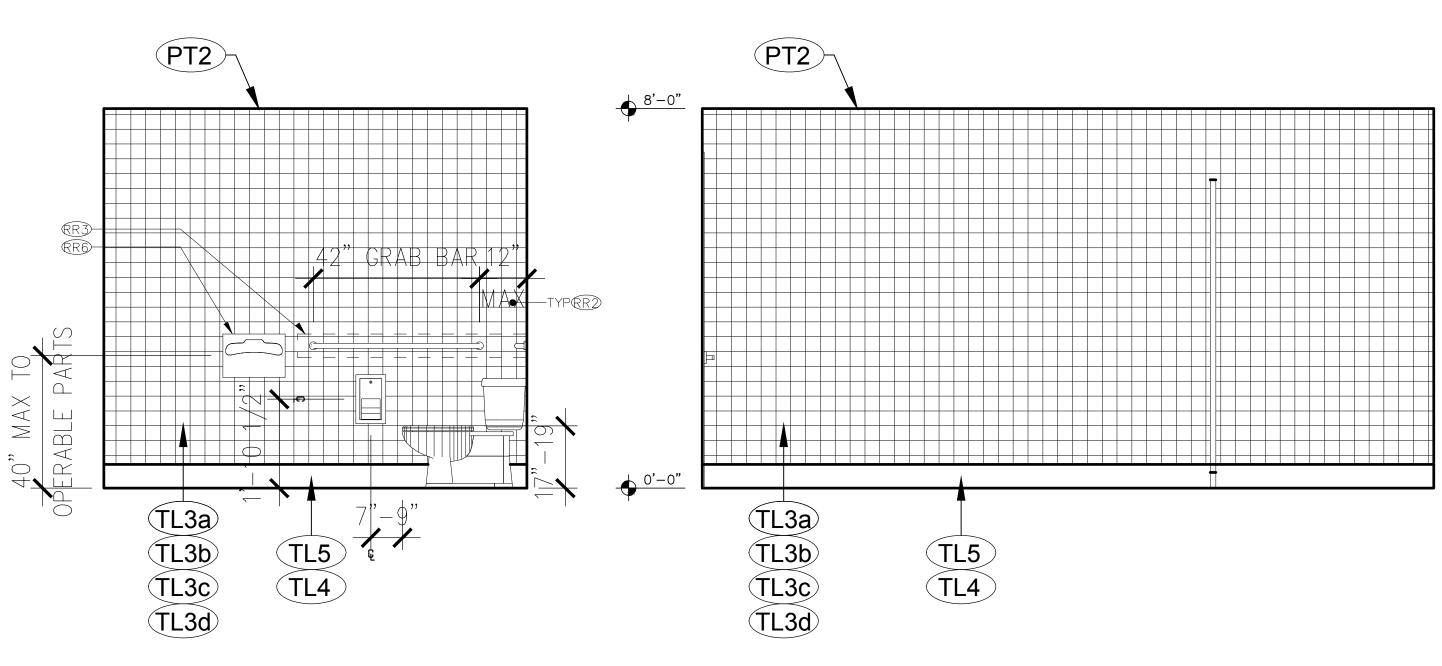
60" MIN CLR

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WOMEN'S RESTROOM ENLARGED PLAN
1/2" = 1'-0"

3 WOMEN'S RESTROOM ELEVATION-2

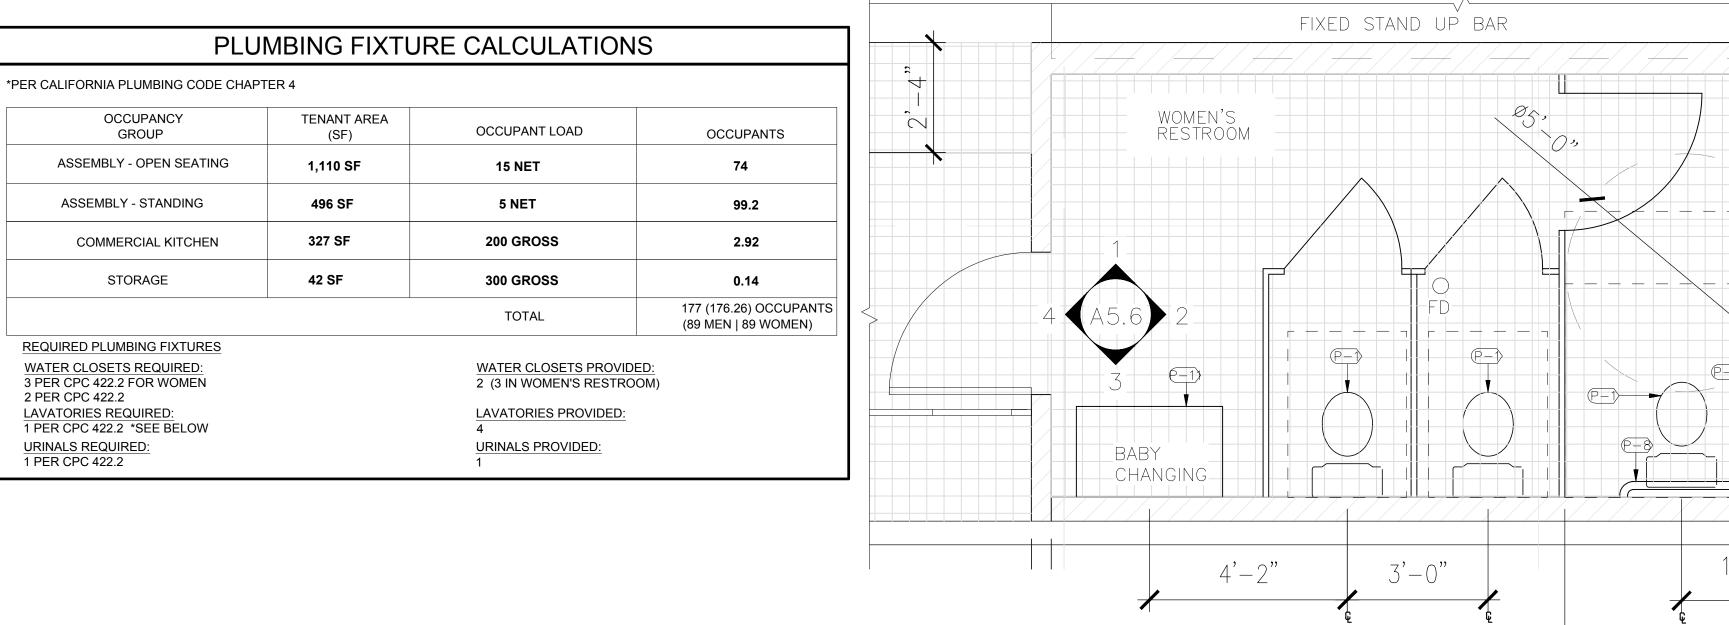2 WOMEN'S RESTROOM ELEVATION-1

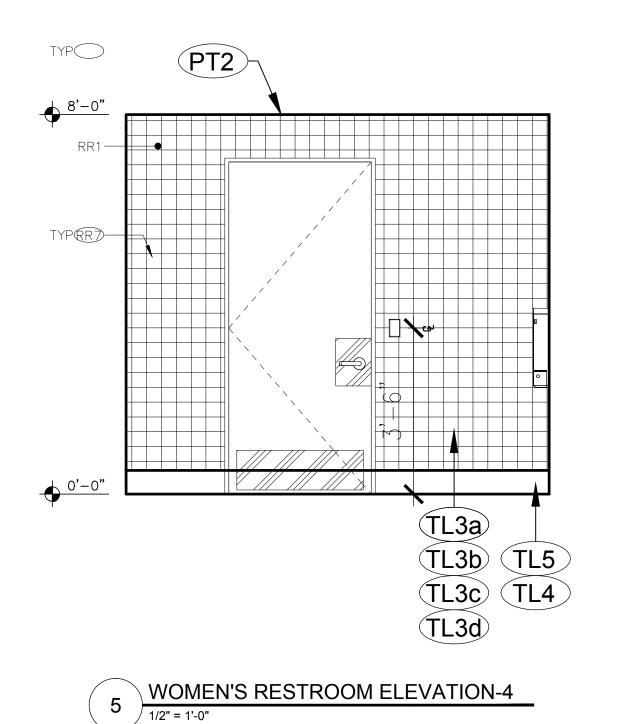TA CLARA SQUARE - BUILDINGONE 2520 AUGUSTINE DRIVE

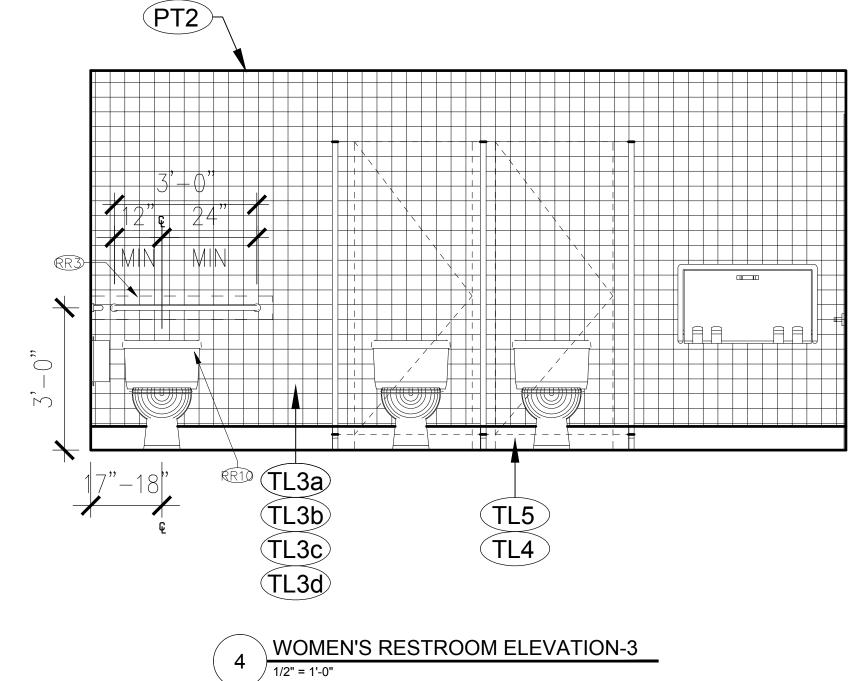BAREBOTTLE BREW COMPANY
SANTA CLARA SQUARE
BUILDING ONE

2520 AUGUSTINE SQUARE SANTA CLARA, CA 95054


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SUBMITTAL SET

ACCESSIBLE RESTROOM PLAN & DETAILS SHEET 2 OF 3


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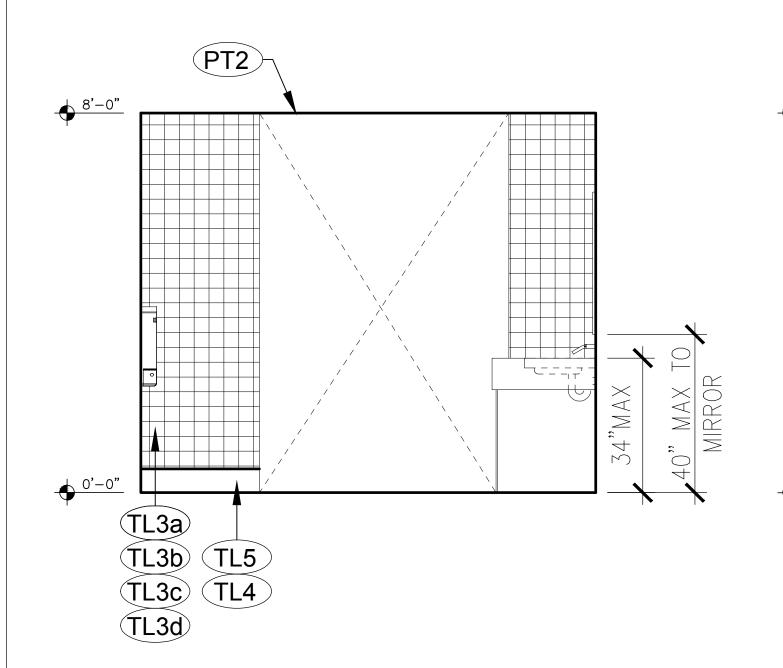


			RESTRO	OM FIXTUR	ES AND ACCESSORIES
FIXTURE TYPE	DESCRIPTION	MFR	MODEL#	FINISH	NOTES
P-1	WATER CLOSET - TANK TYPE, FLOOR MOUNTED	тото	DRAKE II		FLUSH HANDLE AT WIDE SIDE.
P-2	LAVATORY - WALL HUNG	KOHLER	K-2005-R KINGSTON		
P-3	LAVATORY FAUCET	MOEN	8416	CHROME	
P-4	BOBRICK B-3942 CLASSIC SERIES SEMI-RECESSED CONVERTIBLE COMBINATION TOWEL AND WASTE UNIT	BOBRICK WASHROOM EQUIPMENT, INC.	B-3942		
P-5	VANITY MIRROR	BOBRICK	B-293 2436	STEEL	MOUNT AT 40" MAX. TO B.O. REFLECTIVE SURFACE OF MIRROR. USE SURFACE MTD. BRACKET FROM MFR. MTG. BRACKET TO BE SECURELY FASTENED TO WALL BACKING TOP AND BOTTOM. (THROUGH TILE AT B.O. BRACKET AND THROUGH SHIM AT T.O. BRACKET). PROVIDE 6" WIDE SHEET METAL BACKING AT TOP & BOTTOM OF MIRROF CENTER VERTICALLY ON MOUNTING BRACKET ANCHOR POINTS. WIDTH TO SPAN & BE ATTACHED TO 3 STUDS MINIMUM AND EXTEND BEYOND EDGE OF MIRROR EACH SIDE.
P-6	TOILET TISSUE DISPENSER	BRADLEY CORP.	5412		
P-7	SOAP DISPENSER - LAVATORY MOUNTED	BOBRICK WASHROOM EQUIPMENT, INC.	B-82316		
P-8	GRAB BARS	BOBRICK	B-5806 x 36; B-5806 x 42	SATIN STAINLESS STEEL	
- -9	URINAL	KOHLER	K-4991-ET-0 BARDON		
P-10	TOILET SEAT COVER DISPENSER	BRADLEY CORP.	5847		
P-11	BABY CHANGING TABLE				
P-12	TOILET PARTITIONS	BRADLEY CORP.		STAINLESS STEEL	

			RESTROOM KEYNOTES
	1	RR1	NOT USED
		RR2	IMPERVIOUS WALL TILE WAINSCOT, SEE FINISH PLAN A2.3 FOR SCHEDULE. TILE IN STACKED BOND PATTERN
		RR3	CONTINUOUS CONCEALED BACKING PLATE AT WALL MOUNTED ITEM. REFER TO SCHEDULED ITEM FOR ADDITIONAL INFORMATION.
		RR4	CONTINUOUS BLACK SHIM BEHIND MIRROR TO MATCH THICKNESS OF TILE. SHIM TO BE RECESSED FROM MIRROR EDGE 2"MIN.
G.		RR5	LOCATE WATER VALVES HIGH AND TIGHT TO BOTTOM OF SINK BUT OUTSIDE OF DRAIN SKIRT/SHROUD
T OR.		RR6	ALIGN TOP OF ACCESSORY TO TILE GROUT JOINT SUCH THAT OPERABLE PART IS NO HIGHER THAN 40" AFF.
3		RR7	NOT USED
		RR9	ACCESSIBLE INSULATED SAFETY SHROUD AT DRAIN AND SUPPLY PIPES
		RR10	FLUSH VALVE AT WIDE SIDE OF TOILET

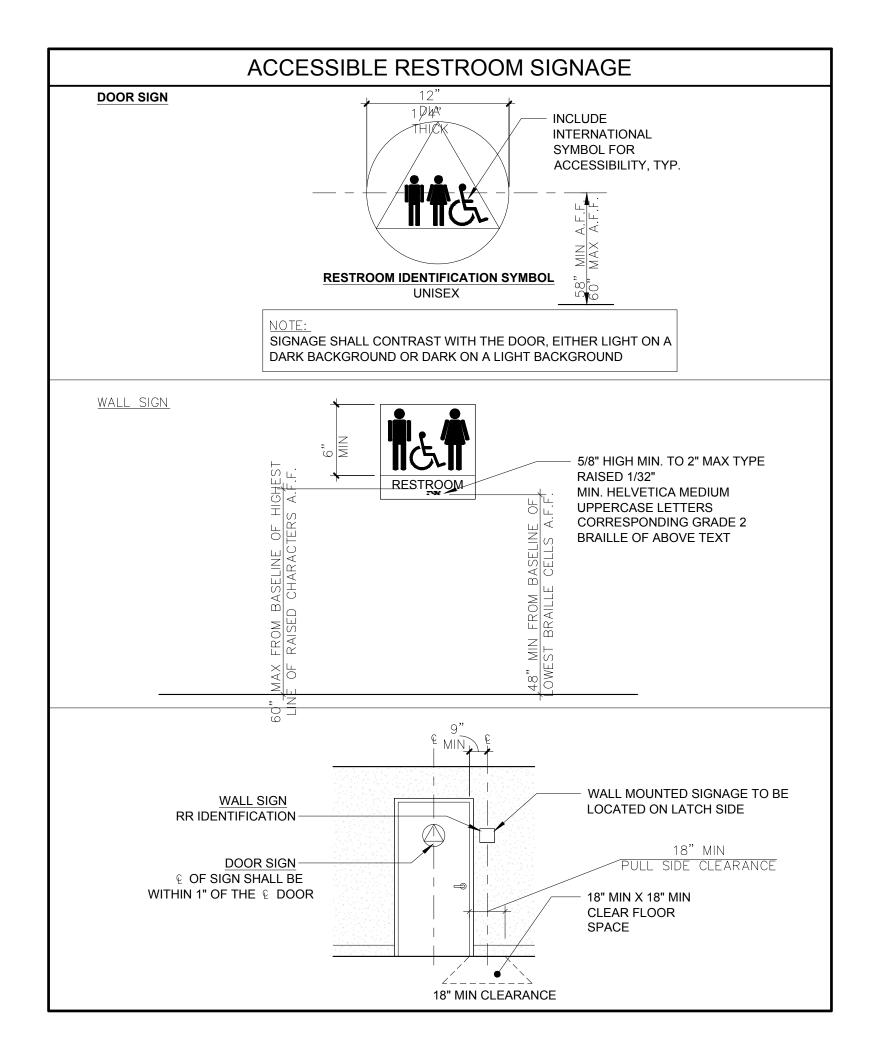
PLUN	IBING FIXTU	JRE CALCULATION	S
*PER CALIFORNIA PLUMBING CODE CHAPTE	ER 4		
OCCUPANCY GROUP	TENANT AREA (SF)	OCCUPANT LOAD	OCCUPANTS
ASSEMBLY - OPEN SEATING	1,110 SF	15 NET	74
ASSEMBLY - STANDING	496 SF	5 NET	99.2
COMMERCIAL KITCHEN	327 SF	200 GROSS	2.92
STORAGE	42 SF	300 GROSS	0.14
		TOTAL	177 (176.26) OCCUPANTS (89 MEN 89 WOMEN)
REQUIRED PLUMBING FIXTURES WATER CLOSETS REQUIRED: 3 PER CPC 422.2 FOR WOMEN 2 PER CPC 422.2 LAVATORIES REQUIRED: 1 PER CPC 422.2 *SEE BELOW URINALS REQUIRED: 1 PER CPC 422.2		WATER CLOSETS PROVIDIDE 2 (3 IN WOMEN'S RESTRO LAVATORIES PROVIDED: 4 URINALS PROVIDED: 1	




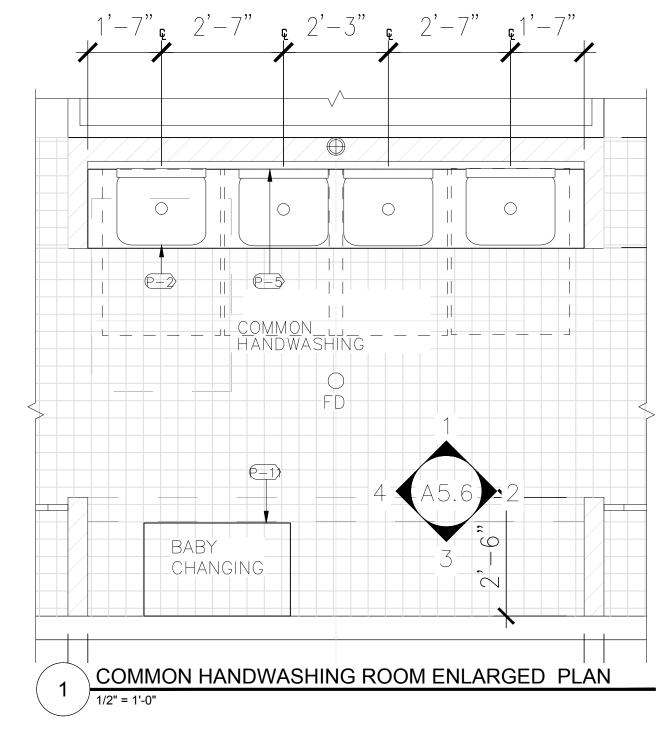


5 COMMON HANDWASHING ROOM ELEVATION-4

1/2" = 1'-0"

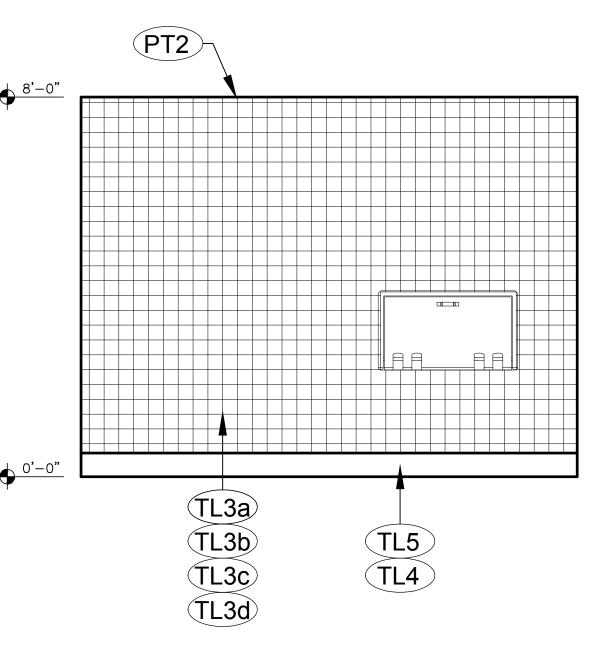

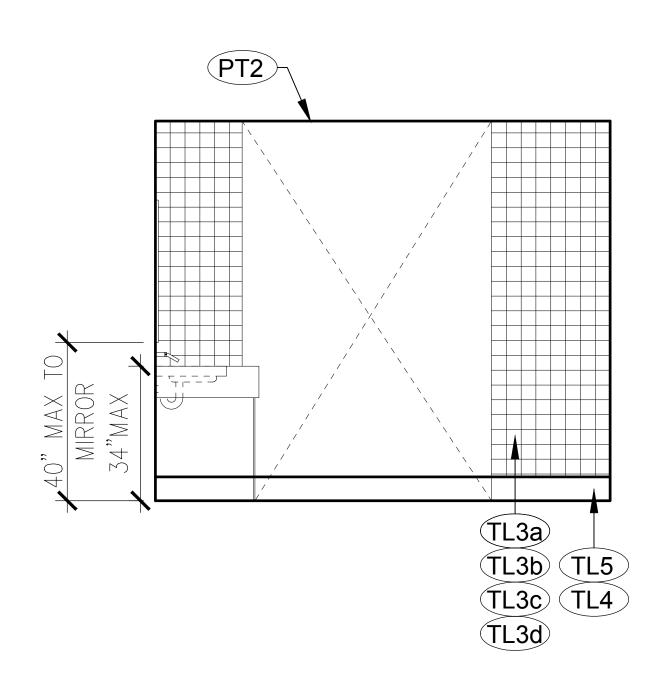

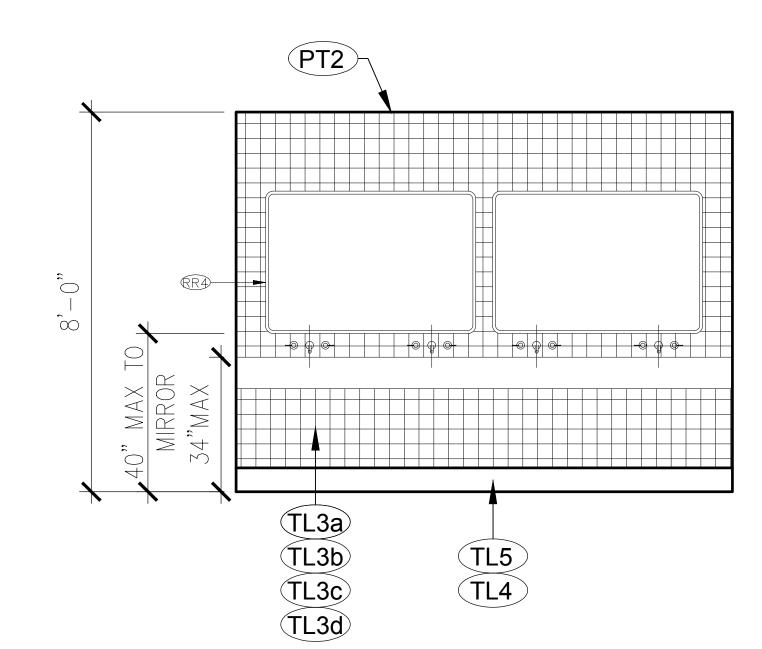

4 COMMON HANDWASHING ROOM ELEVATION-3

1/2" = 1'-0"

3 COMMON HANDWASHING ROOM ELEVATION-2

2 COMMON HANDWASHING ROOM ELEVATION-1

BOTTLE BEN UNARE - BUILDINGONE USTINE DRIVE

BAREBOTTLE BREW COMPANY
SANTA CLARA SQUARE
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ACCESSIBLE RESTROOM PLAN & DETAILS SHEET 3 OF 3

A5.7

			EQUIPN	MENT SCHEDULE	
ITEM	QTY	DESCRIPTION	MANUFACTURER	MODEL	COMMENTS
EQ-01	2	POINT OF SALE			BY OWNER
EQ-02	1	STAINLESS STEEL POS UNDER-COUNTER UNIT	BY G.C.	CUSTOM FAB.	CUSTOM FAB. S/S OPEN CABINET W/ ADJUSTABLE SHELVES
EQ-03	1	DECK MOUNTED GLASS FILLER	ENCORE	KL26-5012-SP	TO BE COORDINATED WITH MEP
	1	WATER TAP DRIP PAN	T&S BRASS AND BRONZE	B-1231	COORDINATE WITH MILLWORK & EQ-03. PROVIDE RECESSED CUSTOM STAINLESS DRIP PAN.
EQ-04	1	WATER FILTRATION	HOSHIZAKI	TRIPLE CONFIGURATION	
EQ-05	3	HAND SINK W/ SIDE SPLASHES	GSW	HS-1615SS	
EQ-06	7	PAPER TOWEL DISPENSER	BOBRICK	B-262	
EQ-07	7	SOAP DISPENSER	BOBRICK	B-2111	
EQ-08	1	BAR DUMP SINK	BY G.C.	CUSTOM FAB	CUSTOM FAB. S/S COUNTERTOP WITH INTEGRAL HANDSINK. PROVIDE 2-1/2" BACK SPLASH
EQ-09	2	DRAFT TAP			BY OWNER
EQ-10	3	GLASS RINSER	ADVANCE TABCO	COUNTERTOP	
EQ-11	1	WALK-IN	NORLAKE	KLB	CUSTOM SIZE
EQ-12	1	WALK-IN CONDENSER	TURBO AIR	SEE MEP DRAWINGS	SEE MEP DRAWINGS
EQ-13	1	UNIT COOLER	TURBO AIR	SEE MEP DRAWINGS	SEE MEP DRAWINGS
EQ-14	1	SUPER ERECTA WIRE SHELVING	METRO SHELVING	VARIES	VARIOUS SIZES
EQ-15	8	SUPER ERECTA WIRE SHELVING	METRO SHELVING	VARIES	VARIOUS SIZES
EQ-16	1	UNDER COUNTER ICE MACHINE	MANITOWOC NEO	VARIES	SEE MEP DRAWINGS
EQ-17	15	PLASTIC TRASH BINS	RUBBERMAID	H-1385	23 GALLON SIZE
EQ-18	1	EMPLOYEE LOCKER	NEXEL	12X15X24 ASSEMBLED	
EQ-19	5	SUPER ERECTA WIRE SHELVING	METRO SHELVING	VARIES	VARIOUS SIZES
EQ-20	1	WATER HEATER	BY G.C.	BY G.C.	SEE MEP DRAWINGS
EQ-21	1	STAINLESS STEEL 3-COMPARTMENT SINK W/ DRAINBOARD	BY G.C.	CUSTOM FAB.	
EQ-22	6	SUPER ERECTA WIRE SHELVING	BY G.C.	CUSTOM FAB.	SIZE VARIES, SEE INTERIOR ELEVATIONS - G.C. TO PROVIDE WALL BACKING AS NECESSARY
EQ-23	2	STAINLESS STEEL WORK TABLE W/ UNDERSHELF	BY G.C.	CUSTOM FAB.	SIZE VARIES - SEE PLAN
EQ-24	1	COFFEE GRINDER	MAHLKONIG	EK43	
EQ-25	1	POTABLE WATER HEATER	BUNN	H5X ELEMENT WHITE	
EQ-26	1	COFFEE MACHINE	BUNN	DUAL SH DBC(33500.0000)	
EQ-28	1	CONVECTION OVEN	CADCO	OV-003, OV-013, OV-023	
EQ-30	1	DISH SANITIZER	HOBART	LXe SERIES	FOR SUPPLY CONNECTIONS, USE COPPER WIRE ONLY RATED AT 90°C MINIMUM
EQ-31	1	MOP SINK	ZURN	1996-24	
EQ-32	1	MOP SINK FAUCET	FIAT	830-AA	
EQ-33	1	MOP SINK SHELF	ADVANCE TABCO		CONTRACTOR TO PROVIDE WALL-MOUNTED RACK AND CHEMICAL SHELF ABOVE MOP SINK
EQ-34	1	SAFE			BY OWNER
EQ-35	1	PING PONG TABLE			BY OWNER
EQ-36	1	SHUFFLEBOARD			BY OWNER

HEALTH DEPARTMENT NOTES

- 1. ALL COUNTERS TO BE LIGHT COLORED AND FINISHED INSIDE AND OUTSIDE WITH NON-ABSORBENT MATERIAL WHICH IS SMOOTH AND CLEANABLE
- 2. ALL WALLS IN ALL ROOMS SHALL BE OF A DURABLE, SMOOTH, NON-ABSORBENT AND EASILY CLEANABLE SURFACE (PAINTED, CONCRETE BLOCK IS NOT ALLOWED)
- 3. ALL WALLS BEHIND SINKS MUST BE PROTECTED WITH AT WATER RESISTANT MATERIAL MEASURED FROM THE TOP OF COVE BASE UP.
- 4. WATER HEATER BASE TO BE ELEVATED AT LEAST 6-INCHES ABOVE THE FINISHED FLOOR ON A STAND OR COVED CURB.
- 5. SURFACE MOUNTED PIPING IS NOT ACCEPTABLE. PIPING AND CONDUITS OF ALL TYPES

UNCOVERED FOOD OR UTENSILS MUST BE SHATTER-RESISTANT AND CLEANABLE.

- MUST BE CONCEALED WITHIN WALLS, FLOORS AND CEILINGS.
- 7. VERTICAL SNEEZE GUARDS MUST EXTEND TO A HEIGHT OF AT LEAST 60-INCHES ABOVE THE FINISHED FLOOR.
- 8. ALL HAND SINKS TO HAVE PERMANENTLY MOUNT SOAP & TOWEL DISPENSERS.
- 9. THE TOILET ROOM MUST BE EQUIPPED WITH THE FOLLOWING: A) PERMANENTLY INSTALLED SOAP AND PAPER TOWEL DISPENSERS B) TOILET TISSUE DISPENSER C) VENTILATION TO THE OUTSIDE AIR THROUGH A LIGHT-SWITCH
- ACTIVATED EXHAUST FAN D) SELF-CLOSING DOOR

E) HAND WASH SINK WITH HOT/COLD COMBINATION WATER FAUCET

- 10. SEE SHEET P-2 FOR ALL PLUMBING AND WASTE CONNECTIONS.
- 11. SUFFICIENT NATURAL OR ARTIFICIAL LIGHTING SHALL BE PROVIDED TO PRODUCE THE FOLLOWING LIGHT INTENSITY, WHILE THE AREA IS IN USE: -AT LEAST 10-FOOT CANDLE AT A DISTANCE OF 30 INCHES ABOVE THE FLOOR, IN DRY
 - FOOD STORAGE AREAS. -AT LEAST 20-FOOT CANDLES FOR THE FOLLOWING:
 - -AT A SURFACE WHERE FOOD IS PROVIDED FOR CONSUMER SELF-SERVICE OR WHERE FRESH PRODUCE OR PREPACKAGED FOODS ARE SOLD OR OFFERED FOR CONSUMPTION. -INSIDE EQUIPMENT SUCH AS REACH-IN AND UNDER-COUNTER REFRIGERATORS. -AT A DISTANCE OF 30 INCHES ABOVE THE FLOOR IN AREAS USED FOR HANDWASHING, WAREWASHING, AND EQUIPMENT AND UTENSIL STORAGE, AND IN TOILET ROOMS.


- 12. ALL FOOD SERVICE AND RELATED EQUIPMENT SHALL BE NATIONAL SANITATION FOUNDATION (NSF) APPROVED AND IN CONFORMITY WITH LOCAL HEALTH REGULATIONS. INSTALLATION OF EQUIPMENT SHALL MEET SAME REQUIREMENTS. ALL REFRIGERATION SHALL MEET NSF-CHAPTER7 REQUIREMENTS.
- 13. ALL ADJOINING EQUIPMENT AND COUNTER SHALL BE SEALED TOGETHER TO PREVENT THE ENTRANCE OF MOISTURE, SPLASH, GREASE, INSECTS, ETC. ALL EQUIPMENT, INCLUDING SHELVING, SHALL BE SMOOTHLY SEALED TO THE WALL TO PREVENT THE ENTRANCE OF SPLASH AND DEBRIS. ALL PORTABLE OR FREE STANDING UNITS SHALL BE REMOVABLE AND EASILY ACCESSIBLE FOR CLEANING.
- 14. ALL REFRIGERATION EQUIPMENT AND EQUIPMENT FOR HOT STORAGE SHALL HAVE THERMOMETERS WHICH ARE EASILY READABLE IN PROPER WORKING CONDITIONS.
- 6. LIGHT FIXTURES, INCLUDING PENDANT, RECESSED AND TRACK LIGHTING, LOCATED OVER 15. STORAGE SHELVING MUST BE SPECIFIED AS HAVING A SMOOTH, NON-ABSORBENT FINISH. THE LOWEST SHELF TO BE 6 INCHES ABOVE THE FLOOR.
 - 16. A SEPARATE WALL-MOUNTED HANDWASH SINK IS REQUIRED WITHIN OR ADJACENT TO THE FOOD PREPARATION AND PACKAGING AREA. PROVIDE PERMANENTLY MOUNTED SINGLE-SERVICE SOAP AND PAPER TOWEL DISPENSERS.
 - 17. ALL SINKS TO BE PROVIDED WITH ADEQUATE HOT AND COLD WATER FROM MIXING FAUCETS.
 - 18. THE JUNCTURE AT THE FLOOR AND WALL, IN FOOD PREPARATION, COOKING AND SERVICE AREAS, MUST HAVE A COVED BASE WITH AT LEAST A 3/8 INCH RADIUS AND EXTENDING AT LEAST 6 INCHES UP THE WALL. IF TOP SET COVING IS USED, IT MUST BE ADEQUATELY SEALED AT THE FLOOR WITH SILICONE SEALANT OR EQUIVALENT TO FORM WATERPROOF SEAL.
 - 19. PROVIDE AUTOMATIC DOOR CLOSURES ON ALL ENTRY AND DELIVERY ROOM DOORS.
 - 20. BUILDING SHALL BE INSECT AND RODENT PROOF, INCLUDING EXTERIOR DOOR WHICH MUST COME WITHIN 1/4 INCH OF FLOOR. ALL VENTS AND OTHER OPENINGS TO OUTSIDE NEED TO BE SEALED OR SCREENED.
 - 21. REFUSE CONTAINERS SHALL BE MOISTURE AND VERMIN PROOF WITH TIGHT FITTING LIDS.
 - 22. ANY TRASH AND GARBAGE STORAGE AREA RECEIVING FOOD WASTE OR FOOD CONTAINERS, WILL HAVE A WATER BIB TO FACILITATE CLEANING. FLOOR, WALL AND CEILING WILL BE SMOOTH AND CLEANABLE, RECOMMEND HOT AND COLD WATER BIBS BE AVAILABLE FOR CLEANING. WASTE WATER FROM SUCH CLEANING OPERATIONS MUST BE DISPOSED OF AS SEWAGE THROUGH A FLOOR DRAIN IN THE TRASH ENCLOSURE OR THE EQUIVALENT.

SEE ADDITIONAL NOTES PER PLANS.

EQUIPMENT PLAN KEYNOTES K1 (N) COFFEE FIXING STATIONS (MILK, SUGAR, ETC.) K2 (N) ELECTRICAL PANEL K3 (N) FLOOR DRAIN, S.P.D. K7 (N) CO2 SENSOR K10 S.P.D. FOR GREASE TRAP INFORMATION. K11 (N) MILLWORK COUNTER AND UPPER SHELVES, SEE ELEVATION. K12 (N) FLOOR SINK, S.P.D. K13 REFER TO ENLARGED RESTROOM PLANS AND ELEVATIONS FOR PLUMBING FIXTURES AND ACCESSORIES K14 WATER HEATER PLATFORM ABOVE MOP SINK. PROVIDE SEISMIC STUD TO WALL FRAMING K15 (N)110 V OUTLETS K16 (N)TRAY DRAIN K17 (N)GLASS RINSER

EQUIPMENT PLAN GENERAL NOTES

- 1. REVIEW ALL (N) EQUIPMENT DIMENSIONS & FLOOR CLEARANCES WITH OWNER PRIOR TO FINAL FRAMING.
- 2. VERIFY ALL EQUIPMENT ROUGH-IN REQUIREMENTS WITH MANUFACTURER SPECIFICATIONS AND CUT SHEETS
- 3. REFER TO ACCESSIBILITY REQUIREMENTS ON SHEETS A0.2 FOR MOUNTING HEIGHT REQUIREMENTS.
- 4. SOUND SYSTEM, TV, POS STATIONS AND ALL OTHER ELECTRONIC EQUIPMENT BY OWNER U.O.N.
- 5. STORE ALL PRODUCTS 6" MIN. OFF THE FLOOR ON NSF APPROVED SHELVING.
- 6. GENERAL CONTRACTOR TO VERIFY ALL ROUGH-IN PLUMBING & ELECTRICAL LOCATIONS PRIOR TO CLOSING WALLS.
- 7. EQUIPMENT POWER AND PLUG TYPE MAY VARY WITH FINAL EQUIPMENT SELECTION. CONTRACTOR TO REVIEW OUTLET REQUIREMENTS WITH EQUIPMENT SUPPLIER PRIOR TO INSTALLATION.

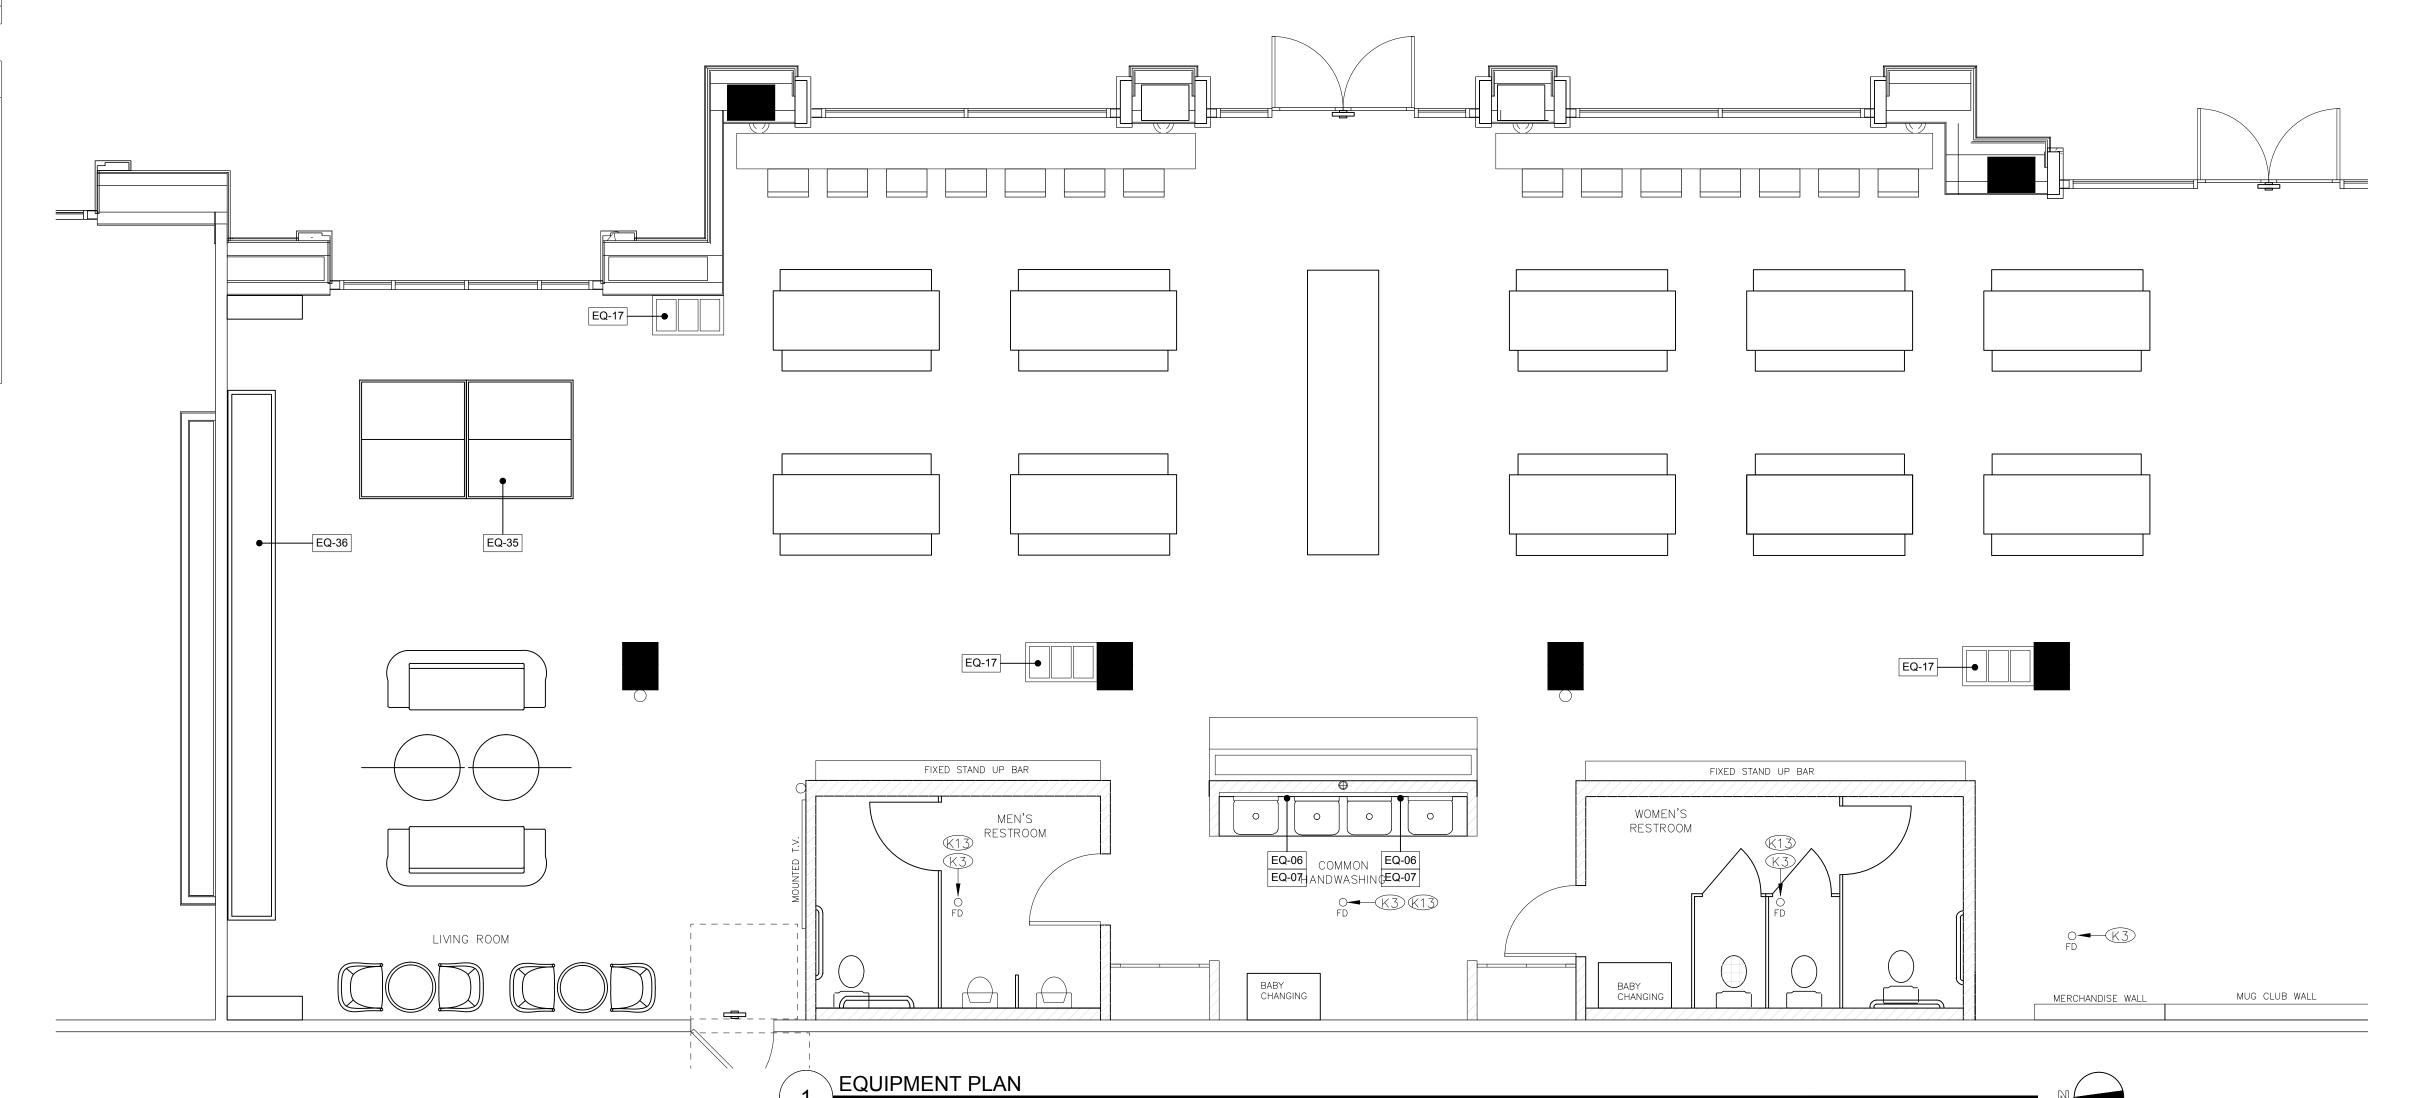

BAREBOTTLE BREW COMPANY SANTA CLARA SQUARE BUILDING ONE 2520 AUGUSTINE SQUARE SANTA CLARA, CA 95054

SUBMITTAL/REVISIONS LANDLORD/PERMIT 12/21/18 SUBMITTAL SET

> EQUIPMENT PLAN, SCHEDULE & NOTES

			EQUIPM	IENT SCHEDULE	
ITEM	QTY	DESCRIPTION	MANUFACTURER	MODEL	COMMENTS
EQ-01	2	POINT OF SALE			BY OWNER
EQ-02	1	STAINLESS STEEL POS UNDER-COUNTER UNIT	BY G.C.	CUSTOM FAB.	CUSTOM FAB. S/S OPEN CABINET W/ ADJUSTABLE SHELVES
EQ-03	1	DECK MOUNTED GLASS FILLER	ENCORE	KL26-5012-SP	TO BE COORDINATED WITH MEP
	1	WATER TAP DRIP PAN	T&S BRASS AND BRONZE	B-1231	COORDINATE WITH MILLWORK & EQ-03. PROVIDE RECESSED CUSTOM STAINLESS DRIP PAN.
EQ-04	1	WATER FILTRATION	HOSHIZAKI	TRIPLE CONFIGURATION	
EQ-05	3	HAND SINK W/ SIDE SPLASHES	GSW	HS-1615SS	
EQ-06	7	PAPER TOWEL DISPENSER	BOBRICK	B-262	
EQ-07	7	SOAP DISPENSER	BOBRICK	B-2111	
EQ-08	1	BAR DUMP SINK	BY G.C.	CUSTOM FAB	CUSTOM FAB. S/S COUNTERTOP WITH INTEGRAL HANDSINK. PROVIDE 2-1/2" BACK SPLASH
EQ-09	2	DRAFT TAP			BY OWNER
EQ-10	3	GLASS RINSER	ADVANCE TABCO	COUNTERTOP	
EQ-11	1	WALK-IN	NORLAKE	KLB	CUSTOM SIZE
EQ-12	1	WALK-IN CONDENSER	TURBO AIR	SEE MEP DRAWINGS	SEE MEP DRAWINGS
EQ-13	1	UNIT COOLER	TURBO AIR	SEE MEP DRAWINGS	SEE MEP DRAWINGS
EQ-14	1	SUPER ERECTA WIRE SHELVING	METRO SHELVING	VARIES	VARIOUS SIZES
EQ-15	8	SUPER ERECTA WIRE SHELVING	METRO SHELVING	VARIES	VARIOUS SIZES
EQ-16	1	UNDER COUNTER ICE MACHINE	MANITOWOC NEO	VARIES	SEE MEP DRAWINGS
EQ-17	15	PLASTIC TRASH BINS	RUBBERMAID	H-1385	23 GALLON SIZE
EQ-18	1	EMPLOYEE LOCKER	NEXEL	12X15X24 ASSEMBLED	
EQ-19	5	SUPER ERECTA WIRE SHELVING	METRO SHELVING	VARIES	VARIOUS SIZES
EQ-20	1	WATER HEATER	BY G.C.	BY G.C.	SEE MEP DRAWINGS
EQ-21	1	STAINLESS STEEL 3-COMPARTMENT SINK W/ DRAINBOARD	BY G.C.	CUSTOM FAB.	
EQ-22	6	SUPER ERECTA WIRE SHELVING	BY G.C.	CUSTOM FAB.	SIZE VARIES, SEE INTERIOR ELEVATIONS - G.C. TO PROVIDE WALL BACKING AS NECESSARY
EQ-23	2	STAINLESS STEEL WORK TABLE W/ UNDERSHELF	BY G.C.	CUSTOM FAB.	SIZE VARIES - SEE PLAN
EQ-24	1	COFFEE GRINDER	MAHLKONIG	EK43	
EQ-25	1	POTABLE WATER HEATER	BUNN	H5X ELEMENT WHITE	
EQ-26	1	COFFEE MACHINE	BUNN	DUAL SH DBC(33500.0000)	
EQ-28	1	CONVECTION OVEN	CADCO	OV-003, OV-013, OV-023	
EQ-30	1	DISH SANITIZER	HOBART	LXe SERIES	FOR SUPPLY CONNECTIONS, USE COPPER WIRE ONLY RATED AT 90°C MINIMUM
EQ-31	1	MOP SINK	ZURN	1996-24	
EQ-32	1	MOP SINK FAUCET	FIAT	830-AA	
EQ-33	1	MOP SINK SHELF	ADVANCE TABCO		CONTRACTOR TO PROVIDE WALL-MOUNTED RACK AND CHEMICAL SHELF ABOVE MOP SINK
EQ-34		SAFE			BY OWNER
EQ-35	1	PING PONG TABLE			BY OWNER
EQ-36	1	SHUFFLEBOARD			BY OWNER

K1 (N) COFFEE FIXING STATIONS (MILK, SUGAR, ETC.) K2 (N) ELECTRICAL PANEL K3 (N) FLOOR DRAIN, S.P.D. K7 (N) CO2 SENSOR K10 S.P.D. FOR GREASE TRAP INFORMATION. K11 (N) MILLWORK COUNTER AND UPPER SHELVES, SEE ELEVATION. K12 (N) FLOOR SINK, S.P.D. K13 REFER TO ENLARGED RESTROOM PLANS AND ELEVATIONS FOR PLUMBING FIXTURES AND ACCESSORIES K14 WATER HEATER PLATFORM ABOVE MOP SINK. PROVIDE SEISMIC
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K11 (N) MILLWORK COUNTER AND UPPER SHELVES, SEE ELEVATION. K12 (N) FLOOR SINK, S.P.D. K13 REFER TO ENLARGED RESTROOM PLANS AND ELEVATIONS FOR PLUMBING FIXTURES AND ACCESSORIES
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PLUMBING FIXTURES AND ACCESSORIES
K14 WATER HEATER PLATFORM ABOVE MOP SINK, PROVIDE SEISMIC
STUD TO WALL FRAMING
K15 (N)110 V OUTLETS
K16 (N)TRAY DRAIN
K17 (N)GLASS RINSER

EQUIPMENT PLAN GENERAL NOTES


- 1. REVIEW ALL (N) EQUIPMENT DIMENSIONS & FLOOR CLEARANCES WITH OWNER PRIOR TO FINAL FRAMING.
- 2. VERIFY ALL EQUIPMENT ROUGH-IN REQUIREMENTS WITH MANUFACTURER SPECIFICATIONS AND CUT SHEETS
- 3. REFER TO ACCESSIBILITY REQUIREMENTS ON SHEETS
- A0.2 FOR MOUNTING HEIGHT REQUIREMENTS. 4. SOUND SYSTEM, TV, POS STATIONS AND ALL OTHER ELECTRONIC
- EQUIPMENT BY OWNER U.O.N. 5. STORE ALL PRODUCTS 6" MIN. OFF THE FLOOR ON NSF APPROVED
- SHELVING. 6. GENERAL CONTRACTOR TO VERIFY ALL ROUGH-IN PLUMBING &
- ELECTRICAL LOCATIONS PRIOR TO CLOSING WALLS. 7. EQUIPMENT POWER AND PLUG TYPE MAY VARY WITH FINAL EQUIPMENT SELECTION. CONTRACTOR TO REVIEW OUTLET REQUIREMENTS WITH EQUIPMENT SUPPLIER PRIOR TO INSTALLATION.

HEALTH DEPARTMENT NOTES

- 1. ALL COUNTERS TO BE LIGHT COLORED AND FINISHED INSIDE AND OUTSIDE WITH NON-ABSORBENT MATERIAL WHICH IS SMOOTH AND CLEANABLE
- 2. ALL WALLS IN ALL ROOMS SHALL BE OF A DURABLE, SMOOTH, NON-ABSORBENT AND EASILY CLEANABLE SURFACE (PAINTED, CONCRETE BLOCK IS NOT ALLOWED)
- 3. ALL WALLS BEHIND SINKS MUST BE PROTECTED WITH AT WATER RESISTANT MATERIAL MEASURED FROM THE TOP OF COVE BASE UP.
- 4. WATER HEATER BASE TO BE ELEVATED AT LEAST 6-INCHES ABOVE THE FINISHED FLOOR ON A STAND OR COVED CURB.
- 5. SURFACE MOUNTED PIPING IS NOT ACCEPTABLE. PIPING AND CONDUITS OF ALL TYPES MUST BE CONCEALED WITHIN WALLS, FLOORS AND CEILINGS.
- UNCOVERED FOOD OR UTENSILS MUST BE SHATTER-RESISTANT AND CLEANABLE.
- 7. VERTICAL SNEEZE GUARDS MUST EXTEND TO A HEIGHT OF AT LEAST 60-INCHES ABOVE THE FINISHED FLOOR.
- 8. ALL HAND SINKS TO HAVE PERMANENTLY MOUNT SOAP & TOWEL DISPENSERS.
- 9. THE TOILET ROOM MUST BE EQUIPPED WITH THE FOLLOWING: A) PERMANENTLY INSTALLED SOAP AND PAPER TOWEL DISPENSERS
- B) TOILET TISSUE DISPENSER C) VENTILATION TO THE OUTSIDE AIR THROUGH A LIGHT-SWITCH
- ACTIVATED EXHAUST FAN D) SELF-CLOSING DOOR
- E) HAND WASH SINK WITH HOT/COLD COMBINATION WATER FAUCET
- 10. SEE SHEET P-2 FOR ALL PLUMBING AND WASTE CONNECTIONS.
- 11. SUFFICIENT NATURAL OR ARTIFICIAL LIGHTING SHALL BE PROVIDED TO PRODUCE THE FOLLOWING LIGHT INTENSITY, WHILE THE AREA IS IN USE: -AT LEAST 10-FOOT CANDLE AT A DISTANCE OF 30 INCHES ABOVE THE FLOOR, IN DRY
- FOOD STORAGE AREAS. -AT LEAST 20-FOOT CANDLES FOR THE FOLLOWING:
- -AT A SURFACE WHERE FOOD IS PROVIDED FOR CONSUMER SELF-SERVICE OR WHERE FRESH PRODUCE OR PREPACKAGED FOODS ARE SOLD OR OFFERED FOR CONSUMPTION. -INSIDE EQUIPMENT SUCH AS REACH-IN AND UNDER-COUNTER REFRIGERATORS. -AT A DISTANCE OF 30 INCHES ABOVE THE FLOOR IN AREAS USED FOR HANDWASHING, WAREWASHING, AND EQUIPMENT AND UTENSIL STORAGE, AND IN TOILET ROOMS.

- 12. ALL FOOD SERVICE AND RELATED EQUIPMENT SHALL BE NATIONAL SANITATION FOUNDATION (NSF) APPROVED AND IN CONFORMITY WITH LOCAL HEALTH REGULATIONS. INSTALLATION OF EQUIPMENT SHALL MEET SAME REQUIREMENTS. ALL REFRIGERATION SHALL MEET NSF-CHAPTER7 REQUIREMENTS.
- 13. ALL ADJOINING EQUIPMENT AND COUNTER SHALL BE SEALED TOGETHER TO PREVENT THE ENTRANCE OF MOISTURE, SPLASH, GREASE, INSECTS, ETC. ALL EQUIPMENT, INCLUDING SHELVING, SHALL BE SMOOTHLY SEALED TO THE WALL TO PREVENT THE ENTRANCE OF SPLASH AND DEBRIS. ALL PORTABLE OR FREE STANDING UNITS SHALL BE REMOVABLE AND EASILY ACCESSIBLE FOR CLEANING.
- 14. ALL REFRIGERATION EQUIPMENT AND EQUIPMENT FOR HOT STORAGE SHALL HAVE THERMOMETERS WHICH ARE EASILY READABLE IN PROPER WORKING CONDITIONS.
- 6. LIGHT FIXTURES, INCLUDING PENDANT, RECESSED AND TRACK LIGHTING, LOCATED OVER 15. STORAGE SHELVING MUST BE SPECIFIED AS HAVING A SMOOTH, NON-ABSORBENT FINISH. THE LOWEST SHELF TO BE 6 INCHES ABOVE THE FLOOR.
 - 16. A SEPARATE WALL-MOUNTED HANDWASH SINK IS REQUIRED WITHIN OR ADJACENT TO THE FOOD PREPARATION AND PACKAGING AREA. PROVIDE PERMANENTLY MOUNTED SINGLE-SERVICE SOAP AND PAPER TOWEL DISPENSERS.
 - 17. ALL SINKS TO BE PROVIDED WITH ADEQUATE HOT AND COLD WATER FROM MIXING FAUCETS.
 - 18. THE JUNCTURE AT THE FLOOR AND WALL, IN FOOD PREPARATION, COOKING AND SERVICE AREAS, MUST HAVE A COVED BASE WITH AT LEAST A 3/8 INCH RADIUS AND EXTENDING AT LEAST 6 INCHES UP THE WALL. IF TOP SET COVING IS USED, IT MUST BE ADEQUATELY SEALED AT THE FLOOR WITH SILICONE SEALANT OR EQUIVALENT TO FORM WATERPROOF SEAL.
 - 19. PROVIDE AUTOMATIC DOOR CLOSURES ON ALL ENTRY AND DELIVERY ROOM DOORS.
 - 20. BUILDING SHALL BE INSECT AND RODENT PROOF, INCLUDING EXTERIOR DOOR WHICH MUST COME WITHIN 1/4 INCH OF FLOOR. ALL VENTS AND OTHER OPENINGS TO OUTSIDE NEED TO BE SEALED OR SCREENED.
 - 21. REFUSE CONTAINERS SHALL BE MOISTURE AND VERMIN PROOF WITH TIGHT FITTING LIDS.
 - 22. ANY TRASH AND GARBAGE STORAGE AREA RECEIVING FOOD WASTE OR FOOD CONTAINERS, WILL HAVE A WATER BIB TO FACILITATE CLEANING. FLOOR, WALL AND CEILING WILL BE SMOOTH AND CLEANABLE, RECOMMEND HOT AND COLD WATER BIBS BE AVAILABLE FOR CLEANING. WASTE WATER FROM SUCH CLEANING OPERATIONS MUST BE DISPOSED OF AS SEWAGE THROUGH A FLOOR DRAIN IN THE TRASH ENCLOSURE OR THE EQUIVALENT.

SEE ADDITIONAL NOTES PER PLANS.

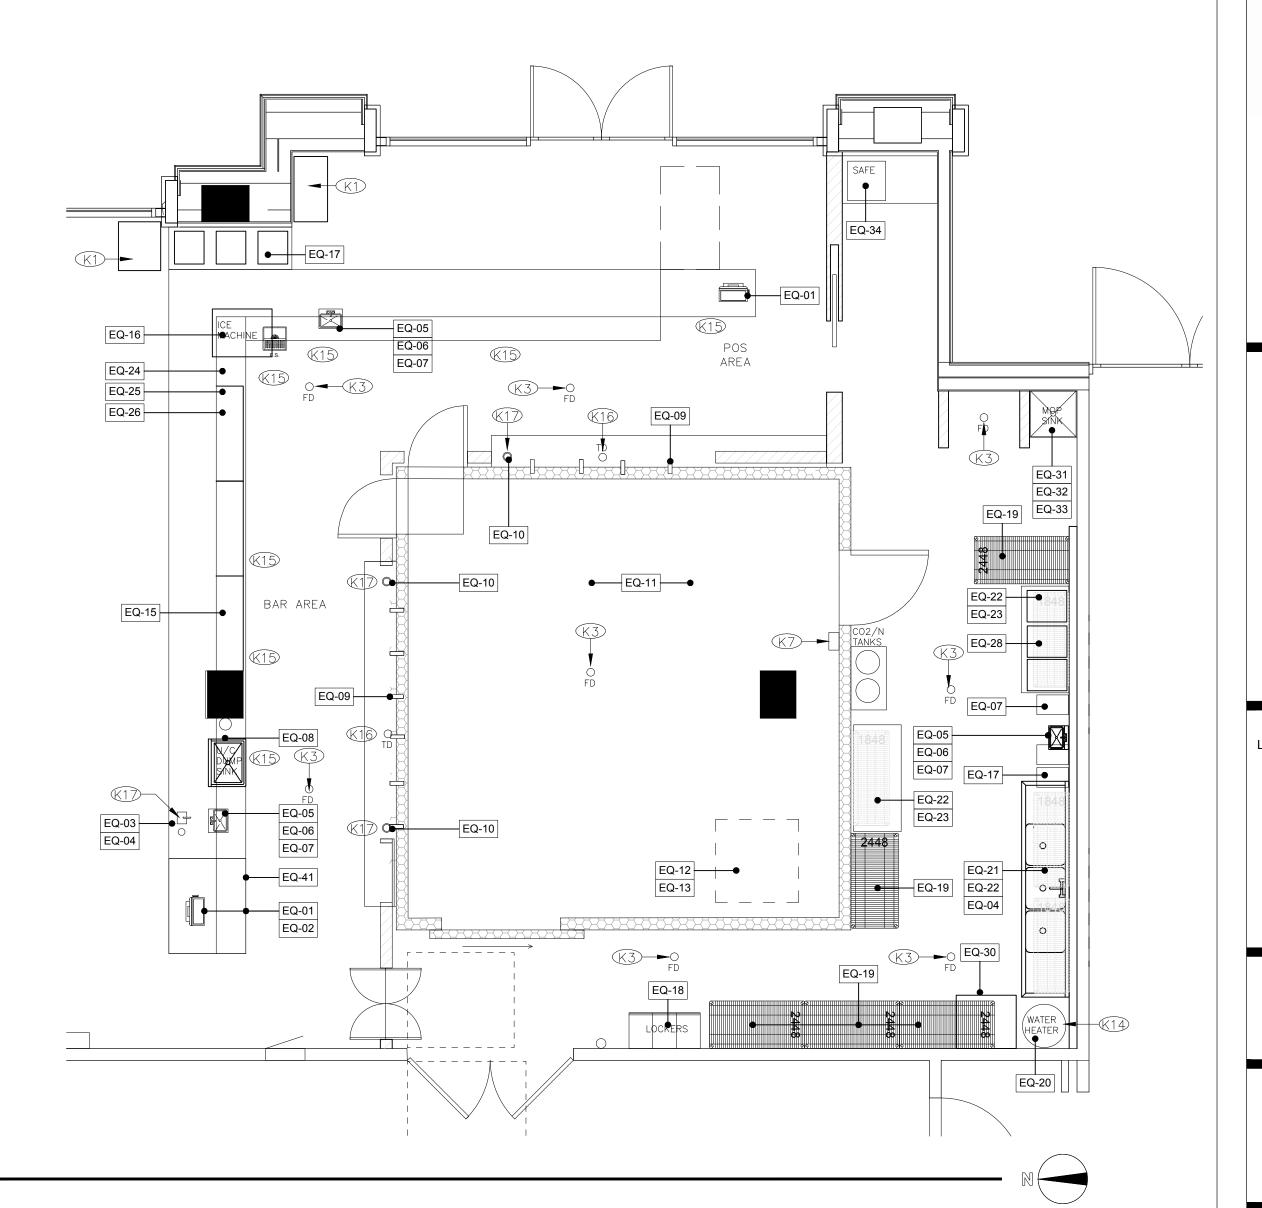

BAREBOTTLE BREW COMPANY SANTA CLARA SQUARE BUILDING ONE


2520 AUGUSTINE SQUARE SANTA CLARA, CA 95054

SUBMITTAL/REVISIONS LANDLORD/PERMIT 12/21/18 SUBMITTAL SET

> EQUIPMENT PLAN, SCHEDULE & NOTES


SHEET NUMBER

EQUIPMENT PLAN

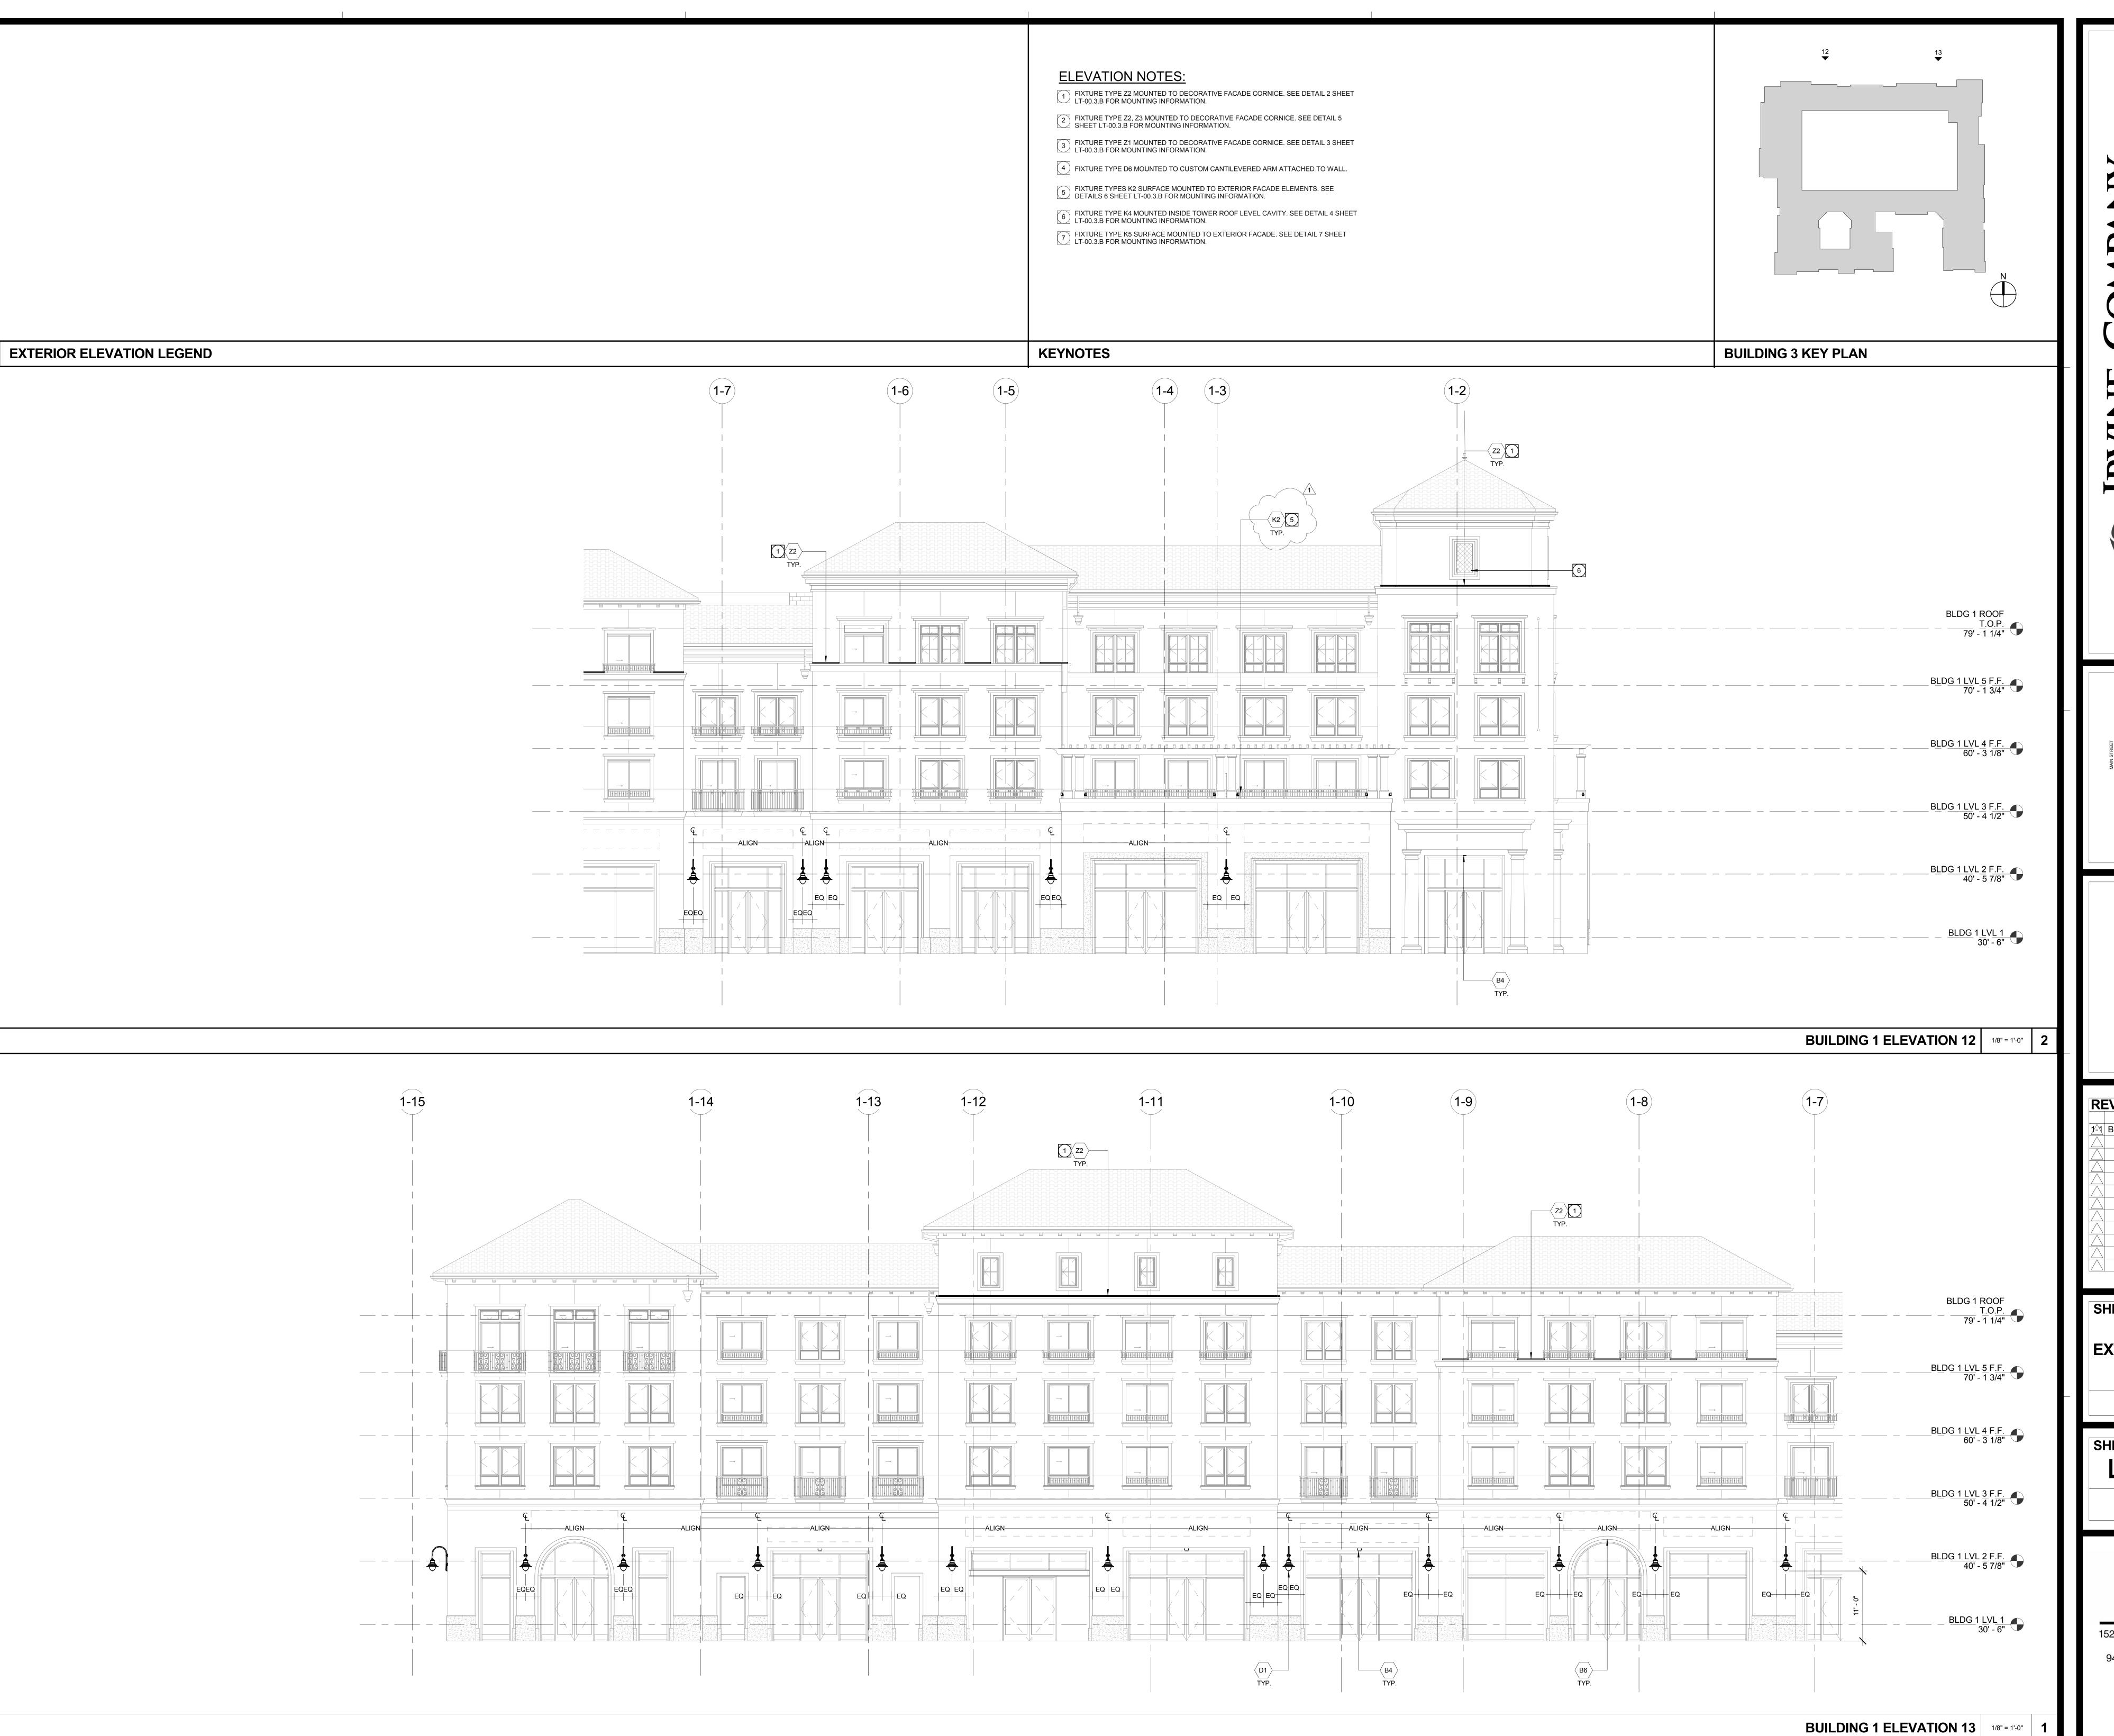

RA SQUARE
ITA CLARA, CA 95054

APARTMENT COMMUNITY 690 N. MCCARTHY BLVD. SUITE 100 MILPITAS, CA 95035
TELEPHONE: (408) 957-1232 FAX: (408) 957-1212

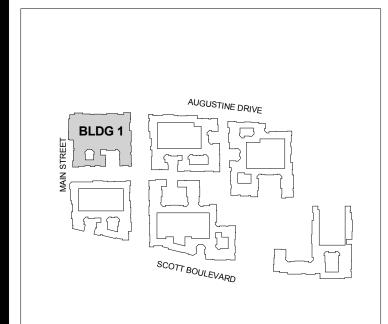

REVISIONS

DESCRIPTION
DATE

1 BULLETIN 1-1
2016-10-07

SHEET TITLE

EXTERIOR ELEVATIONS

BUILDING 1

SHEET NUMBER 2013-10130

LT1-20.2

DATE 02/23/2016
SCALE As indicated

Studio K

DESIGNING LIGHT

15231 Laguna Canyon Road, Suite 100
Irvine, California 92618
949.751.5800 - www.studiok1.com

Salwa Osman
SK1 Job #: 2015-0293

				LIG	HTIN	NG FIXTURE SCHEDULE		
SYMBOL	TYPE	MANUFACTURER & MODEL NO.	LAMP	ССТ	VA SYSTEI WATTS	GENERAL DESCRIPTION RECESSED WET LOCATION RATED DOWNLIGHT FOR USE WITH (1) 14.7W 1000 LUMEN	NOTES	SYI
0	B1	DMF LIGHTING DRDH-N-JD-DRD2M-10-9-27-DRD2T-R-J D-ACRYL-DIF-WH DMF LIGHTING	LED	2700	14.7 14.7	93 CRI LED MODULE AT 2700K. 4-INCH APERTURE. DEEP FIRE-RESISTANCE RATED JUNCTION BOX, RATED FOR UP TO 2 HOURS. 1-INCH DROPPED DIFFUSED ACRYLIC PIECE WITH FROSTED BOTTOM. 0-10V DIMMING. WHITE TRIM FINISH. RECESSED WET LOCATION RATED DOWNLIGHT FOR USE WITH (1) 19.5W 1500 LUMEN	-	;
©	B2	DCDH-N-4-150-?[MOUNTING]-DCD1M-15- 9-27-A-DCD2T-R-4-S-AZ	LED	2700	19.5 19.5	90 CRI LED MODULE AT 2700K. 4-INCH APERTURE. LOW IRIDESCENT REFLECTOR. 0-10V DIMMING. WHITE TRIM FINISH. RECESSED DAMP LOCATION RATED DOWNLIGHT FOR USE WITH (1) 22.84W, 2000 LUMEN	FINISH TO BE CONFIRMED BY ARCHITECT/OWNER.	•
<u></u>	B3	RP4-2000-278-?/IC430-HZ-SFW GOTHAM	LED	2700	22.84 22.	LED MODULE AT 2700K. 4-INCH NOMINAL APERTURE. HAZE REFLECTOR. 0-10V DIMMING STANDARD. SELF-FLANGED WHITE TRIM RING: RECESSED DOWNLIGHT FOR USE WITH (1) 28.9W, 2500 LUMEN LED MODULE AT	FINISH TO BE CONFIRMED BY ARCHITECT/OWNER.	3
\ \ \ \ \ \ \ \ \ \ \ \ \ \ \ \ \ \ \	B3A	NATIC-EVO-27-25-4WTR-W-LD-MVOLT-EZ1	LED		28.9 28.9	2700K. WIDE BEAM DISTRIBUTION. 4-INCH NOMINAL APERTURE. 0-10V DIMMING. SELF FLANGED MATTE DIFFUSE WHEAT FINISH. RECESSED WET LOCATION RATED DOWNLIGHT FOR USE WITH (1) 18:14W, 1500 LUMEN	FINISH TO BE CONFIRMED BY ARCHITECT/OWNER.	3
⊕ →	B4 	RP4-1500-308-?/IC432-HZ-SF?-SB GOTHAM ICO	LED	2700	14	LED MODULE AT 3000K. 4-INCH NOMINAL APERTURE. HAZE REFLECTOR, SAND BLASTED LENS. 0-10V DIMMING STANDARD. SELF-FLANGED TRIM RING. FINISH TBD. RECESSED ADJUSTABLE ACCENT LIGHT FOR USE WITH (1) 22W LED MODULE AT 2700K. 2-INCH APERTURE. 25-DEGREE BEAM. DIMMING STANDARD. PROVIDE ALLEN WRENCH	TRIM TO BE PAINTED TO MATCH CEILING. FINISH TO BE CONFIRMED BY ARCHITECT/OWNER.	<
→	B5A	ADJ-27/15-2WR-LSS-25D-MVOLT-UGZ-AW 50 GOTHAM ICO ADJ-27/25-4WTC-T00-LD-50D-?[VOLT]-EZ	LED	2700	33 33	ACCESSORY. SELF-FLANGED WHITE TRIM RING. RECESSED ADJUSTABLE ACCENT LIGHT FOR USE WITH (1) 33W LED MODULE AT 2700K. 4-INCH APERTURE. 50-DEGREE BEAM. MATTE DIFFUSE WHEAT REFLECTOR. DIMMING	FINISH TO BE CONFIRMED BY ARCHITECT/OWNER.	
△	B6	10 USAI 2221-W-B1-S-10/	LED	3000	18.14 18.	STANDARD. SELF-FLANGED WHITE TRIM RING. RECESSED WET LOCATION RATED DOWNLIGHT FOR USE WITH (1) 20W, 1100 LUMEN LED MODULE AT 3000K. 50-DEGREE BEAM OPTICS. 3-INCH NOMINAL APERTURE.	TRIM TO BE PAINTED TO MATCH CEILING.	
*	B7	LRTD3-9020-M2-30KS-50-FT-120-DIML2 CSL	LED	2700	14	SPECULAR REFLECTOR, SOLITE LENS. 0-10V DIMMING STANDARD. WHITE TRIM RING. RECESSED WET LOCATION RATED DOWNLIGHT FOR USE WITH (1) 15W 1425 LUMEN LED MODULE AT 2700K. 3-INCH APERTURE, 2.5-INCH HOUSING DEPTH. 80-DEGREE	FINISH TO BE CONFIRMED BY ARCHITECT/OWNER.	
+	D1	NERI LUMINAIRE: SU210L02-1-P2-71-120-277V	LED	3000	27 27	OPTICS. HAZE REFLECTOR. 0-10V DIMMING STANDARD. WHITE TRIM FINISH. WALL MOUNTED EXTERIOR RATED LARGE DECORATIVE SCONCE FOR USE WITH (1) 27W, 2500 LUMEN LED MODULE AT 3000K. TYPE 3 DISTRIBUTION WITH WHITE FROSTED LENS. WALL MOUNTED BRACKET, FIXTURE MOUNTED BELOW ARM, INTEGRAL DRIVER.	FINISH TO BE CONFIRMED BY OWNER. PROVIDE MANUAL DIMMING UP TO 50%. MOUNTING HEIGHTS PER ELEVATIONS.	
4	D1A	WALL BRACKET: 4075.0000 (2.26-FEET) STERNBERG F330_MOD_?/6236WB/BB/XRLED-9L27T3-M	LED	2700	44 44	PROVIDE MANUAL DIMMING. NERI GREY FINISH. WALL MOUNTED EXTERIOR RATED LARGE DECORATIVE SCONCE FOR USE WITH (1) 44W LED MODULE AT 2700K. TYPE 3 DISTRIBUTION WITH FROSTED ACRYLIC DIFFUSER. WALL MOUNTED BRACKET WITH FIXTURE ABOVE ARM. INTEGRAL 0-10V DIMMING DRIVER.	FINISH TO BE CONFIRMED BY ARCHITECT/OWNER. MOUNTING	
	D.4.D	DL14/FA_MOD_EXTRA SAND BLASTED/CM? STERNBERG		0=00		FINISH TO MATCH "NERI GREY" SAMPLE. WALL MOUNTED EXTERIOR RATED LARGE DECORATIVE SCONCE FOR USE WITH (1) 44W LED MODULE AT 2700K. TYPE 3 DISTRIBUTION WITH WHITE ACRYLIC DIFFUSER. WALL	FINISH TO BE CONFIRMED BY ARCHITECT/OWNER. REMOTE DRIVER TO BE LOCATED IN ACCORDANCE WITH MANUFACTURER GUIDELINES	
		S640CR_MOD_?/OMWB/XRLED-9L27T3-MDL1 4/WA/CM? STERNBERG	LED	2700	44 44	MOUNTED BRACKET WITH FIXTURE ABOVE ARM. REMOTE 0-10V DIMMING DRIVER. FINISH TO MATCH "NERI GREY" SAMPLE. WALL MOUNTED EXTERIOR RATED LARGE DECORATIVE SCONCE FOR USE WITH (1) 44W LED MODULE AT 2700K. TYPE 3 DISTRIBUTION WITH WHITE ACRYLIC DIFFUSER. WALL	AND IN COORDINATION WITH ARCHITECT. MOUNTING HEIGHTS PER ELEVATIONS. FINISH TO BE CONFIRMED BY ARCHITECT/OWNER. MOUNTING	<u> </u>
Ψ	D1C	F330_MOD_?/480WB/BB/XRLED-9L27T3-MD L14/FA_MOD_EXTRA SAND BLASTED/CM? STERNBERG	LED	2700	44 44	MOUNTED BRACKET WITH FIXTURE ABOVE ARM. INTEGRAL 0-10V DIMMING DRIVER. FINISH TO MATCH "NERI GREY" SAMPLE. WALL MOUNTED EXTERIOR RATED LARGE DECORATIVE SCONCE FOR USE WITH (1) 44W	HEIGHTS PER ELEVATIONS.	
•	D1D	S640CR_MOD_?/6236WB/XRLED-9L27T3-MD L14/WA/CM?	LED	2700	44 44	LED MODULE AT 2700K. TYPE 3 DISTRIBUTION WITH WHITE ACRYLIC DIFFUSER. WALL MOUNTED BRACKET WITH FIXTURE ABOVE ARM. INTEGRAL 0-10V DIMMING DRIVER. FINISH TO MATCH "NERI GREY" SAMPLE. WALL MOUNTED EXTERIOR RATED DECORATIVE SCONCE FOR USE WITH (1) 21W LED	FINISH TO BE CONFIRMED BY ARCHITECT/OWNER. MOUNTING HEIGHTS PER ELEVATIONS.	
+	D2A	STERNBERG F230_MOD_?/478WB/XRLED-9L27T3-MDL07 /FA_MOD_EXTRA SAND BLASTED/CM?	LED	2700	21 21	MODULE AT 2700K. TYPE 3 DISTRIBUTION WITH FROSTED ACRYLIC DIFFUSER. WALL MOUNTED BRACKET WITH FIXTURE ABOVE ARM. INTEGRAL 0-10V DIMMING DRIVER. FINISH TO MATCH "NERI GREY" SAMPLE.	FINISH TO BE CONFIRMED BY ARCHITECT/OWNER. MOUNTING HEIGHTS PER ELEVATIONS.	
*	D2B	STERNBERG S540CR_MOD_?/EU1WB/XRLED-9L27T3-MDL 07/WA/CM?	LED	2700	21 21	WALL MOUNTED EXTERIOR RATED DECORATIVE SCONCE FOR USE WITH (1) 21W LED MODULE AT 2700K. TYPE 3 DISTRIBUTION WITH WHITE ACRYLIC DIFFUSER. WALL MOUNTED BRACKET WITH FIXTURE ABOVE ARM. REMOTE 0-10V DIMMING DRIVER. FINISH TO MATCH "NERI GREY" SAMPLE.	FINISH TO BE CONFIRMED BY ARCHITECT/OWNER. REMOTE DRIVER TO BE LOCATED IN ACCORDANCE WITH MANUFACTURER GUIDELINES AND IN COORDINATION WITH ARCHITECT. MOUNTING HEIGHTS PER ELEVATIONS.	
\angle \square \qu	D2C	STERNBERG F230_MOD_?/80WB/XRLED-9L27T3-MDL07/ FA_MOD_EXTRA SAND BLASTED/CM?	LED	2700	21 21	WALL MOUNTED EXTERIOR RATED DECORATIVE SCONCE FOR USE WITH (1) 21W LED MODULE AT 2700K. TYPE 3 DISTRIBUTION WITH WHITE ACRYLIC DIFFUSER. WALL MOUNTED BRACKET WITH FIXTURE ABOVE ARM. INTEGRAL 0-10V DIMMING DRIVER. FINISH TO MATCH "NERI GREY" SAMPLE.	FINISH TO BE CONFIRMED BY ARCHITECT/OWNER. MOUNTING HEIGHTS PER ELEVATIONS.	
*	D2D	STERNBERG S540CR_MOD_SC22394/478WB/XRLED-9L27 T3-MDL07/WA/CM?	LED	2700	21 21	WALL MOUNTED EXTERIOR RATED DECORATIVE SCONCE FOR USE WITH (1) 21W LED MODULE AT 2700K. TYPE 3 DISTRIBUTION WITH WHITE ACRYLIC DIFFUSER. WALL MOUNTED BRACKET WITH FIXTURE ABOVE ARM. REMOTE DRIVER. FINISH TO MATCH "NERI GREY" SAMPLE.	FINISH TO BE CONFIRMED BY ARCHITECT/OWNER. REMOTE DRIVER TO BE LOCATED IN ACCORDANCE WITH MANUFACTURER GUIDELINES AND IN COORDINATION WITH ARCHITECT. MOUNTING HEIGHTS PER ELEVATIONS.	
Φ	D3A	MAXIM LIGHTING 86596MOOB_MOD LAMP: TCP LED10A19GUDOD27K	LED	2700	10 10	WALL MOUNTED EXTERIOR RATED SMALL DECORATIVE SCONCE FOR USE WITH (1) 10W, 800 LUMEN GU24 LED LAMP AT 2700K. MOCHA ACRYLIC DIFFUSER. WALL MOUNTED BRACKET WITH FIXTURE BELOW ARM. FINISH TO MATCH "NERI GREY" SAMPLE.	FINISH TO BE CONFIRMED BY ARCHITECT/OWNER. MOUNTING HEIGHTS PER ELEVATIONS.	
Q	D3B	STERNBERG S440CR_MOD_SC?????/78WB/XRLED-9L27T3 -MDL07/WA/CM?	LED	2700	21 21	WALL MOUNTED EXTERIOR RATED SMALL DECORATIVE SCONCE FOR USE WITH (1) 21W LED MODULE AT 2700K. TYPE 3 DISTRIBUTION WITH WHITE ACRYLIC DIFFUSER. WALL MOUNTED BRACKET WITH FIXTURE ABOVE ARM. REMOTE 0-10V DIMMING DRIVER. FINISH TO MATCH "NERI GREY" SAMPLE.	FINISH TO BE CONFIRMED BY ARCHITECT/OWNER. REMOTE DRIVER TO BE LOCATED IN ACCORDANCE WITH MANUFACTURER GUIDELINES AND IN COORDINATION WITH ARCHITECT. MOUNTING HEIGHTS PER ELEVATIONS.	
ф	D3C	MAXIM LIGHTING 86596MOOB_MOD LAMP: TCP LED10A19GUDOD27K	LED	2700	10 10	WALL MOUNTED EXTERIOR RATED SMALL DECORATIVE SCONCE FOR USE WITH (1) 10W, 800 LUMEN GU24 LED LAMP AT 2700K. MOCHA ACRYLIC DIFFUSER. WALL MOUNTED BRACKET WITH FIXTURE ABOVE ARM. FINISH TO MATCH "NERI GREY" SAMPLE.	FINISH TO BE CONFIRMED BY ARCHITECT/OWNER. MOUNTING HEIGHTS PER ELEVATIONS.	
	D3D	STERNBERG S440CR_MOD_SC?????/78WB/XRLED-9L27T3 -MDL07/WA/CM?	LED	2700	21 21	WALL MOUNTED EXTERIOR RATED SMALL DECORATIVE SCONCE FOR USE WITH (1) 21W LED MODULE AT 2700K. TYPE 3 DISTRIBUTION WITH WHITE ACRYLIC DIFFUSER. WALL MOUNTED BRACKET WITH FIXTURE ABOVE ARM. REMOTE 0-10V DIMMING DRIVER. FINISH TO MATCH "NERI GREY" SAMPLE.	FINISH TO BE CONFIRMED BY ARCHITECT/OWNER. REMOTE DRIVER TO BE LOCATED IN ACCORDANCE WITH MANUFACTURER GUIDELINES AND IN COORDINATION WITH ARCHITECT. MOUNTING HEIGHTS PER ELEVATIONS.	
Ţ	D4	WE-EF 622-6722_2700K-?[FINISH]-?[VOLTAGE]-FR OSTED_LENS	LED	2700	28 28	SURFACE MOUNTED EXTERIOR RATED WALL PACK FOR USE WITH (1) 28W LED MODULE AT 2700K. TYPE IV MEDIUM DISTRIBUTION. PROVIDE CUSTOM FROSTED LENS. FINISH TO MATCH "NERI GREY" SAMPLE.	FINISH TO BE CONFIRMED BY ARCHITECT/OWNER. MOUNTING HEIGHTS PER ELEVATIONS.	
4	D4A	WE-EF 622-6720_2700K-?[FINISH]-?[VOLTAGE]-FR OSTED_LENS	LED	2700	14 14	SURFACE MOUNTED EXTERIOR RATED WALL PACK FOR USE WITH (1) 14W LED MODULE AT 2700K. TYPE IV MEDIUM DISTRIBUTION. PROVIDE CUSTOM FROSTED LENS. FINISH TO MATCH "NERI-GREY" SAMPLE.	FINISH TO BE DETERMINED BY ARCHITECT/OWNER. MOUNTING HEIGHTS PER ELEVATIONS.	<u> </u>
	D5 D6	NOT USED NERI LUMINAIRE: SU210L02-1-P2-71-120-277V	- LED	3000	- - 27 27	NOT USED. CANTILEVER ARM MOUNTED EXTERIOR BATED LARGE DECORATIVE FIXTURE FOR USE WITH (1) 27W, 2500 LUMEN LED MODULE AT 3000K. TYPE 3 DISTRIBUTION WITH WHITE	FINISH TO BE CONFIRMED BY OWNER. PROVIDE MANUAL DIMMING UP TO 50%. MOUNTING HEIGHTS PER ELEVATIONS.	} [
	D7A	WALL BRACKET: TBD FEISS WB1452-17" MOD1A	LED	2700	9.3 9.3	FROSTED LENS. CUSTOM WALL MOUNTED BRACKET. FIXTURE MOUNTED BELOW ARM. INTEGRAL DRIVER. PROVIDE MANUAL DIMMING. NERI GREY FINISH. WALL MOUNTED DAMP RATED ADA COMPLIANT DECORATIVE SCONCE FOR USE WITH (1) 9.3W LED MODULE AT 2700K. OPAL ACRYLIC DIFFUSER. CUSTOM FINISH TO MATCH	FINISH TO BE CONFIRMED BY OWNER. MOUNTING HEIGHT PER	[
4	D8	NOT USED	-	-	- -	ARCHITECT'S "DRIFTWOOD MICA" SAMPLE. NOT USED. CEILING SUSPENDED DECORATIVE PENDANT FOR USE WITH (8) 22W LED MODULES AT		}
	D8A	CAMMAN LIGHTING CH78995-8-72-D8A	LED	2700	176 176	2700K. 72-INCHES BY 72-INCHES NOMINAL DIMENSIONS. CUSTOM CONFIGURATION OF ACRYLIC DIFFUSERS. 0.375-INCH DIAMETER STEMS, 5-INCH WIDE RAIL. INTEGRAL DRIVERS. PROVIDE 0-10V DIMMING. CUSTOM DARK BRONZE METAL TRIM FINISH.	DIFFUSER FINISH TO BE DETERMINED; METAL FINISH TO BE CONFIRMED BY ARCHITECT/OWNER. ARCHITECT TO CONFIRM SUSPENSION LENGTH.	
	D8B	CAMMAN LIGHTING CH78995-8-108-D8B	LED	2700	176 176	CEILING SUSPENDED DECORATIVE PENDANT FOR USE WITH (8) 22W LED MODULES AT 2700K. 72-INCHES BY 108-INCHES NOMINAL DIMENSIONS. CUSTOM CONFIGURATION OF ACRYLIC DIFFUSERS. 0.375-INCH DIAMETER STEMS, 5-INCH WIDE RAIL. INTEGRAL DRIVERS. PROVIDE 0-10V DIMMING. CUSTOM DARK BRONZE METAL TRIM FINISH.	FINISHES TO BE DETERMINED BY ARCHITECT/OWNER. SUSPENSION LENGTH TO BE DETERMINED.	
	D8C	CAMMAN LIGHTING CH78995-8-108-D8C	LED	2700	176 176	CEILING SUSPENDED DECORATIVE PENDANT FOR USE WITH (8) 22W LED MODULES AT 2700K. 72-INCHES BY 108-INCHES NOMINAL DIMENSIONS. CUSTOM CONFIGURATION OF ACRYLIC DIFFUSERS. 0.375-INCH DIAMETER STEMS, 5-INCH WIDE RAIL. INTEGRAL DRIVERS. PROVIDE 0-10V DIMMING. CUSTOM DARK BRONZE METAL TRIM FINISH.	FINISHES TO BE DETERMINED BY ARCHITECT/OWNER. SUSPENSION LENGTH TO BE DETERMINED.	4
	D8D	CAMMAN LIGHTING CH78995-8-93-D8D	LED	2700	176 176	CEILING SUSPENDED DECORATIVE PENDANT FOR USE WITH (8) 22W LED MODULES AT 2700K. 45-INCHES BY 93-INCHES NOMINAL DIMENSIONS. CUSTOM CONFIGURATION OF ACRYLIC DIFFUSERS. 0.375-INCH DIAMETER STEMS, 5-INCH WIDE RAIL. INTEGRAL	FINISHES TO BE DETERMINED BY ARCHITECT/OWNER. SUSPENSION LENGTH TO BE DETERMINED.	-
	D8E	CAMMAN LIGHTING	LED	2700	176 176	DRIVERS. PROVIDE 0-10V DIMMING. CUSTOM DARK BRONZE METAL TRIM FINISH. CEILING SUSPENDED DECORATIVE PENDANT FOR USE WITH (8) 22W LED MODULES AT 2700K. 168-INCHES NOMINAL LENGTH. CUSTOM CONFIGURATION OF ACRYLIC	FINISHES TO BE DETERMINED BY ARCHITECT/OWNER. SUSPENSION	
	D8E	CH78995-8-168-D8E DMF	LED	2700	10 10	DIFFUSERS. 0.375-INCH DIAMETER STEMS, 5-INCH WIDE RAIL. INTEGRAL DRIVERS. PROVIDE 0-10V DIMMING. CUSTOM DARK BRONZE METAL TRIM FINISH. SURFACE MOUNTED EXTERIOR RATED DOWNLIGHT CYLINDER FOR USE WITH (1) 10W	LENGTH TO BE DETERMINED. FINISH TO BE DETERMINED BY ARCHITECT/OWNER. MOUNTING	
Y		DCC2-SW-M-7-27-? ART MANUFACTURERS D10-MONT-42WLED-[0-10V DIM]-2700K-FINISH: ?	LED	2700	42 42	LED MODULE AT 2700K. 4-INCHES DIAMETER, 10-INCHES HEIGHT. FINISH TBD. PIER MOUNTED EXTERIOR RATED DECORATIVE LANTERN FIXTURE FOR USE WITH (1) 42W LED MODULE AT 2700K. INTEGRAL 0-10V DIMMING DRIVER. FROSTED ACRYLIC	HEIGHTS PER ELEVATIONS. FINISH TO BE DETERMINED BY ARCHITECT/OWNER.	L
4	D11	ART MANUFACTURERS D11-MONT-21WLED_2700K-FINISH: 2	LED	2700	21 21	DIFFUSER. CUSTOM FINISH TBD. PIER MOUNTED EXTERIOR RATED DECORATIVE LANTERN FIXTURE FOR USE WITH (1) 21W LED MODULE AT 2700K, FROSTED ACRYLIC DIFFUSER, CUSTOM FINISH TBD	FINISH TO BE DETERMINED BY ARCHITECT/OWNER.	\ \
		NOT USED DAY-BRITE 2STF?[AIR FUNCTION]34L830-2-DS-UNV-DIM-ACTILUME	LED	3000	-l- 40.5 40. 5	RECESSED 2X2 FIXTURE FOR USE WITH (1) 40.1W LED MODULE AT 3000K. FLANGE MOUNTING AND SMOOTH DIFFUSER. PROVIDE 0-10V DIMMING AND INTEGRAL	- -	3
	G1A	1-10V DAY-BRITE 2STF?[AIR FUNCTION]34L830-2-DS-UNV-DIM	LED	3000	40.5 40. 5	OCCUPANCY SENSOR. WHITE FINISH. RECESSED 2X2 FIXTURE FOR USE WITH (1) 40.1W LED MODULE AT 3000K. FLANGE MOUNTING AND SMOOTH DIFFUSER. PROVIDE 0-10V DIMMING. WHITE FINISH.	-	
4	G2	ARCHITECTURAL LIGHTING WORKS LP1RT/WW-?[LENGTH]-DRY-MED/2700K-0/1 0/-EXT/F-?[FINISH]-UNV	LED	2700	9.6 9.6/ FT	RECESSED LINEAR WALL WASHER FOR USE WITH LED AT 2700K. 9.6W PER LINEAR FOOT. 1.625-INCH APERTURE. ACRYLIC DIFFUSE LENS. LENGTH PER PLANS. PROVIDE 0-10V DIMMING. WHITE TRIM FINISH.	FINISH TO BE CONFIRMED BY OWNER.	}
	G3	OCL LIGHTING UA3-C1OB-?[LENGTH]-GW-PTD_?[FINISH CODE]-LED 2700K_27K-?[VOLTAGE]-DMO	LED	2700	8 8/FT	EXTERIOR RATED RECESSED LINEAR DOWNLIGHT FOR USE WITH LED AT 2700K. 8W, 500 LUMENS PER LINEAR FOOT. 2.38-INCH APERTURE. OPAL WHITE LENS. LENGTH PER PLANS. PROVIDE 0-10V DIMMING. FINISH TBD.	FIXTURE MOUNTS WITHIN FAÇADE MOUNTED SIGNAGE ENCLOSURE. COORDINATE MOUNTING WITH SIGNAGE FABRICATOR. FINISH TO BE DETERMINED BY OWNER.	}
4	K 1	INTENSE LIGHTING IVT702K-L1-27-12-DIM-[RAL #7016]- PFL2-S	LED	2700	9 9	NPT SURFACE MOUNTED WET LOCATION RATED ADJUSTABLE BULLET FOR USE WITH (1) 9W LED MODULE AT 2700K. 12-DEGREE SPOT OPTIC. LINEAR SPREAD LENS. LINEAR SPREAD LENS. MOUNT TO NERI POLE. INTEGRAL DRIVER. PROVIDE 120V ELV DIMMING. CUSTOM FINISH TO MATCH RAL #7016.	FINISH TO BE CONFIRMED BY OWNER.	
ō	K2	HEVI-LITE HL-915-?-15-27-FL-12-GL-915-LA-4-2 0-A-SM-3	LED	2700	15 15	SURFACE MOUNTED ADJUSTABLE BULLET FOR USE WITH (1) 15W LED MODULE AT 2700K. 40-DEGREE FLOOD OPTIC. ANGLED GLARE SHIELD. SOFT FOCUS LENS. PROVIDE 2.75-INCH SURFACE MOUNT CANOPY. REMOTE MLV DIMMING TRANSFORMER REQUIRED. FINISH TBD.	FINISH TO BE DETERMINED BY ARCHITECT/OWNER. REMOTE TRANSFORMER(S) TO BE LOCATED IN ACCESSIBLE LOCATIONS AND IN COORDINATION WITH ARCHITECT. CONTRACTOR TO VERIFY TRANSFORMER QUANTITIES TO ENSURE COMPLETE WORKING	N(
\(\phi\)	K3	HEVI-LITE HL-915-?-5-27-SP-12-GL-915-LA-4-2	LED	2700	5 5	SURFACE MOUNTED ADJUSTABLE BULLET FOR USE WITH (1) 5W LED MODULE AT 2700K. 10-DEGREE SPOT OPTIC. ANGLED GLARE SHIELD. SOFT FOCUS LENS. REMOTE	SYSTEM. FINISH TO BE DETERMINED BY ARCHITECT/OWNER. REMOTE TRANSFORMER(S) TO BE LOCATED IN ACCESSIBLE LOCATIONS AND IN COORDINATION WITH ARCHITECT. CONTRACTOR TO VERIFY	0
	K4	0 PHILIPS GARDCO DFL7-DIM-W-HFL-75LA-WW-UNV-?[FINISH]	LED	3000	75 75	MLV DIMMING TRANSFORMER REQUIRED. ALUMINUM CONSTRUCTION. FINISH TBD. SURFACE MOUNTED WET LOCATION RATED FLOOD LIGHT FOR USE WITH (1) 75W LED MODULE AT 3000K. INTEGRAL DRIVER. PROVIDE 0-10V DIMMING. CUSTOM FINISH TBD.	TRANSFORMER QUANTITIES TO ENSURE COMPLETE WORKING SYSTEM. FINISH TO BE DETERMINED BY ARCHITECT/OWNER. CONTRACTOR TO COORDINATE MOUNTING WITH FIELD CONDITIONS.	
	K5	LINEA LIGHT E9613?[FINISH]-M-15	LED	2700	8 8	SURFACE MOUNTED ACCENT LIGHT FOR USE WITH (1) 8W, 639 LUMEN, 80 CRI LED MODULE AT 2700K. 15-DEGREE SPOT OPTIC. SOFT FOCUS LENS. MOUNTS TO SINGLE GANG ELECTRICAL BOX. REMOTE 0-10V DIMMING DRIVER REQUIRED. CUSTOM FINISH	FINISH TO BE DETERMINED BY ARCHITECT/OWNER. REMOTE TRANSFORMER(S) TO BE LOCATED IN ACCESSIBLE LOCATIONS AND IN COORDINATION WITH ARCHITECT. CONTRACTOR TO VERIFY	
	L1	REMOTE 0-10V DIMMING DRIVER: D010 HEVI LITE HL-915-?-15-27-[4-SP, 2-FL]-12-GL-915-LA-4-20/ C01400?-?	LED	2700	90 90	TBD. (6) TREE RING MOUNTED ADJUSTABLE BULLETS, EACH WITH (1) 15W LED MODULE AT 2700K PER BULLET. (6) BULLETS PER RING, (2) UP, SPOT OPTIC; (2) DOWN, SPOT OPTIC; (2) DOWN, FLOOD OPTIC. (6) SOFT FOCUS LENS AND 45-DEGREE BEZEL.	TRANSFORMER QUANTITIES TO ENSURE COMPLETE WORKING SYSTEM. FINISH TO BE DETERMINED BY LANDSCAPE ARCHITECT/OWNER. RING DIMENSIONS TO BE VERIFIED PRIOR TO ORDERING. REMOTE TRANSFORMER(S) TO BE LOCATED IN ACCORDANCE WITH MANUFACTURER GUIDELINES AND IN COORDINATION WITH LANDSCAPE ARCHITECT. CONTRACTOR TO VERIFY TRANSFORMER	ı
	L2	KICHLER BBR-SPBS16207-BBR30-SC-16066FRO	LED	2700	19.5 19.5	REMOTE TRANSFORMER REQUIRED. FINISH TBD. STAKE MOUNTED CAST BRASS FLOODLIGHT FOR USE WITH (1) 19.5W LED MODULE AT 3000K. 60-DEGREE OPTIC WITH STANDARD GLARE SHIELD AND FROSTED LENS.	QUANTITIES AND CAPACITIES TO ENSURE COMPLETE WORKING SYSTEM. FINISH TO BE CONFIRMED BY LANDSCAPE ARCHITECT/OWNER.	
	LZ	WITH FOCUS INDUSTRIES FA-26-BRT	LEU	∠1 UU		BRONZED BRASS FINISH.		

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SYMBOL	TYPE	MANUFACTURER & MODEL NO. HEVI-LITE	LAMP	CCT	WATTS	SURFACE MOUNTED ADJUSTABLE BULLET FOR USE WITH (1) 8W LED MODULE AT	NOTES FINISH TO BE DETERMINED BY LANDSCAPE ARCHITECT/OWNER. REMOTE TRANSFORMER(S) TO BE LOCATED IN ACCESSIBLE
P		HL-369-LED-?8LED_MOD_27K-FL-12-L A-4	LED	2700	olo	2700K. 36-DEGREE FLOOD OPTIC. SOFT FOCUS LENS WITH ANGLED GLARE SHIELD. REMOTE MAGNETIC DIMMING TRANSFORMER REQUIRED. ALUMINUM CONSTRUCTION. FINISH TBD.	LOCATIONS AND IN COORDINATION WITH LANDSCAPE ARCHITECT. CONTRACTOR TO VERIFY TRANSFORMER QUANTITIES TO ENSURE COMPLETE WORKING SYSTEM. FINISH TO BE DETERMINED BY LANDSCAPE ARCHITECT/OWNER.
•		EATON LUMIERE 1407-10LED2741-12-?-DIF-LVR	LED	2700	10 10	SURFACE MOUNTED SUBMERSIBLE RATED ADJUSTABLE BULLET FOR USE WITH (1) 10W LED MODULE AT 2700K. 41-DEGREE WIDE FLOOD OPTIC. DIFFUSED LENS. REMOTE DIMMING TRANSFORMER REQUIRED. ALUMINUM CONSTRUCTION. FINISH TBD.	REMOTE TRANSFORMER(S) TO BE LOCATED IN ACCESSIBLE LOCATIONS AND IN COORDINATION WITH LANDSCAPE ARCHITECT. CONTRACTOR TO VERIFY TRANSFORMER QUANTITIES TO ENSURE COMPLETE WORKING SYSTEM. FINISH TO BE DETERMINED BY LANDSCAPE ARCHITECT/OWNER.
<u>-</u>	L5	HEVI-LITE HL-915-15-27-FL-12-GL-915-LA-1-20- LA-4-20/GM-9-N	LED	2700		POWER POST MOUNTED ADJUSTABLE BULLET FOR USE WITH (1) 15W LED MODULE AT 2700K. 40-DEGREE FLOOD OPTIC. SOFT FOCUS LENS, HEXCELL LOUVER AND ANGLED GLARE SHIELD. REMOTE MAGNETIC DIMMING TRANSFORMER REQUIRED. FINISH TBD.	REMOTE TRANSFORMER(S) TO BE LOCATED IN ACCESSIBLE LOCATIONS AND IN COORDINATION WITH LANDSCAPE ARCHITECT. CONTRACTOR TO VERIFY TRANSFORMER QUANTITIES TO ENSURE COMPLETE WORKING SYSTEM.
○	L6	HEVI-LITE HL-915-15-27-NF-12-GL-915-LA-3-20/ GM-9-N	LED	2700		POWER POST MOUNTED ADJUSTABLE BULLET FOR USE WITH (1) 15W LED MODULE AT 2700K. 20-DEGREE NARROW FLOOD OPTIC. LINEAR SPREAD LENS AND ANGLED GLARE SHIELD. REMOTE MAGNETIC DIMMING TRANSFORMER REQUIRED. FINISH TBD.	FINISH TO BE DETERMINED BY LANDSCAPE ARCHITECT/OWNER. REMOTE TRANSFORMER(S) TO BE LOCATED IN ACCESSIBLE LOCATIONS AND IN COORDINATION WITH LANDSCAPE ARCHITECT. CONTRACTOR TO VERIFY TRANSFORMER QUANTITIES TO ENSURE COMPLETE WORKING SYSTEM. FINISH TO BE DETERMINED BY LANDSCAPE ARCHITECT/OWNER.
		AURORA LIGHTING LHL2-BR-W-27-P-?[FINISH] NERI	LED	2700		PENDANT MOUNTED EXTERIOR RATED "FIREFLY" FIXTURE FOR USE WITH (1) 4W LED MODULE AT 2700K. 2-INCHES WIDE X 8.5-INCHES HIGH. PERFORATED HOOD. REMOTE MAGNETIC DIMMING TRANSFORMER REQUIRED. FINISH TBD.	MOUNTS IN TREE. SUSPENSION HEIGHT TO BE DETERMINED IN THE FIELD BY LANDSCAPE ARCHITECT. REMOTE TRANSFORMER(S) TO BE LOCATED IN ACCESSIBLE LOCATIONS AND IN COORDINATION WITH LANDSCAPE ARCHITECT. CONTRACTOR TO VERIFY TRANSFORMER QUANTITIES TO ENSURE COMPLETE WORKING SYSTEM.
•	P1	[NATIC] POLE: 1420.016 ARM: 4202.275 LUMINAIRE: (2) LIGHT 21-SU210L02-1-P3-71-120-277V WITH FROSTED DROP DOWN GLOBE, TYPE III OPTICS OPTIONAL 02 HATCH COVER WITH PLUG ARRANGEMENT AND CABLE PASSAGE BANNER BRACKETS	LED	3000	74 74	DOUBLE HEAD DECORATIVE PEDESTRIAN POLE FOR USE WITH (2) 37W LED MODULES AT 3000K. FROSTED ACRYLIC DROP LENS DIFFUSERS. TYPE III OPTICS. PROVIDE WITH 22-FOOT POLE AND (2) DECORATIVE SIDE MOUNTED BRACKETS. PROVIDE SIDE MOUNTED BANNER ARMS. PROVIDE RECEPTACLES PER DRAWINGS. INTEGRAL DRIVER. PROVIDE MANUAL DIMMING. NERI GREY FINISH.	FINISH TO BE CONFIRMED BY OWNER. PROVIDE MANUAL DIMMING UP TO 50%
	P1A	STERNBERG 2A-1910ALED/5RLM22-MOD/R2PM/9119P5. 250/1RND30T3-MDL03/STD/BANNER BRACKETS	LED	3000	32 32	DOUBLE HEAD DECORATIVE PEDESTRIAN POLE FOR USE WITH (2) 32W LED MODULES AT 3000K. FROSTED ACRYLIC TEAR DROP LENS DIFFUSERS. TYPE III DISTRIBUTION OPTICS. PROVIDE WITH 22-FOOT POLE AND (2) DECORATIVE SIDE MOUNTED BRACKETS. PROVIDE SIDE MOUNTED BANNER ARMS. PROVIDE RECEPTACLES PER DRAWINGS. INTEGRAL DRIVER. FINISH TO MATCH "NERI GREY" SAMPLE.	FINISH TO BE CONFIRMED BY OWNER.
• •	P2	STERNBERG 2A-1910ALED/5RLM22-MOD/480PM/9115P5. 250/1RND30T3-MDL03/STD/BANNER BRACKETS/RECEPTACLE	LED	3000		DOUBLE HEAD DECORATIVE PEDESTRIAN POLE FOR USE WITH (2) 32W LED MODULES AT 3000K. FROSTED ACRYLIC TEAR DROP LENS DIFFUSERS. TYPE III DISTRIBUTION OPTICS. PROVIDE WITH 15-FOOT 4-INCH HEIGHT POLE AND (2) DECORATIVE SIDE MOUNTED BRACKETS. PROVIDE SIDE MOUNTED BANNER ARMS. PROVIDE RECEPTACLES PER DRAWINGS. INTEGRAL DRIVER. PROVIDE DIMMING. FINISH TO MATCH "NERI GREY" SAMPLE.	FINISH TO BE CONFIRMED BY OWNER. PROVIDE.
•——	P2A	NERI [NATIC] POLE: 1410.021 ARM: 4218.285.001_MOD_(1)ARM LUMINAIRE: (1) LIGHT 21SU210L02-1-P3-71-120-277V WITH FROSTED DROP DOWN GLOBE, TYPE III OPTICS OPTIONAL 02 HATCH COVER WITH PLUG ARRANGEMENT AND CABLE PASSAGE BANNER BRACKETS	LED	3000	37 37	SINGLE HEAD DECORATIVE PEDESTRIAN POLE FOR USE WITH (1) 37W LED MODULE AT 3000K. FROSTED ACRYLIC DROP LENS DIFFUSER. TYPE III OPTICS. PROVIDE WITH 14-FOOT 9-INCH POLE AND (1) DECORATIVE SIDE MOUNTED BRACKET. PROVIDE SIDE MOUNTED BANNER ARMS. PROVIDE RECEPTACLES PER DRAWINGS. INTEGRAL DRIVER. PROVIDE MANUAL DIMMING. NERI GREY FINISH.	FINISH TO BE CONFIRMED BY OWNER. PROVIDE MANUAL DIMMING UP TO 50%
X	D4	ERCO 33943.023-CUSTOM FINISH	LED	3000	28 28	EXTERIOR RATED SHIELDED BOLLARD FOR USE WITH (1) 28W LED MODULE AT 3000K. 35-7/16-INCH HIGH, 6-11/16-INCH DIAMETER. INTEGRAL 120V ELV DIMMING DRIVER. CUSTOM FINISH TO MATCH "NERI GREY" SAMPLE.	FINISH TO BE CONFIRMED BY ARCHITECT/OWNER.
-0-	P5	LITHONIA (2)-DSX0-40C-1000-30K-T3M-?-SPA-DM G-PIRH1FC3V?-DDBXD/ SSS-18-4.0 x 18.0-DM28-VD-DDB	LED	3000	276 276	DOUBLE HEAD POLE FOR USE WITH (2) 138W LED MODULES AT 3000K. ACRYLIC LENSES. TYPE III MEDIUM DISTRIBUTION OPTICS. PROVIDE WITH 18-FOOT POLE, 4-INCH SHAFT. PROVIDE 0-10V DIMMING DRIVER AND MOTION SENSOR. DARK BRONZE FINISH.	FINISH TO BE CONFIRMED BY OWNER. MOUNT ON CONCRETE PIER AS REQUIRED BY STRUCTURAL ENGINEER. POLE HEIGHT INDICATED INCLUDES CONCRETE PIER HEIGHT.
©	De	LANDSCAPE FORMS HW-006L4-035F-30K	LED	3000	7.8 7.8	EXTERIOR RATED DECORATIVE BOLLARD FOR USE WITH (1) 7.8W LED MODULE AT 3000K. THERMOFORMED LENS DIFFUSER. TYPE IV OPTICS. 37-INCH OVERALL HEIGHT. INTEGRAL DRIVER. PROVIDE 0-10V DIMMING. FINISH TBD.	FINISH TO BE DETERMINED BY LANDSCAPE ARCHITECT/OWNER.
þ	S1	COLE LIGHTING L2100RW-TP-[VOLT?]-[FINISH?]-27K-K1	LED	2700		RECESSED EXTERIOR RATED ROUND STEPLIGHT FOR USE WITH 9.18W, 909 LUMEN LED MODULES AT 2700K. 9-INCHES DIAMETER. CLEAR TEMPERED GLASS LENS, SANDBLASTED ON LAMP SIDE. ALUMINUM LOUVER TRIM. FINISH TBD.	FINISH TO BE DETERMINED BY ARCHITECT/OWNER.
(W1	LUMASCAPE LS793LED-6H6-LH-13-DIM-U- SR-00490	LED	3000	6 6	INGRADE ADJUSTABLE UPLIGHT FOR USE WITH (1) 6W LED MODULE AT 3000K. 316 MARINE GRADE STAINLESS STEEL CONSTRUCTION. 3.8-INCH APERTURE. 40-DEGREE BY 20-DEGREE LINEAR HORIZONTAL OPTIC WITH ROUND FLUSH TRIM. INTERNAL GLARE CONTROL. PVC CONCRETE POUR HOUSING WHERE INDICATED. REMOTE 0-10V DIMMING TRANSFORMER REQUIRED. FINISH TBD.	FINISH TBD BY ARCHITECT. REMOTE TRANSFORMER(S) TO BE LOCATED IN ACCORDANCE WITH MANUFACTURER GUIDELINES AND IN COORDINATION WITH LANDSCAPE ARCHITECT. CONTRACTOR TO VERIFY TRANSFORMER QUANTITIES AND CAPACITIES TO ENSURE COMPLETE WORKING SYSTEM.
\blacksquare		DURALAMP 1DU2503-MODS: BRONZE TRIM RING, WITH 1DU3423, 1DU2521	LED	3000	11 11	IN-GRADE FLUSH MOUNTED ADJUSTABLE UPLIGHT FOR USE WITH (1) 11W LED MODULE AT 3000K. 6.34-INCH APERTURE. FLOOD OPTIC. PROVIDE HONEYCOMB ANTI-GLARE LOUVER. PROVIDE INSTALLATION SLEEVE. INTEGRAL DRIVER. PROVIDE DIMMING. BRONZE TRIM FINISH.	FINISH TO BE CONFIRMED BY OWNER.
	W3	DURALAMP 1DU2503-MODS: WITH IDU2525B BRONZE TRIM RING, WITH 1DU3423, WITH 1DU2521 WITH 1DU4343 RAISED TUBE	LED	3000	11 11	MID-GRADE MOUNTED ADJUSTABLE UPLIGHT FOR USE WITH (1) 11W LED MODULE AT 3000K. 6.34-INCH APERTURE. FLOOD OPTIC. PROVIDE HONEYCOMB ANTI-GLARE LOUVER. PROVIDE INSTALLATION SLEEVE AND FIELD CUTTABLE RAISED INSTALLATION TUBE. INTEGRAL DRIVER. PROVIDE DIMMING. BRONZE TRIM FINISH.	RAISED TUBE HEIGHT TO DETERMINED PER FIELD CONDITIONS. FINISH TO BE CONFIRMED BY OWNER.
	1 1/1/1	DURALAMP 1DU2400-DL2325B WITH 1DU2402, 1DU2394	LED	RGBW	41 41	IN-GRADE FLUSH MOUNTED ADJUSTABLE UPLIGHT FOR USE WITH (1) 41W RGBW LED MODULE. 8.27-INCH APERTURE. ZOOM OPTICAL SYSTEM. FLAT CLEAR LENS. PROVIDE HONEYCOMB ANTI-GLARE LOUVER. PROVIDE INSTALLATION SLEEVE. INTEGRAL DRIVER. PROVIDE DMX CONTROL WITH SEPARATE DMX IN AND DMX OUT CABLES. BRONZE TRIM FINISH.	DMX STARTING ADDRESS AND LABEL APPLIED AT FACTORY. FINISH TO BE CONFIRMED BY OWNER.
	W5	DURALAMP 1DU2400-DL2325B WITH 1DU2402, 1DU2394 WITH 1DU4343 RAISED TUBE	LED	RGBW	41 41	MID-GRADE MOUNTED ADJUSTABLE UPLIGHT FOR USE WITH (1) 41W RGBW LED MODULE. 8.27-INCH APERTURE. ZOOM OPTICAL SYSTEM. FLAT CLEAR LENS. PROVIDE HONEYCOMB ANTI-GLARE LOUVER. PROVIDE INSTALLATION SLEEVE AND FIELD CUTTABLE RAISED INSTALLATION TUBE. INTEGRAL DRIVER. PROVIDE DMX CONTROL WITH SEPARATE DMX IN AND DMX OUT CABLES. BRONZE TRIM FINISH.	RAISED TUBE HEIGHT TO DETERMINED PER FIELD CONDITIONS. DMX STARTING ADDRESS AND LABEL APPLIED AT FACTORY. FINISH TO BE CONFIRMED BY OWNER.
	1	TARGETTI KPL-10-ZM-L2-30-DL2325B/ 1T1699/ 1DU2402, 1DU2394 WITH 1DU4343 RAISED TUBE	LED	3000	41 41	MID-GRADE MOUNTED ADJUSTABLE UPLIGHT FOR USE WITH (1) 36W LED MODULE AT 3000K. 8.27-INCH APERTURE. ZOOM OPTICAL SYSTEM. FLAT CLEAR LENS. PROVIDE HONEYCOMB ANTI-GLARE LOUVER. PROVIDE INSTALLATION SLEEVE AND FIELD CUTTABLE RAISED INSTALLATION TUBE. INTEGRAL 0-10V DIMMING DRIVER. BRONZE TRIM FINISH.	RAISED TUBE HEIGHT TO DETERMINED PER FIELD CONDITIONS. FINISH TO BE CONFIRMED BY OWNER.
	1	DURALAMP 1DU2501-MODS: BRONZE TRIM RING, WITH 1DU2521	LED	3000	11 11	IN-GRADE FLUSH MOUNTED ADJUSTABLE UPLIGHT FOR USE WITH (1) 11W LED MODULE AT 3000K. 6.34-INCH APERTURE. SPOT OPTIC. PROVIDE INSTALLATION SLEEVE. INTEGRAL DRIVER. PROVIDE DIMMING. BRONZE TRIM FINISH.	FINISH TO BE CONFIRMED BY OWNER.
	21	COLOR KINETICS 523-000030-??	LED	2700	15 15/FT	SURFACE MOUNTED WET LOCATION RATED LINEAR ACCENT LIGHT FOR USE WITH LED AT 2700K. 15W PER LINEAR FOOT. 10-DEGREE BY 60-DEGREE BEAM ANGLE. RUN LENGTHS PER DRAWINGS. CLEAR POLYCARBONATE LENS. INTEGRAL ELV DIMMING DRIVER. ANODIZED ALUMINUM FINISH.	FINISH TO BE DETERMINED BY ARCHITECT/OWNER. CONTRACTOR TO PROVIDE ALL MOUNTING AND CONNECTING HARDWARE TO ENSURE COMPLETE WORKING SYSTEM.
	Z2	CALIFORNIA ACCENT LIGHTING ALS210T-F -SA-LED-2.7K-30D-8W [0-10V DM]-MO-[FEED?]-WET- [LENGTH?] BRACKET: ALS210T-MC-CUSTOM	LED	2700	8 8/FT	SURFACE MOUNTED WET LOCATION RATED LINEAR ACCENT LIGHT FOR USE WITH LED AT 2700K. 8W PER LINEAR FOOT. 30-DEGREE OPTIC WITH FROSTED LENS. SYSTEM LENGTHS PER DRAWINGS. INTEGRAL 0-10V DIMMING DRIVER. SATIN ALUMINUM FINISH.	FINISH TO BE DETERMINED BY ARCHITECT/OWNER. CONTRACTOR TO PROVIDE ALL MOUNTING AND CONNECTING HARDWARE TO ENSURE COMPLETE WORKING SYSTEM.
		LED LINEAR VARIO-LED-FLEX-SKYLLA-W825-?[LENGTH]- SV-IP67/ VARIOCLIP-SV-13000051	LED	2700		SURFACE MOUNTED EXTERIOR IP67 RATED FLEXIBLE LINEAR ACCENT LIGHT FOR USE WITH LED AT 2900K. 4.6W, 181 LUMENS PER LINEAR FOOT. RUN LENGTHS AND FIXTURE MOUNTING PER DRAWINGS. REMOTE 0-10V DIMMING DRIVER REQUIRED.	MOUNT FIXTURE WHERE INDICATED PER DETAIL SHEET. DRIVER(S) TO BE LOCATED IN ACCORDANCE WITH MANUFACTURER GUIDELINES AND IN COORDINATION WITH ARCHITECT. CONTRACTOR TO VERIFY DRIVER QUANTITIES AND CAPACITIES TO ENSURE COMPLETE WORKING SYSTEM
	Z5	ECOSENSE L35-I-?[LENGTH]-06-27-80-MULT-120/ LCDM-PL-120-277-010V-GR	LED	2700	6 6/FT	SURFACE MOUNTED CONTNUOUS LINEAR COVE LIGHT FOR USE WITH 6W, 450 LUMEN PER FOOT LED MODULE AT 2700K. ADJUSTABLE HINGED 120-DEGREE OPTICS. 1.64-INCH WIDTH BY 1.4-INCH HEIGHT. LENGTH PER PLANS. PROVIDE 0-10V DIMMING. ALUMINUM FINISH.	CONTRACTOR TO FIELD VERIFY FINAL SYSTEM LENGTHS AND MOUNTING ACCESSORIES AS NEEDED.
	Z5A	ECOSENSE L35-I-?[LENGTH]-08-27-80-MULT-120/ LCDM-PL-120-277-010V-GR/ KEC-A-COFFER-CUSTOM	LED	2700	8 8/FT	SURFACE MOUNTED CONTNUOUS LINEAR COVE LIGHT FOR USE WITH 8W, 576 LUMEN PER FOOT LED MODULE AT 2700K. ADJUSTABLE HINGED 120-DEGREE OPTICS. 1.64-INCH WIDTH BY 1.4-INCH HEIGHT. LENGTH PER PLANS. KNIFE EDGE COFFER COVE SYSTEM. PROVIDE 0-10V DIMMING. ALUMINUM FINISH.	CONTRACTOR TO FIELD VERIFY FINAL SYSTEM LENGTHS AND MOUNTING ACCESSORIES AS NEEDED.
LIGHTIN	Z7	PRUDENTIAL LIGHTING MIC-LED27-LO-?[LENGTH]-SC-UNV-DM10 OL EQUIPMENT	LED	2700		SURFACÉ MÔUNTED COVE LIGHT FOR ÚSE WITH 5W, 460 LÚMEN PÉR FOOT LED MODULE AT 2700K. 5 3/4-INCH WIDTH BY 2 3/8-INCH HEIGHT. LENGTH PER PLANS. SINGLE CIRCUIT. INTEGRAL 0-10V DIMMING DRIVER. ASYMMETRIC DISTRIBUTION.	CONTRACTOR TO FIELD VERIFY FINAL SYSTEM LENGTHS AND MOUNTING ACCESSORIES AS NEEDED.
	CS-4	ACUITY CONTROLS FCS-7TSN-?[OPTION]-?[FINISH]	N/A	N/A	6 6	WALL MOUNTED LCD TOUCHSCREEN CONTROL STATION. 7.9-INCHES WIDE BY 5.3-INCHES HIGH, 0.5-INCHES PROJECTION. 7-INCHES VIEWABLE AREA. REMOTE POWER SUPPLY. FINISH TBD.	FINISH TO BE DETERMINED BY OWNER. LOCATE DEVICE IN ELECTRICAL ROOM ADJACENT TO LIGHTING CONTROL PANEL. DEVICE REQURIES DIGITAL DATA CONNECTION TO LIGHTING CONTROL SYSTEM. REFER TO MANUFACTURER SHOP DRAWINGS FOR EXACT WIRE TYPE, QTY, TOPOLOGY AND LENGTH RESTRICTIONS.
	00	ACUITY CONTROLS FCS-7TSN-?[OPTION]-?[FINISH]	N/A	N/A	6 6	WALL MOUNTED LCD TOUCHSCREEN CONTROL STATION. 7.9-INCHES WIDE BY 5.3-INCHES HIGH, 0.5-INCHES PROJECTION. 7-INCHES VIEWABLE AREA. REMOTE POWER SUPPLY. FINISH TBD.	FINISH TO BE DETERMINED BY OWNER. LOCATE DEVICE IN ELECTRICAL ROOM ADJACENT TO LIGHTING CONTROL PANEL. DEVICE REQURIES DIGITAL DATA CONNECTION TO LIGHTING CONTROL SYSTEM. REFER TO MANUFACTURER SHOP DRAWINGS FOR EXACT WIRE TYPE, QTY, TOPOLOGY AND LENGTH RESTRICTIONS.
	000	ACUITY CONTROLS FCS-7TSN-?[OPTION]-?[FINISH]	N/A	N/A	6 6	WALL MOUNTED LCD TOUCHSCREEN CONTROL STATION. 7.9-INCHES WIDE BY 5.3-INCHES HIGH, 0.5-INCHES PROJECTION. 7-INCHES VIEWABLE AREA. REMOTE POWER SUPPLY. FINISH TBD.	FINISH TO BE DETERMINED BY OWNER. LOCATE DEVICE IN ELECTRICAL ROOM ADJACENT TO LIGHTING CONTROL PANEL. DEVICE REQURIES DIGITAL DATA CONNECTION TO LIGHTING CONTROL SYSTEM. REFER TO MANUFACTURER SHOP DRAWINGS FOR EXACT WIRE TYPE, QTY, TOPOLOGY AND LENGTH RESTRICTIONS. FINISH TO BE DETERMINED BY OWNER. LOCATE DEVICE IN
	000	ACUITY CONTROLS FCS-7TSN-?[OPTION]-?[FINISH]	N/A	N/A	6 6	WALL MOUNTED LCD TOUCHSCREEN CONTROL STATION. 7.9-INCHES WIDE BY 5.3-INCHES HIGH, 0.5-INCHES PROJECTION. 7-INCHES VIEWABLE AREA. REMOTE POWER SUPPLY. FINISH TBD.	FINISH TO BE DETERMINED BY OWNER. LOCATE DEVICE IN ELECTRICAL ROOM ADJACENT TO LIGHTING CONTROL PANEL. DEVICE REQURIES DIGITAL DATA CONNECTION TO LIGHTING CONTROL SYSTEM. REFER TO MANUFACTURER SHOP DRAWINGS FOR EXACT WIRE TYPE, QTY, TOPOLOGY AND LENGTH RESTRICTIONS.

SEE GENERAL LIGHTING FIXTURE SCHEDULE NOTES FOR CRITICAL FIXTURE SPECIFICATION AND ORDERING INFORMATION.

NOTE:

OUTDOOR LIGHTING SYSTEMS HAVE BEEN DESIGNED AND WILL BE INSTALLED TO COMPLY WITH CALGreen SECTION # 5.106.8.

REVISIONS
DESCRIPTION DATE
2016-12-15
2017-03-24 BULLETIN 3
BULLETIN 4

SANTA CLARA SQUARE 3255 SCOTT BLVD, SANTA CLARA, CA 95054

IRMINE COMPANY
APARTMENT COMMUNITIES
690 N. MCCARTHY BLVD. SUITE 100 MILPITAS, CA 95035
TELEPHONE: (408) 957-1232 FAX: (408) 957-1212

SHEET TITLE
LIGHTING FIXTURE
SCHEDULE

SHEET NUMBER

11870 Pierce Street, Suite 160 Riverside, California 92505 951.299.4160 www.tk1sc.com Hong Vu - Electrical tk1sc Job #: 2015-0384

M RETAIL 11 4729 SF

26436 SF

SCHEDULE, PARKING TYPE IS LABELED AS VISITOR).

200 RETAIL PARKING STALLS ARE PROVIDED IN ADJACENT OFFICE PARKING

RETAIL OUTDOOR SEATING PARKING STALLS REQUIRMENTS ARE LOCATED

IN BUIDLING 1 GARAGE WITH 48 STALLS PROVIDED (SEE PARKING

6555 SF

9106 SF

179589 SF

248327 SF

SUPPORT

BUILDING TYPE 3A

BUILDING TYPE 3A

BUILDING TYPE 3A

BIKE PARKING PROVIDED

UNIT SCHEDULE MATRIX (IAC USE)

TENANT STORAGE NET AREA (IAC USE)

CITY **PARKING** TOTAL REQUIRED

VEHICULAR PARKING TABULATION

Туре	COUNT
Tenant - Accessible (9'-0" x 18'-0")	5
Tenant - Accessible EV Van (9'-0" x 18'-0")	1
Tenant - Accessible Van (9'-0" x 18'-0")	2
Tenant - Assigned (8'-6" x 18'-0")	147
Tenant - Assigned (9'-0" x 18'-0")	28
Tenant - EV (8'-6" x 18'-0")	12
Tenant - Standard (9'-0" x 18'-0")	8
Tenant - Universal (8'-6" x 18'-0")	23
Tenant -FEV (8'-6" x 18'-0")	26

EV STALLS REQUIRED FOR FUTURE INSTALLATION (10%): 252 * .1 = 25.2

PARKING - BUILDING 1 PROVIDED GUE	EST STALLS		
Туре	COUNT		
Guest - Accessible EV Van (9'-0" x 18'-0")	1		
Guest - EV (8'-6" x 18'-0")			
Guest - FEV (8'-6" x 18'-0")	2		
Guest Standard (8' 6" v 19' 0")	12		

ADA PARKING REQUIRED (5% OF PARKING PROVIDED): 16 * .05 = .8

PARKING - BUILDING 1 PROVIDED VISITO	OR PARKING
Type	COUNT
Visitor - Accessible (9'-0" x 18'-0")	2
Visitor - Accessible EV Van (9'-0" x 18'-0")	1
Visitor - EV (8'-6" x 18'-0")	2
Visitor - EV FUTURE (8'-6" x 18'-0")	5
Visitor - Standard (9'-0" x 18'-0")	8
Visitor - Universal (8'-6" x 18'-0")	30
	48

		2 BULLETIN 2	11.04.2016
UI DINO 4 DDOVIDED EMDLOVE	TE DADIZINO		
ILDING 1 PROVIDED EMPLOYE	E PARKING		
Туре	COUNT		
EV Van (9'-0" x 18'-0")	1		
18'-0")	2		
'-6" x 18'-0")	17		
	20		

SHEET TITLE PROJECT DATA

DATE

10.11.2016

REVISIONS

BULLETIN 1-1

S

PHASE-1

	JOB NO.				
HEET NUMBER	2013-10130				
	DATE				
GEN-2.2	09-07-16				
GLIN-Z.Z	SCALE				
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1900 Main Street, Suite 800 Irvine. California 92614 949.809.3388 www.mve-architects.com

01