


T.I. - TAPSILOG BISTRO

SANTA CLARA, CA

GENERAL NOTES

1. AIA DOCUMENT A201, LATEST EDITION ISSUED BY THE AMERICAN INSTITUTE OF ARCHITECTS, "GENERAL CONDITIONS FOR THE PERFORMANCE OF A CONTRACT" ARE HEREBY INCORPORATED INTO THESE DRAWINGS AND SHALL BE CONSIDERED AS PART OF THE REQUIREMENTS FOR THE COMPLETION OF WORK.
 2. ALL PERMITS REQUIRED BY THE CITY AND STATE AGENCIES SHALL BE APPLIED FOR AND OBTAINED BY THE CONTRACTOR AT HIS/HER SOLE EXPENSE.
 3. ALL CONSTRUCTION WORK SHALL BE PROVIDED IN ACCORDANCE WITH ALL LOCAL, STATE, AND FEDERAL CODES, WITH THE MOST STRINGENT ALWAYS APPLYING.
 4. THE CONTRACTOR SHALL IMMEDIATELY EXAMINE ALL PORTIONS OF THE SITE AFFECTING THIS PROJECT, AND BASE HIS/HER BID ON EXISTING CONDITIONS. ALL CONFLICTS OR OMISSIONS IN THE DRAWINGS SHALL BE REPORTED TO THE ARCHITECT AT THIS TIME. NO ALLOWANCE SHALL BE MADE FOR EXTRA EXPENSES TO THE CONTRACTOR DUE TO HIS/HER FAILURE TO COMPLY WITH THIS REQUIREMENT AND TO THOROUGHLY CONDUCT THIS EXAMINATION.
 5. THE CONTRACTOR SHALL CONFORM IN WRITING IMMEDIATELY FOLLOWING AWARDING OF THE JOB THE DELIVERY DATES OF ALL CONSTRUCTION MATERIALS REQUIRED BY THESE DRAWINGS. ANY MATERIALS WHOSE UNAVAILABILITY WILL AFFECT A DELAY IN AGREED UPON OCCUPANCY SHALL BE BROUGHT TO THE ATTENTION OF THE DESIGNER AT START OF WORK.
 6. ANY REQUEST FOR THE SUBSTITUTION OF SPECIFIED MATERIALS SHALL BE MADE TO THE DESIGNER IN WRITING WITH THE PROPER TIME FOR REVIEW OF EQUAL QUALITY AND PERFORMANCE, AND SHALL NOT BE PURCHASED WITHOUT WRITTEN APPROVAL.
 7. THE CONTRACTOR IS RESPONSIBLE FOR THE COORDINATION OF ALL SUBCONTRACTORS AND SHALL SCHEDULE ALL WORK TO MEET AGREED UPON COMPLETION DATES.
 8. CONTRACTORS SHALL PROTECT ALL EXISTING AREAS WITH FRAGILE EQUIPMENT FROM DAMAGE THROUGHOUT TIME OF CONSTRUCTION. AT OWNER'S REQUEST, CONTRACTOR SHALL ERECT A TEMPORARY ENCLOSURE OR PLASTIC SCREEN.
 9. CONTRACTOR SHALL KEEP JOB SITE CLEAN OF DIRT, DEBRIS, AND DUST WHICH COULD AFFECT FINISHED AREAS IN OR OUT OF JOB SITE, AND SHALL BE RESPONSIBLE FOR THE STORAGE AND REMOVAL, OR BURIAL ON A REGULAR BASIS.
 10. CONTRACTOR SHALL LEAVE PREMISES CLEAN AT THE COMPLETION OF WORK. CONTRACTOR SHALL PROVIDE PROFESSIONAL CLEANING SERVICES OF AREA INCLUDING WINDOWS, CARRIERS, CABINETS, AND WALLS.
 11. ALL DIMENSIONS ARE GIVEN FROM FACE TO FINISH UNLESS OTHERWISE NOTED. NO DIMENSIONS SHALL BE SCALED FROM DRAWINGS. NO DIMENSIONS ARE TO BE ADJUSTED WITHOUT WRITTEN APPROVAL OF THE DESIGNER.
 12. ALL WORK TO BE ACCEPTABLE, MUST BE IN COMPLIANCE WITH THESE DRAWINGS AND SPECIFICATIONS, AND MUST BE OF A QUALITY EQUAL TO OR BETTER THAN THE STANDARDS OF THE TRADE. FINISHED WORK SHALL BE FIRM, WELL-ANCHORED, IN TRUE ALIGNMENT, PLUMB, LEVEL, WITH SMOOTH, CLEAN, & UNIFORM APPEARANCE.
 13. CONTRACTOR SHALL SUBMIT SHOP DRAWINGS TO DESIGNER OF ALL FABRICATED ITEMS SUCH AS CABINETS, GLAZING, CUT SHEETS OF EQUIPMENT AND SAMPLES OF ACTUAL FINISH MATERIALS FOR APPROVAL PRIOR TO INSTALLATION.
 14. CONTRACTOR TO PROVIDE BLOCKING BEHIND ALL ELEMENTS REQUIRING SUPPORT. REVIEW REQUIREMENTS WITH DESIGNER.
 15. CONTRACTOR TO COORDINATE INSTALLATION OF ALL ITEMS WITH OTHER TRADES.
 16. A COMPLETE SET OF STAMPED APPROVED PLANS MUST BE ON THE JOB SITE.
 17. ALL CONTRACTORS & SUBCONTRACTORS MUST HAVE VALID CURRENT BUSINESS LICENSES BEFORE INSPECTIONS CAN BE MADE.
 18. ALL WORK SHALL REMAIN EXPOSED FOR INSPECTION. THIS INCLUDES BUILDING CONSTRUCTION AND DEFERRED FIRE PERMITS. IF ADEQUATE EXPOSURE IS NOT PROVIDED FOR INSPECTION PURPOSES, THERE MAY BE DELAYS IN GRANTING TCO OR FINALIZATION OF PERMITS(S).
- SANTA CLARA FIRE DEPT. NOTES/SEPARATE PERMITS REQUIRED DIRECTLY WITH SCFD**
- THE FOLLOWING ITEMS SHALL BE SEPARATE PERMITS APPLIED DIRECTLY TO THE SANTA CLARA FIRE DEPT.:
1. AUTOMATIC SPRINKLER SYSTEM (MODIFICATIONS)-
 2. FIRE ALARM SYSTEM
 3. REFRIGERATION SYSTEM
 4. COOKING OIL STORAGE TANKS (EXCEEDING 60 GALLONS)
 5. HOOD/DUCT FIRE SUPPRESSION SYSTEM
 6. CARBON DIOXIDE BEVERAGE SYSTEMS (EXCEEDING 100 LBS)
 7. INVERTER BATTERIES (IF APPLICABLE)
 8. HOOD/ANUL SYSTEM IS A DEFERRED SUBMITTAL FOR FIRE DEPT. PURPOSES.
 9. ALL HVAC UNITS ABOVE 2,000 CFM SHALL BE REQUIRED TO BE PROVIDED WITH DUCT SMOKE DETECTION AND SHALL BE REQUIRED TO BE CONNECTED TO THE FIRE ALARM SYSTEM.

SITE PLAN SCALE: 1/16" = 1'-0"

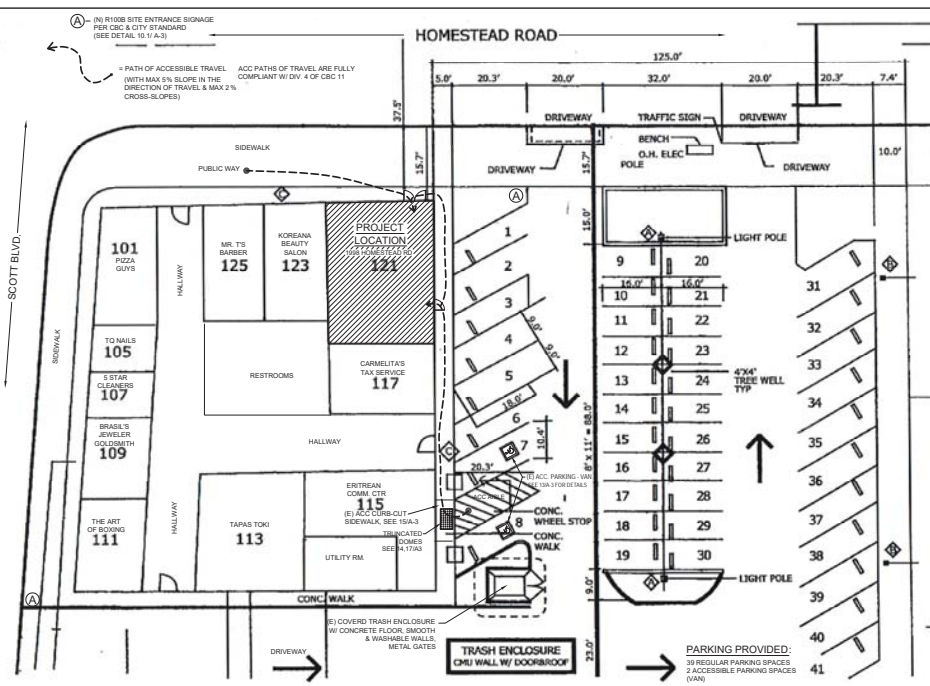

PROJECT DATA DESCRIPTION

Area: 1,200 SQ. FT. INTERIOR TENANT SPACE (WALLS OF WALLS NOT INCLUDED)

Construction Type: TYPE V-B, 1 STORY

Sprinkler System: NONE

Existing Use: VACANT (FORMER MESSAGE - GOLDEN BAY SPA)

Proposed Use: RESTAURANT (FILIPINO)

Disability Guidelines: THIS FACILITY WILL CONFORM TO ALL REQUIREMENTS OF CBC 11B DIVISION 6

Title 24: LIGHTING & AREA VENTILATION TO REMAIN THE SAME

Occupancy Load: GROUP B OCCUPANCY: OCC. LOAD 36 LESS THAN 50 - ONE EXIT REQ., TWO PUBLIC EXITS AVAILABLE

OCCUPANCY LOAD FACTOR CHART					
ROOMS	FUNCTION	LOAD FACTOR (S.F./P)	PERMITTED OCCUPANCY (P)	OCCUPANCY LOAD (P)	REMARKS
DRIVING AREA	DRIVING	150	150	150	AS THIS IS A CLASS B RESTAURANT, ONLY 111 ALL GROUND FLOOR ROOMS BOTH (1) LAY & (1) W.C. IS REQUIRED PER CBC 422.1 (EXCEPTION (3))
RESTAURANT	RESTAURANT	150	150	150	
TOTAL					36

PROJECT DIRECTORY			
ENGINEERING:	ARCHITECTING:	TENNANT:	CONTRACTOR:
HAROLD E. HOWELL, P.E.	GLENN CUNNINGHAM	EDMUND SANCHEZ	CASTILLO RESTAURANT SUPPLIES
1041A FOLGER AVE.	434 43RD AVENUE	434 43RD AVENUE	233 COMMERCIAL ST.
BREKELY, CA 94710	SAN FRANCISCO	819 W. HAMILTON AVE	SAN JOSE, CA 95112
510-549-0440	CA 94121	CAMPBELL, CA 95008	
haroldhowell954@gmail.com	510-301-3005 CELL	408-807-5827	tapsilogbistro@gmail.com

SCOPE OF WORK - TENANT IMPROVEMENT

NEW RESTAURANT IN EXISTING RETAIL SPACE. THIS WILL INVOLVE THE FOLLOWING WORK:

1. ADD NEW PARTITION WALLS. NONE TO BE INTRICATELY STRUCTURED TO BUILDING.
2. ELECTRICAL WORK AS REQUIRED FOR NEW PLAN.
3. PLUMBING WORK AS REQUIRED FOR NEW PLAN.
4. INSTALL COUNTERS AND COVE AS REQUIRED.
5. INSTALL AND PROVIDE FLOORING AND ALL OTHER REQUIRED FINISHES.
6. PROVIDE AND INSTALL NEW EQUIPMENT AS REQUIRED.
7. INSTALL HOOD SYSTEM AND RELATED EQUIPMENT.

ALL LIGHTING & AREA VENTILATION TO REMAIN AS EXISTING (NO CHANGE TO CEILING PLAN LAYOUT)

DEFERRED SUBMITTALS:

1. SIGNAGE
2. HOOD SUPPRESSION SYSTEM (ANSUL) TO BE UNDER SEPARATE PERMIT.

DEFERRED SUBMITTALS (CALC'S & DRAWINGS) SHALL BE REVIEWED & APPROVED BY THE ENGINEER OF RECORD PRIOR TO SUBMITTING TO THE CITY FOR REVIEW & APPROVAL.

APPLICABLE CODES


ALL WORK SHALL CONFORM TO ALL APPLICABLE CODES, ORDINANCES, AND REGULATIONS AS PRESCRIBED BY THE LOCAL CITY & COUNTY. CODES SHALL INCLUDE BUT ARE NOT NECESSARILY LIMITED TO:

2016 CALIFORNIA PLUMBING CODE AMENDMENTS	2016 CALIFORNIA FIRE CODE W/ CITY AMENDMENTS
2016 CALIFORNIA BUILDING CODE	2016 CALIFORNIA ELECTRICAL CODE
2016 CALIFORNIA MECHANICAL CODE	2016 CALIFORNIA ENERGY CODE

FEDERAL AND STATE DISABILITY GUIDELINES AND REGULATIONS AND ANY OTHER STATE REGULATIONS, CODES, & ORDINANCES AS AMENDED BY THE STATE OF CALIFORNIA AND LOCAL CITY & COUNTY THAT ARE APPLICABLE TO THIS PROJECT.

SHEET INDEX

- ARCHITECTURAL PLANS:**
- A-1 COVER SHEET, PROJECT DATA, VICINITY MAP, SITE PLAN
 - A-2 NEW CONSTRUCTION FLOOR PLAN, FIRE DEPT. NOTES, EQUIPMENT SCHEDULE
 - A-3 ACCESSIBILITY REQUIREMENTS
 - EH-1 ENVIRONMENTAL HEALTH DEPT. REQUIREMENTS, FINISH PLAN & DOOR SCH.
- ELECTRICAL PLANS:**
- E-1 ELECTRICAL PLAN & SCHEDULE, ELECTRICAL PANEL, LOAD CALC'S
- MECHANICAL HOOD PLANS:**
- M-1 HOOD, DUCT, & FAN SUPPORT DETAILS: ROOF PLAN (HOOD FANS)
 - M-2 MECHANICAL HOOD PLAN (CAPTIVE AIRE) - PLAN & ELEVATIONS
 - M-3 MECHANICAL HOOD PLAN (CAPTIVE AIRE) - EXHAUST & SUPPLY FAN
 - M-4 MECHANICAL HOOD ELECTRICAL DIAGRAMS
- PLUMBING PLANS:**
- P-0.1 PLUMBING KEY, TABLES & SCHEDULES
 - P-0.2 PLUMBING NOTES & WATER HEATER COMPLIANCE
 - P-2.0 PLUMBING PLANS - WASTE AND VENT, WATER & GAS SUPPLY, DETAILS
- S-1 STRUCTURAL PLANS - NEW PARTITION WALLS, EQUIPMENT (INCLUDING WALK-IN COOLER) SEISMIC**
- S-2 STRUCTURAL PLANS - HOOD SUPPORT DETAILS**
- * FOR BUILDING DEPT. ONLY

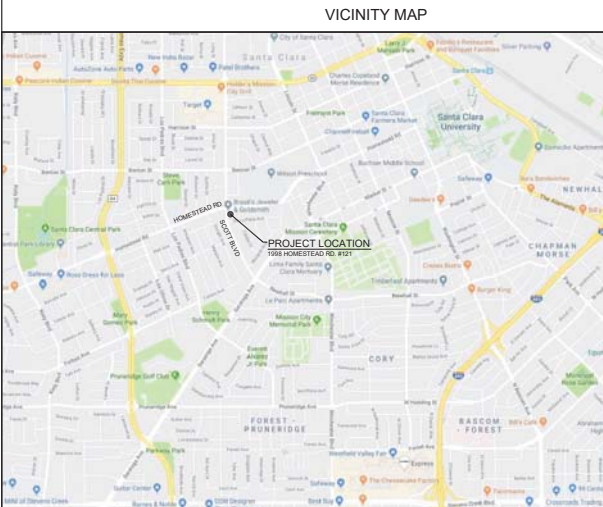

REV.	DATE	NO.
12/27/19		1



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THESE PLANS HAVE BEEN PREPARED BY ME OR UNDER MY CLOSE PERSONAL SUPERVISION AND I AM A LICENSED PROFESSIONAL ENGINEER IN THE STATE OF CALIFORNIA. I CERTIFY THAT I AM A duly Licensed Professional Engineer in the State of California, License No. 51067, and that I am the author of these plans. I am not providing these plans to any other party without your written consent. I am not providing these plans to any other party without your written consent. I am not providing these plans to any other party without your written consent.

T.I. - TAPSILOG BISTRO
1998 HOMESTEAD ROAD #121
SANTA CLARA, CA 95050

Date:	10/7/19
Drawn:	GOC
Sheet:	A-1

PANEL P-1			VOLTAGE: 120/240		WIRE: 3		MOUNTING: FLUSH		NOTES:	
			BUS RATING:		PHASE: 1		AIC RATING: 10K			
			MAIN REQ.: 175A		TYPE:		CONDITION: EXISTING			
Ckt #	LOAD	CB	LOAD DESCRIPTION	LOAD KVA	PHASE	LOAD KVA	LOAD DESCRIPTION	CB	LOAD	Ckt #
1	K	P T	FREEZER, SHORTY	1.4	A	1.1	WALK-IN COOLER	P T	2	K
3	K	1	TABLE, HOT FOOD	3.0	B	1.1	WALK-IN COOLER	2	20	K
5	K	1	REFRIGERATOR, SANDWICH/SALAD PREP	1.0	C	0.7	HOOD EXHAUST FAN*	2	20	M
7	K	1	FREEZER, WORKTOP	0.6	A	0.7	HOOD EXHAUST FAN*	2	20	M
9	K	1	ICE MAKER, U/C W/BIN	0.6	B	1.6	HOOD MAKE-UP AIR FAN*	1	20	M
11	K	1	DISPLAY CASE, REFRIGERATED	1.3	C	0.2	REC. - ROOF	1	20	G
13	K	1	DISPLAY CASE, REFRIGERATED	1.3	A	1.1	REC. - KITCHEN	1	20	G
15	C	1	LIGHTS/FAN - RESTROOMS	0.3	B	1.1	REC. - BACK	1	20	G
17	D	1	ALARM SYSTEM	0.2	C	0.4	REC. - FRONT SIGN	1	20	D
19			SPARE		A	0.4	REC. - WINDOWS	1	20	D
21					B	0.2	REC. - POS	1	20	D
23					C		SPARE			
25					A					
27					B					
29					C					
31					A					
33					B					
35					C					
37					A					
39					B					
41					C					

CONNECTED LOAD:		DEMAND LOAD CALCULATION			
PHASE A	_____ KVA	DEMAND	SUBTOTAL	NEC DEMAND FACTOR	KVA
PHASE B	_____ KVA	CONTINUOUS LOAD (C)	0.3	125%	0.4
PHASE C	_____ KVA	DEDICATED LOAD (D)	1.2	100%	1.2
		GENERAL RECEPTACLE (G)	2.4	100% of 1st 10KVA & 50% of remaining	2.4
		KITCHEN EQUIPMENT (K)	11.4	65%	7.4
		MECHANICAL EQUIPMENT (M)	3.0	125% of largest motor & 100% of remaining	3.4
		TOTAL DEMAND KVA		14.8	
				÷ 240	
*EXHAUST AND MAKE-UP AIR WILL BE ELECTRICALLY INTERLOCKED.				= AMPS @ 120/208, 3 PHASE, 4 WIRE:	61.7

ELECTRICAL PANEL SCHEDULE & LOAD CALC'S

ELECTRICAL NOTES:

1. SWITCHES, CONTROLS, THERMOSTATS, ETC., ARE TO BE INSTALLED NO HIGHER THEN 48" TO THE TOP OF THE BOX ABOVE FINISHED FLOOR.
2. RECEPTACLE OUTLETS TO BE INSTALLED TO BE NO LOWER THEN 18" TO THE BOTTOM OF BOX ABOVE FINISH FLOOR.
3. ALL ELECTRICAL WORK SHALL COMPLY WITH THE NEC 2016 CODE.
4. RACEWAYS WILL COMPLY WITH 2016 CEC.
5. ALL KITCHEN APPLIANCES AND MOTORS (IN COMPLIANCE WITH CEC) TO HAVE DISCONNECT SWITCH.
6. ALL FEEDERS AND ALL OTHER SYSTEMS (BRAC, FEEDERS, & EQUIPMENT WHIPS) TO COMPLY WITH NEC.
7. ALL ELECTRICAL PANELS SHALL BE PROPERLY LABELED.
8. ~~NEC DOCUMENTATION REGARDING THE SERIES RATED BREAKERS TO BE USED ON THE PROJECT WILL BE AVAILABLE FOR THE FIELD INSPECTION UPON REQUEST. THE SERIES RATED CONDUIT SHALL BE HIGHLIGHTED AND LABELED FOR THE INSPECTION USE. NO SERIES RATED BREAKERS~~
9. A PERMANENT PLAQUE OR DIRECTORY SHALL BE INSTALLED AT EACH SERVICE DISCONNECTING LOCATION IN COMPLIANCE WITH 2016 NEC ART.
10. ALL ELECTRICAL EQUIPMENT SHALL BE FIELD MARKED WARNING QUALIFIED PERSONAL OF THE POTENTIAL ARC FLASH HAZARDS AND THE APPROPRIATE PPE REQUIRED, PER 2016 CEC.
11. ALL KITCHEN APPLIANCES OF MORE THAN 1/2 HP TO BE PROVIDED WITH A UNIT SWITCH THAT COMPLIES WITH 2016 CEC.

CIRCUIT, CONDUIT, & GROUNDING NOTES:

FIELD VERIFY ALL EXISTING CONDITIONS
AIC RATINGS FOR ALL PANELS AND CIRCUIT BREAKERS TO BE PER CEC.
PANELS TO BE MARKED PER CEC ARTICLE 119-32
EQUIPMENT CONDUIT TYPES: ALL EMT (NO FLEX CABLE ALLOWED)
EQUIPMENT CONDUIT SIZES: ALL 120V USE #10 WIRE
ALL ABOVE 200V USE #10 WIRE

GROUNDING NOTE:
THE CONNECTION OF A GROUNDING ELECTRODE CONDUCTOR TO A GROUNDING ELECTRODE SHALL BE ACCESSIBLE, AND MADE IN A MANNER THAT WILL ASSURE A PERMANENT AND EFFECTIVE GROUND WHERE NECESSARY TO ASSURE THIS FOR A METAL PIPING SYSTEM USED AS A GROUNDING ELECTRODE. EFFECTIVE BONDING SHALL BE PROVIDED AROUND INSULATED CONTS AND SECTIONS AND AROUND ANY EQUIPMENT THAT IS LIKELY TO BE DISCONNECTED FOR REPAIRS OR REPLACEMENT. BONDING CONTRACTORS SHALL BE SUFFICIENT LENGTH TO PERMIT REMOVAL OF SUCH EQUIPMENT WHILE RETAINING THE INTEGRITY OF THE BOND.

ELECTRICAL SCHEDULE

Item No	Qty	Equipment Category	Manufacturer	Model Number	Equipment Remarks	Amps	KW	HP	Volts	Phase	Direct Plug	NEMA
5	1	FREEZER, SHORTY	DELFIELD	F2660	ON DEDICATED CIRCUIT	12.0	1.4	0.5	120	1	X	5-20P
6	1	TABLE, HOT FOOD	DUKE MANUFACTURING	E304	ON DEDICATED CIRCUIT	25.0	3.0		120	1	X	5-50P
7	1	REFRIGERATOR, SANDWICH/SALAD PREP	TRUE FOOD SERVICE	TSSU-48-12	ON DEDICATED CIRCUIT	8.6	1.0	0.33	115	1	X	5-15P
8	1	FREEZER, WORKTOP	TRUE FOOD SERVICE	TWT-27F	ON DEDICATED CIRCUIT	4.8	0.6	0.33	115	1	X	5-15P
9	1	ICE MAKER, U/C W/BIN	MANITOWOC ICE	UY-0190A	ON DEDICATED CIRCUIT	5.5	0.6	0.42	115	1	X	5-15P
15	2	DISPLAY CASE, REFRIGERATED	TURBO AIR	TQM-48RB	ON DEDICATED CIRCUIT	10.9	1.3	0.5	115	1	X	5-15P
16	1	WALK-IN COOLER	MASTER-BILT OR EQUAL	NANDSORLO-BPH	ON DEDICATED CIRCUIT	10	2.2	1.5	230	1	X	
20	1	TYPE 1 HOOD	ECON-AIR	16" X 4.5" W TYPE 1	SEE M-1 & M-3	6.0	1.4	1.5	230	1	X	
20.1	1	HOOD EXHAUST FAN	ECON-AIR	EABDU24HP	SEE M-1 & M-3	13.8	1.6	3	115	1	X	
20.2	1	HOOD MAKE-UP AIR FAN	FRIGIKING	650FD	SEE M-1 & M-3							

EXHAUST AND MAKE-UP AIR WILL BE ELECTRICALLY INTERLOCKED.


ELECTRICAL SYMBOLS

(ONLY SUGGESTED LOCATIONS FOR NEW EQUIPMENT OUTLETS & CONVENIENCE OUTLETS SHOWN - USE EQUIVALENT NEARBY EXISTING OUTLETS WHEN POSSIBLE)

- 120V DEDICATED SINGLE OUTLET (TO BE 18" ABOVE FLOOR UNLESS OTHERWISE NOTED)
 - 120V DUPLEX OUTLET (TO BE 18" OVER FLOOR UNLESS OTHERWISE NOTED)
 - 120V QUADPLEX OUTLET
 - 120V CEILING MOUNTED DUPLEX OUTLET; MOUNT ABOVE SHOW WINDOW, OUTLET & PLATE COVER SHALL MATCH CEILING, MOUNT PARALLEL WITH STORE FRONT.
 - JUNCTION BOX
 - TELEPHONE OUTLET, FLUSH MOUNTED IN WALL +36" (VON)
 - GROUND FAULT INTERRUPTED OUTLET (ALL KITCHEN OUTLETS)
 - SPECIAL OUTLET (SEE NEMA)
 - 120V DEDICATED SINGLE OUTLET (STUBBED UP 5')
 - 120V DUPLEX OUTLET (STUBBED UP 5')
 - TIME CLOCK (ASTRONOMICAL) - FOR WINDOW SIGNAGE ONLY; ALL OTHER LIGHTING CONTROLLED BY OCCUPANCY SENSORS, SEE SHEET LIG-1
- SEE M-1 ROOF PLAN FOR ELECTRICAL CONNECTIONS FOR HOOD FANS

ELECTRICAL SCOPE OF WORK:

1. NEW EQUIPMENT OUTLETS & CIRCUITS
2. EXISTING LIGHTING TO REMAIN

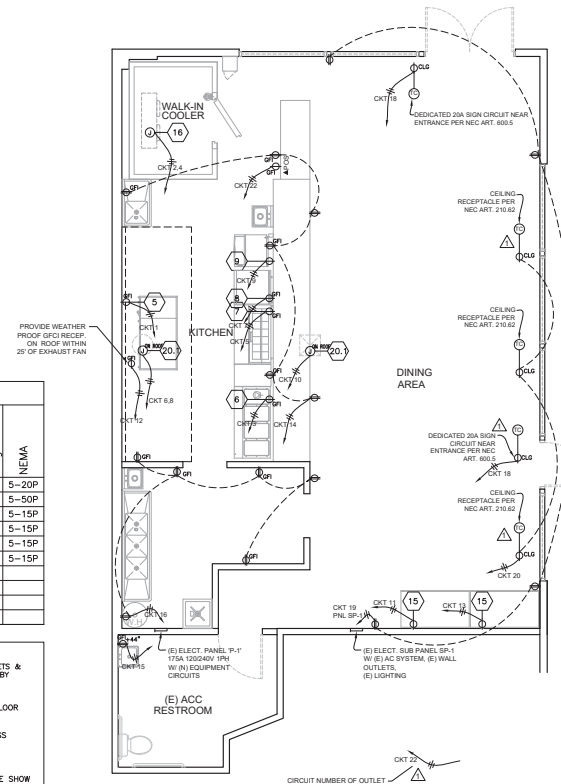

ELECTRICAL OUTLET PLAN

SCALE: 1/4" = 1'-0"

SEE SHEET M-1 FOR ROOF-TOP EQUIPMENT ELECTRICAL

REV. DATE NO.
12/27/19 1



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THE CONTRACTOR SHALL BE RESPONSIBLE FOR OBTAINING ALL NECESSARY PERMITS AND APPROVALS FROM THE APPROPRIATE AGENCIES. THE CONTRACTOR SHALL BE RESPONSIBLE FOR OBTAINING ALL NECESSARY PERMITS AND APPROVALS FROM THE APPROPRIATE AGENCIES. THE CONTRACTOR SHALL BE RESPONSIBLE FOR OBTAINING ALL NECESSARY PERMITS AND APPROVALS FROM THE APPROPRIATE AGENCIES.

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1998 HOMESTEAD ROAD #121
SANTA CLARA, CA 95050

Date: 10/7/19
Drawn: GOC
Sheet: E-1

GENERAL HEALTH DEPARTMENT NOTES

- GREASE TRAP LIDS AND FLOOR SINKS MUST BE INSTALLED FLUSH WITH THE FINISHED FLOOR.
- EACH PERMANENT FOOD FACILITY SHALL BE FULLY ENCLOSED IN A BUILDING CONSISTING OF PERMANENT FLOOR, WALLS, AND AN OVERHEAD STRUCTURE.
- INSTALL A MINIMUM FIVE (5) FOOT HIGH SMOOTH, WASHABLE, NONABSORBENT AND LIGHT COLORED WALL OR PARTITION AS MEASURED FROM THE FLOOR, BETWEEN THE JANITORIAL MOP SINK AND THE FOOD FROM THE FLOOR, BETWEEN THE JANITORIAL MOP SINK AND THE FOOD PREP SINK, THE WALL OR PARTITION MUST HAVE AN ACCEPTABLE MOISTURE RESISTANT FINISH ON THE SIDE FACING THE MOP SINK, SUCH AS FRP, STAINLESS STEEL, OR CERAMIC TILE.
- AT LEAST 16 SQUARE FEET OF DRY STORAGE IS PROVIDED IN 5 TIER WIRE SHELVING AND UNDER OVER SHELVING.
- NON NSF COUNTER/CABINET WILL HAVE PLASTIC LAMINATION INSIDE AND OUT, AND THE FLOOR MATERIAL WILL HAVE A CONTINUOUS COVE BASE ON THE EMPLOYEE SIDE.
- CONCRETE FLOORS ARE TO BE SEALED WITH A PENETRATING SEALER THAT IS GREASE, OIL, ACID AND MOISTURE RESISTANT AND APPROVED FOR COMMERCIAL USE.
- WHERE A SEALED CONCRETE FLOOR IS PROPOSED AND APPROVED INTEGRAL COVE BASE (SUCH AS AN APPROVED QUARRY OR CERAMIC TILE COVERED BASE) MUST BE KEV-ED-UP TO THE FLOOR SURFACE, TO KEV-IN, THE FLOOR IS BUILT OUT AT THE WALL/FLOOR JUNCTURE AND AN APPROVED COVERED BASE IS INSERTED AND GROUTED IN SO AS TO BE FLUSH, INTEGRAL, AND CONTINUOUS WITH THE FLOOR SURFACE.
- THE WALL SURFACES ADJACENT TO DRAINBOARDS & UTENSIL, MOP, AND FOOD PREPARATION SINKS SHALL BE COVERED WITH FIBERGLASS REINFORCED POLYESTER PANELS (FRP), T.I.E. STAINLESS STEEL, OR OTHER EQUIVALENT DURABLE WATERPROOF MATERIAL, EXTENDING AT LEAST 1' FEET ABOVE THE COVERED BASE FLOOR.
- THE WALL SURFACES AT LOW, FLOOR-TYPE MOP BASINS SHALL BE COVERED WITH FIBERGLASS REINFORCED POLYESTER PANELS (FRP), STAINLESS STEEL, CERAMIC TILE OR EQUIVALENT DURABLE WATERPROOF MATERIAL TO A MINIMUM HEIGHT OF 8 FEET ABOVE THE FLOOR.
- NON NSF COUNTER/CABINETS WILL HAVE PLASTIC LAMINATION INSIDE AND OUT, AND THE FLOOR MATERIAL WILL HAVE A CONTINUOUS COVE BASE ON THE EMPLOYEE SIDE.
- DISHWASHING CHEMICALS SHALL BE OFF THE FLOOR AT LEAST 6 INCHES ON EITHER AN ANCHORED DRAINAGE RACK OR ON WALL MOUNTED UNITS.
- ALL FOOD SERVICE AND RELATED EQUIPMENT SHALL BE NATIONAL SANITATION FOUNDATION (NSF) APPROVED AND IN CONFORMITY WITH LOCAL HEALTH REGULATIONS. INSTALLATIONS OF EQUIPMENT SHALL MEET SAME REQUIREMENTS. ALTHOUGH HEALTH REQUIREMENTS WILL BE REVIEWED DURING BUILDING DEPT. AUTHORIZATION, THE OWNER WILL HAVE TO TAKE OUT SEPARATE HEALTH PERMIT.
- ALL JOINING EQUIPMENT AND COUNTERS SHALL BE SEALED TOGETHER TO PREVENT THE ENTRANCE OF MOISTURE. MAXIMUM OPENING BELOW SNEEZE GUARD IS 1/4". A PORTABLE SNEEZE GUARD MAY BE USED IF THE HEALTH DEPT. APPROVES SIZE AND POSITIONING DURING CONSTRUCTION.
- ALL CUTTING BOARDS SHALL BE OF NON-WOOD CONSTRUCTION AND IN S.F. APPROVAL.
- ALL REFRIGERATION EQUIPMENT AND EQUIPMENT FOR HOT STORAGE SHALL HAVE THERMOMETERS WHICH ARE EASILY READABLE IN PROPER WORKING CONDITIONS AND ACCURATE WITHIN RANGE OF PLUS OR MINUS TWO DEGREES.
- STORAGE SHELVING MUST BE SPECIFIED AS HAVING SMOOTH, NONABSORBENT FINISH. THE LOWEST SHELF SHOULD BE 6" ABOVE FLOOR.
- EXHAUST HOODS MUST MEET ALL MECHANICAL CODE REQUIREMENTS. CANNOPY HOODS SHALL EXTEND IF BEYOND ALL SIDES OF COOKING EQUIPMENT AS MEASURED FROM INSIDE EDGE OF THE GREASE TROUGH. ADEQUATE MECHANICAL MAKE-UP AIR MUST BE PROVIDED TO PRODUCE A BALANCED SYSTEM. (MAKE-UP AIR SHALL BE EQUAL EXHAUSTED AIR.)
- TOILET AND DRESSING ROOMS SHALL BE MECHANICALLY VENTILATED BY EXHAUST FAN TO THE OUTSIDE PREMISES. THE EXHAUST FAN WITHIN EACH TOILET ROOM SHALL BE ACTIVATED BY THE SWITCH TO THE LIGHT FIXTURE LOCATED THEREIN AND CAPABLE OF 12 AIR CHANGES PER HOUR.
- CATERERS 3'-6" FOR ALL FLOOR/JOINTED EQUIPMENT, INSTALLATION ON SINK LEGS OR COMPLETELY SEALED IN POSITION ON AT LEAST A 4" HIGH CONTINUOUSLY COVERED BASE OR CONCRETE CURB.
- IF A HOT WATER (180 DEGREES F) SANITIZING RINSE DISHWASHING MACHINE IS INSTALLED IT WILL REQUIRE A TYPE 2 VAPOR HOOD WITH MECHANICAL EXHAUST.

- ATMOSPHERIC VACUUM BREAKERS OR OTHER APPROVED BACKFLOW PREVENTION DEVICES REQUIRED AT WATER SUPPLY LINES TO SINKS WITH THREADED SPOUTS, DISHWASHER, GARBAGE DISPOSAL, FLUSH LINES, STEAM EQUIPMENT, URINALS, TOILETS, BLOWAGE DISPENSERS, ICE MACHINE, LANDSCAPE IRRIGATION SYSTEMS, AND OTHER FIXTURE WHERE REQUIRED.
 - AT LEAST ONE SINK OR ONE SINK COMPARTMENT SHALL BE AVAILABLE FOR FOOD PREPARATION. FOOD PREP SINKS SHALL HAVE AND INDIRECT SEWER CONNECTION, I.E., FIXED IN-LINE AIR GAP OR DRAIN TO A FLOOR SINK THROUGH AN APPROVED AIR GAP.
 - A SEPARATE WALL-MOUNTED HAND WASHBASIN IS REQUIRED WITHIN OR ADJACENT TO THE FOOD PREP AND PACKAGING AREA. PROVIDE PERMANENTLY MOUNTED SINGLE SERVICE SOAP AND PAPER TOWEL DISPENSERS.
 - ALL SINKS TO BE PROVIDED WITH ADEQUATE HOT AND COLD WATER FROM MIXING FAUCETS.
 - BUILDING SHALL BE INSECT AND RODENT VERMIN PROOF. EXTERIOR DOORS SHALL BE SELF-CLOSING AND MUST COME WITHIN 1/4" OF FLOOR. ALL VENTS AND OTHER OPENINGS TO OUTSIDE NEED TO BE SEALED OR SCREENED. 16-MESH SCREENING IS REQUIRED ON ANY OPERABLE WINDOWS.
 - REUSE CONTAINER SHALL BE MOISTURE AND VERMIN PROOF WITH TIGHT FITTING LIDS.
 - ANY TRASH AND GARBAGE STORAGE AREA RECEIVING FOOD WASTE OR FOOD CONTAINERS MUST HAVE A WATER BIB TO FACILITATE CLEANING. FLOOR, WALLS AND CEILING MUST BE SMOOTH AND CLEANABLE. RECOMMENDED HOT AND COLD-WATER BIB IS AVAILABLE FOR CLEANING. WASTEWATER FROM MANY CLEANING OPERATIONS MUST BE DISPOSED OF AS SEWAGE THROUGH A FLOOR DRAIN IN THE TRASH ENCLOSURE OR EQUIVALENT.
 - PROVIDE A MOP OR ROOM RACK AND CLEANING SOLUTION STORAGE SHELVING AWAY FROM FOOD PREPARATION AND STORAGE AREAS.
 - EMPLOYEE GARMENT CHANGE AREA, SEPARATE FROM RESTROOM, IS REQUIRED. CABINETS OR LOCKERS MUST BE INSTALLED IN THIS AREA.
 - EQUIPMENT SHALL MEET OR BE EQUAL TO APPLICABLE N.E.F. STANDARDS OR IN THE ABSENCE OF APPLICABLE N.E.F. THE ENFORCEMENT OFFICER SHALL APPROVE STANDARDS. SUBMIT DOCUMENTATION OF WRITTEN VERIFICATION THAT ONLY APPROVED COMMERCIAL EQUIPMENT SHALL BE USED.
 - PROVIDE A SPACE OF AT LEAST 1" BETWEEN UTENSIL SINK AND ADJACENT WALL TO AVOID CALLED CRACKS, WHICH COLLECT WATER AND DEBRIS.
 - WALLS AND CEILINGS OF ALL ROOMS EXCEPT BARS, WHERE FOOD IS STORED IN UNOPENED CONTAINERS, AND DINING AREAS SHALL BE DURABLE, SMOOTH, NON-ABSORBENT AND WASHABLE. WALLS AND CEILINGS SHALL BE LIGHT COLORED. SEE DRAWINGS FOR SCHEDULES.
 - EACH METAL SINK COMPARTMENT MUST BE LARGE ENOUGH TO HOLD THE LARGEST UTENSILS TO BE WASHED IN THE SINK. EVERY UTENSIL SINK MUST HAVE 2" MIN. DRAIN BOARD. EACH DRAIN BOARD MUST BE INTEGRAL AND SHOULD BE AT LEAST AS LARGE AS ONE SINK COMPARTMENT.
 - ALL EXPOSED CONDUIT, PLUMBING, ETC. MUST BE INSTALLED AT LEAST 6" OFF THE FLOOR AND 4" FROM WALLS. ALL EXPOSED FLEX CONDUITS IS TO BE SEAL TIGHT OR EQUIVALENT.
 - THE JUNCTURE AT THE FLOOR AND THE WALL MUST HAVE A COVERED BASE WITH AT LEAST 36" RADIUS AND EXTENDING AT LEAST 6" UP THE WALL. STATIONARY FIXTURES OR BUILT-IN EQUIPMENT CAN BE SEALED ON A 4" HIGH 36" RADIUS CONCRETE CURB OR COVERED-IN POSITION ON THE FLOOR IT MUST BE COVERED WITH AN APPROVED MATERIAL.
 - PROVIDE AUTOMATIC DOOR CLOSURES ON ALL ENTRY, DELIVERY, RESTROOM AND CHANGE ROOM DOORS.
 - ALL AREAS MUST HAVE SUFFICIENT VENTILATION TO FACILITATE PROPER FOOD STORAGE AND TO PROVIDE A REASONABLE CONDITION OF COMFORT FOR ANY EMPLOYEE, CONSISTENT WITH THE JOB PERFORMED BY THE EMPLOYEE.
 - PROVIDE AT LEAST 1" SPACE BETWEEN SINKS AND SIDEWALL OR ANGLE SIDE SPLINES TO WALL.
 - ALL WORKING SURFACES SHALL BE SMOOTH AND IMPERVIOUS.
 - WHERE PIPELINES OR CONDUITS ENTER A WALL, CEILING OR FLOOR, THE OPENING AROUND THE LINE SHALL BE TIGHTLY SEALED AND MADE SMOOTH, NONABSORBENT AND EARLY CLEANABLE.
- TOILET ROOM NOTES:**
TOILET ROOM IS EXISTING.
- PERMANENTLY INSTALLED SOAP AND SANITARY TOWEL DISPENSERS.
 - TOILET TISSUE DISPENSER.
 - VENTILATION TO THE OUTSIDE AIR THROUGH AN OPENABLE SCREENED WINDOW, OR LIGHT-SWITCH ACTIVATED EXHAUST FAN.
 - SELF-CLOSING DOORS.
 - HAND WASH SINKS WITH HOT/COLD COMINATION WATER FAUCETS.

DOOR SCHEDULE






DOOR NO.	DOOR	REMARKS (ALSO SEE NOTE BELOW)
(C) = EXISTING	(N) = NEW	
(C) 1	MTL/GLASS AND ALUM 3' - 0" H x 3' - 0" W	BY SELF CLOSING DEVICE
(C) 2	WOOD PANEL 3' - 0" H x 3' - 0" W	OR CLOSURE, LEVER HANDLE, PUSHPAD LOCKSET PAINT DOOR TO MATCH ADJ. WALL COLOR
(N) 3	MTL PAINT 3' - 0" H x 3' - 0" W	OR DUAL ACTING DOOR W/ MIN. 200 SQ. IN. NEW PANEL (UNC 1003.3.1.5) SEE DETAIL 3.
(N) 4	MTL GALV. MTL 3' - 0" H x 3' - 0" W	NEARLY COLORED OR PRESSURE DOOR

DOOR NOTES


- ALL DOORS 1 3/8" THICK UNLESS OTHERWISE NOTED. (DOORS WITH GLASS LITE SHALL BE 1 1/2" THICK)
- PROVIDE STOPS AT ALL DOORS AS APPLICABLE TO ADJACENT WALL AND DOOR SWING, ALL WITH SELF CLOSING MECHANISM.
- HARDWARE ON ALL DOORS SHALL MEET HANDICAP HEIGHTS, CLOSURE PRESSURE, THRESHOLD SHALL NOT BE MORE THAN 1/2" HIGH. PRESSURE SHALL NOT EXCEED 5 LBS. ON EXTERIOR AND INTERIOR DOORS. 15 LBS. FOR FIRE DOORS. HARDWARE HEIGHT TO MEET REQUIREMENT OF 34" TO 44" CENTERLINE OFF MOUNTING.
- NO FLOOR TRANSITION OR THRESHOLD SHALL BE HIGHER THAN 1/2" (HANDICAP REQUIREMENT).
- WHERE NECESSARY, UNDERCUT DOORS 1" TO ALLOW VENTILATION. SEE MECHANICAL DRAWINGS.
- DOORS AND FRAMES TO BE PREPARED FOR RELATED HARDWARE. IF NECESSARY, REINFORCE DOORS AND FRAMES AS REQUIRED BY HARDWARE.
- FIRE DOORS, FRAMES, HARDWARE AND ALL OTHER DOORS OPERATION SHALL BE IN STRICT COMPLIANCE WITH ALL APPLICABLE CODES.
- PROVIDE ALL ACCESSORIES, COMPONENTS, ASSEMBLIES AND RELATED HARDWARE (EVEN IF NOT SPECIFIED) SO AS TO MAKE COMPLETE AND READY FOR USE.
- GENERAL CONTRACTOR TO PROVIDE ON 12" EQUILATERAL TRIANGLE SIGN FOR MEN AND 12" DIAMETER CIRCLE FOR WOMEN ON TOILET DOORS WITH RAISED LETTER AND BRAGUE SIGNAGE AT LATCH OUTSIDE RESTROOMS (ENTRANCE DOORS). MOUNTED 6" ABOVE TILE FLOOR AND ILLUSTRATED TO ALLOW AN INDIVIDUAL TO APPROACH WITHIN 4'.
- ALL EXTERIOR DOORS SHALL BE OPERABLE FROM THE EXTERIOR WITHOUT THE USE OF A KEY OR ANY SPECIAL KNOWLEDGE OR EFFORT. KEY LOCKING HARDWARE MAY BE USED ON THE MAIN ENTRY WHEN THERE IS A READILY VISIBLE, DURABLE SIGN ON OR ADJACENT TO THE DOOR STATING "THIS DOOR MUST REMAIN UNLOCKED WHILE THIS SPACE IS OCCUPIED". 2014 CBC 100.1.3.3.
- ALL EXTERIOR & RESTROOM DOORS TO HAVE SELF-CLOSING DEVICES; GAPS UNDER EXTERIOR DOORS NOT TO EXCEED 1/4".
- LOWER 90° OF DOOR SURFACE IS PROVIDED WITH A SMOOTH SURFACE FOR THE FULL WIDTH OF THE DOOR, AT THE PUSH SIDE OF THE DOOR PER CBC 114-4.2.10.

CEILING / LIGHTING NOTES:

- PROVIDE PLASTIC TUBE GUARDS WITH PLASTIC END HOLDERS FOR EXPOSED FLUORESCENT LAMPS IN FOOD PREPARATION AREAS OR IN AREAS WHERE FOOD IS EXPOSED.
- LIGHT FIXTURES IN AREAS WHERE FOOD IS PREPARED OR WHERE OPEN FOOD IS STORED OR WHERE UTENSILS ARE CLEANED MUST HAVE SHATTER PROOF SHIELDS AND SHALL BE READILY CLEANABLE. SAFETY SHIELDS TO MEET OSHA, FDA, AND USDA REQUIREMENTS.
- ALL FLUORESCENT LAMPS TO BE "COOL WHITE" NO SUBSTITUTIONS.
- IN EVERY ROOM & AREA IN WHICH ANY FOOD IS PREPARED, MANUFACTURED, PROCESSED, OR PREPACKAGED, OR IN WHICH EQUIPMENT OR UTENSILS ARE CLEANED, SUFFICIENT NATURAL OR ARTIFICIAL LIGHTING SHALL BE PROVIDED TO PRODUCE THE FOLLOWING LIGHT INTENSITY, WHILE THE AREA IS IN USE:
 - AT LEAST 10' CANDLES AT A DISTANCE OF 30' ABOVE THE FLOOR, IN WALK-IN REF. UNITS & DRY FOOD STORAGE AREAS.
 - AT LEAST 30' CANDLES FOR THE FOLLOWING:
 - AT A SURFACE WHERE FOOD IS PROVIDED FOR CONSUMER SELF-SERVICE OR WHERE FRESH PRODUCE OR PREPACKAGED FOODS ARE SOLD OR OFFERED FOR CONSUMPTION.
 - INSIDE EQUIPMENT SUCH AS REACH-IN AND UNDER-COUNTER REFRIGERATORS, HOT HOLD EQUIPMENT, & OVENS.
 - AT A DISTANCE OF 30' ABOVE THE FLOOR IN AREAS USED FOR HANDWASHING, WAREWASHING, & EQUIPMENT & UTENSIL STORAGE, & IN TOILET ROOMS.
 - AT LEAST 50' CANDLES AT A SURFACE WHERE A FOOD EMPLOYEE IS WORKING WITH FOOD OR WORKING WITH UTENSILS OR EQUIPMENT SUCH AS KNIVES, SLICERS, GRINDERS, OR SAWS WHERE EMPLOYEE SAFETY IS A FACTOR AND IN OTHER AREAS AND ROOMS DURING PERIODS OF CLEANING.

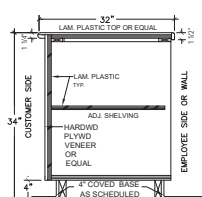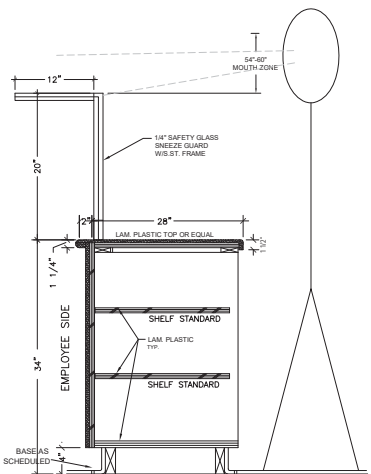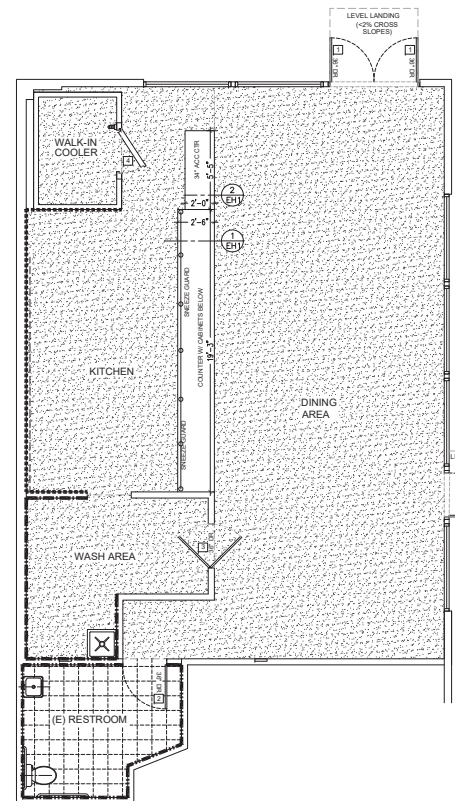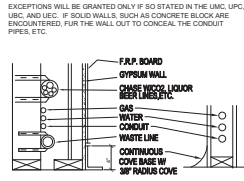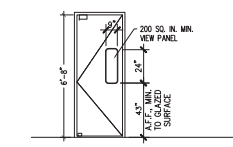

TYPICAL BASE COVING

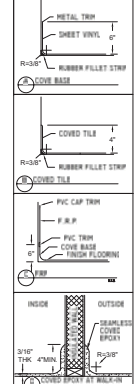

ROOMS	FINISHES	NOTES
KITCHEN	1. CARPET AND PAD, MAX FILE HT OF 1/2" IF NO PAD-BACKING 2. EXISTING CERAMIC TILE 3. SOLID SHEET VINYL, COMMERCIAL GRADE (ALTO STONGHOLD 90 OR EQUAL), HEAT WELD BEAMS 4. 6" X 6" QUARRY TILE W/ GREASE RESISTANT EPOXY GROUT 5. NSF APPROVED PANEL, INSULATED FLOOR 6. 4" INTEGRAL METAL COVE, APPLY COMMERCIAL GRADE SEALANT BETWEEN BASE AND PANEL 7. INTEGRAL COVERED SHEET VINYL, CONTINUOUS W/ 3/8" RAD. 8. COVERED WOOD MOLDING 9. 4" INTEGRAL COVERED EPOXY W/ 3/8" RAD. 10. 4" COVERED CERAMIC TILE, CONTINUOUS W/ 3/8" RAD. 11. 6" X 6" TYPE "X" GYPSUM BOARD 12. (E) CERAMIC TILE TO 4" ABOVE COVERED BASE 13. SMOOTH FINISHES, WITHOUT TEXTURE, PAINTED SURFACES TO BE OIL OR ENAMEL BASED (BIRM GLOSS) 14. STUCCO GALVANIZED STEEL 15. STAINLESS STEEL SHEET (BACK & SIDE OF HOOD TO FLOOR) 16. TOP BOARD FULL HEIGHT TO CEILING, @ JARCS BEHIND SINKS & OTHER WET EQUIPMENT 17. EXISTING HAROLD CEILING (PAINT AS NEEDED) 18. SMOOTH, CLEANABLE, NO TEXTURE, LITE COLOR, OIL OR ENAMEL BASED PAINT 19. T-BAR GYP BD CEILING W/ REMOVABLE SMOOTH AND WASHABLE TILE 20. T-BAR GYP BD CEILING W/ ACOUSTICAL CORRUGATED TILE LAY-IN 21. EXPOSED CEILING PAINTED BLACK 22. STUCCO GALVANIZED STEEL	
DINING AREA	1. CARPET AND PAD, MAX FILE HT OF 1/2" IF NO PAD-BACKING 2. EXISTING CERAMIC TILE 3. SOLID SHEET VINYL, COMMERCIAL GRADE (ALTO STONGHOLD 90 OR EQUAL), HEAT WELD BEAMS 4. 6" X 6" QUARRY TILE W/ GREASE RESISTANT EPOXY GROUT 5. NSF APPROVED PANEL, INSULATED FLOOR 6. 4" INTEGRAL METAL COVE, APPLY COMMERCIAL GRADE SEALANT BETWEEN BASE AND PANEL 7. INTEGRAL COVERED SHEET VINYL, CONTINUOUS W/ 3/8" RAD. 8. COVERED WOOD MOLDING 9. 4" INTEGRAL COVERED EPOXY W/ 3/8" RAD. 10. 4" COVERED CERAMIC TILE, CONTINUOUS W/ 3/8" RAD. 11. 6" X 6" TYPE "X" GYPSUM BOARD 12. (E) CERAMIC TILE TO 4" ABOVE COVERED BASE 13. SMOOTH FINISHES, WITHOUT TEXTURE, PAINTED SURFACES TO BE OIL OR ENAMEL BASED (BIRM GLOSS) 14. STUCCO GALVANIZED STEEL 15. STAINLESS STEEL SHEET (BACK & SIDE OF HOOD TO FLOOR) 16. TOP BOARD FULL HEIGHT TO CEILING, @ JARCS BEHIND SINKS & OTHER WET EQUIPMENT 17. EXISTING HAROLD CEILING (PAINT AS NEEDED) 18. SMOOTH, CLEANABLE, NO TEXTURE, LITE COLOR, OIL OR ENAMEL BASED PAINT 19. T-BAR GYP BD CEILING W/ REMOVABLE SMOOTH AND WASHABLE TILE 20. T-BAR GYP BD CEILING W/ ACOUSTICAL CORRUGATED TILE LAY-IN 21. EXPOSED CEILING PAINTED BLACK 22. STUCCO GALVANIZED STEEL	
WASH AREA	1. CARPET AND PAD, MAX FILE HT OF 1/2" IF NO PAD-BACKING 2. EXISTING CERAMIC TILE 3. SOLID SHEET VINYL, COMMERCIAL GRADE (ALTO STONGHOLD 90 OR EQUAL), HEAT WELD BEAMS 4. 6" X 6" QUARRY TILE W/ GREASE RESISTANT EPOXY GROUT 5. NSF APPROVED PANEL, INSULATED FLOOR 6. 4" INTEGRAL METAL COVE, APPLY COMMERCIAL GRADE SEALANT BETWEEN BASE AND PANEL 7. INTEGRAL COVERED SHEET VINYL, CONTINUOUS W/ 3/8" RAD. 8. COVERED WOOD MOLDING 9. 4" INTEGRAL COVERED EPOXY W/ 3/8" RAD. 10. 4" COVERED CERAMIC TILE, CONTINUOUS W/ 3/8" RAD. 11. 6" X 6" TYPE "X" GYPSUM BOARD 12. (E) CERAMIC TILE TO 4" ABOVE COVERED BASE 13. SMOOTH FINISHES, WITHOUT TEXTURE, PAINTED SURFACES TO BE OIL OR ENAMEL BASED (BIRM GLOSS) 14. STUCCO GALVANIZED STEEL 15. STAINLESS STEEL SHEET (BACK & SIDE OF HOOD TO FLOOR) 16. TOP BOARD FULL HEIGHT TO CEILING, @ JARCS BEHIND SINKS & OTHER WET EQUIPMENT 17. EXISTING HAROLD CEILING (PAINT AS NEEDED) 18. SMOOTH, CLEANABLE, NO TEXTURE, LITE COLOR, OIL OR ENAMEL BASED PAINT 19. T-BAR GYP BD CEILING W/ REMOVABLE SMOOTH AND WASHABLE TILE 20. T-BAR GYP BD CEILING W/ ACOUSTICAL CORRUGATED TILE LAY-IN 21. EXPOSED CEILING PAINTED BLACK 22. STUCCO GALVANIZED STEEL	
(E) RESTROOM	1. CARPET AND PAD, MAX FILE HT OF 1/2" IF NO PAD-BACKING 2. EXISTING CERAMIC TILE 3. SOLID SHEET VINYL, COMMERCIAL GRADE (ALTO STONGHOLD 90 OR EQUAL), HEAT WELD BEAMS 4. 6" X 6" QUARRY TILE W/ GREASE RESISTANT EPOXY GROUT 5. NSF APPROVED PANEL, INSULATED FLOOR 6. 4" INTEGRAL METAL COVE, APPLY COMMERCIAL GRADE SEALANT BETWEEN BASE AND PANEL 7. INTEGRAL COVERED SHEET VINYL, CONTINUOUS W/ 3/8" RAD. 8. COVERED WOOD MOLDING 9. 4" INTEGRAL COVERED EPOXY W/ 3/8" RAD. 10. 4" COVERED CERAMIC TILE, CONTINUOUS W/ 3/8" RAD. 11. 6" X 6" TYPE "X" GYPSUM BOARD 12. (E) CERAMIC TILE TO 4" ABOVE COVERED BASE 13. SMOOTH FINISHES, WITHOUT TEXTURE, PAINTED SURFACES TO BE OIL OR ENAMEL BASED (BIRM GLOSS) 14. STUCCO GALVANIZED STEEL 15. STAINLESS STEEL SHEET (BACK & SIDE OF HOOD TO FLOOR) 16. TOP BOARD FULL HEIGHT TO CEILING, @ JARCS BEHIND SINKS & OTHER WET EQUIPMENT 17. EXISTING HAROLD CEILING (PAINT AS NEEDED) 18. SMOOTH, CLEANABLE, NO TEXTURE, LITE COLOR, OIL OR ENAMEL BASED PAINT 19. T-BAR GYP BD CEILING W/ REMOVABLE SMOOTH AND WASHABLE TILE 20. T-BAR GYP BD CEILING W/ ACOUSTICAL CORRUGATED TILE LAY-IN 21. EXPOSED CEILING PAINTED BLACK 22. STUCCO GALVANIZED STEEL	

FINISH NOTES

- RESTROOM IS EQUIPPED W/ TOILET PAPER ROLL DISPENSER, SOAP & PAPER TOWEL DISPENSER, TOILET COVER DISPENSER, MIRRORS, A.D.A. APPROVED GRAB BARS; SEE TOILET ROOM NOTES THIS PAGE. LOCATION REQ. DETAILS FOR SLODS, DEPT. ONLY.) ON SHEET A-3.
- NEW SMOOTH & WASHABLE TILE OVER FOOD PREP AREAS
- ALL WALLS BEHIND SINKS TO HAVE APPROVED WAINSCOT TO A MIN. OF 4" HIGH FROM TOP OF THE BASE COVE BEHIND ALL SINKS.
- EXISTING TO REMAIN: PATCH, REPAIR, & REPLACE TILE AS NECESSARY

WALLS WITH (E) CERAMIC PORCELAIN TILE ARE DESIGNATED BY:

WALLS WITH FRP ARE DESIGNATED BY:

WALLS WITH S.S. SHEET ARE DESIGNATED BY:

FINISH FLOOR PLAN

SCALE: 1/8" = 1'-0"

REV. DATE NO.




TAKAMI ENGINEERING GROUP, INC.
Harold E. Howell, P.E.
10414 Folger Ave., Berkeley CA 94710
510.549.0440 fax: 510.704.1975

GLENN CUNNINGHAM DESIGNER
BULL'S EYE CADD
c. (510) 301-3005
434 45TH AVENUE
SAN FRANCISCO, CA 94112
EMAIL: glenn@cungham.com

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T.J. TAPSILOG BISTRO
1988 HOMESTEAD ROAD #121
SANTA CLARA, CA 95050

Date: 10/7/19
Drawn: GOC
Sheet: EH-1

[illegible][illegible]

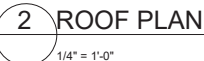ⓐ = JUNCTION BOX

[illegible]

HOOD INFORMATION - Job#4001167

HOOD NO.	TAG	MODEL	LENGTH	MAX. COOKING TEMP.	APPLIANCE DUTY	DESIGN CFM/Ft	TOTAL EXH. CFM	EXHAUST PLENUM RISERS							HOOD CONSTRUCTION	HOOD CONFIG. END TO END	ROW
								WIDTH	LENG.	HEIGHT	DIA.	CFM	VEL.	S.P.			
1		5424 EX-2	16' 0"	600 Deg.	Heavy	250	4000	14'	26'	4'	4000	1582	-0.503'	430 SS Where Exposed	ALONE	ALONE	

PATENT NUMBERS


Exhaust Hoods NO-2/BD-2/SND-2 (Canada) - CA Patent 2520435 C

HOOD INFORMATION


HOOD NO.	TAG	TYPE	FILTER(S)			EFFICIENCY @ 7 MICRONS	QTY.	LIGHT(S)			WIRE GUARD	LOCATION	SIZE	UTILITY CABINET(S)		ELECTRICAL	SWITCHES	FIRE HOOD SYSTEM	HOOD HANGING PIPING	WEIGHT
			QTY.	HEIGHT	LENGTH			TYPE	CFM	S.P.				TYPE	SIZE					
1		SS Baffle with Handles	12	20"	16"	30%	5	LSS Series E26	ND	ND	ND							ND	573 LBS	

HOOD OPTIONS

HOOD NO.	TAG	OPTION
1		LEFT END STANDOFF (FINISHED) 1' Wide 54" Long Insulated INSULATION FOR BACK OF HOOD LEFT WALL AS END PANEL

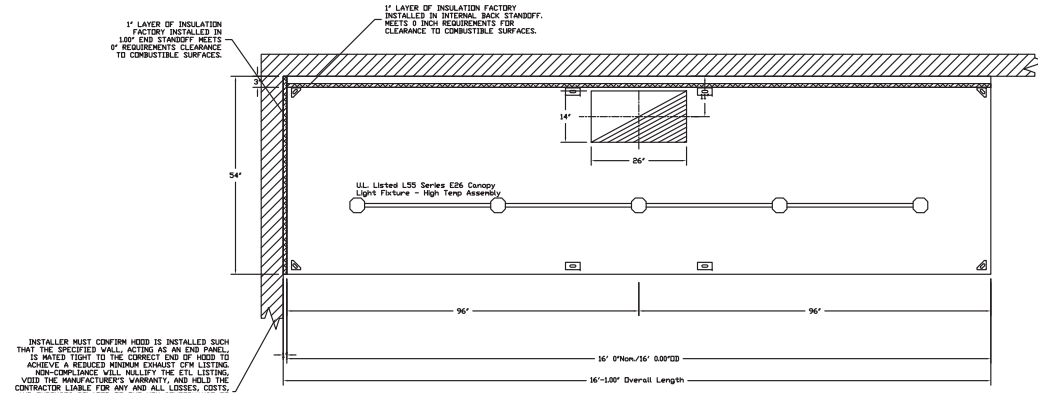


INSTALLER MUST CONFIRM HOOD IS INSTALLED SUCH THAT THE SPECIFIED WALL, ACTING AS AN END PANEL, IS MATED TIGHT TO THE CORRECT END OF HOOD TO ACHIEVE A REDUCED MINIMUM EXHAUST CFM LISTING. NON-COMPLIANCE WILL NULLIFY THE ETL LISTING, VOID THE MANUFACTURER'S WARRANTY, AND HOLD THE CONTRACTOR LIABLE FOR ANY AND ALL LOSSES, COSTS, AND EXPENSES RELATED TO THE NON-COMFORMANCE OF THE MANUFACTURER'S SPECIFIED INSTRUCTION. THE WALL ACTING AS AN END PANEL MUST EXTEND NO LESS THAN 20" FROM THE INTERSECTING WALL ON WHICH HOOD IS MOUNTED AND MUST EXTEND NO LESS THAN 10" OF UNDER BOTTOM OF HOOD TO BE ELIGIBLE FOR REDUCED MINIMUM EXHAUST CFM LISTING.

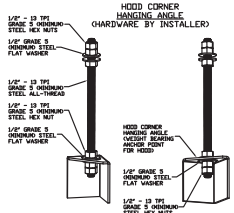


ASSEMBLY INSTRUCTIONS

HANGING ANGLE MUST BE SUPPORTED WITH 1/2" - 13 TPI GRADE 5 MINIMUM ALL-THREAD, SANDWICH HANGING ANGLES AND CEILING ANCHOR POINTS WITH 1/2" GRADE 5 MINIMUM STEEL FLAT WASHERS AND 1/2" - 13 TPI GRADE 5 MINIMUM HEX NUTS AS SHOWN. MUST USE DOUBLED HEX NUT CONFIGURATION BENEATH HOOD HANGING ANGLES AND ABOVE CEILING ANCHORS. MAINTAIN 1/4" OF EXPOSED THREADS BENEATH BOTTOM HEX NUT. TORQUE ALL HEX NUTS TO 57 FT-LBS.

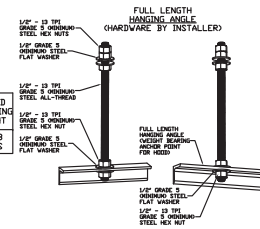

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SECTION VIEW - MODEL 5424EX-2
HOOD - #1

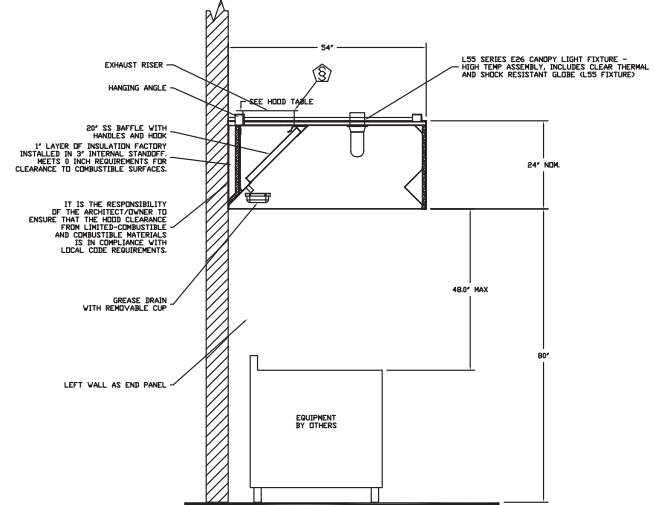

REVISIONS	DESCRIPTION	DATE
1		

ECON-AIR
Central CA
8 Adrian Court, Burlingame, CA 94010 PHONE: (415) 956-2203 FAX: (415) 227-5942 EMAIL: reg1@econair.com

Tapsilog Bistrot -
SAN JOSE, CA,

DATE:	9/30/2019
DWG.#:	4001167
DRAWN BY:	TT-91
SCALE:	3/4" = 1'-0"
MASTER DRAWING	

M-2
SHEET NO.
1

FOR QUESTIONS, CALL THE
CAPTIVE-AIR SYSTEMS
CENTRAL CALIFORNIA OFFICE

Region 11

8 ADRIAN COURT
BURLINGAME, CA 94010
PHONE: (415) 956-2200
EMAIL: REG1@CAPTIVEAIR.COM

ECON-AIR HOODS ARE
BUILT IN COMPLIANCE WITH



NSF #P6
UL TR-18 ULCTD STANDARDS
ETL LISTED 55480-001

KLEEN-GARD FILTERS
ARE BUILT IN COMPLIANCE WITH



NSF #P6
NSF STANDARD #2
UL STANDARD #1066
INT. MICH. CULC. (M)

EXHAUST FAN INFORMATION - Job#4001167

FAN UNIT NO.	TAG	FAN UNIT MODEL #	CFM	ESP.	RPM	H.P.	B.H.P.	#	VOLT	FLA	DISCHARGE VELOCITY	WEIGHT (LBS.)	SDNES
1		EABDU24HP	4000	1.000	886	1.500	1.1590	1	230	6.0	909 FPM	238	16.9

FAN OPTIONS

FAN UNIT NO.	TAG	OPTION (Qty. - Descr.)
1		1 - Grease Box 1 - Fan Base Ceramic Seal - Installed At Plant - For Grease Ducts


FAN ACCESSORIES

FAN UNIT NO.	TAG	EXHAUST	SUPPLY
		GREASE CUP GRAVITY DAMPER WALL MOUNT SIDE DISCHARGE GRAVITY DAMPER MOTORIZED DAMPER WALL MOUNT	
1		YES	

CURB ASSEMBLIES

NO.	DN FAN	WEIGHT	ITEM	SIZE
1	# 1	48 LBS	Curb	31.500"W x 31.500"L x 20.000"H Vented Hinged

FAN #1 EABDU24HP - EXHAUST FAN

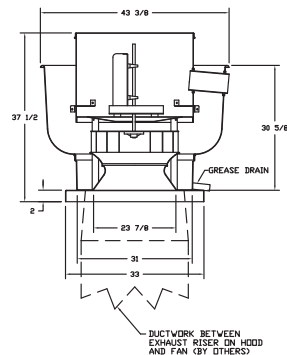

FEATURES:


- ROOF MOUNTED FANS
- RESTAURANT MODEL
- UL759 AND UL742 AND ULC-5645
- ANCA SOUND AND AIR CERTIFIED
- WIRING FROM MOTOR TO DISCONNECT SWITCH
- WEATHERPROOF DISCONNECT
- HIGH HEAT OPERATION 300°F (149°C)
- GREASE CLASSIFICATION TESTING

NORMAL TEMPERATURE TEST
EXHAUST FAN MUST OPERATE CONTINUOUSLY WHILE EXHAUSTING AIR AT 300°F (149°C) UNTIL ALL FAN PARTS HAVE REACHED THERMAL EQUILIBRIUM AND WITHOUT ANY DETRIMENTARY EFFECTS TO THE FAN WHICH WOULD CAUSE UNSAFE OPERATION.

ABNORMAL FLARE-UP TEST
EXHAUST FAN MUST OPERATE CONTINUOUSLY WHILE EXHAUSTING BURNING GREASE VAPORS AT 600°F (316°C) FOR A PERIOD OF 25 MINUTES WITHOUT THE FAN BECOMING DAMAGED TO ANY EXTENT THAT COULD CAUSE AN UNSAFE CONDITION.

OPTIONS


GREASE BOX
FAN BASE CERAMIC SEAL - INSTALLED AT PLANT - FOR GREASE DUCTS

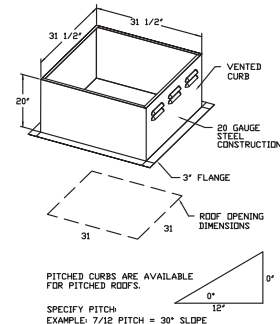

PITCHED CURBS ARE AVAILABLE FOR PITCHED ROOFS.

SPECIFY PITCH
EXAMPLE: 7/12 PITCH = 30° SLOPE

PHOENIX / FRIGIKING - DOWN DISCHARGE

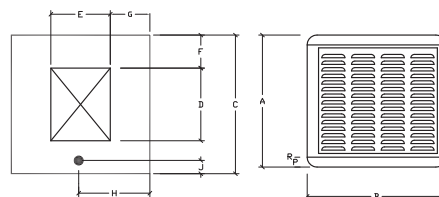

FEATURES

ALL WELDED, HOT DIPPED GALVANIZED STEEL CABINET.

MULTILAYER BOTTOM PAN FINISH

PEBLAR XT ARCHITECTURAL FINISH

HEAVY DUTY MOTOR AND PUMP

NOTES

RESIDENTIAL UNITS ARE 1 PHASE ONLY

MOTORS ARE SHIPPED LOOSE

COOLER CAN BE ORDERED AS A DOWN DISCHARGE OR END DISCHARGE

SUPPLY AIR UNIT DIMENSIONAL DATA

MODEL	CABINET DIMENSIONS											APPROX. WT.	
	A	B	C	D	E	F	G	H	J	K	P	OPER	SHIP
FRIGIKING 650FB	42.25	37	37	19.875	19.875	3.875	8.5625	8.5	5.25	-	-	290	177

FAN INFORMATION

FAN UNIT NO.	FAN UNIT MODEL #	EXHAUST FAN									SUPPLY FAN									
		MODEL	TAG	CFM	S.P.	RPM	H.P.	#	VOLT	FLA	BLOWER	HOUSING	TAG	CFM	S.P.	RPM	H.P.	#	VOLT	FLA
2	PHOENIX / FRIGIKING MUA-1										650FD	DOWN DISCH		3600	.5	446	.75	1	115	13.8



REVISIONS	DESCRIPTION	DATE
1		
2		
3		
4		
5		



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Central CA

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Tapsilog Bistrot -
SAN JOSE, CA,

DATE: 9/30/2019

DWG.#:
4001167

DRAWN BY: TT-91

SCALE:
3/4" = 1'-0"


MASTER DRAWING

M-3

SHEET NO.

2

NO.	TAG	PACKAGE #	LOCATION	SWITCHES		OPTION	FANS CONTROLLED				
				LOCATION	QUANTITY		TYPE	1	HP.	VOLT	FLA
1		SC-C1001102	Wall Mount In SS Box	05 - SS Wall Mount Box	1 Light 1 Fan	Smart Controls Basic	Exhaust	1	1,500	230	6.0
							Supply	1	0.750	115	11.0

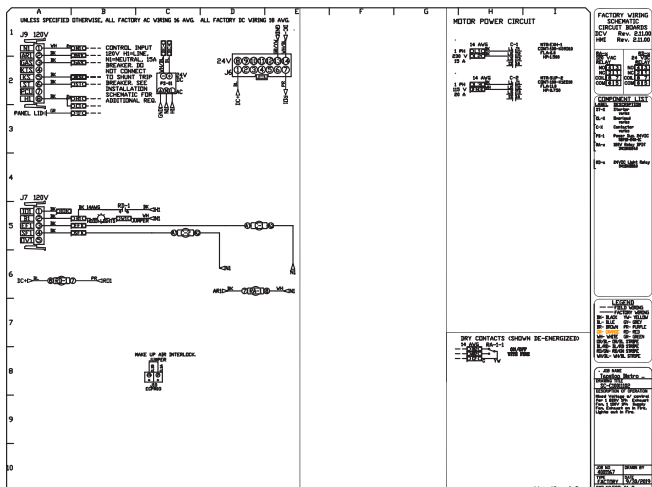

NOTE: MECHANICAL CONTRACTOR SHALL LOCATE AND MOUNT ELECTRICAL CONTROL BOX.

1. A PRE-WIRED ELECTRICAL CONTROL PACKAGE SHALL BE PROVIDED TO OPERATE THE HOOD LIGHTS AND FANS.


2. PACKAGE SHALL INCLUDE TWO 3-WIRE PHASES, WITH 120V SWITCHES AND RED-LEADED LINE SWITCHES, STATISTOR/RELAY, INDICATOR LIGHTS, 1/2" NPT 1/2" MOUNTING, 1/2" IN/OUT/PUT TERMINAL STRIPS, AND A TERMINAL FOR DOUBLE-ON/OFF FINE SYSTEMS MODIFICATION.

3. ONE RELAY IS NEEDED TO MONITOR IN (FINE SYSTEM) FOR SUPPLY FAN SHUTDOWN AND OVERHEAT. (SEE NOTE FOR ADDITIONAL FINE SYSTEM ACTIVATED DRY CONTACTS).

4. ELECTRICAL CONTROL DROPS FROM THE PANEL SHALL BE CONNECTED TO THE NEAREST TERMINAL. STOP CONTACTS SHALL BE THE FIRST AND LAST. LIGHTS AND FANS SHALL BE SUPPLIED BY THE ELECTRICAL CONTRACTOR.

5. LIGHT AND FAN SWITCHES CAPABLE OF 100A.

6. FIELDS WIRED TO HOODS AND EXHAUST FANS.

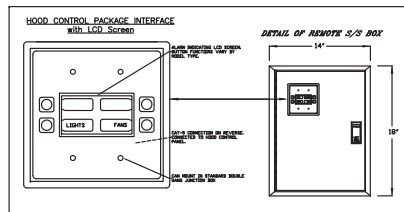

REVISIONS	
DESCRIPTION	DATE:
△	
△	
△	
△	



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Central CA

Tapsilog Bistro -
SAN JOSE, CA,

DATE: 9/30/2019

DWG.#:
4001167

DRAWN BY: TT-91

SCALE:
3/4" = 1'-0"

MASTER DRAWING

M-4

SHEET NO.

PIPING INSULATION SCHEDULE			
FLUID TEMPERATURE RANGE: 105-140(°F)			
PIPE SIZE:	< 1"	1" TO <1.5"	1.5" TO < 4"
INSULATION THICKNESS	1.0"	1.5"	1.5"
ALL INSULATION SHALL HAVE R VALUES OF 4.0 TO 4.6 PER INCH			

FIXTURE ID	DESCRIPTION	MANUFACTURER	MODEL	ROUGH-IN (inches)					REMARKS
				w	V	CW	HW	G	
GWH-1	GAS WATER HEATER	BRADFORD WHITE	ULC2PV50HS 63N	-	-	¾	¾	¾	48 GALLON CAPACITY, 56,000 BTU/HR GAS INPUT, ULTRA LOW NO. 5.1 GALLONS FIRST HOUR RECOVERY, 3" EXHAUST VENT, NEEDS 110V ELECTRICAL OUTLET FULL LINE SIZE T&P RELIEF DISCHARGE TO MOP SINK VIA 2" AIR GAP
FS-1	FLOOR SINK	ZURN	Z4150	SEE PLANS	2	-	-	-	12" x 12" RECEPTOR 6" SUMP DEPTH, WITH HALF GRATE
FD-1	FLOOR DRAIN	ZURN	ZS-890	SEE PLANS	-	-	-	-	TYPE-B STRAINER, NICKEL BRONZE, DURA-COATED CAST IRON, NO-HUB WITH 1/2" TRAP PRIMER CONNECTION.
TP-1	TRAP PRIMER	PRECISION PLUMBING PRODUCTS	P2 500	-	-	½	-	-	CORROSION RESISTANT, INSTALL AT LEAST 12" ABOVE THE TRAP TO INSURE PROPER FLOW, 1/2" MALE INLET, 1/2" FEMALE OUTLET PROVIDE AND INSTALL ACCESS PANEL
WHA-1	WATER HAMMER ARRESTOR	MIFAB	MWH-A	-	-	½	-	-	1-11 FU, 1/2" MPT CONNECTION
WCO-1	WALL CLEANOUT	ZURN	ZN-1468	SAME AS PIPE	-	-	-	-	SAME AS PIPE, POLISHED BRONZE
ET-1	EXPANSION TANK	AMTROL	ST-5-C	-	-	¾	-	-	2.0 GALLON CAPACITY; 0.45 ACCEPTANCE FACTOR 10 LBS TALL OPER. WT.
FCO-1	FLOOR CLEANOUT	ZURN	ZN-1400	SAME AS PIPE	-	-	-	-	SAME AS PIPE, BRONZE COVER
MV-1	MIXING VALVE	WILKINS	ZW3870XLT	-	-	½	-	-	SET OUTLET TEMPERATURE TO 110°F MAXIMUM, TO BE MOUNTED
MS-1	MOP SINK	FLORESTONE	87	3	2	½	½		FLOOR MOUNT, 24"-24"x12" DEEP WITH WALDMOUNT DELTA FAUCET # 2879, 8" CENTERS, 2 HANDLES, INTEGRAL STOPS, VACUUM BREAKER, HOSE-END SPOUT, WALL BRACE
RPZ-1	REDUCED PRESSURE ZONE ASSEMBLY	WATTS	SERIES 009	-	-	½	-	-	BRONZE BODY, DOUBLE CHECK VALVE AND DRAIN CONNECTION.
F-1	WATER FILTER	MANITOWOC	ARCTIC PURE 46-0000	-	-	½	-	-	LONG FILTER HOUSINGS, 1/2" INLET/OUTLET WITH SEDIMENT AND CARBON CARTRIDGE FILTER MOUNT 5FT ABOVE FINISHED FLOOR
GT-1	GREASE TRAP	THERMACO, TRAPIZILLA	TZ-600 ECA	4"	2"				95 LBS CAPACITY, 75 GPM FLOW, 4" INLET/OUTLET WITH 1 MINUTE FLOW CONTROL DEVICE, PROVIDE WITH LID EXTENSION, DIAMOND SHAPE STAMPED COVER, VENT TO ROOF.

































PLUMBING FIXTURE BY OTHERS (SHOWN FOR REFERENCE)								
ITEM	FIXTURE ID	DESCRIPTION	MANUFACTURER MODEL	ROUGH-IN				REMARKS
				W	V	CW	HW	
11	SK-2	PREP SINK W/DRAINBOARD	SEE A-2 DRAWING	2"	1-1/2"	1/2"	1/2"	COORDINATE WITH OWNER FOR FAUCET REQUIREMENTS FAUCET WITH 1.5 GPM AERATOR
12	SK-1	3-COMP SINK	SEE A-2 DRAWING	3"	2"	1/2"	1/2"	PREP SINK 3 TUB WITH DRAIN BOARDS FAUCETS 2.2 GPM FLOW RATE AERATOR
10	SK-3	HAND SINK	SEE A-2 DRAWING	2"	1-1/2"	1/2"	1/2"	WITH CHICAGO 4" CENTERS SWING GOOSENECK SPOUT AND 0.5 AERATOR.

PLUMBING FIXTURE LOAD CALCULATION									
KITCHEN ITEM NUMBER	FIXTURE ID	DESCRIPTION	QUANTITY	SANITARY F.U.		WATER F.U. COLD		WATER F.U. HOT	
				EACH	TOTAL	EACH	TOTAL	EACH	TOTAL
12	SK-1	3-COMPARTMENT SINK	1	3	3	3	3	3	3
11	SK-2	PREP-SINK	1	2	2	2	2	2	2
10	SK-3	HAND SINK	2	1	2	1	2	1	2
13	MS-1	MOP SINK	1	3	3	3	3	3	3
	LV-1	LV-1 (EXISTING)	1	1	1	1	1	1	1
	WC-1	WC-1 (EXISTING)	1	4	4	2.5	2.5	0	0
		TOTAL			15		13.5		11.0

UTILITY LOAD			
COLD WATER FIXTURES UNITS = 13.5 HOT WATER FIXTURES UNITS = 1.5			
SANITARY SEWER	MINIMUM SIZE REQUIRED	3"	19 FU
COLD WATER		1"	(11.0CW + 11HW) X 0.75 + 2.5CW = 19 FU = 13.0 GPM

PROVIDE NEW 4" AND CONNECT TO EXISTING 4" SEWER LINE

PLUMBING LEGEND

SYMBOL	ABBREVIATION	DESCRIPTION
	CW	COLD WATER PIPING
	HW	HOT WATER PIPING
	HWR	HOT WATER RETURN PIPING
	TP	TEMPERED WATER PIPING
	S OR W	SOIL OR WASTE PIPING
	V	VENT PIPING
	G	NATURAL GAS (LOW PRESSURE) PIPING
	CD	CONDENSATE DRAIN PIPING
	D	INDIRECT DRAIN PIPING
	WHA	WATER HAMMER ARRESTOR
	P.O.C.	POINT-OF-CONNECTION
		CAPPED
	UNION	UNION
	UP	PIPE UP
	DN	PIPE DOWN
	DN	PIPE TEE DOWN
	BV	BALL VALVE
	CV	CHECK VALVE
	PUMP	PUMP
	FCO	FLOOR CLEANOOUT
	WCO	WALL CLEANOOUT
	AG	GAS COCK WITH UNION
	AG	ABOVE GROUND
	AFF	ABOVE FINISHED FLOOR
	BG	BELOW GROUND
	(E)	EXISTING
	(I)	INVERT ELEVATION
	(N)	NEW
	QTY:	QUANTITY
	V.T.R.	VENT THRU ROOF
	BTU	BRITISH THERMAL UNITS
	MBH	THOUSAND BTUS PER HOUR

MATERIAL SPECIFICATIONS									
		CAST IRON NO-HUB	DUCTILE IRON	STEEL	TYPE M COPPER	TYPE K COPPER	ABS	PVC	SEAMLESS
SERVICES									
COLD WATER	ABOVE GROUND					•			
	BELOW GROUND								
HOT WATER	ABOVE GROUND					•			
	BELOW GROUND					•			
WASTE	ABOVE GROUND	•							
	BELOW GROUND						•		1.2
VENT	ABOVE GROUND				•		•		
	BELOW GROUND				•		•		1.2
INDIRECT WASTE	INDOOR				•				
	OUTDOOR				•				

1. APPROVED ABS/PVC DWV PIPE IS OK IF PERMITTED BY LOCAL JURISDICTION.
 2. ABS/PVC DWV PIPE IS NOT PERMITTED INSIDE RETURN AIR PLUMBINGS.

FIXTURE WATER RATES (2016 CALIFORNIA GREEN BUILDING STANDARDS CODE)	
FIXTURE TYPE	FLOW RATE
SHOWERS/EAGS	2.0 GPM @60 PSI
LAUNDRY FAUCETS – NON-RESIDENTIAL	0.50 GPM @60 PSI
KITCHEN FAUCETS	1.8 GPM @60 PSI
WASH FOUNTAINS	1.8 GPM /SPR SPACE (N) @60 PSI
METERING FAUCETS	0.20 GALLONS PER CYCLE
WATER CLOSURES FOR WASH FOUNTAINS	.20 G/CYCLE (MIN SPACE) (N @60 PSI)
GRAVITY TANK TYPE WATER CLOSETS	1.28 GALLONS/FLUSH
FLUSHMETER TANK WATER CLOSETS	1.28 GALLONS/FLUSH
FLUSHMETER VALVE WATER CLOSETS	1.28 GALLONS/FLUSH
ELECTROMECHANICAL HYDRAULIC WATER CLOSETS	1.28 GALLONS/FLUSH
URINALS	0.125 GALLONS/FLUSH

NOTE: 1. THE EFFECTIVE FLUSH VOLUME OF ALL WATER CLOSETS SHALL NOT EXCEED 1.28 GALLONS PER CYCLE. 2. GRAVITY TANK TYPE WATER CLOSETS SHALL BE SPECIFIED TO THE PERFORMANCE CRITERIA OF THE U.S. EPA WATER SENSE SPECIFICATION FOR TANK-TYPE TOILETS.

NOTE: EFFECTIVE FLUSH VOLUME OF DUAL FLUSH TOILETS IS DEFINED AS THE COMPOSITE AVERAGE FLUSH VOLUME OF TWO REDUCE FLUSHES AND ONE FULL FLUSH.













SHEET INDEX	
SHEET NO.	DESCRIPTION
P0.1	FIXTURES, SCHEDULES AND CALCULATIONS
P0.2	GENERAL NOTES AND SPECIFICATIONS
P2.0	FLOOR PLANS - WASTE, VENT, WATER, GAS SUPPLY & DETAILS

SEISMIC RESTRAINTS GUIDELINES FOR PIPING

GENERAL NOTES

REV. CHECK PLAN 12/19/19	NO.		GAMA DRAFTING & ENGINEERING 37625 SYCAMORE ST NEWARK CA 94660 gamedrafting@sbcglobal.net (510) 961-1119	GLENN CUNNINGHAM, DESIGNER BULL'S EYE CADD 434 45TH AVENUE SAN FRANCISCO CA 94121 (415) 301-3005 (415) 866-3624 E-MAIL: glenn@caddcentral.net	THE DRAWINGS ON THIS SHEET & SPECIFICATIONS REPRESENT THE DESIGN OF THE PROJECT AS DEVELOPED BY THE DESIGNER. THE DESIGNER HAS CONDUCTED THE DESIGN AND CALCULATIONS TO THE BEST OF HIS/HER KNOWLEDGE AND BELIEVES THE DESIGN TO BE IN ACCORDANCE WITH THE REQUIREMENTS OF THE PROJECT. THE DESIGNER HAS NOT CONDUCTED A VISUAL CHECK OF THE PROJECT FOR CONSTRUCTION. THE DESIGNER HAS NOT CONDUCTED A VISUAL CHECK OF THE PROJECT FOR CONSTRUCTION. THE DESIGNER HAS NOT CONDUCTED A VISUAL CHECK OF THE PROJECT FOR CONSTRUCTION.	T.I. - TAPSLUG BISTRO 1988 HOMESTEAD ROAD #121 SANTA CLARA, CA 95050	Date: 09/30/19	Drawn: HP	Sheet:
							P0.2		

Date: 09/30/19Drawn: HPSheet:P0.2

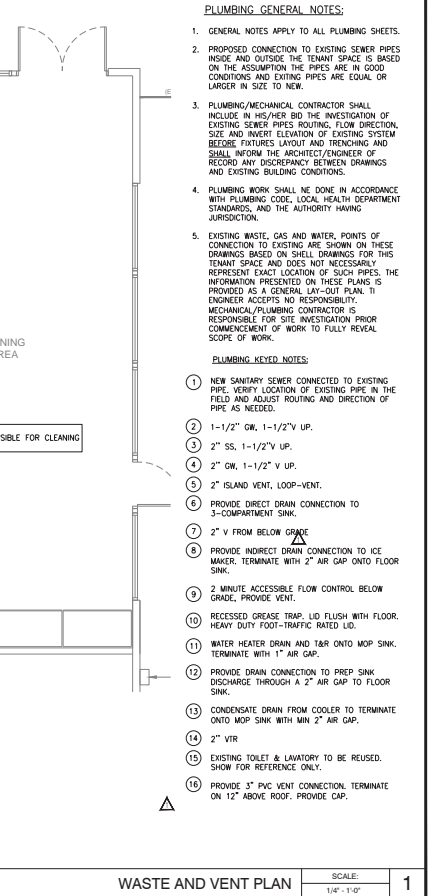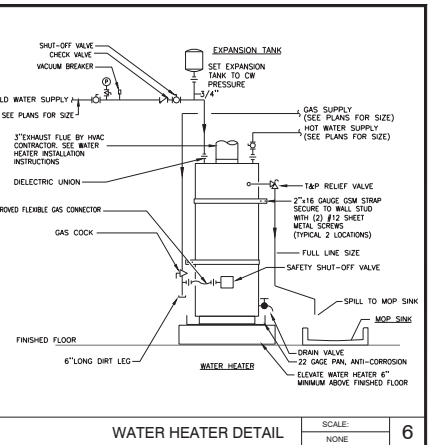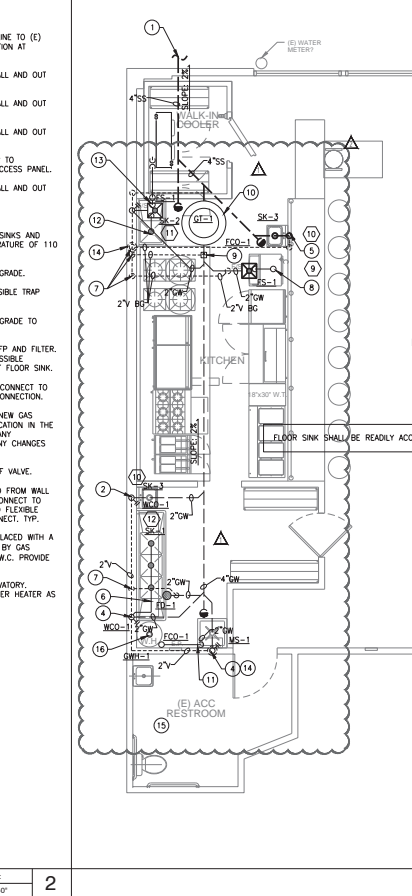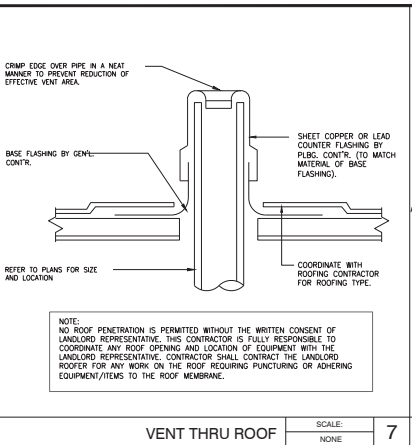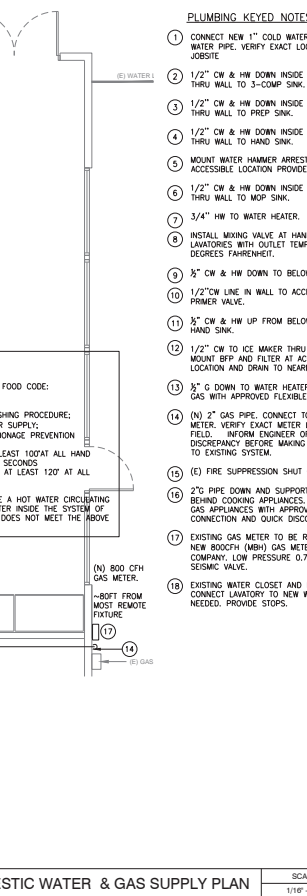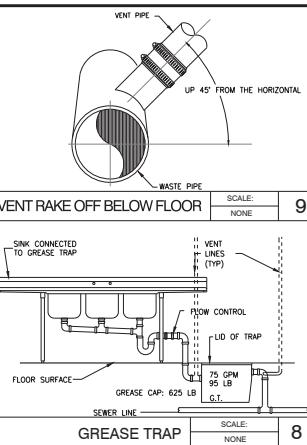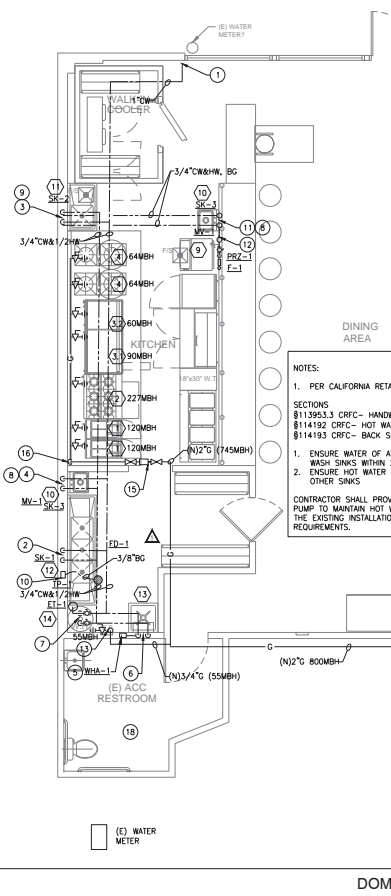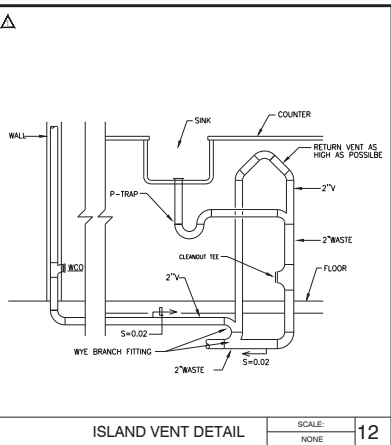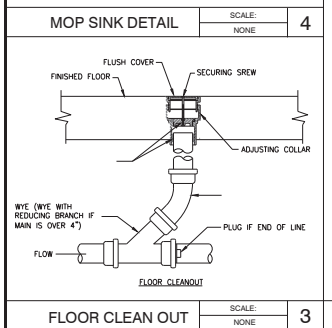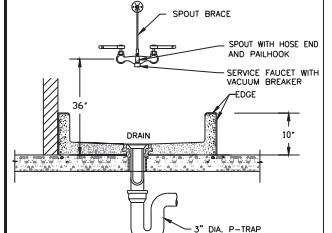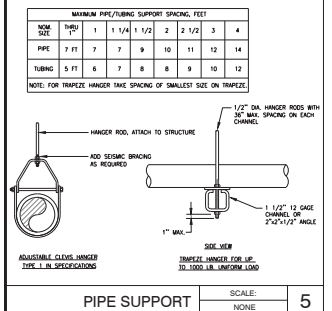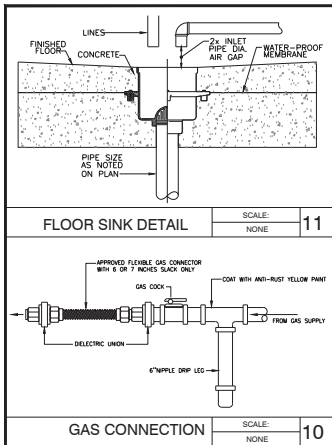

STUDS TABLE PER DIETRICH INDUSTRIES (PER I.C.B.O. #4782)

ALLOWABLE WALL HEIGHT L/120 DEFLECTION					L/240 DEFLECTION				
MEMBER	SIZE	CODE	GAGE	VT. (IN.)	MEMBER	SIZE	CODE	GAGE	VT. (IN.)
1-5/8"	STN	22	9-10	8-11	7-10	STN	22	9-10	8-11
	STN	22	11-5	10-4	9-0	STN	22	9-10	8-11
	STE	20	12-1	11-0	9-7	STE	20	9-7	8-6
2-1/2"	STN	25	13-7	12-4	10-8	STN	25	10-10	9-10
	STN	22	16-8	14-4	13-6	STN	22	12-4	11-4
	STE	20	16-10	15-4	13-4	STE	20	13-4	12-1
3-1/2"	STN	25	17-7	16-0	13-1	STN	25	14-0	12-8
	STN	22	20-5	18-4	16-3	STN	22	16-3	14-8
	STE	20	21-10	19-10	17-4	STE	20	17-4	15-6
3-5/8"	STN	25	18-1	16-4	13-4	STN	25	14-4	13-0
	STN	22	22-0	19-10	16-7	STN	22	16-7	15-1
	STE	20	22-5	20-4	17-10	STE	20	17-10	16-1
4"	STN	22	22-7	20-7	18-0	STN	22	18-0	16-4
	STN	22	24-2	22-0	19-2	STN	22	19-2	17-5
	STE	20	24-2	22-0	19-2	STE	20	19-2	17-5
5-1/2"	STN	22	24-2	22-0	19-2	STN	22	24-2	22-0
	STN	22	26-2	24-6	22-4	STN	22	26-2	24-2
	STE	20	26-2	24-6	22-4	STE	20	26-2	24-2

- NOTE 1 STEEL STUDS AND RUNNERS (TRACK) COMPLY WITH ASTM STANDARD C 645-70, STEEL STUDS RECOMMENDED SPECIFICATION FOR THE APPLICATION AND FINISHING OF GYPSUM BOARD (GA-216)
- NOTE 2 FOR HEAVY DOORS INSTALLED IN PARTITIONS, IT IS RECOMMENDED THAT DOOR CLOSURES BE USED. FOR DOOR FRAME INSTALLATION IN FIRE RATED STEEL STUD PARTITIONS SEE SECTION V.
- NOTE 3 DESCRIPTION.
- NOTE 4 CALCULATIONS ARE BASED ON ALLOWABLE DESIGN STRESS OF 20,000 PSI.

CONTRACTOR SHALL CONSULT WITH MANUFACTURERS
COMPLY WITH ASTM STANDARD C 1002 AND ARE SPACED IN ACCORDANCE WITH GYPSUM ASSOCIATION

STUD TABLE WHEN HEIGHTS EXCEED THOSE LISTED ABOVE. SECTION VI LIMITING HEIGHTS (NONLOAD-BEARING)


NOTE: THE LIMITING HEIGHT CALCULATIONS IN TABLE VI AREA SPECIFIC TO 0.0209 INCH BASE METAL THICKNESS AND MAY NOT BE REPRESENTATIVE OF ALL NOMINAL 25 GAUGE METAL STUDS AVAILABLE INT. THE MARKETPLACE. WHERE BASE METAL THICKNESS ARE UNKNOWN OR KNOWN TO BE LESS THAN 0.0209 INCH, CONSULT THE METAL STUD MANUFACTURER FOR LIMITING HEIGHTS.

MAXIMUM HEIGHT LIMITATIONS ARE GIVEN FOR SOME NONLOAD-BEARING PARTITIONS. IN INSTANCES WHERE NO HEIGHT LIMIT IS GIVEN FOR SPECIAL PURPOSE PARTITIONS, SUCH AS MOVABLE OR SHUTT WALL SYSTEMS, THE MANUFACTURER SHALL BE CONSULTED.

CRITERIA USED TO EVALUATE TRANSVERSE LOAD TESTS, CONDUCTED TO DETERMINE MAXIMUM HEIGHTS, ARE 5 POUNDS PER SQUARE FOOT FOR BOTH STRESS AND DEFLECTION REQUIREMENTS WITH A DEFLECTION LIMITATION OF HEIGHT DIVIDED BY 120 FOR GYPSUM BOARD AND HIGH STRENGTH GYPSUM VENEER FINISHES, AND HEIGHT DIVIDED BY 240 FOR GYPSUM OR METAL LATH AND PLASTER PARTITION HEIGHTS WITH GYPSUM BOARD, SCREW ATTACHED TO STEEL STUDS, ARE BASED UPON A COMPOSITE SECTION WITH STEEL STUDS COMPLYING WITH ASTM C 645-70 UNLESS OTHERWISE INDICATED.


A LIMITING HEIGHT IN EXCESS OF THAT SHOWN MAY BE OBTAINED BY USING A DEEPER STUD THAN THAT TESTED, BY SPACING THE STUDS CLOSER TOGETHER BY USING A HEAVIER GAGE STUD, OR BY ADDING AN ADDITIONAL PLY OF GYPSUM BOARD. TABLE VI MAY BE USED AS A GUIDE FOR GYPSUM BOARD AND HIGH STRENGTH GYPSUM VENEER FINISHES.

A HIGHER DEGREE OF DEFLECTION RESISTANCE FOR SOME APPLICATIONS MAY BE DESIRABLE SUCH AS FOR OFFICES AND INSTITUTIONAL BUILDINGS AS COMPARED TO INDUSTRIAL BUILDINGS. LOWER LIMITING HEIGHTS THAN THOSE BASED ON DEFLECTION AND STRESS CRITERIA MAY THEREFORE BE WARRANTED FOR IMPROVED PERFORMANCE AS RELATED TO HUMAN RESPONSE TO FLEXURE FROM IMPACT, OR TO

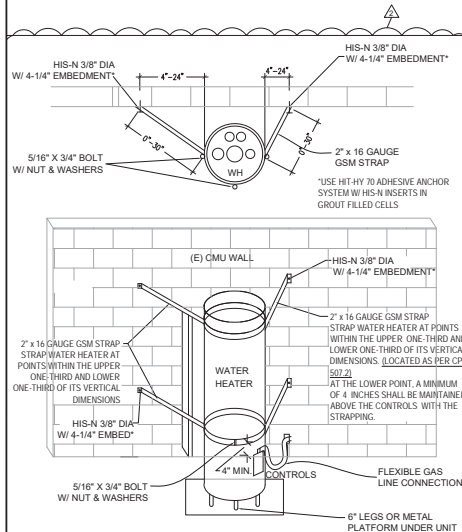


48 GALLON WATER HEATER, HEIGHT (WITH MAX. GAL. WATER = 580 LB)
DIMENSIONS: 22\"/>


9 DETAIL - WATER HEATER STRAPPED TO WALL
N.T.S.

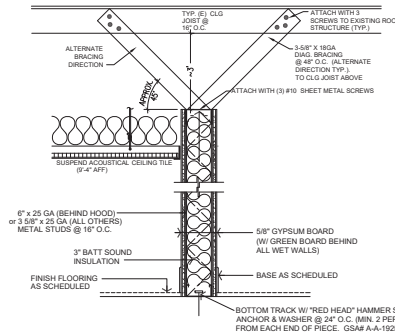


1 MTL STUD PARTITION WALL DETAIL
N.T.S.

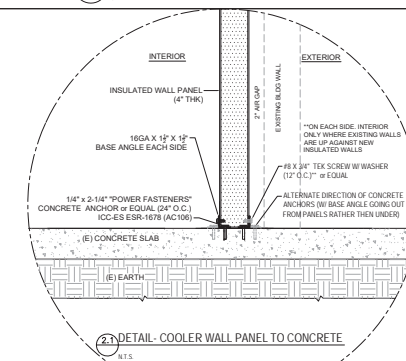


2 DETAIL - COOLER WALL PANEL TO CONCRETE
N.T.S.

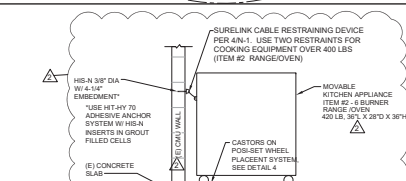

5 DETAIL - 400LB APPLIANCE RESTRAINT
N.T.S. SEISMIC ATTACHMENT FOR ITEM #2

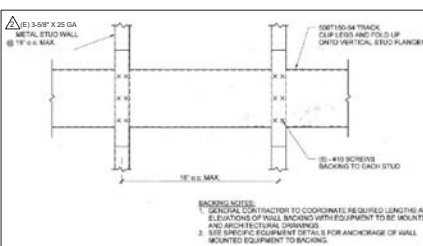

6 DETAIL - WALL BACKING
N.T.S.

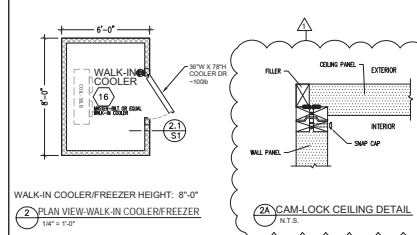


2 PLAN VIEW - WALK-IN COOLER/FREEZER
1/4\"/>

PANEL SPECIFICATIONS: (NBS)
WALLS, FLOOR, & CEILING - MASTER-BILT 4\"/>

R-VALUES:
COOLER WALLS/CEILING/DOOR - R-25 min
FOAM-IN-PLACE URETHANE CAM-LOCK COOLER PANEL OR EQUAL - (2.2 R-VALUE)
FINISH:
ALL WALLS & CEILING - 26 GA VALUUM NEF PANELS
COOLER FLOOR - EPOXY W/ COVED BASE, SEE SHEET EH-1



4 GAS EQUIPMENT RESTRAINT SYSTEM

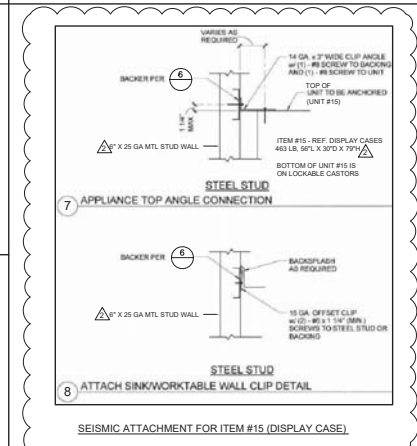

7 ATTACH SINK/WORKTABLE WALL CLIP DETAIL
SEISMIC ATTACHMENT FOR ITEM #15 (DISPLAY CASE)

REV.	DATE	NO.
12/27/19	1	
1/31/20	2	



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"I hereby certify that I am a duly Licensed Professional Engineer in the State of California, License No. 063021, and that I am the author of the above design. I am not providing this design for use in any other project or for any other purpose without the written consent of the client. I am not providing this design for use in any other project or for any other purpose without the written consent of the client."

T.I. - TAPSIOLOG BISTRO
1988 HOMESTEAD ROAD #121
SANTA CLARA, CA 95050

Date: 10/7/19
Drawn: GJC
Sheet: S-1

