

TWISTERS GYMNASTICS

CONDITIONAL USE PERMIT

2800 BOWERS AVE
SANTA CLARA, CA 95051



2011 STEVENS CREEK BLVD
SUITE 270
CUPERTINO, CA 95014
(408) 865-1089

TWISTERS GYMNASTICS
CONDITIONAL USE PERMIT
2800 BOWERS AVE
SANTA CLARA, CA 95051



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△	3/19/21	PLANNING DEPT SUBMITTAL	
△	2/12/21	PLANNING DEPT SUBMITTAL	
NO	DATE BY	DESCRIPTION	
REVISIONS			

DRAWN BY	CHECKED:
DATE:	SCALE: AS NOTED
PROJECT NUMBER:	

PROJECT INFO,
DRAWING INDEX,
& VICINITY PLAN

DRAWING
NUMBER: A0.1


ABBREVIATIONS

& L	And	F.O.S.	Face of Studs	SECT.	Section
Angle	FT.	FTG.	Foot or Feet	SH	Shelf
At	FW	FW	Fire Water	SHWR	Shower
Centerline				SIM	Similar
Diameter or	GA.	Gauge		SPEC.	Specification
Round	GALV.	Galvanized		SQ.	Square
Penny (Nails)	G.B.	Grab Bar		SST.	Stainless
Pound	GI	Galvanized		STL	Steel
(N)	Ext.	Iron		STD.	Standard
(R)	New	Glass		STOR.	Storage
ACC	Relocated	GND.	Ground	STRUC.	Structural
A/C	Accessible	GR.	Grade	SUSP.	Suspended
Conditioning	Air	GS	Galvanized	SYM.	Symmetrical
Asphaltic	Conc.	GYP.	Gypsum	SYS.	System
ACOUS.	Acoustical	H.B.	Hose Bibb	T.B.	Towel Bar
A.D.	Area Drain	H.C.	Hollow Core	TEL	Telephone
ADJ.	Adjustable	HDR.	Header	TER.	Terrazzo
ALT.	Alternate	HDWD.	Hardware	THK.	Thick
ALUM.	Aluminum	HDWR.	Hardware	T & G.	Tongue & Groove
APPROX.	Approximate	H.M.	Hollow Metal	T.O.C.	Top of Curb
ARCH.	Architectural	HORIZ.	Horizontal	T.O.C.D.	Top of Concrete Deck
HT.				T.O.P.	Top of Pavement / Interior
BD.	Board	I.D.	Inside Diameter	T.O.R.D.	Top of Roof Deck
BITUM.	Bituminous	INT.	Interior	T.O.S.	Top of Sheathing
BLDG.	Building	INSUL.	Insulation	T.O.W.	Top of Wall
BLK.	Block	INT.	Interior	TRD.	Tread
BLKG.	Blocking	JAN.	Janitor	T.S.W.	Top of Sidewalk
B.M.	Bench Mark	KIT.	Kitchen	TYP.	Typical
BFP.	Backflow Preventer	LAB.	Laboratory	U.L.	Underwriters
BOT.	Bottom	LAM.	Laminated	U.N.O.	Unless Noted
CAB.	Cabinet	LAV.	Lavatory	U.O.N.	Unless Otherwise Noted
C.B.	Chalk Board	LCKR.	Locker	V.C.T.	Vinyl Composition Tile
C.C.	Cement	LT.	Light	VERT.	Vertical
C.I.	Ceramic	MAINT.	Maintenance	VEST.	Vestibule
C.J.	Cast Iron	MAT.	Material	V.T.R.	Vent Through Roof
CLG.	Chain Link	MECH.	Mechanical	V.W.C.	Vinyl Wall Covering
CLR.	Clear	MAX.	Maximum	W	West
CONTR.	Counter	M.B.	Machine Bolt	W	With
COL.	Column	M.D.F.	Medium Density Fiberboard	W.C.	Water Closet
CONC.	Concrete	MEZ.	Mezzanine	WD.	Wood
CONN.	Connection	MFR.	Manufacturer	WDW.	Window
CONST.	Construction	MH.	Manhole	W/O.	Without
CORR.	Corrosion	MIN.	Minimum	W.S.	Wood Screw
CPT.	Counterpart	MISC.	Miscellaneous	WT.	Weight
CTSK.	Center	MTD.	Mounted	W.W.F.	Weilded Wire Fabric
CTR.	Center	MUL.	Mulch		
CW.	Cold Water	N	North		
DBL.	Double	N.I.C.	Not In Contract		
DEPT.	Department	No. or #	Number		
D.F.	Drinking Fountain	DOWN	Down		
DIA.	Diameter	DOWN	Down		
DIM.	Dimension	DOWN	Down		
DISP.	Dispenser	DOWN	Down		
DN.	Down	DOWN	Down		
DR.	Door	DOWN	Down		
DS.	Downspout	DOWN	Down		
D.S.P.	Dry Standpipe	DOWN	Down		
DTL.	Detail	DOWN	Down		
DWG.	Drawing	DOWN	Down		
DWR.	Drawer	DOWN	Down		
EA.	Each	DOWN	Down		
E.J.	Expansion Joint	DOWN	Down		
EL.	Elevation	DOWN	Down		
ELEC.	Electrical	DOWN	Down		
EMER.	Emergency	DOWN	Down		
ENCL.	Enclosure	DOWN	Down		
EQ.	Equipment	DOWN	Down		
EQPT.	Each Way	DOWN	Down		
E.W.	Exhaust	DOWN	Down		
EXH.	Expansion	DOWN	Down		
EXP.	Exterior	DOWN	Down		
EXT.		DOWN	Down		
F.A.	Fire Alarm	DOWN	Down		
F.D.	Fire Alarm	DOWN	Down		
FDN.	Foundation	DOWN	Down		
F.E.	Fire Extinguisher	DOWN	Down		
FEC.	Fire Extinguisher	DOWN	Down		
F.F.	Finish	DOWN	Down		
F.G.	Finish	DOWN	Down		
F.H.	Finish	DOWN	Down		
FHC.	Finish	DOWN	Down		
FIN.	Finish	DOWN	Down		
FLASH.	Finish	DOWN	Down		
FLR.	Finish	DOWN	Down		
FLUR.	Finish	DOWN	Down		
F.O.C.	Face of Conc.	DOWN	Down		
F.O.F.	Face of Finish	DOWN	Down		
F.E.M.	Masonry	DOWN	Down		

DRAWING SYMBOL LEGEND

PROJECT NORTH	REFERENCE NOTE IDENTIFICATION
COLUMN REFERENCE GRIDS B,23 = COLUMN DESIGNATION	WALL IDENTIFICATION C = WALL TYPE DESIGNATION - REF SCHEDULE 4 = NOMINAL STUD OR MASONRY SIZE 2 = FIRE RATING IN HOURS B = ADDITIONAL REMARKS - REF SCHEDULE * = OPTIONAL CHARACTER
ELEVATION 4 = ELEVATION DESIGNATION A5.1 = REFERENCE DRAWING NUMBER ARROW INDICATES DIRECTION OF VIEW	TOILET ACCESSORY IDENTIFICATION 3 = ACCESSORY NUMBER - REF SCHEDULE
BUILDING SECTION C = SECTION DESIGNATION A5.2 = REFERENCE DRAWING NUMBER ARROW INDICATES DIRECTION OF VIEW	APPLICABLE CODES
WALL SECTION E = SECTION DESIGNATION A5.3 = REFERENCE DRAWING NUMBER ARROW INDICATES DIRECTION OF VIEW	2019 BUILDING STANDARDS ADMINISTRATIVE CODE PART 1, TITLE 24 C.C.R. 2019 CALIFORNIA BUILDING CODE (CBC) PART 2, TITLE 24 C.C.R. (2019 INTERNATIONAL BUILDING CODE (IBC) W/ CALIFORNIA AMENDMENTS) 2019 CALIFORNIA PLUMBING CODE (CPC) 2019 CALIFORNIA MECHANICAL CODE (CMC) 2019 CALIFORNIA ELECTRICAL CODE (CEC) 2019 CALIFORNIA FIRE CODE (CFC) 2019 CALIFORNIA GREEN BUILDING CODE 2019 CALIFORNIA ENERGY CODE SANTA CLARA MUNICIPAL CODE
DETAIL 10 = DETAIL DESIGNATION 8.3 = REFERENCE DRAWING NUMBER	PROJECT TEAM
CODE ANALYSIS LOBBY = ROOM NAME E1 = OCCUPANCY GROUP 6 = SPACE USE - REF SPACE USE SCHEDULE 900 = FLOOR AREA - SQUARE FEET 45 = OCCUPANT LOAD (CBC TABLE 10-A) = OCCUPANT LOAD SIGN REQUIRED WHEN NOTED - (CBC SEC 1002.3) REF SIGNAGE SCHEDULE	CLIENT / TENANT TWISTER GYMNASTICS, INC. OWNER: ALLAN FUSILERO 1165 N FAIR OAKS AVE SUNNYVALE, CA 94089 (408) 313-8857 afusilero@hotmail.com
LEVEL LINE, CONTROL POINT FFE 0'-0" = ELEVATION	ARCHITECT ADAPTIVE ARCHITECTURE CONTACT: JANICE YEH 20111 STEVENS CREEK BLVD, SUITE 275 CUPERTINO, CA 95014 (408) 865-1089
MATCH LINE AND AREA DESIGNATOR SHADED PORTION IS THE SIDE CONSIDERED	
CENTER LINES, FLOOR LINES AND LEVEL LINES	
SECTION LINES	
PROPERTY LINES, BOUNDARY LINES AND MATCH LINES	
HIDDEN CONSTRUCTION FEATURE	
BREAKS OF BUILDING COMPONENTS	
REVISION 3 = REVISION NUMBER	
GLAZED OPENING OR WINDOW TYPE	
DOOR IDENTIFICATION 50 = DOOR NUMBER	

VICINITY MAP

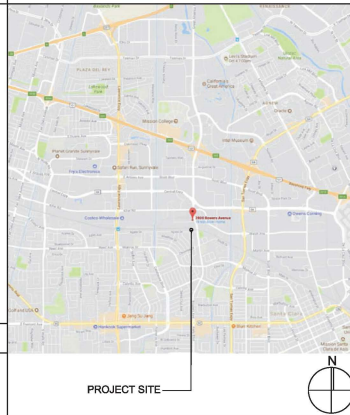


PROJECT DATA

1. LOCATION:	2800 BOWERS AVE, SANTA CLARA CA 95051
2. PARCEL NUMBER:	216-28-087 VARIABLE, SEE SITE PLAN
3. ZONING DISTRICT:	ML - LIGHT INDUSTRIAL
4. GENERAL PLAN:	HIGH INTENSITY OFFICE / R&D
5. CURRENT USE:	MANUFACTURING/ WAREHOUSE USE (VACANT SINCE JUNE 2019)
6. PROPOSED USE:	RECREATIONAL USE
7. CONSTRUCTION TYPE:	III-B
8. FIRE SUPPRESSION SYSTEM:	(E) BUILDING IS FULLY SPRINKLERED
9. CURRENT OCCUPANCY TYPE:	F-1, S-1, B (NON-SEPARATED)
10. PROPOSED OCCUPANCY TYPE (FOR 2800 BOWERS ONLY):	A-3, B (NON-SEPARATED)
11. YEAR BUILT:	1974
12. NUMBER OF STORIES:	1
13. MAX. BLDG HEIGHT PERMITTED:	70 FT.
14. PARCEL AREA:	45,738 SF (1.05 ACRES)
15. TOTAL BUILDING AREA (INCLUDING 2800 AND 2810 BOWERS):	21,016 SF
17. MAX. ALLOWED BLDG COVERAGE:	75%
18. (E) BLDG COVERAGE:	46%
19. REQ'D SETBACKS FOR ML ZONING (CORNER LOT):	FRONT: 15 FT. STREET SIDE: 15 FT. SIDE: 0 FT. REAR: 0 FT.
20. GROSS FLOOR AREA (INCLUDING EXTERIOR WALLS):	EXISTING 10,674 SF PROPOSED 10,674 SF

DRAWING INDEX

ARCHITECTURAL	
A0.1	PROJECT INFO, DRAWING INDEX, & VICINITY PLAN
A0.2	CODE ANALYSIS PLAN
A1.1	SITE PLAN
A2.0	DEMOLITION PLAN
A2.1	PROPOSED FLOOR PLAN
A3.1	EXISTING ELEVATIONS & TRASH ENCLOSURE DETAILS
SCOPE OF WORK	
PROJECT SCOPE IS TO OBTAIN A CONDITIONAL USE PERMIT TO CONVERT AN EXISTING EXISTING INDUSTRIAL WAREHOUSE TO RECREATIONAL USE FOR YOUTH GYMNASTICS. UPGRADES TO THE EXISTING BUILDING AND SIDE INCLUDE THE FOLLOWING:	
1.	DEMOLITION OF EXISTING INTERIOR PARTITIONS AND WAREHOUSE SHELVING.
2.	INSTALLATION OF EXERCISE MATS FOR GYMNASTICS USE.
3.	INSTALLATION OF BICYCLE RACKS.
GENERAL NOTES	
1. GC IS RESPONSIBLE FOR COLLECTION AND PICK-UP OF ALL TRASH AND DEBRIS ON-SITE AND ADJACENT PUBLIC RIGHT-OF-WAY.	
2. CONSTRUCTION ACTIVITY SHALL BE LIMITED TO THE HOURS OF 7:00 A.M. TO 6:00 P.M. WEEKDAYS AND 9:00 A.M. TO 6:00 P.M. SATURDAYS FOR PROJECTS WITHIN 300 FEET OF A RESIDENTIAL USE AND SHALL NOT BE ALLOWED ON RECOGNIZED STATE AND FEDERAL HOLIDAYS. ALL IN ACCORDANCE WITH CITY CODE CHAPTER 9.10.	

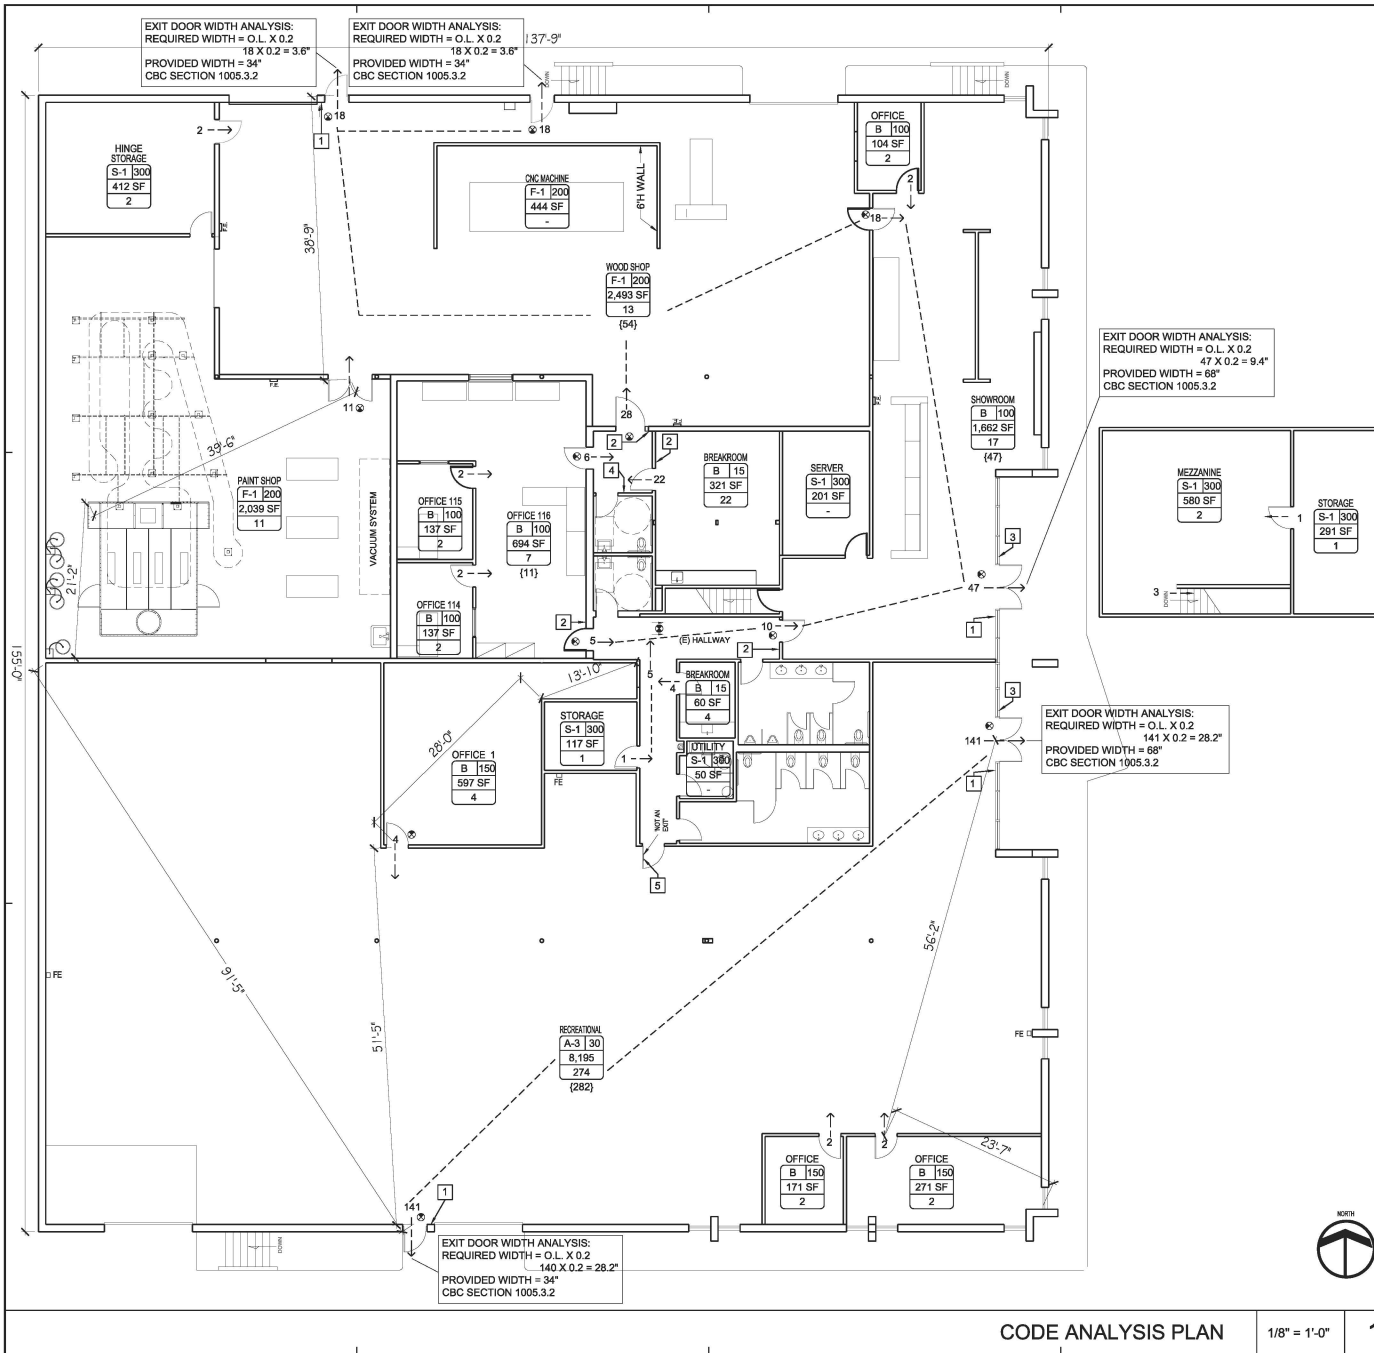

LEGEND

ILLUMINATED EXIT SIGN

DIRECTIONAL ILLUMINATED EXIT SIGN

CODE ANALYSIS

ALLOWABLE AREA PER CBC TABLE 506.2

1. OCCUPANCY TYPE: A-3, B, F-1, S-1 (NON-SEPARATED OCCUPANCY)

2. SPRINKLERED: YES (S1)

3. CONSTRUCTION TYPE: III-B

4. BUILDING AREA: 21,000 SF

5. MIXED OCCUPANCY CALCULATION

ALLOWABLE AREA: A-3 38,000 SF, B 76,000 SF, F-1 48,000 SF, S-1 70,000 SF

ACTUAL AREA: A-3 8,162 SF, B 4,910 SF, F-1 6,376 SF, S-1 1,562 SF

8,162/38,000 + 4,910/76,000 + 6,376/48,000 + 1,562/70,000 = 0.42 < 1

FIRE DEPARTMENT NOTES

1. GAS SHUTOFF VALVES, ELECTRIC METERS, SERVICE SWITCHES AND OTHER UTILITY EQUIPMENT SHALL BE CLEARLY AND LEGIBLY MARKED TO IDENTIFY THE UNIT OR SPACE THAT IT SERVES. IDENTIFICATION SHALL BE MADE IN AN APPROVED MANNER, READILY VISIBLE AND SHALL BE MAINTAINED (2018 CFC 509.1.1).

COMMON PATH OF TRAVEL

OCCUPANCY	MAXIMUM OCCUPANT LOAD OF SPACE	MAXIMUM COMMON PATH OF EGRESS TRAVEL DISTANCE W/ SPRINKLER SYSTEM
B	49	100
F	49	100
S	29	100

SIGNAGE NOTES

1 TACTILE EXIT SIGN

2 TACTILE EXIT ROUTE SIGN

3 ACCESSIBLE ENTRY SIGN

4 WALL MOUNTED RESTROOM SIGN

5 "NOT AN EXIT" SIGN

ADAPTIVE ARCHITECTURE

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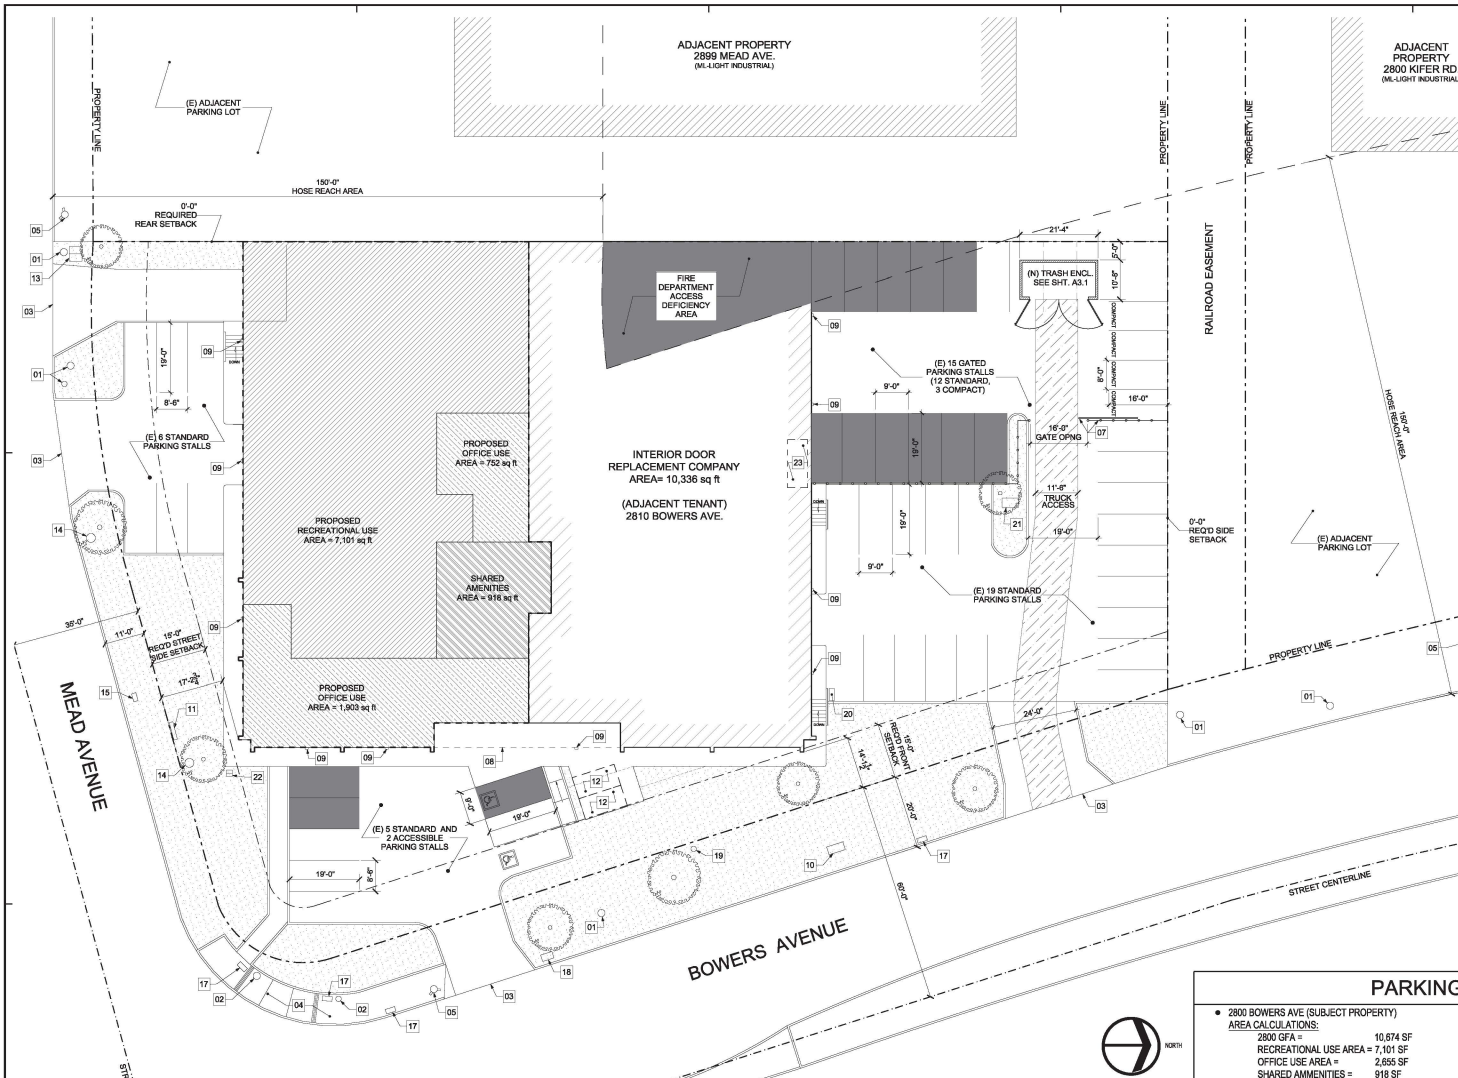
CODE ANALYSIS PLAN

DRAWING NUMBER: A0.2

CODE ANALYSIS PLAN

1/8" = 1'-0"

1



SITE PLAN LEGEND

- PROPERTY LINE
- LINE OF SETBACK
- CENTERLINE OF STREET
- BOUNDARY OF SUBJECT PROPERTY
- FENCE
- (E) LANDSCAPED AREA
- (E) HARDSCAPED AREA
- (E) ADJACENT BUILDING STRUCTURE
- PROPOSED RECREATIONAL USE
- PROPOSED OFFICE USE
- SHARED AMENITIES
- PROPOSED SHARED PARKING STALLS
- (E) TREES

SITE PLAN KEY NOTES

- (E) UTILITY POLE / STREET LIGHT
- (E) TRAFFIC LIGHT POLE
- (E) CURB CUT
- (E) SIDEWALK
- (E) FIRE HYDRANT
- (E) TRASH AREA (2) 8 CY AND (1) 96 GA. BINS WILL BE SHARED BY APPLICANT & (E) TENANT.
- (E) FENCE AND 16V VEHICLE GATE. PARKING SPACES BEYOND THIS POINT SHALL BE MADE AVAILABLE AND ACCESSIBLE DURING TWISTERS OPERATING HOURS. PROVIDE APPROVED KNOX SYSTEM FOR FIRE DEPARTMENT ACCESS.
- LINE OF (E) EXTERIOR WALL AND ROOF ABOVE
- (E) EXTERIOR LIGHT FIXTURE ABOVE
- (E) FIRE SPRINKLER MAIN
- (E) WATER METER
- (N) BICYCLE PARKING AREA. PROVIDE A MINIMUM OF ONE CLASS I BICYCLE LOCKER SPACE AND SEVEN CLASS II BICYCLE RACK SPACES
- (E) UNDERGROUND CATV
- (E) SEWER AND STORM DRAIN MANHOLE
- (E) UNDERGROUND LOW VOLTAGE LINE (RESERVED)
- (E) UNDERGROUND CSC TRAFFIC SIGNAL
- (E) UNDERGROUND FIBER COMMUNICATIONS
- (E) SEWER CLEAN OUT
- (E) GAS METER
- (E) TRANSFORMER
- (E) IRRIGATION CONTROL VALVES
- LOCATION OF (E) MAIN ELECTRICAL PANEL (MSE).

PARKING CALCULATIONS

• 2800 BOWERS AVE (SUBJECT PROPERTY) AREA CALCULATIONS: 2800 GFA = 10,674 SF RECREATIONAL USE AREA = 7,101 SF OFFICE USE AREA = 2,655 SF SHARED AMENITIES = 918 SF (<10% OF TOTAL GFA)		REQUIRED PARKING STALLS FOR 2800 AND 2810: TOTAL REQUIRED STALLS = 48 + 14 = 62
REQUIRED PARKING STALLS (PER CSMC CHAPTER 18.74): RECREATIONAL USE STALLS = 36 OFFICE USE + AMENITIES STALLS = 12 (1 / 300 SF OF GFA) 2800 REQUIRED STALLS = 48		EXISTING PARKING STALLS IN PROPERTY: (E) STANDARD STALLS = 30 (E) ACCESSIBLE STALLS = 2 (E) GATED STANDARD STALLS = 12 (E) GATED COMPACT STALLS = 4 TOTAL EXISTING STALLS = 48 (22.8% DEVIATION)
• 2810 BOWERS AVE (ADJACENT TENANT) AREA CALCULATIONS: 2810 GFA = 10,336 SF LIGHT INDUSTRIAL USE AREA = 10,336 SF		REQUIRED PARKING STALLS (PER CSMC CHAPTER 18.74): LIGHT INDUSTRIAL USE STALLS = 14 (1 / 750 SF OF GFA) 2810 REQUIRED STALLS = 14

EXISTING & PROPOSED SITE PLAN

1/16" = 1'-0"

1

SITE PLAN GENERAL NOTES

- NO EXTERIOR WORK IS PROPOSED IN THE PRESENT PROJECT SCOPE.
- EXISTING ENVELOPE CONDITIONS WILL BE ASSESSED FOR MINOR REPAIRS OR MAINTENANCE.
- TENANT WILL BE RESPONSIBLE FOR SUBMITTING A SIGNAGE PERMIT IF MODIFICATIONS TO EXTERIOR SIGNAGE ARE INTENDED.
- ALL DIMENSIONS ARE TO FACE OF FINISH U.N.O.
- ON-STREET PARKING SHALL NOT BE COUNTED TOWARD ON-SITE PARKING REQUIREMENTS.

TOTAL OCCUPANTS PER HOUR OF THE DAY												
MONDAY	TUESDAY	WEDNESDAY	THURSDAY	FRIDAY	SATURDAY	SUNDAY						
TWISTERS (2800)	CSC (2810)	TWISTERS (2800)	CSC (2810)	TWISTERS (2800)	CSC (2810)	TWISTERS (2800)	CSC (2810)	TWISTERS (2800)	CSC (2810)	TWISTERS (2800)	CSC (2810)	TWISTERS (2800)
06:00 AM - 07:00 AM	-	1	-	1	-	1	-	1	-	-	-	-
07:00 AM - 08:00 AM	-	7	-	7	-	7	-	7	-	-	-	-
08:00 AM - 09:00 AM	-	9	-	11	-	13	-	13	-	15	-	-
09:00 AM - 10:00 AM	13	9	13	9	13	9	13	9	13	9	88	4
10:00 AM - 11:00 AM	13	9	13	9	13	9	13	9	13	9	88	4
11:00 AM - 12:00 PM	13	9	13	9	13	9	13	9	13	9	88	4
12:00 PM - 01:00 PM	2	9	2	9	2	9	2	9	2	9	88	4
01:00 PM - 02:00 PM	2	9	2	9	2	9	2	9	2	9	88	4
02:00 PM - 03:00 PM	2	14	2	14	2	14	2	14	2	14	87	4
03:00 PM - 04:00 PM	73	14	73	14	73	14	73	14	73	14	87	4
04:00 PM - 05:00 PM	73	9	73	10	73	10	73	10	73	10	87	4
05:00 PM - 06:00 PM	73	73	73	73	73	73	73	73	73	73	87	4
06:00 PM - 07:00 PM	73	-	73	-	73	-	73	-	73	-	87	4
07:00 PM - 08:00 PM	73	-	73	-	73	-	73	-	73	-	87	4
08:00 PM - 09:00 PM	73	-	73	-	73	-	73	-	73	-	87	4

ADAPTIVE ARCHITECTURE

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TWISTERS GYMNASTICS

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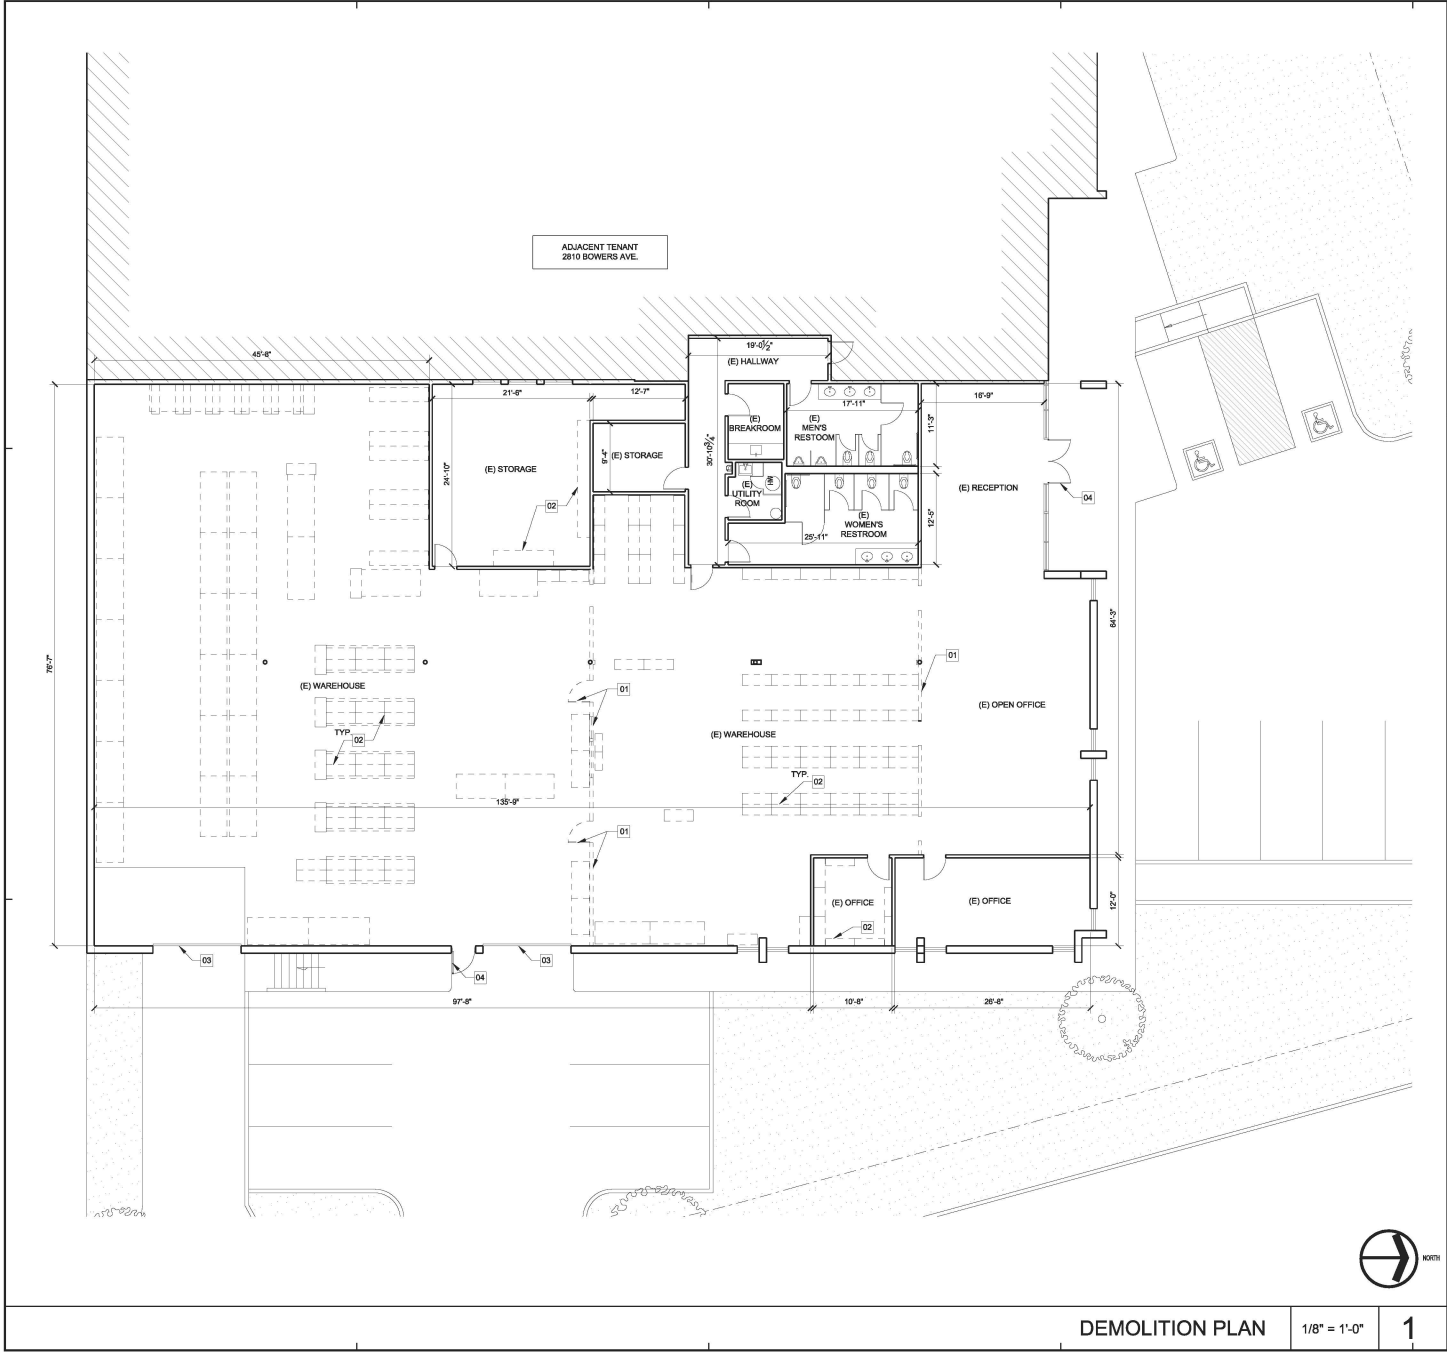


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EXISTING & PROPOSED SITE PLAN

DRAWING NUMBER: **A1.1**



PLAN LEGEND

- (E) WALL/ STRUCTURE TO REMAIN
- WALL TO BE DEMOLISHED
- (E) ADJACENT BUILDING STRUCTURE
- FURNITURE TO BE REMOVED

DEMOLITION KEY NOTES

- 01 (E) WALL/ DOOR/ WINDOW TO BE DEMOLISHED.
- 02 (E) SHELVES TO BE REMOVED.
- 03 (E) GARAGE DOOR TO REMAIN.
- 04 (E) EGRESS DOOR TO REMAIN.

GENERAL NOTES

- A. NO EXTERIOR DEMOLITION WORK IS PROPOSED IN THE PRESENT PROJECT SCOPE.
- B. PROTECT EXISTING WALL STRUCTURE WHERE INDICATED. COORDINATE WITH STRUCTURAL PLANS.
- A. ALL DIMENSIONS ARE TO FACE OF FINISH U.N.O.

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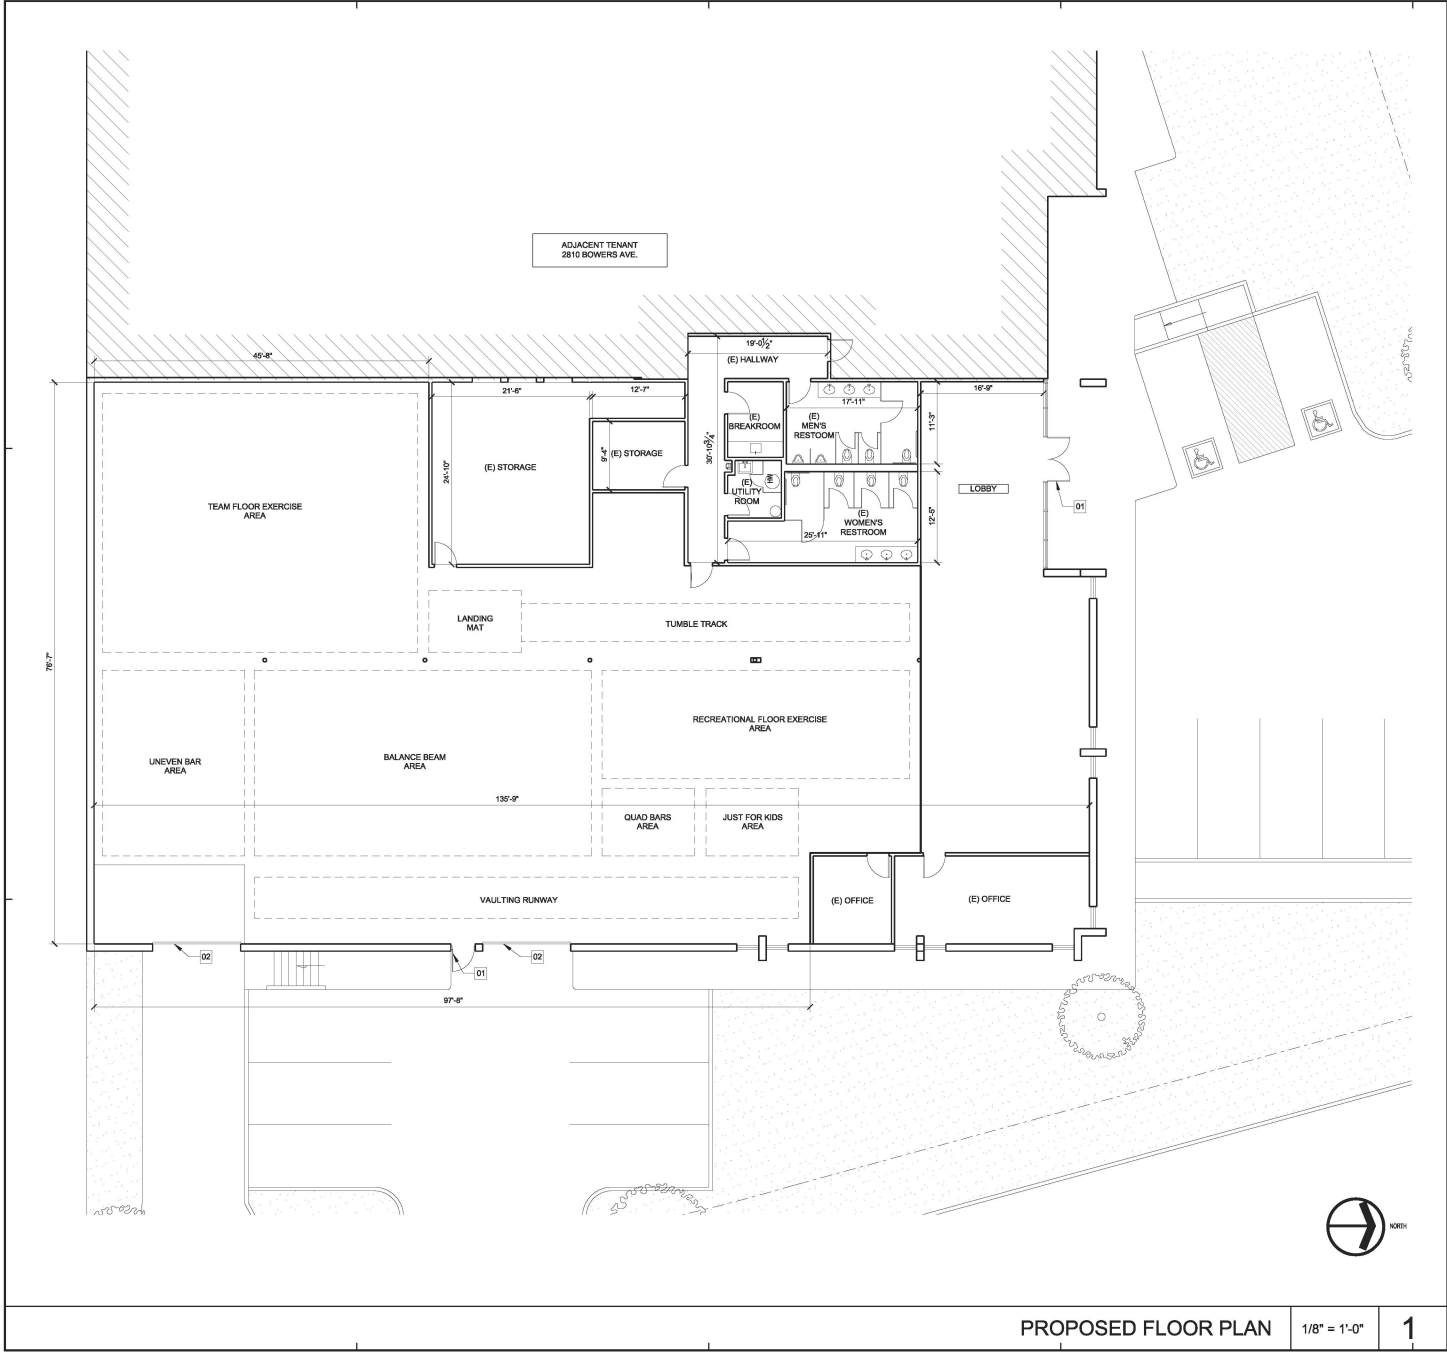


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DEMOLITION
PLAN

DRAWING
NUMBER: A2.0



PLAN LEGEND

- (E) WALL TO REMAIN
- (E) ADJACENT BUILDING STRUCTURE
- PROPOSED ACTIVITY AREAS W/ EXERCISE MATS

DEMOLITION KEY NOTES

- 01 (E) EGRESS DOOR TO REMAIN
- 02 (E) GARAGE DOOR TO REMAIN

GENERAL NOTES

- A. NO EXTERIOR CONSTRUCTION WORK IS PROPOSED IN THE PRESENT SCOPE OF WORK.
- B. ALL DIMENSIONS ARE TO FACE OF FINISH U.N.O.
- C. ENGINEERING DISCIPLINES TO CONFIRM COMPLIANCE OF EXISTING SYSTEMS AND EQUIPMENT FOLLOWING USE-PERMIT SUBMITTAL.

PROPOSED FLOOR PLAN

1/8" = 1'-0"

1

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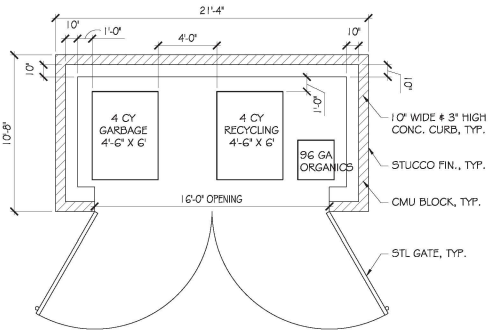


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NEW TRASH ENCLOSURE PLAN

1/4" = 1'-0"


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2800 BOWERS EAST ELEVATION

N.T.S.

1



NEW TRASH ENCLOSURE SECTION

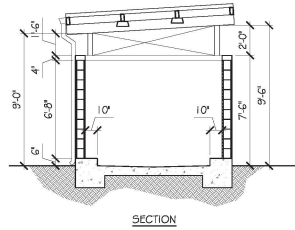1/4" = 1'-0"


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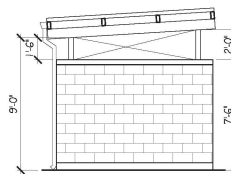
2800 BOWERS SOUTH ELEVATION

N.T.S.


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FRONT ELEVATION



TYPICAL SIDE ELEVATION

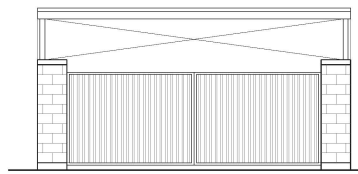

REAR ELEVATION

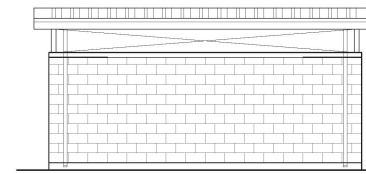NEW TRASH ENCLOSURE ELEVATIONS

1/4" = 1'-0"

3



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△	3/18/21	PLANNING DEPT RESUBMITTAL
△	2/12/21	PLANNING DEPT SUBMITTAL
NO	DATE BY	DESCRIPTION
REVISIONS		

DRAWN: JY	CHECKED:
DATE:	SCALE: AS NOTED
PROJECT NUMBER:	

EXISTING ELEV.
& TRASH ENCL.
DETAILS

DRAWING
NUMBER: **A3.1**